

# HISTORIC AND DESIGN REVIEW COMMISSION

June 01, 2016

## Agenda Item No: 18

**HDRC CASE NO:** 2016-049  
**ADDRESS:** 810 N OLIVE ST  
**LEGAL DESCRIPTION:** NCB 540 BLK 11 LOT A-13 & A-14  
**ZONING:** RM4 H  
**CITY COUNCIL DIST.:** 2  
**DISTRICT:** Dignowity Hill Historic District  
**APPLICANT:** Porter Dillard/Dillard Architect Group  
**OWNER:** Stephen Green  
**TYPE OF WORK:** Final Approval for New Construction  
**REQUEST:**

The applicant is requesting a Certificate of Appropriateness to construct three attached, two story units with two car garages on the vacant lot at 810 N Olive. The applicant has proposed materials consisting of brick, fiber cement board siding, vinyl windows with wood screens and a composition shingle roof.

### APPLICABLE CITATIONS:

*Historic Design Guidelines, Chapter 4, Guidelines for New Construction*

#### 1. Building and Entrance Orientation

##### A. FAÇADE ORIENTATION

- i. *Setbacks*—Align front facades of new buildings with front facades of adjacent buildings where a consistent setback has been established along the street frontage. Use the median setback of buildings along the street frontage where a variety of setbacks exist. Refer to UDC Article 3, Division 2. Base Zoning Districts for applicable setback requirements.
- ii. *Orientation*—Orient the front façade of new buildings to be consistent with the predominant orientation of historic buildings along the street frontage.

##### B. ENTRANCES

- i. *Orientation*—Orient primary building entrances, porches, and landings to be consistent with those historically found along the street frontage. Typically, historic building entrances are oriented towards the primary street.

#### 2. Building Massing and Form

##### A. SCALE AND MASS

- i. *Similar height and scale*—Design new construction so that its height and overall scale are consistent with nearby historic buildings. In residential districts, the height and scale of new construction should not exceed that of the majority of historic buildings by more than one-story. In commercial districts, building height shall conform to the established pattern. If there is no more than a 50% variation in the scale of buildings on the adjacent block faces, then the height of the new building shall not exceed the tallest building on the adjacent block face by more than 10%.
- ii. *Transitions*—Utilize step-downs in building height, wall-plane offsets, and other variations in building massing to provide a visual transition when the height of new construction exceeds that of adjacent historic buildings by more than one-half story.
- iii. *Foundation and floor heights*—Align foundation and floor-to-floor heights (including porches and balconies) within one foot of floor-to-floor heights on adjacent historic structures.

##### B. ROOF FORM

- i. *Similar roof forms*—Incorporate roof forms—pitch, overhangs, and orientation—that are consistent with those predominantly found on the block. Roof forms on residential building types are typically sloped, while roof forms on nonresidential

building types are more typically flat and screened by an ornamental parapet wall.

### C. RELATIONSHIP OF SOLIDS TO VOIDS

i. *Window and door openings*—Incorporate window and door openings with a similar proportion of wall to window space as typical with nearby historic facades. Windows, doors, porches, entryways, dormers, bays, and pediments shall be considered similar if they are no larger than 25% in size and vary no more than 10% in height to width ratio from adjacent historic facades.

ii. *Façade configuration*— The primary façade of new commercial buildings should be in keeping with established patterns. Maintaining horizontal elements within adjacent cap, middle, and base precedents will establish a consistent street wall through the alignment of horizontal parts. Avoid blank walls, particularly on elevations visible from the street. No new façade should exceed 40 linear feet without being penetrated by windows, entryways, or other defined bays.

### D. LOT COVERAGE

i. *Building to lot ratio*— New construction should be consistent with adjacent historic buildings in terms of the building to lot ratio. Limit the building footprint for new construction to no more than 50 percent of the total lot area, unless adjacent historic buildings establish a precedent with a greater building to lot ratio.

## 3. Materials and Textures

### A. NEW MATERIALS

i. *Complementary materials*—Use materials that complement the type, color, and texture of materials traditionally found in the district. Materials should not be so dissimilar as to distract from the historic interpretation of the district. For example, corrugated metal siding would not be appropriate for a new structure in a district comprised of homes with wood siding.

ii. *Alternative use of traditional materials*—Consider using traditional materials, such as wood siding, in a new way to provide visual interest in new construction while still ensuring compatibility.

iii. *Roof materials*—Select roof materials that are similar in terms of form, color, and texture to traditionally used in the district.

iv. *Metal roofs*—Construct new metal roofs in a similar fashion as historic metal roofs. Refer to the Guidelines for Alterations and Maintenance section for additional specifications regarding metal roofs.

v. *Imitation or synthetic materials*—Do not use vinyl siding, plastic, or corrugated metal sheeting. Contemporary materials not traditionally used in the district, such as brick or simulated stone veneer and Hardie Board or other fiberboard siding, may be appropriate for new construction in some locations as long as new materials are visually similar to the traditional material in dimension, finish, and texture. EIFS is not recommended as a substitute for actual stucco.

### B. REUSE OF HISTORIC MATERIALS

i. *Salvaged materials*—Incorporate salvaged historic materials where possible within the context of the overall design of the new structure.

## 4. Architectural Details

### A. GENERAL

i. *Historic context*—Design new buildings to reflect their time while respecting the historic context. While new construction should not attempt to mirror or replicate historic features, new structures should not be so dissimilar as to distract from or diminish the historic interpretation of the district.

ii. *Architectural details*—Incorporate architectural details that are in keeping with the predominant architectural style along the block face or within the district when one exists. Details should be simple in design and should complement, but not visually compete with, the character of the adjacent historic structures or other historic structures within the district. Architectural details that are more ornate or elaborate than those found within the district are inappropriate.

iii. *Contemporary interpretations*—Consider integrating contemporary interpretations of traditional designs and details for new construction. Use of contemporary window moldings and door surroundings, for example, can provide visual interest while helping to convey the fact that the structure is new. Modern materials should be implemented in a way that does not distract from the historic structure.

## 6. Mechanical Equipment and Roof Appurtenances

### A. LOCATION AND SITING

- i. *Visibility*—Do not locate utility boxes, air conditioners, rooftop mechanical equipment, skylights, satellite dishes, and other roof appurtenances on primary facades, front-facing roof slopes, in front yards, or in other locations that are clearly visible from the public right-of-way.
- ii. *Service Areas*—Locate service areas towards the rear of the site to minimize visibility from the public right-of-way.

### B. SCREENING

- i. *Building-mounted equipment*—Paint devices mounted on secondary facades and other exposed hardware, frames, and piping to match the color scheme of the primary structure or screen them with landscaping.
- ii. *Freestanding equipment*—Screen service areas, air conditioning units, and other mechanical equipment from public view using a fence, hedge, or other enclosure.
- iii. *Roof-mounted equipment*—Screen and set back devices mounted on the roof to avoid view from public right-of-way.

## *Historic Design Guidelines, Chapter 5, Guidelines for Site Elements*

## 2. Fences and Walls

### B. NEW FENCES AND WALLS

- i. *Design*—New fences and walls should appear similar to those used historically within the district in terms of their scale, transparency, and character. Design of fence should respond to the design and materials of the house or main structure.
- ii. *Location*—Avoid installing a fence or wall in a location where one did not historically exist, particularly within the front yard. The appropriateness of a front yard fence or wall is dependent on conditions within a specific historic district. New front yard fences or wall should not be introduced within historic districts that have not historically had them.
- iii. *Height*—Limit the height of new fences and walls within the front yard to a maximum of four feet. The appropriateness of a front yard fence is dependent on conditions within a specific historic district. New front yard fences should not be introduced within historic districts that have not historically had them. If a taller fence or wall existed historically, additional height may be considered. The height of a new retaining wall should not exceed the height of the slope it retains.
- iv. *Prohibited materials*—Do not use exposed concrete masonry units (CMU), Keystone or similar interlocking retaining wall systems, concrete block, vinyl fencing, or chain link fencing.
- v. *Appropriate materials*—Construct new fences or walls of materials similar to fence materials historically used in the district. Select materials that are similar in scale, texture, color, and form as those historically used in the district, and that are compatible with the main structure. Screening incompatible uses—Review alternative fence heights and materials for appropriateness where residential properties are adjacent to commercial or other potentially incompatible uses.

## 3. Landscape Design

### A. PLANTINGS

- i. *Historic Gardens*—Maintain front yard gardens when appropriate within a specific historic district.
- ii. *Historic Lawns*—Do not fully remove and replace traditional lawn areas with impervious hardscape. Limit the removal of lawn areas to mulched planting beds or pervious hardscapes in locations where they would historically be found, such as along fences, walkways, or drives. Low-growing plantings should be used in historic lawn areas; invasive or large-scale species should be avoided. Historic lawn areas should never be reduced by more than 50%.
- iii. *Native xeric plant materials*—Select native and/or xeric plants that thrive in local conditions and reduce watering usage. See UDC Appendix E: San Antonio Recommended Plant List—All Suited to Xeriscape Planting Methods, for a list of appropriate materials and planting methods. Select plant materials with a similar character, growth habit, and light requirements as those being replaced.
- iv. *Plant palettes*—If a varied plant palette is used, incorporate species of taller heights, such informal elements should be restrained to small areas of the front yard or to the rear or side yard so as not to obstruct views of or otherwise distract

from the historic structure.

v. *Maintenance*—Maintain existing landscape features. Do not introduce landscape elements that will obscure the historic structure or are located as to retain moisture on walls or foundations (e.g., dense foundation plantings or vines) or as to cause damage.

## B. ROCKS OR HARDSCAPE

i. *Impervious surfaces* —Do not introduce large pavers, asphalt, or other impervious surfaces where they were not historically located.

ii. *Pervious and semi-pervious surfaces*—New pervious hardscapes should be limited to areas that are not highly visible, and should not be used as wholesale replacement for plantings. If used, small plantings should be incorporated into the design.

iii. *Rock mulch and gravel* - Do not use rock mulch or gravel as a wholesale replacement for lawn area. If used, plantings should be incorporated into the design.

## 4. Residential Streetscapes

### A. PLANTING STRIPS

i. *Street trees*—Protect and encourage healthy street trees in planting strips. Replace damaged or dead trees with trees of a similar species, size, and growth habit as recommended by the City Arborist.

ii. *Lawns*— Maintain the use of traditional lawn in planting strips or low plantings where a consistent pattern has been retained along the block frontage. If mulch or gravel beds are used, low-growing plantings should be incorporated into the design.

iii. *Alternative materials*—Do not introduce impervious hardscape, raised planting beds, or other materials into planting strips where they were not historically found.

## 5. Sidewalks, Walkways, Driveways, and Curbing

### A. SIDEWALKS AND WALKWAYS

i. *Maintenance*—Repair minor cracking, settling, or jamming along sidewalks to prevent uneven surfaces. Retain and repair historic sidewalk and walkway paving materials—often brick or concrete—in place.

ii. *Replacement materials*—Replace those portions of sidewalks or walkways that are deteriorated beyond repair. Every effort should be made to match existing sidewalk color and material.

iii. *Width and alignment*— Follow the historic alignment, configuration, and width of sidewalks and walkways. Alter the historic width or alignment only where absolutely necessary to accommodate the preservation of a significant tree.

iv. *Stamped concrete*—Preserve stamped street names, business insignias, or other historic elements of sidewalks and walkways when replacement is necessary.

v. *ADA compliance*—Limit removal of historic sidewalk materials to the immediate intersection when ramps are added to address ADA requirements.

### B. DRIVEWAYS

i. *Driveway configuration*—Retain and repair in place historic driveway configurations, such as ribbon drives. Incorporate a similar driveway configuration—materials, width, and design—to that historically found on the site. Historic driveways are typically no wider than 10 feet. Pervious paving surfaces may be considered where replacement is necessary to increase stormwater infiltration.

ii. *Curb cuts and ramps*—Maintain the width and configuration of original curb cuts when replacing historic driveways. Avoid introducing new curb cuts where not historically found.

### C. CURBING

i. *Historic curbing*—Retain historic curbing wherever possible. Historic curbing in San Antonio is typically constructed of concrete with a curved or angular profile.

ii. *Replacement curbing*—Replace curbing in-kind when deteriorated beyond repair. Where in-kind replacement is not be feasible, use a comparable substitute that duplicates the color, texture, durability, and profile of the original. Retaining walls and curbing should not be added to the sidewalk design unless absolutely necessary.

## FINDINGS:

- a. The request for conceptual approval of the construction of three attached, two story units at 810 N Olive was reviewed by the Design Review Committee on June 23, 2015. At that meeting, committee members recommended that the applicant provide more information regarding materials, site design, porch and column detailing and window and door specifications. Office of Historic Preservation staff found that the proposed new construction featured many inconsistencies with the Guidelines for New Construction and recommended this project take advantage of the suggestions of the Design Review Committee.
- b. The request for conceptual approval was heard by the Historic and Design Review Commission on August 5, 2015, where it was referred to the Design Review Committee. Staff's recommendation at that time was for denial of conceptual approval due to the applicant's inappropriate massing, lack of visual transitions, lack of information regarding the location and screening of mechanical equipment and the inappropriate garage doors. At the August 25, 2015, meeting of the Design Review Committee, committee members noted that the revisions to the design were appropriate.
- c. The request for conceptual approval was heard by the Historic and Design Review Commission on October 7, 2015, where committee members referred it to the Design Review Committee. At the time of this hearing, the Office of Historic Preservation's recommendation was for denial of conceptual approval due to inconsistencies with the Guidelines for New Construction including the proposed width, lack of information regarding an appropriate setback, the lack of appropriate window materials and the lack of appropriate garage door materials.
- d. This request was reviewed by the Design Review Committee on October 12, 2015, where committee members noted that the proposed arches were inappropriate, that the applicant should devote more time to the presentation of application documents and that the applicant should produce better renderings.
- e. The request was reviewed by the Design Review Committee on January 26, 2016. At that meeting, committee members expressed concerns regarding the installation of vinyl windows and the Neoclassical scaling.
- f. At the February 3, 2016, Historic and Design Review Commission hearing, this project received conceptual approval with the stipulation that the applicant consider using alternative materials in order to separate the facades massing prior to returning for final approval. At the time of conceptual approval, the Office of Preservation's recommendation was for denial of conceptual approval due to the applicant's inappropriate massing and orientation.
- g. The request for final approval was reviewed by the Design Review Committee on April 13, 2016, where committee members noted that additional elements should be incorporated into overall porch design of the middle unit.
- h. The request for final approval was reviewed a second time by the Design Review Committee on May 24, 2016. At that meeting where committee members noted that the proposed massing was problematic and had questions regarding landscaping.
- i. The applicant's proposed massing, architectural details and window materials have remained inconsistent throughout multiple Design Review Commission meetings and HDRC hearing. Office of Historic Preservation staff has noted that the proposed massing is not appropriate for the historic context found on N Olive Street, the Dignowity Hill Historic District nor the Historic Design Guidelines. The lack of modification to the design of the proposed new construction has resulted in multiple DRC meetings and HDRC hearings.
- j. SETBACKS – According to the Guidelines for New Construction 1.A.i., the front facades of new buildings should be aligned with the front facades of adjacent buildings where a consistent setback has been established along the street frontage. If no consistent setback has been established, the median setback of all buildings should be used. The applicant has provided a site plan noting a proposed setback of approximately thirty-five (35) feet, however, has not provided a diagram that gives precedent for the proposed setback of thirty-five (35) feet. Staff recommends the applicant provide additional information in regards to the appropriateness of the proposed setback.
- k. ORIENTATION – The front façade of new construction should be oriented in a manner that is consistent with the historic example of the block. This block of N Olive features three historic structures which feature orientations toward N Olive. The applicant has proposed to orient the new construction toward N Olive, consistent with the historic example and the Guidelines for New Construction 1.A.ii.
- l. FRONT PORCH – Many historic structures feature front porches that are the primary points of entrance. Additionally, front porches of historic structures typically cover the length of at least half of the front façade. The applicant has proposed for the structure to feature a front porch that extends toward the public right of way as well

as two small ground level covered patio areas. Above the proposed ground level covered patio areas, the applicant has proposed two balconies featuring a width comparable to that of the middle unit. Historic structures generally feature massing that's hierarchal; larger porches are featured at the first level while smaller porches are above them, or both levels features porches of the same size. Staff finds the applicant's proposed porch massing and configuration inappropriate.

- m. **SCALE & MASS** – Per the Guidelines for New Construction 2.A.i., a height and massing similar to historic structures in the vicinity of the proposed new construction should be used. This block of N Olive features three structures that are oriented toward N Olive as the applicant has proposed that feature one story in height and average widths of approximately thirty (30) feet. The applicant has proposed a two (2) story structure with a width of seventy-nine (79) feet. This is not consistent with the historic example found on N Olive nor is it consistent with the Guidelines for New Construction. Given the number of two story structures in the district, a two story structure may be appropriate but the proportion of height to width should more accurately reflect the historic precedents in the neighborhood. The proportion of height to width is inappropriate to district and inconsistent with the character of the neighborhood.
- n. **TRANSITIONS** – Step downs in building height should be utilized to transition from the height of the proposed new construction to the single story height of neighboring structures. As previously mentioned, each structure located on this block of N Olive features heights of one story. The applicant has not proposed any variation in height or massing to facilitate a transition from the height of the proposed new construction to the height of the neighboring historic structures. This is not consistent with the Guidelines.
- o. **FOUNDATION & FLOOR HEIGHTS** – According to the Guidelines for New Construction 2.A.iii., foundation and floor heights should be aligned within one (1) foot of those of neighboring structures. The applicant has proposed foundation heights that appear to be approximately one (1) foot in height as well as a first floor that features ten (10) feet in height and a second floor that features nine (9) feet in height. Staff recommends the applicant provide an elevation of the proposed new construction on context with neighboring structures to show consistency in the proposed foundation and floor heights.
- p. **ROOF FORM** – The applicant has proposed for the new construction to feature a front gable roof at the overhang of the middle unit's porch as well as side gables on the north and south facades. The applicant's proposed roof forms are consistent with the Guidelines for New Construction 2.B.i.
- q. **WINDOW & DOOR OPENINGS** – The applicant has proposed window and door openings that generally are appropriately scaled and are comparable to the historic examples found throughout the Dignowity Hill Historic District. While staff finds the applicant's proposed openings appropriate, staff finds the proposal to use vinyl windows inappropriate and inconsistent with the Guidelines for New Construction. Staff recommends the applicant install windows that are appropriate for new construction in a historic district. The use of wood screens is not an appropriate alternative for using vinyl windows.
- r. **LOT COVERAGE** – The building footprint for new construction should be no more than fifty (50) percent of the size of total lot area. The applicant's proposed building footprint is consistent with the Guidelines for New Construction 2.D.i.
- s. **MATERIALS** – In regards to materials, the applicant has proposed brick, fiber cement board siding and trim, a composition shingle roof, wood railing, wood columns and wood fascias and soffits. Staff finds these previously mentioned materials appropriate.
- t. **WINDOW & DOOR MATERIALS** – As previously mentioned, staff does find the applicant's proposed window materials neither appropriate nor consistent with the Guidelines. Additionally, staff recommends the applicant provide information regarding materials for both the pedestrian doors and the overhead rolling garage doors.
- u. **ARCHITECTURAL DETAILS** – The applicant has proposed architectural details that staff finds to be inappropriate for the proposed setting in the Dignowity Hill Historic District. The applicant's proposed massing and overall width have resulted in architectural components that are not typical to historic districts nor hold appropriate ratios. Staff finds that the applicant's proposed porch configuration, column proportions and side gable widths are not appropriate.
- v. **ARCHITECTURAL DETAILS** – Staff finds that a reduction in mass to one that's comparable to the historic example would facilitate more appropriate architectural details. This particular lot features depth than many lots in the immediate area do not. Staff finds that a rotation of the structure's footprint would provide a more appropriate mass fronting the public right of way as well as provide traditional widths which would promote appropriate details.
- w. **GARAGE** – At the rear of the proposed new construction, the applicant has proposed for each unit to feature a

- garage to accommodate parking for two (2) vehicles. Staff finds the applicant's proposed location for parking appropriate. The applicant has proposed garage door which in elevation share an appearance to traditional carriage doors. Staff recommends the applicant provide additional information in regards to the proposed garage doors.
- x. **MECHANICAL EQUIPMENT** – The applicant has noted that HVAC equipment will be located at the rear of the proposed new construction. Staff finds this placement appropriate and consistent with the Guidelines, however, staff recommends the applicant provide additional information regarding the additional screening and enclosing of the HVAC equipment.
  - y. **SIDEWALKS** – The applicant has proposed to install three front sidewalks to connect the front stoops of each unit to the existing sidewalk at the public right of way. According to the Guidelines for Site Elements 5.A.iii., the historic alignment, configuration and width of sidewalks and walkways should be implemented into new construction. The historic example throughout the Dignowity Hill Historic District is for one sidewalk to service each structure. The applicant's proposed sidewalks are not consistent with the Guidelines. Staff recommends the applicant keep the proposed center sidewalk and establish on site paths to the two exterior stoops.
  - z. **SITE PAVING** – According to the Guidelines for Site Elements 3.B.i., large pavers, asphalt or other impervious surfaces should not be introduced where not historically located. Staff finds the applicant's proposal to install asphalt paving at the rear of the proposed structure inappropriate and inconsistent with the Guidelines. Staff recommends the applicant use pervious ground cover such as decomposed granite.
  - aa. **DRIVEWAY** – The applicant has proposed to maintain the existing driveway as it currently exists. Staff finds this proposal appropriate and consistent with the Guidelines for Site Elements.
  - bb. **LANDSCAPING** – The applicant has provided a landscaping plan noting a number of plant materials that are to be installed on both the east and west sides of the proposed new construction. Staff finds the applicant's proposed landscaping design appropriate.

#### **RECOMMENDATION:**

Staff does not recommend final approval based on findings g through y. Staff recommends the applicant address the following:


1. The applicant should provide information to staff noting that an appropriate and consistent setback has been proposed as noted in finding j.
2. The applicant should propose front porch massing that is architecturally appropriate as noted in finding l.
3. The applicant should propose an appropriate scale and mass, specifically in regards to the proposed width and height as noted in finding m.
4. The applicant should incorporate an architectural transition that relates to the neighboring structures as noted in finding n.
5. The applicant should provide information to staff in regards to the proposed foundation and floor heights as they relate to the historic heights of the neighboring structures as noted in finding o.
6. The applicant should propose windows that are appropriate for a historic district and consistent with the Guidelines as noted in findings q and t.
7. The applicant should provide additional information in regards to proposed pedestrian and garage door materials as noted in finding t.
8. The applicant should provide additional information in regards to the screening of mechanical equipment as noted in finding x.
9. The applicant should propose an appropriate sidewalk configuration on site as noted in finding y.
10. The applicant should propose an appropriate site paving material at the rear of the proposed new construction as noted in finding z.

#### **CASE MANAGER:**

Edward Hall

#### **CASE COMMENTS:**

This item was reviewed by the Design Review Committee on June 23, 2015; August 25, 2015; October, 14, 2015; January 26, 2016; April 13, 2016, and May 24, 2016.

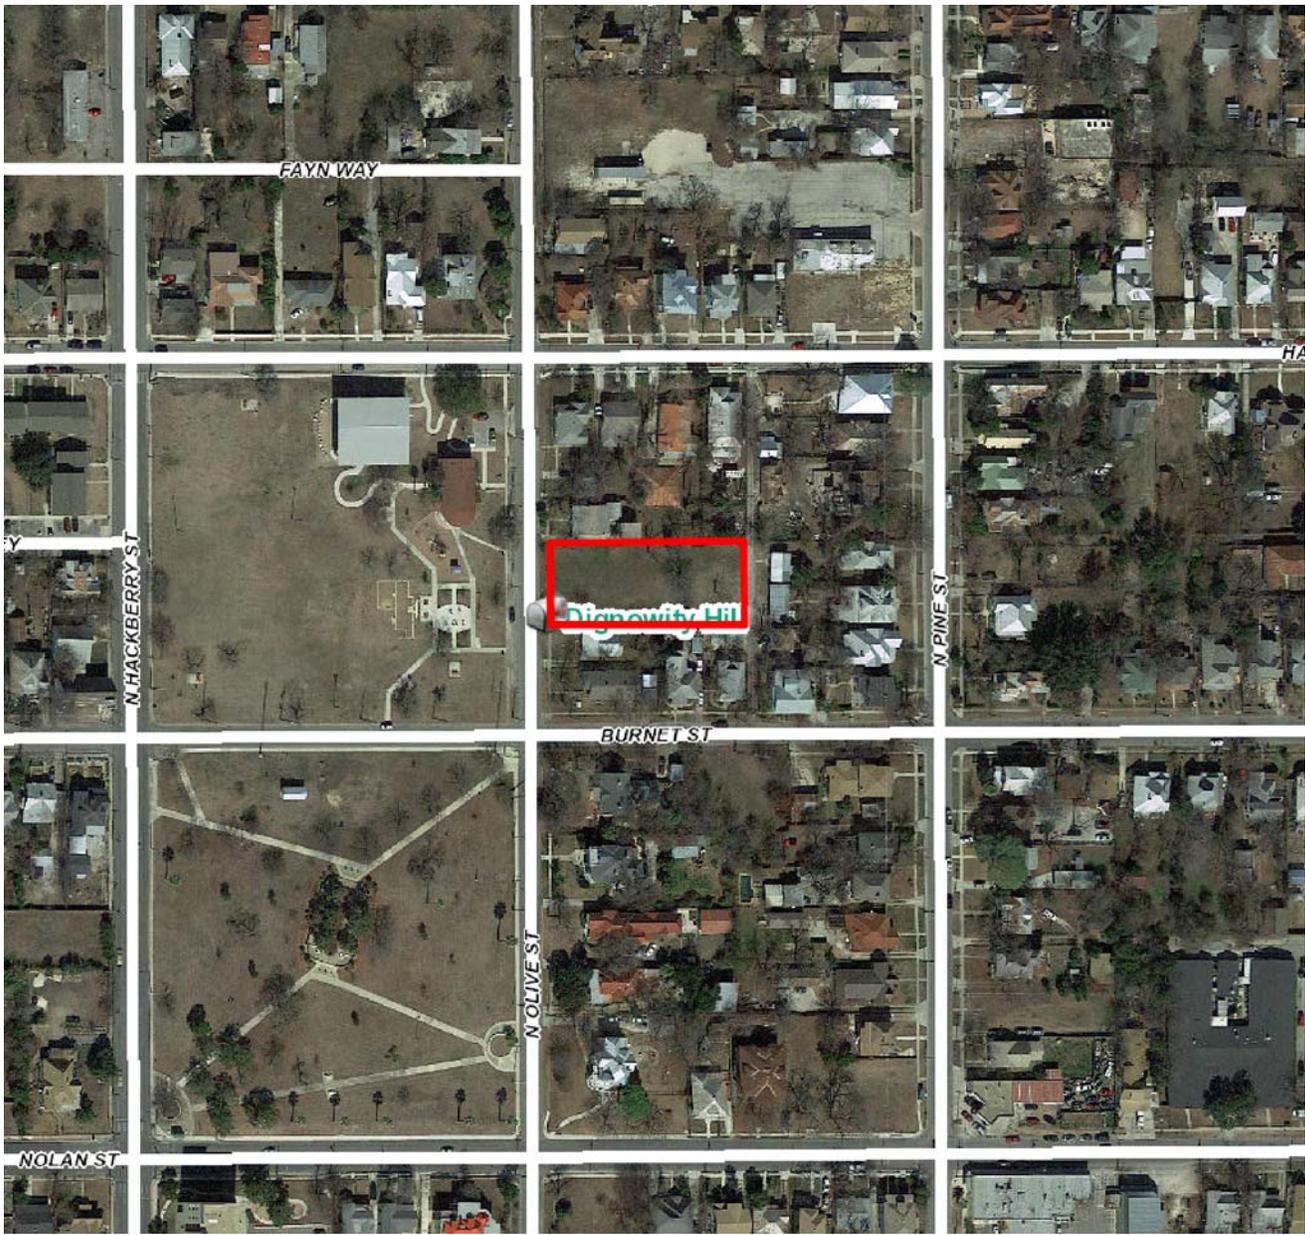

## Flex Viewer

Powered by ArcGIS Server

Printed: May 23, 2016

The City of San Antonio does not guarantee the accuracy, adequacy, completeness or usefulness of any information. The City does not warrant the completeness, timeliness, or positional, thematic, and attribute accuracy of the GIS data. The GIS data, cartographic products, and associated applications are not legal representations of the depicted data. Information shown on these maps is derived from public records that are constantly undergoing revision. Under no circumstances should GIS-derived products be used for final design purposes. The City provides this information on an "as is" basis without warranty of any kind, express or implied, including but not limited to warranties of merchantability or fitness for a particular purpose, and assumes no responsibility for anyone's use of the information.



N Pine St

N Pine St

N Pine St

Hays St

Burnet St

810 N Olive St

N Olive St

Lockwood Center

N Olive St

Fayn Way

Hays St

Burnet St

Dignowity Park

Fayn Way

Hays St

N Hackberry

N Hackberry

N Hackberry

N Hackberry

# CONTINUATION OF APPLICATION PROJECT DESCRIPTION

## Excerpt From HDRC Letter of Conceptual Approval

### HISTORIC AND DESIGN REVIEW COMMISSION

#### COMMISSION ACTION

**This is not a Certificate of Appropriateness and cannot be used to acquire permits**

February 3, 2016

**HDRC CASE NO: 2016-049**

**ADDRESS: 810 N OLIVE ST**

**LEGAL DESCRIPTION: NCB 540 BLK 11 LOT A-13 & A-14**

**HISTORIC DISTRICT: Dignowity Hill**

**APPLICANT: Porter Dillard/Dillard Architect Group - 708 Rigsby**

**OWNER: Stephen Green - 2810 Lake Crystal St**

**TYPE OF WORK: New construction**

#### RECOMMENDATION:

Staff does not recommend conceptual approval. Staff finds that the applicant should address the proposed massing and width as noted in finding h.

#### COMMISSION ACTION:

Approved with stipulations: consider alternating materials in order to help break up the massing before returning for final approval.

## APPLICANTS RESPONSE TO HDRC CONCEPTUAL APPROVAL:

Based on HDRC Conceptual Approval, applicant proceeded with documents for final approval. Applicant made adjustments to the approved Conceptual Design incorporating adjustments to the 2<sup>nd</sup> floor porches to impact the massing issues referenced in Staff's Comments item h. The results of the changes created a reduction in the overall mass. The applicant met with HDRC Architectural Design Committee on April 13, 2016, presenting the revised massing conditions. Members of the committee suggested additional elements with the in-corporation of masonry columns at the porch of the middle unit. The felt that this worked well with the overall concept and is reflected on the final submission for Full Approval..



# GREEN TOWNHOUSE

810 N. OLIVE ST  
SAN ANTONIO, TX 78202







Dillard Architect Group  
708 Rigby Avenue  
San Antonio, Texas  
(210) 531-0050 office (210) 531-0074 fax  
dillarchgrp@att.net





**Dillard Architect Group**  
 702 Ripley Avenue  
 San Antonio, Texas  
 (210) 834-0050 office (210) 834-0074 fax  
 dillarchgrp@aol.com

Scale:  
 1" = 10'-0"  
 1/8" = 1'-0"  
 1/4" = 1'-0"  
 1/2" = 1'-0"  
 3/4" = 1'-0"  
 1" = 1'-0"  
 1 1/4" = 1'-0"  
 1 1/2" = 1'-0"  
 1 3/4" = 1'-0"  
 2" = 1'-0"  
 2 1/4" = 1'-0"  
 2 1/2" = 1'-0"  
 2 3/4" = 1'-0"  
 3" = 1'-0"  
 3 1/4" = 1'-0"  
 3 1/2" = 1'-0"  
 3 3/4" = 1'-0"  
 4" = 1'-0"  
 4 1/4" = 1'-0"  
 4 1/2" = 1'-0"  
 4 3/4" = 1'-0"  
 5" = 1'-0"  
 5 1/4" = 1'-0"  
 5 1/2" = 1'-0"  
 5 3/4" = 1'-0"  
 6" = 1'-0"  
 6 1/4" = 1'-0"  
 6 1/2" = 1'-0"  
 6 3/4" = 1'-0"  
 7" = 1'-0"  
 7 1/4" = 1'-0"  
 7 1/2" = 1'-0"  
 7 3/4" = 1'-0"  
 8" = 1'-0"  
 8 1/4" = 1'-0"  
 8 1/2" = 1'-0"  
 8 3/4" = 1'-0"  
 9" = 1'-0"  
 9 1/4" = 1'-0"  
 9 1/2" = 1'-0"  
 9 3/4" = 1'-0"  
 10" = 1'-0"  
 10 1/4" = 1'-0"  
 10 1/2" = 1'-0"  
 10 3/4" = 1'-0"  
 11" = 1'-0"  
 11 1/4" = 1'-0"  
 11 1/2" = 1'-0"  
 11 3/4" = 1'-0"  
 12" = 1'-0"  
 12 1/4" = 1'-0"  
 12 1/2" = 1'-0"  
 12 3/4" = 1'-0"  
 13" = 1'-0"  
 13 1/4" = 1'-0"  
 13 1/2" = 1'-0"  
 13 3/4" = 1'-0"  
 14" = 1'-0"  
 14 1/4" = 1'-0"  
 14 1/2" = 1'-0"  
 14 3/4" = 1'-0"  
 15" = 1'-0"  
 15 1/4" = 1'-0"  
 15 1/2" = 1'-0"  
 15 3/4" = 1'-0"  
 16" = 1'-0"  
 16 1/4" = 1'-0"  
 16 1/2" = 1'-0"  
 16 3/4" = 1'-0"  
 17" = 1'-0"  
 17 1/4" = 1'-0"  
 17 1/2" = 1'-0"  
 17 3/4" = 1'-0"  
 18" = 1'-0"  
 18 1/4" = 1'-0"  
 18 1/2" = 1'-0"  
 18 3/4" = 1'-0"  
 19" = 1'-0"  
 19 1/4" = 1'-0"  
 19 1/2" = 1'-0"  
 19 3/4" = 1'-0"  
 20" = 1'-0"

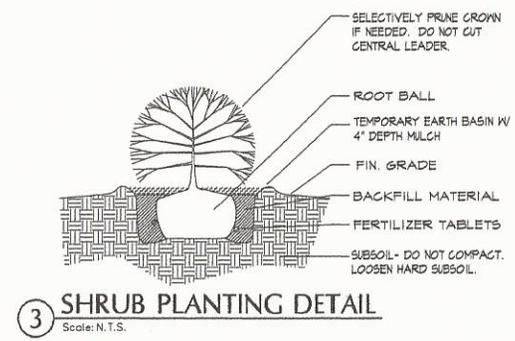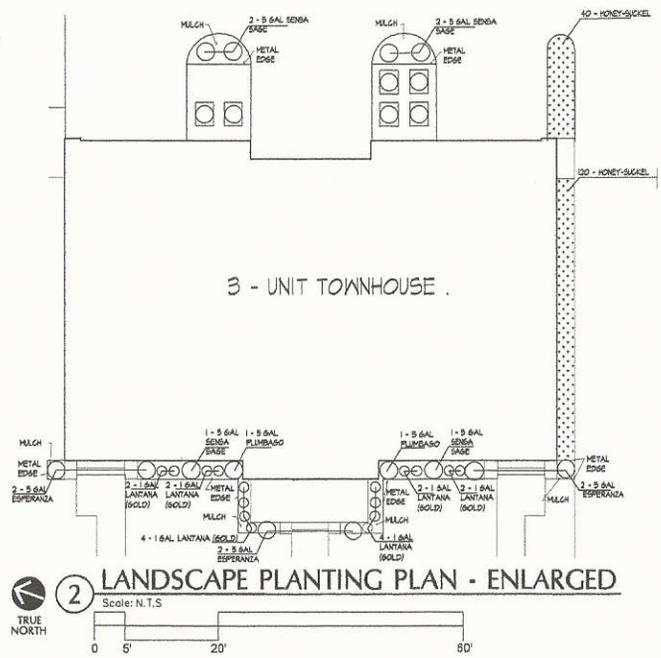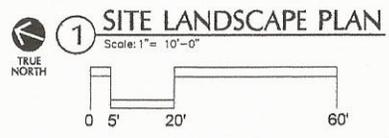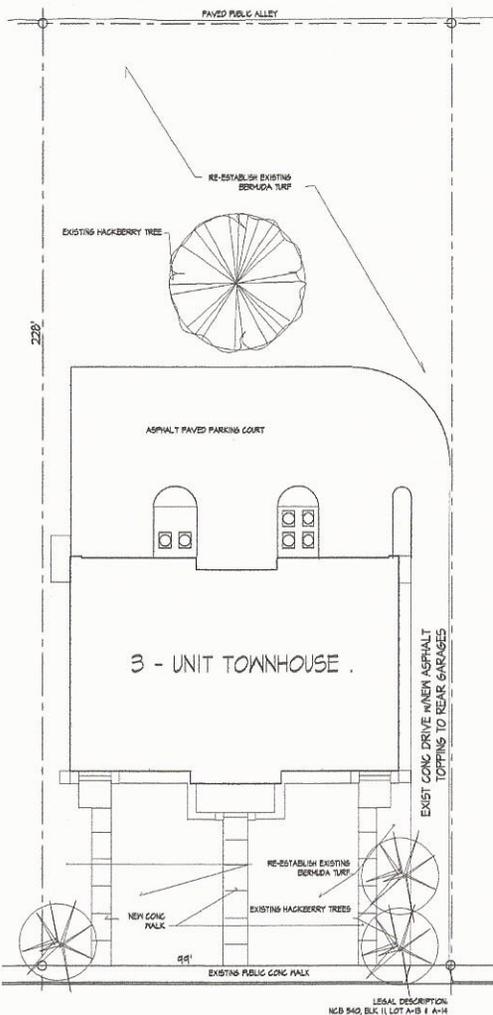


**GREEN TOWNHOUSE**

810 N. OLIVE ST.  
 SAN ANTONIO, TX. 78202

| No. | Revision/Author | Date |
|-----|-----------------|------|
|     |                 |      |
|     |                 |      |

Sheet Name  
**LANDSCAPE SITE PLAN & DETAILS**

|              |                |                |
|--------------|----------------|----------------|
| Drawn By: JS | Date: 05/10/16 | Sheet No: L-10 |
| Checked By:  |                |                |
| Sheet Desc:  |                |                |
| Project No:  |                |                |

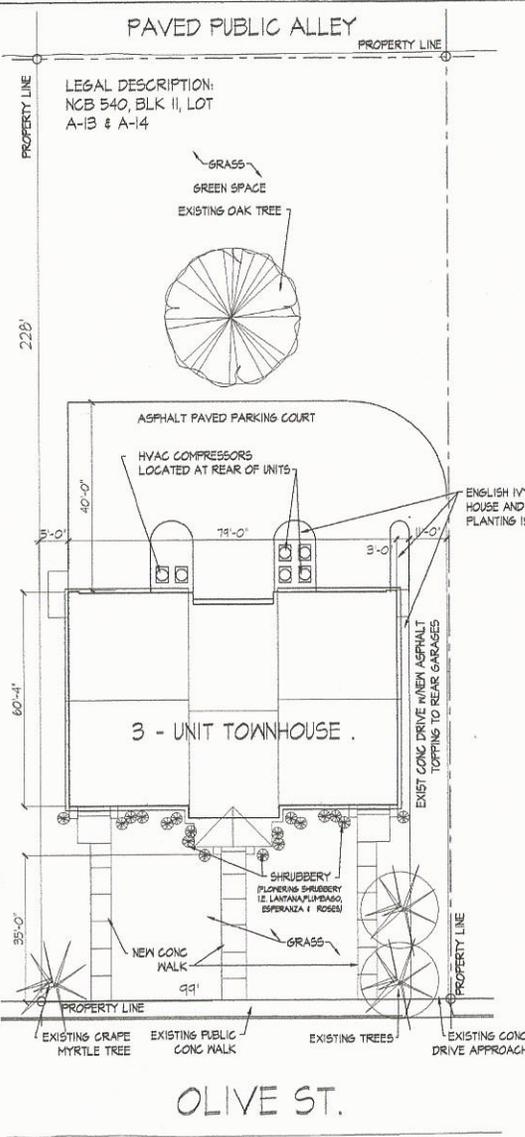

**Dillard Architect Group**  
708 Rigby Avenue  
San Antonio, Texas  
(214) 534-0000 office (214) 531-6074 fax  
dillardgrp@att.net

Scale:

DATE: \_\_\_\_\_

PROJECT: \_\_\_\_\_

CLIENT: \_\_\_\_\_

DESIGNER: \_\_\_\_\_

DATE: \_\_\_\_\_

GREEN TOWNHOUSE


810 N. OLIVE ST.  
SAN ANTONIO, TX. 78202


| No. | Revision/Issue: | Date: |
|-----|-----------------|-------|
|     |                 |       |
|     |                 |       |

Sheet Name:


**SITE PLAN**

|              |                |                 |
|--------------|----------------|-----------------|
| Drawn By: JS | Date: 05/10/16 | Sheet No: A-0.0 |
| Checked By:  |                |                 |
| Scale:       |                |                 |
| Project No.: |                |                 |

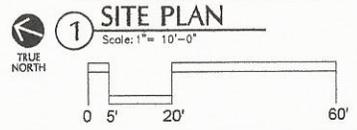


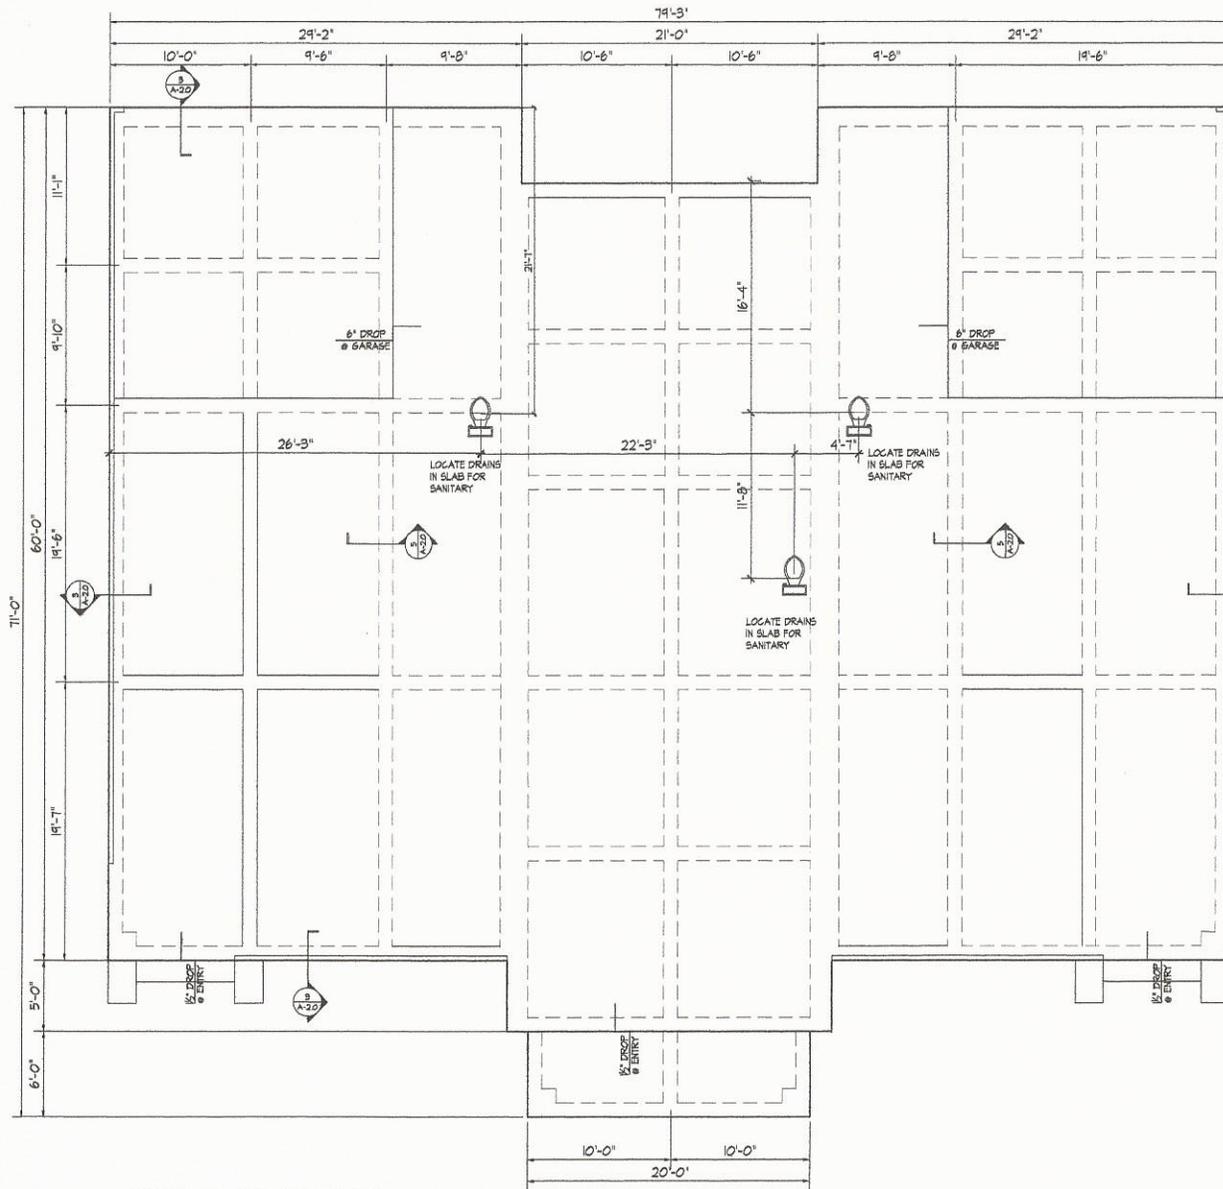


**1 FOUNDATION PLAN**  
Scale: 1/4" = 1'-0"

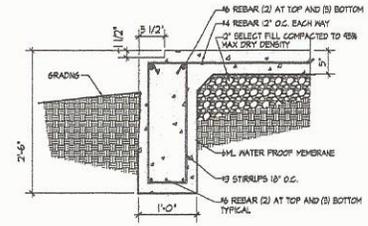


**2 DTL: FOUNDATION PLAN**  
Scale: 1" = 1'-0"

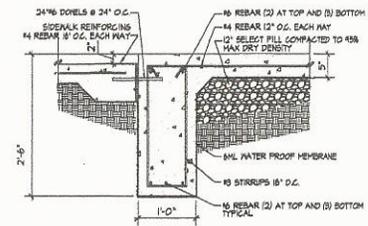

**3 DTL: FOUNDATION PLAN**  
Scale: 1" = 1'-0"

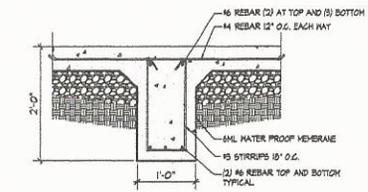

**4 DTL: FOUNDATION PLAN**  
Scale: 1" = 1'-0"

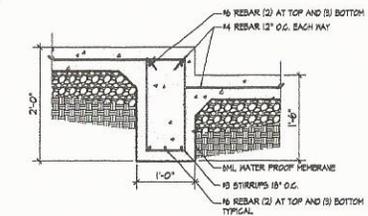

**5 DTL: FOUNDATION PLAN**  
Scale: 1" = 1'-0"



**Dillard Architect Group**  
708 Rigby Avenue  
San Antonio, Texas  
(210) 531-0550 office (210) 531-0274 fax  
dillarchgrp@aol.net

Sheet  
Date  
Scale

DISCLAIMER: THESE drawings are prepared by the drafter under the supervision of the professional engineer or architect. The engineer or architect is not responsible for the accuracy of the information provided by the client or for the use of the drawings for any purpose other than that intended by the drafter.


**GREEN TOWNHOUSE**

810 N. OLIVE ST.  
SAN ANTONIO, TX. 78202

| No. | Revision/Issue | Date |
|-----|----------------|------|
|     |                |      |
|     |                |      |

**FOUNDATION PLAN**

|              |                    |              |
|--------------|--------------------|--------------|
| Drawn By: JS | Check By: JS/10/16 | Scale: A-1.0 |
| Project No.: | Sheet No.:         | Date:        |

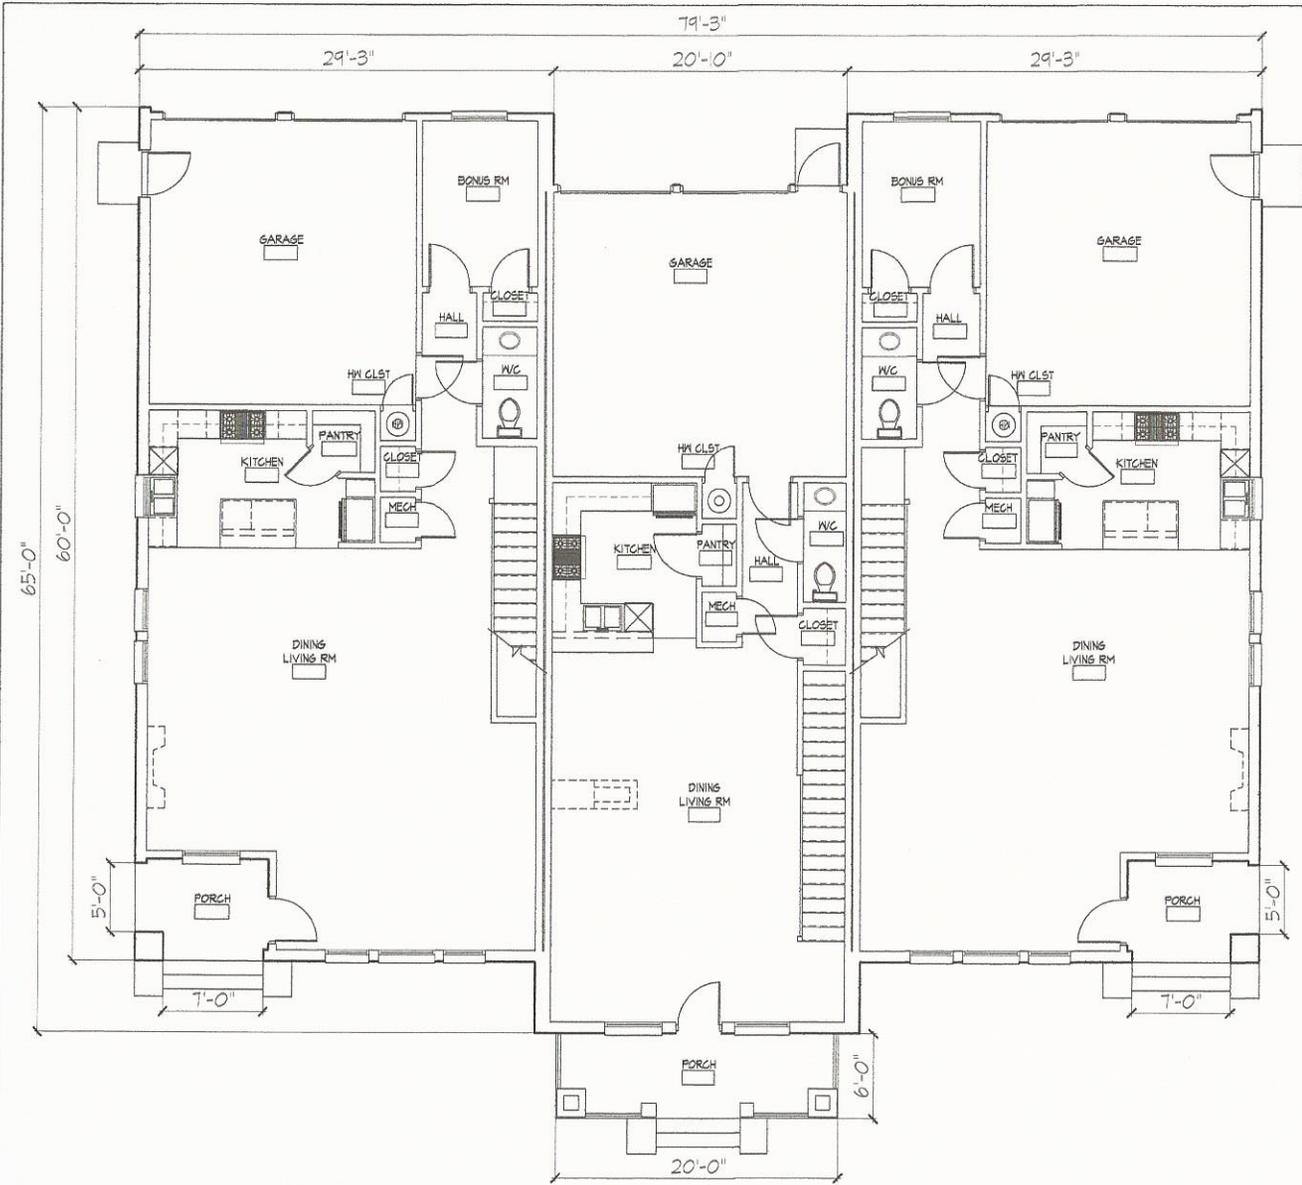

**COMPOSITE FLOOR PLAN - FIRST FLOOR**

Scale: 1/4" = 1'-0"



1

TRUE NORTH



**Dillard Architect Group**  
 708 Rigley Avenue  
 San Antonio, Texas  
 (214) 531-6500 office (214) 531-6274 fax  
 dillarchgrp@att.net

Scale: \_\_\_\_\_

© 2005 DILLARD ARCHITECT GROUP  
 All rights reserved. No part of this drawing may be reproduced or transmitted in any form or by any means, electronic or mechanical, including photocopying, recording, or by any information storage and retrieval system, without the prior written permission of Dillard Architect Group.


**GREEN TOWNHOUSE**

810 N. OLIVE ST.  
 SAN ANTONIO, TX. 78202

| No. | Revision/Issue | Date |
|-----|----------------|------|
|     |                |      |
|     |                |      |

**FIRST FLOOR PLAN**

|              |                |                  |
|--------------|----------------|------------------|
| Drawn By: JS | Date: 05/19/06 | Sheet No.: A-2.0 |
| Checked By:  |                |                  |
| Project No.: |                |                  |

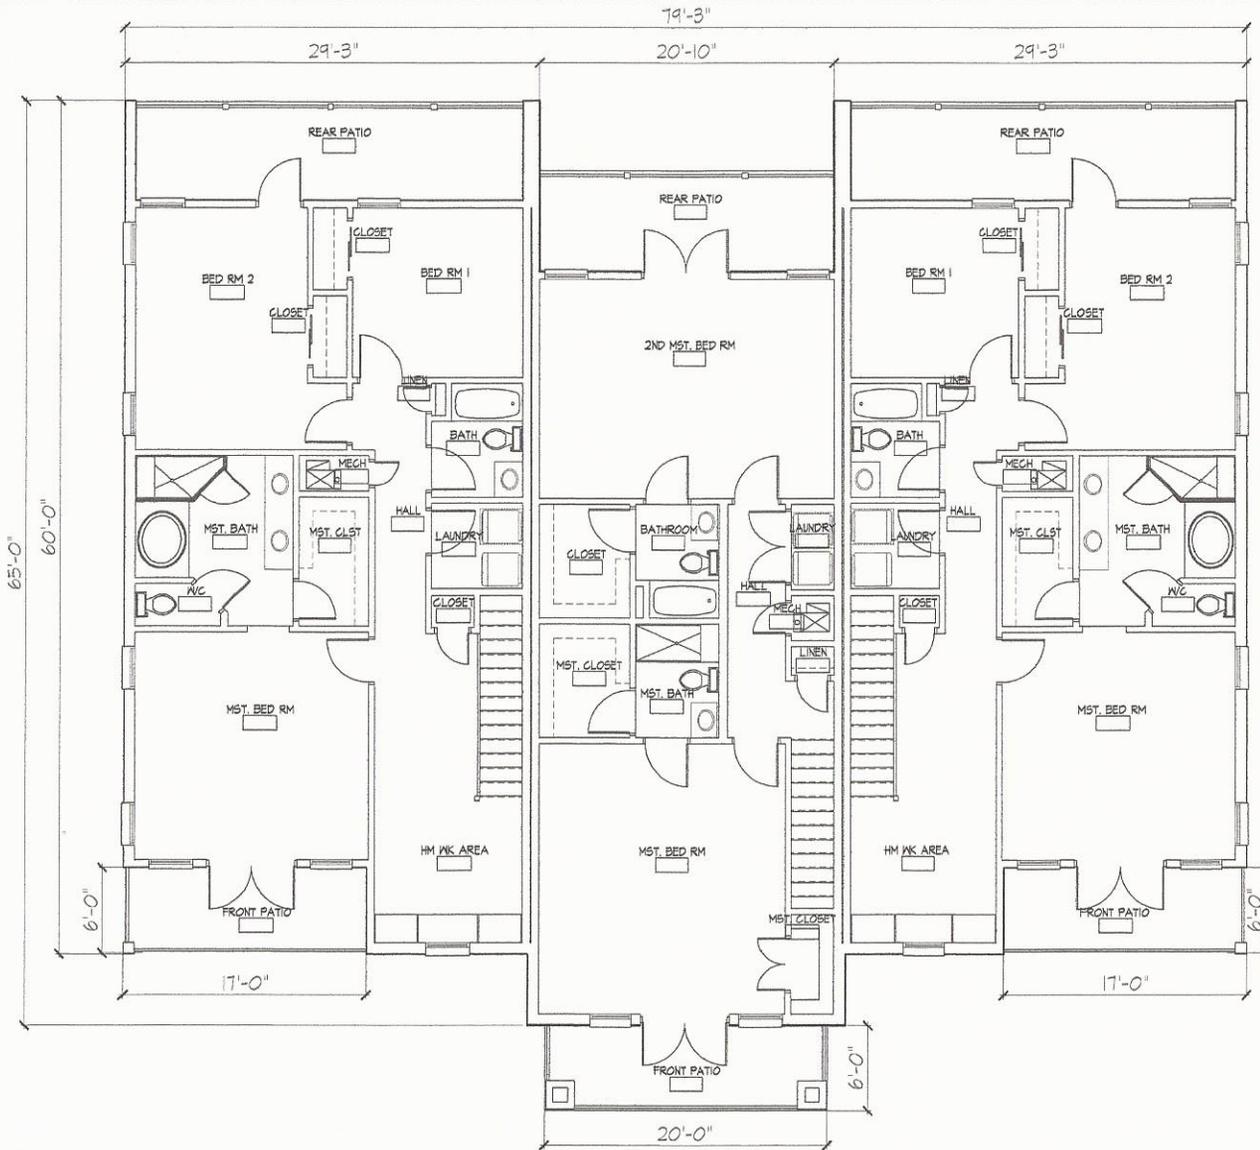

1

**COMPOSITE FLOOR PLAN - SECOND FLOOR**  
 Scale: 1/4" = 1'-0"



**Dillard Architect Group**  
 708 Riggsby Avenue  
 San Antonio, Texas  
 (214) 591-0880 Office (214) 591-0874 Fax  
 dillarchgrp@aol.com

Sheet: \_\_\_\_\_  
 Title: \_\_\_\_\_  
 DATE: \_\_\_\_\_

DISCLAIMER: This plan is provided as a service of Dillard Architect Group, Inc. It is not to be used for any other purpose without the express written consent of Dillard Architect Group, Inc. The user assumes all liability for any use of this plan not intended by the user.

**GREEN TOWNHOUSE**

810 N. OLIVE ST.  
 SAN ANTONIO, TX. 78202


| No. | Revision/Issue | Date |
|-----|----------------|------|
|     |                |      |
|     |                |      |

Sheet Name:  
**SECOND FLOOR PLAN**


|              |                |                     |
|--------------|----------------|---------------------|
| Drawn By: JS | Date: 05/10/16 | Scale: 1/4" = 1'-0" |
| Checked By:  |                |                     |
| Project No:  |                |                     |

A-3




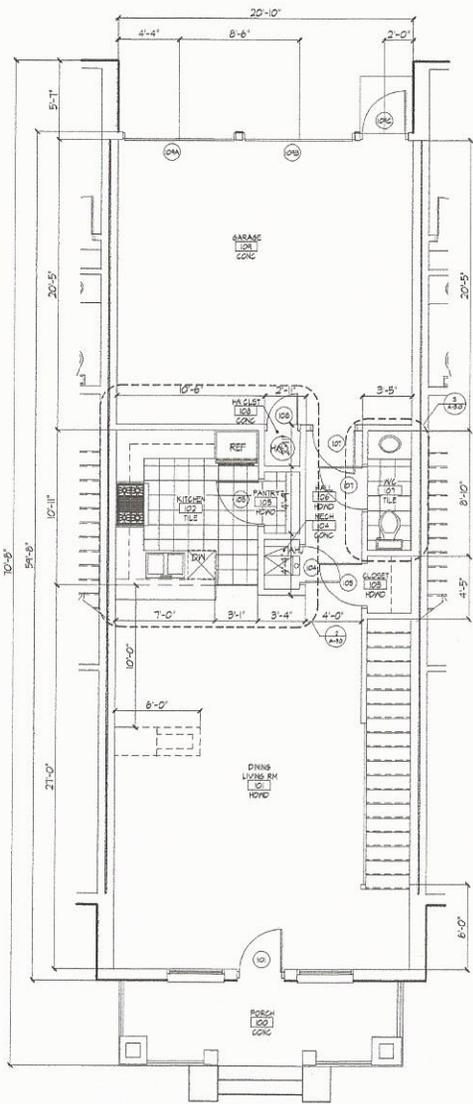

1 PLAN: FLOOR PLAN  
2ND FLOOR UNIT B  
Scale: 1/4" = 1'-0"

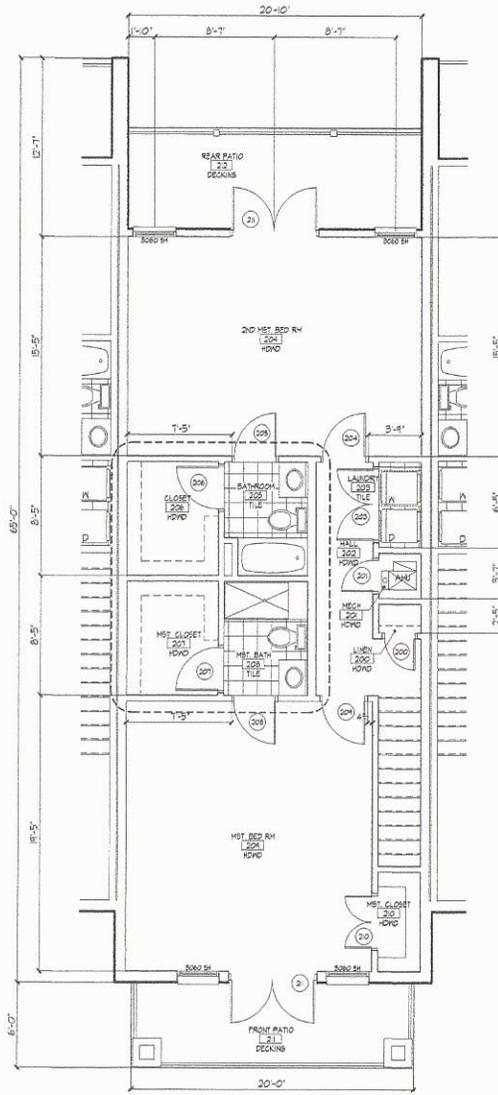

2 PLAN: FLOOR PLAN  
2ND FLOOR UNIT B  
Scale: 1/4" = 1'-0"

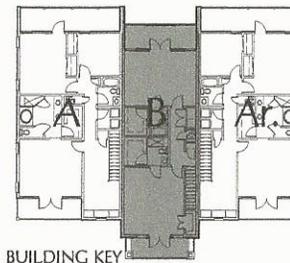

BUILDING KEY



**Dillard Architect Group**  
709 Rigby Avenue  
San Antonio, Texas  
(214) 531-0550 office (214) 531-0274 fax  
#dillarchgrp@att.net

Scale: \_\_\_\_\_

NOT TO SCALE

All construction practices in use of these plans are subject to the local building codes and regulations. It is the responsibility of the contractor to verify all applicable codes and regulations for the project. The architect is not responsible for any errors or omissions in these plans.

# GREEN TOWNHOUSE

810 N. OLIVE ST.  
SAN ANTONIO, TX. 78202

Project Name and Address

|      |                 |       |
|------|-----------------|-------|
| No.: | Revision/Issue: | Date: |
|      |                 |       |

## FLOOR PLANS UNIT B

|             |    |       |          |            |       |
|-------------|----|-------|----------|------------|-------|
| Drawn By:   | JS | Date: | 03/10/16 | Sheet No.: | A-5.0 |
| Checked By: |    |       |          |            |       |
| Print Date: |    |       |          |            |       |
| Print No.:  |    |       |          |            |       |



**Dillard Architect Group**  
 728 Highgate Avenue  
 San Antonio, Texas  
 (210) 531-0055 office (210) 531-4074 fax  
 dillard@dag.com

Scale:


NOT TO SCALE  
 All dimensions are given in feet and inches unless otherwise noted. All dimensions are given in feet and inches unless otherwise noted. All dimensions are given in feet and inches unless otherwise noted.



**1 FRONT ELEVATION**  
 Scale: 1/4" = 1'-0"



**1 SIDE ELEVATION**  
 Scale: 1/4" = 1'-0"

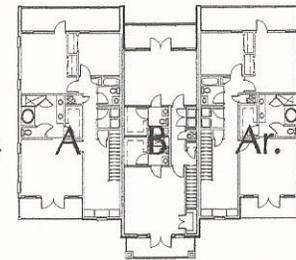

BUILDING KEY

**GREEN TOWNHOUSE**

810 N. OLIVE ST.  
 SAN ANTONIO, TX. 78202

No. 1 Revision/Issue: Date:

|  |  |
|--|--|
|  |  |
|  |  |

**ELEVATIONS**

|              |                |                  |
|--------------|----------------|------------------|
| Drawn By: JS | Date: 03/10/16 | Sheet No.: A-6.0 |
| Checked By:  |                |                  |
| Project No.: |                |                  |



**Dillard Architect Group**  
 738 Ripley Avenue  
 San Antonio, Texas  
 (210) 531-0050 office (210) 531-0074 fax  
 dillard@dag.com

Sheet:  
 7 of 11  
 COPYRIGHT © 2016  
 All rights reserved. This drawing is the property of Dillard Architect Group. It is to be used only for the project and site for which it was prepared. No part of this drawing may be reproduced or transmitted in any form or by any means, electronic, mechanical, photocopying, recording, or by any information storage and retrieval system, without the prior written permission of Dillard Architect Group.

**GREEN TOWNHOUSE**

810 N. OLIVE ST.  
 SAN ANTONIO, TX. 78202

No. 1 Revision/Issue: Date:

**ELEVATIONS**


Drawn By: JS Date: 03/10/16 Sheet No.:  
 Checked By: [Signature] Date: [Blank] Sheet No.: **A-7.0**  
 Small Date: [Blank] Sheet No.: [Blank]  
 Project No.: [Blank] Sheet No.: [Blank]



**1 REAR ELEVATION**  
 Scale: 1/4" = 1'-0"



**1 SIDE ELEVATION**  
 Scale: 1/4" = 1'-0"

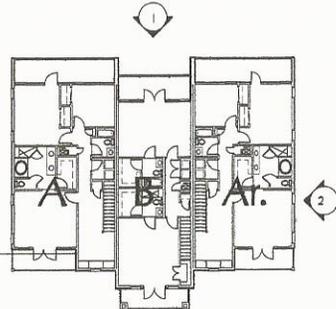

BUILDING KEY



**Dillard Architect Group**  
 788 Highway Avenue  
 San Antonio, Texas  
 (214) 514-0050 office (214) 531-0074 fax  
 dilldard@at.net

Scale: \_\_\_\_\_  
 Date: \_\_\_\_\_  
 2017 PROJECT #1111  
 ALL RIGHTS RESERVED. NO PART OF THIS DOCUMENT MAY BE REPRODUCED OR TRANSMITTED IN ANY FORM OR BY ANY MEANS, ELECTRONIC OR MECHANICAL, INCLUDING PHOTOCOPYING, RECORDING, OR BY ANY INFORMATION STORAGE AND RETRIEVAL SYSTEM, WITHOUT PERMISSION IN WRITING FROM THE ARCHITECT.

**GREEN TOWNHOUSE**

810 N. OLIVE ST.  
 SAN ANTONIO, TX. 78202

No. 1 Revision/Issue: \_\_\_\_\_ Date: \_\_\_\_\_


**ENLARGED ELEVATIONS WALL SECTION**

Drawn By: JS Date: 05/10/16 Sheet No.:  
 Checked By: \_\_\_\_\_  
 Sheet Title: **A-8.0**  
 Project No.: \_\_\_\_\_  
 Scale: 1/2" = 1'-0"




**1 FRONT ELEVATION**  
 Scale: 1/2" = 1'-0"

- 2 x 6 WOOD GABLE BRACKET
- COMPOSITION SHINGLE ROOF
- 20'-0" T.O. TRUSS BEARING
- 1 x 6 SMOOTH FACE FIBRE CEMENT LAP SIDING
- 17'-10" T.O. WINDOWS/ DOORS
- SMOOTH FACE FIBRE CEMENT BOARD ENGAGEMENT OF WOOD COLUMNS w/ FIBRE CEMENT BOARD 4" TRIM
- SOLDIER COURSE
- 2x6 WOOD HAND RAIL w/ 2x2 WOOD PICKETS
- 11'-0" SECOND FLOOR
- MODULAR FACE BRICK
- EXTERIOR
- 6'-10" T.O. WINDOWS/ DOORS
- SMOOTH FACE FIBRE CEMENT BOARD FASCIA AND TRIM
- BRICK ROWLOCK STOOP TOPPING
- 0'-0" FIRST FLOOR

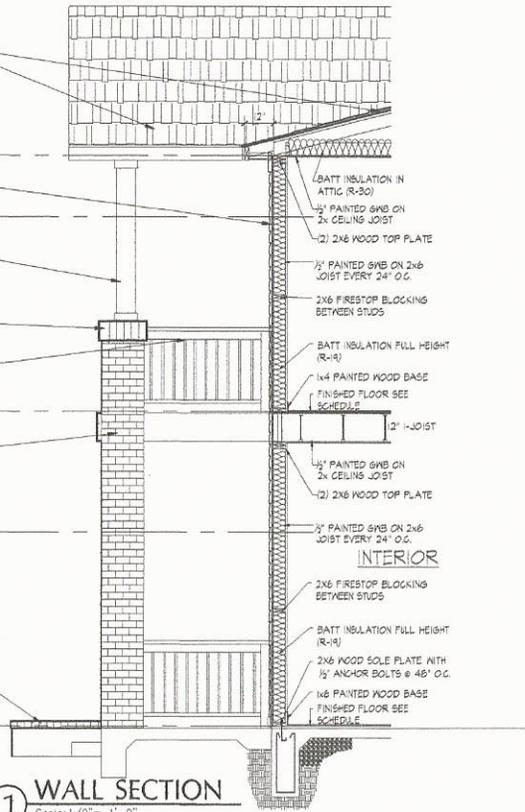

**1 WALL SECTION**  
 Scale: 1/2" = 1'-0"

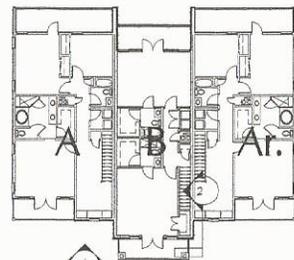

**BUILDING KEY**



**Dillard Architect Group**  
 768 Ripley Avenue  
 San Antonio, Texas  
 (210) 531-6000 office (210) 531-0074 fax  
 dillardgrp@aol.com

Scale:

UNPLANNED BLDG.  
 All work shall conform to the code of laws of the City of San Antonio, Texas. The City Engineer shall be notified by the contractor of all work to be done in the City of San Antonio, Texas.



# GREEN TOWNHOUSE

810 N. OLIVE ST.  
 SAN ANTONIO, TX. 78202


| No. | Revision/Issue: | Date: |
|-----|-----------------|-------|
|     |                 |       |

ENLARGED  
 ELEVATIONS  
 WALL SECTION



|              |                |            |
|--------------|----------------|------------|
| Drawn By: JS | Date: 05/10/06 | Scale: A-9 |
| Checked By:  |                |            |
| Project No.: |                | Sheet: 04  |

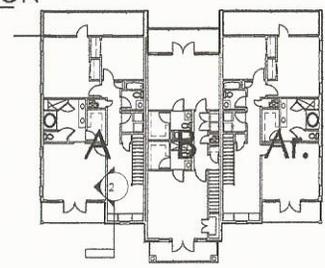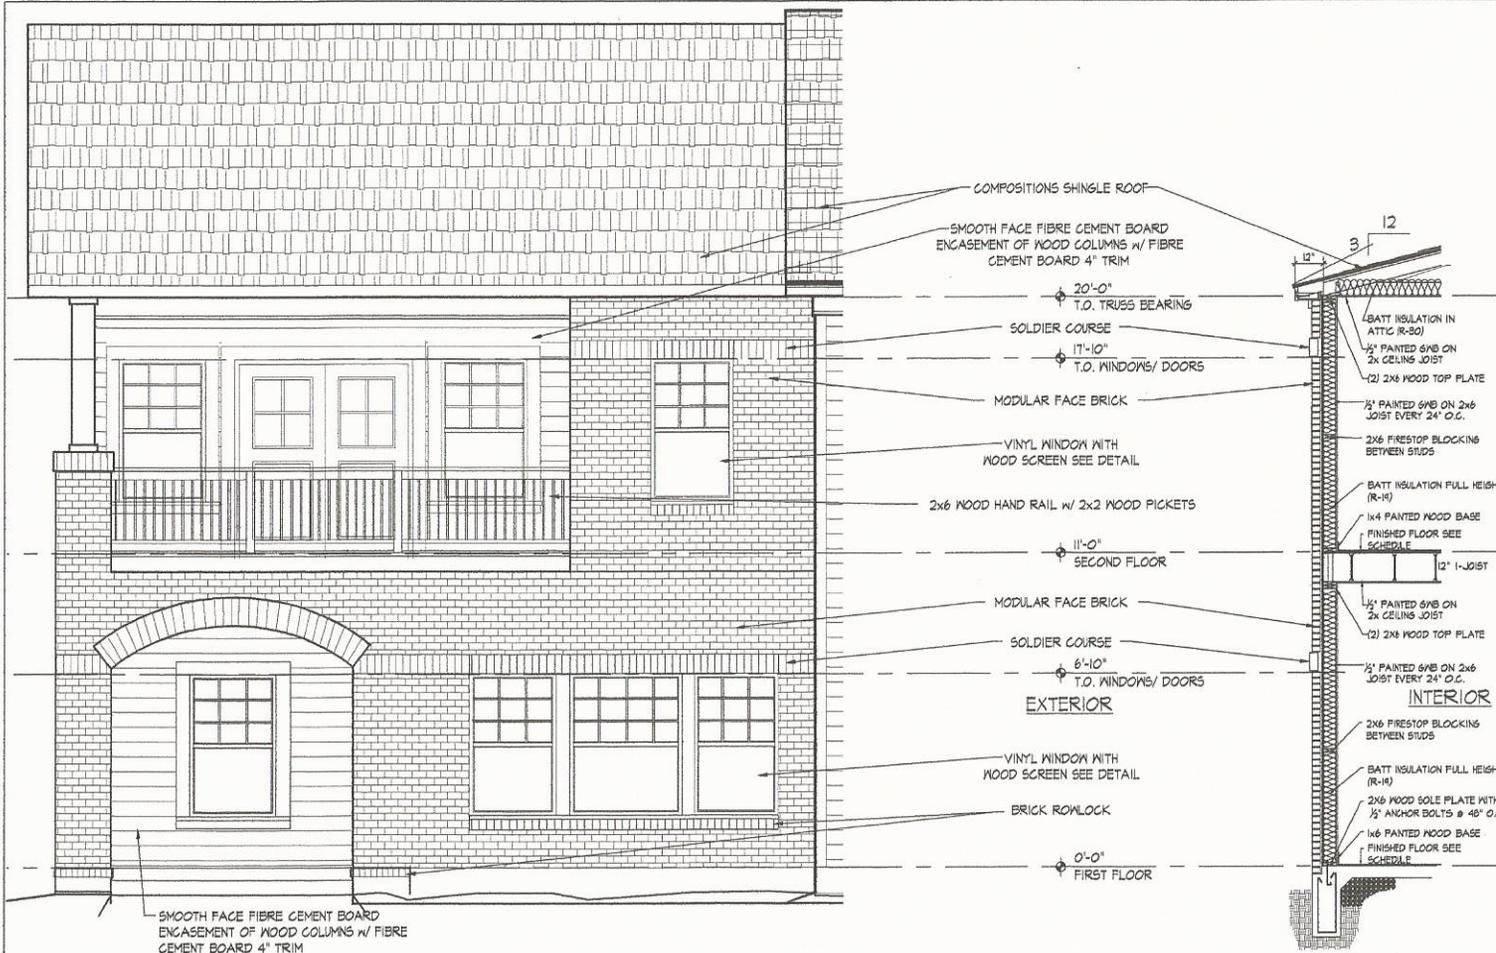


BUILDING KEY

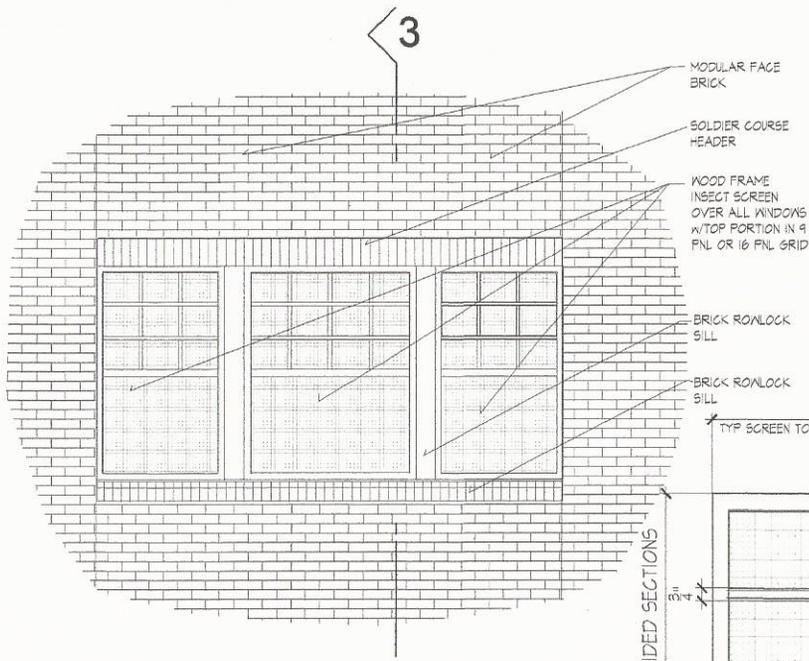


**1 WINDOW ELEVATION**  
Scale: N.T.S.

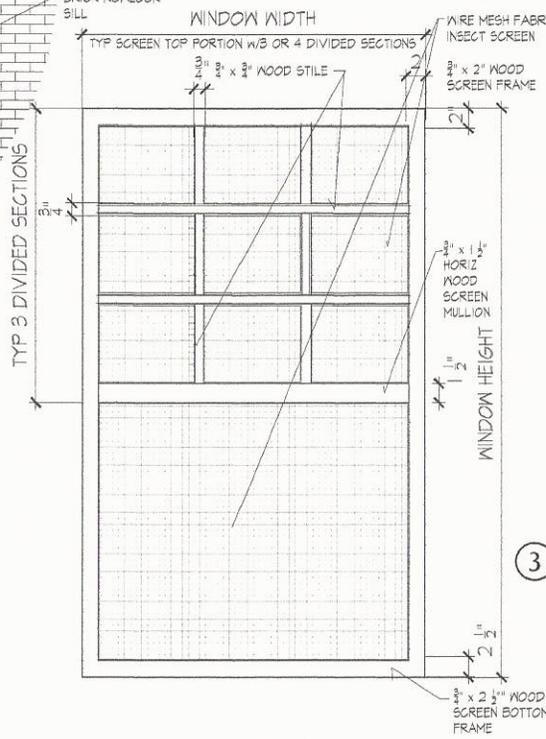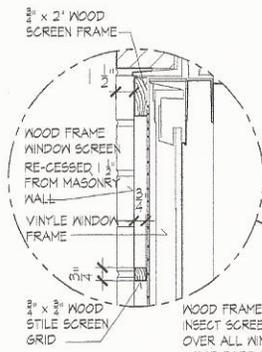

**2 WINDOW SCREEN ELEVATION**  
Scale: N.T.S.

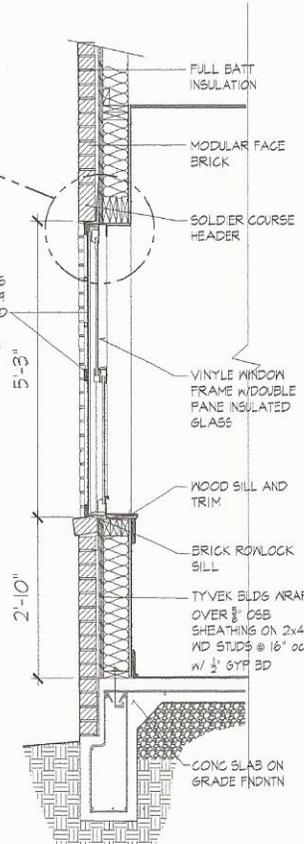

**3 WALL SECTION AT WINDOW**

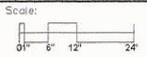

**lp**  
 Dillard Architect Group  
 708 Riggsby Avenue  
 6th Floor, Austin, TX 78701  
 (512) 511-0255 office (512) 531-0274 fax  
 dillard@lpgr.com

Architect's seal and stamp area.


**GREEN TOWNHOUSE**  
 810 N. OLIVE ST.  
 SAN ANTONIO, TX. 78202

|     |                 |       |
|-----|-----------------|-------|
| No. | Revision/Issue: | Date: |
|     |                 |       |

Sheet Name: **ENLARGED ELEVATIONS**

|              |                |                 |
|--------------|----------------|-----------------|
| Drawn By: JS | Date: 05/10/16 | Sheet No.: A-10 |
| Checked By:  |                |                 |
| Project No.: |                | Sheet Of:       |

**BRICK MASONRY**

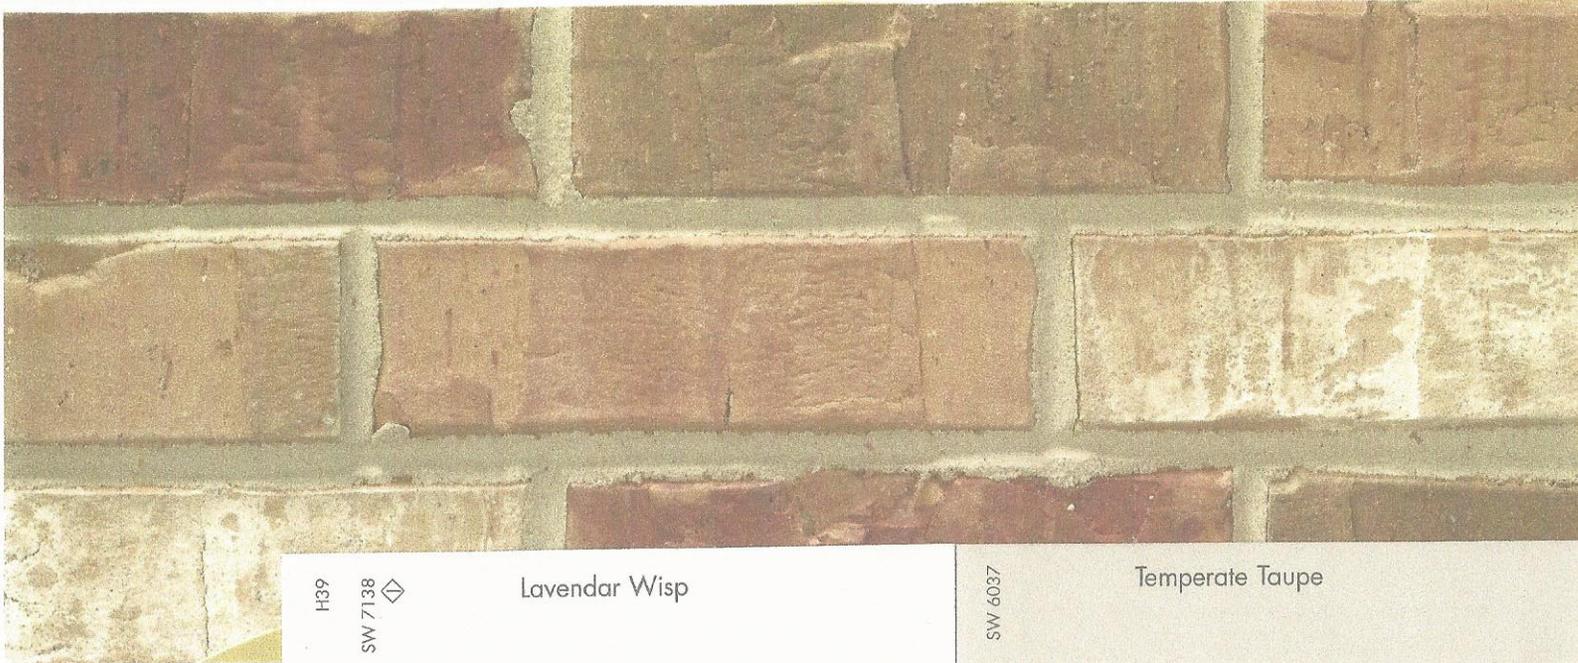

H39

SW 7138



Lavendar Wisp

SW 6037

Temperate Taupe



**ASPHALT SHINGLES**


**WOOD DOORS  
GARAGE DOORS  
WOOD SCREENS  
DOOR & WINDOW TRIM  
WOOD HANDRAILS  
HANDRAIL PICKETS  
WOOD COLUMNS  
WOOD FASCIA & SOFFITS**

**CEMENTIIOUS SIDING  
SIDING CORNER TRIM**



**Dillard Architect Group**  
708 Ripley Avenue  
San Antonio, Texas  
(210) 531-0220 office (210) 531-0074 fax  
dillarchgrp@aol.com

Check  
Date  
COPYRIGHT 2011  
All rights reserved. No part of this publication may be reproduced, stored in a retrieval system, or transmitted, in any form or by any means, electronic, mechanical, photocopying, recording, or by any information storage and retrieval system, without the prior written permission of the publisher.

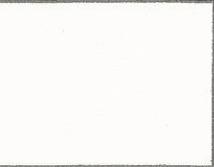

**GREEN TOWNHOUSE**

**810 OLIVE ST.  
SAN ANTONIO, TEXAS**

| Rev. | Revision/Reason | Date |
|------|-----------------|------|
|      |                 |      |
|      |                 |      |

**EXTERIOR  
COLOR/MATERIAL  
SELECTIONS**

| Color No. | Color | Material |
|-----------|-------|----------|
|           |       |          |
|           |       |          |
|           |       |          |

**EXHIBIT "2"**



806 N. OLIVE, HOUSE  
ADJACENT TO GREEN  
TOWNHOUSE COLUMNS  
AND INSET PORCH

802 N. OLIVE, GABLE  
TRIM AT EVE OF  
GABLE ROOF



900 BLOCK OF E. HOUSTON,  
HOUSE IN AREA W/ ARCHED  
OPENING AT FRONT PORCH  
AND SIDES

700 BLOCK OF N. OLIVE TYPICAL  
CHARACTER OF WOOD WINDOW  
SCREENS TO HAVE DECORATIVE  
WOOD STILES AT TO



EXTERIOR FEATURES ON HOUSE IN DIGNOWITY  
NEIGHBOR CAPTURED ON GREEN TOWNHOUSE

**HDRC - 810 N. OLIVE ST  
GREEN TOWNHOUSE PROJECT**



Dillard Architect Group  
708 Rigby Avenue  
San Antonio, Texas  
(210) 833-0025 with fax (210) 833-0074 fax  
dillard@dagc.com

Scale:  
  
DATE PLOTTED: 11/11/2011 10:58:11 AM  
PLOTTER: HP DesignJet T1100e  
PLOT FILE: C:\Users\jgarcia\Documents\Green Townhouse\Green Townhouse.dwg  
PLOT SCALE: 1/8" = 1'-0"

Project Name:  
Project No.:

Project Location:  
Project Description:

Project Architect:  
Project Engineer:

Project Designer:  
Project Checker:

Project Date:  
Project Status:

Project No.:

Project Name:  
Project No.:

Project Date:  
Project Status:

Project Location:  
Project Description:

**GREEN TOWNHOUSE  
810 OLIVE ST.  
SAN ANTONIO, TEXAS**

**EXHIBIT 2**

# "DIGNOWITY/LOCKWOOD PARK STREET-SCAPE MASSING RELATIONSHIPS"

Northeast  
Blk  
N. Olive St.  
Street-  
Scape



Southeast  
Blk N. Olive  
St. Street-  
Scape

HDCR CASE - 810 N. Olive St.-  
Green 3-Unit Townhouse Site



North  
Street-Scape,  
Hays St. Blk



800 N. Hackberry St. ,  
2-Story SAHA Apt Bldg



South  
Street-Scape,  
Nolan St. Blk



700 N. Hackberry St., 6-Story  
SAHA Sr Housing Apt Bldg

Northwest  
Blk  
N. Hackberry  
Street-Scape



Southwest  
Blk  
N. Hackberry  
Street-Scape

## HDCR - 810 N. OLIVE ST. - GREEN TOWNHOUSE PROJECT



Scale: \_\_\_\_\_  
Date: \_\_\_\_\_  
PROJECT TITLE: \_\_\_\_\_  
PROJECT LOCATION: \_\_\_\_\_  
DRAWN BY: \_\_\_\_\_  
CHECKED BY: \_\_\_\_\_  
DATE: \_\_\_\_\_

**GREEN TOWNHOUSE**  
810 OLIVE ST.  
SAN ANTONIO, TEXAS

| No. | Revision/Issue | Date |
|-----|----------------|------|
|     |                |      |
|     |                |      |
|     |                |      |

Sheet Name: **PARK MASSING**

| Drawn By | Check | Scale |
|----------|-------|-------|
|          |       |       |
|          |       |       |
|          |       |       |

**EXHIBIT**



812 N. OLIVE ST  
ONE STORY STRUCTURE  
WITH GARAGE APARTMENT

GREEN TOWNHOUSE RELATIONSHIP ON SITE TO  
ADJACENT HOUSE - LOOKING NORTH

**HDRC - 810 N. OLIVE ST  
GREEN TOWNHOUSE PROJECT**



**Dillard Architect Group**  
728 Algeza Avenue  
San Antonio, Texas  
(210) 621-0850 office (210) 621-0074 fax  
d@archgr.com

Sheet:  
  
DATE PLOTTED: 02/10/2011 10:00:00 AM  
PLOTTER: HP DesignJet T1100e  
PLOT FILE: C:\Users\jgarcia\Documents\Green Townhouse\Green Townhouse.dwg

**GREEN TOWNHOUSE**  
810 OLIVE ST.  
SAN ANTONIO, TEXAS

|      |                 |       |
|------|-----------------|-------|
| No.: | Revision/Issue: | Date: |
|      |                 |       |

Sheet Name:  
**EXHIBIT**

|             |      |       |
|-------------|------|-------|
| Sheet No.   | Date | Scale |
|             |      |       |
| Project No. |      |       |



CITY OF SAN ANTONIO  
OFFICE OF HISTORIC  
PRESERVATION

Historic and Design Review Commission  
Design Review Committee  
Report & Recommendation

DATE: 6/23/15

HDRC Case# \_\_\_\_\_

ADDRESS: 810 N. Olive

Meeting Location: 1901 S. Alamo

APPLICANT: Stephen Green

DRC Members present: \_\_\_\_\_

Staff present: Adriana Zign


Others present: \_\_\_\_\_

REQUEST: Construct 3 new units.

COMMENTS/CONCERNS: TC - are you working w/ designer/architect?  
 SG - my son contacted a designer. Elevation doesn't matter  
 plan. Context? SG - Frame house, on the corner of  
 next block there is original Dignovity house which is brick.  
 Mixture of structural, one and 2 story.  
 MC - Internal lot, w/ driveway and parking at back.  
 BF - What's happening at rear? SG - eventually build at rear.  
 MG - more information; aerial view, pictures.  
 TC - where it sits on block, setback w/ other houses.  
 Language of other houses, show neighbors. Elevations:  
 how it relates to other houses, proposed colors, materials,  
 detailing of porch & columns, specs. for windows/doors.  
 MG - Helpful to look for patterns in neighborhood.  
 Not something you see in SA, more like east coast, dif. bldg.  
 types from what's in neighborhood.  
 TC - study other buildings in neighborhood.

COMMITTEE RECOMMENDATION: APPROVE [ ] DISAPPROVE [ ]  
 APPROVE WITH COMMENTS/STIPULATIONS:  
NO ACTION

REVISE & RETURN

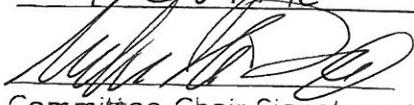  
 Committee Chair Signature (or representative)

6/23/15  
 Date



CITY OF SAN ANTONIO  
OFFICE OF HISTORIC  
PRESERVATION

Historic and Design Review Commission  
Design Review Committee  
Report & Recommendation

DATE: 6/23/15

HDRC Case# \_\_\_\_\_

ADDRESS: 810 N. Olive

Meeting Location: 1901 S. Alamo

APPLICANT: Stephen Green

DRC Members present: \_\_\_\_\_

Staff present: Adriana Zign

Others present: \_\_\_\_\_

REQUEST: Construct 3 new units.

COMMENTS/CONCERNS: TC - are you working w/ designer/architect?  
 SA - my son contacted a designer. Elevation doesn't matter  
 plan. Context? SB - Frame house, on the corner of  
 next block there is original Dignovity house which is brick.  
 Mixture of structural, one and 2 story.

MC - internal lot, w/ driveway and parking at back.

BF - what's happening at rear? SG - eventually build at rear.

MG - more information; aerial view, pictures.

TC - where it sits on block, setback w/ other houses.

Language of other houses, show neighbors. Elevations:  
 how it relates to other houses, proposed colors, materials,  
 detailing of porch & columns, specs. for windows/doors.

MG - Helpful to look for patterns in neighborhood.

Not something you see in SA, more like east coast, dif. bldg.  
 types from what's in neighborhood.

TC - study other buildings in neighborhood.

COMMITTEE RECOMMENDATION: APPROVE [ ] DISAPPROVE [ ]

APPROVE WITH COMMENTS/STIPULATIONS:

NO ACTION

REVISE & RETURN

  
Committee Chair Signature (or representative)

6/23/15  
Date



CITY OF SAN ANTONIO  
**OFFICE OF HISTORIC  
PRESERVATION**

**Historic and Design Review Commission  
Design Review Committee  
Report & Recommendation**

DATE: 1/26/16

HDRC Case# 2016-3956

ADDRESS: 810 N OLIVE

Meeting Location: KING William Rm

APPLICANT: PORTER DILLARD

DRC Members present: JOHN LAFCON, KENT BRITTON, Michael Guzman  
*came late*

Staff present: Lauren Sage

Others present: LIZ FRANKLIN, ~~ALICE~~ BETTY Green

REQUEST: CONCEPTUAL APPROVAL FOR NEW CONSTRUCTION

COMMENTS/CONCERNS: PD: KB: are there new construction with vinyl in DH? - JL: BRING EX OF THOSE New and documentation construction w vinyl KB: Neoclassical scaling is consistent w ex.s provided. He does not have issues w massing.

JL: similar to KWIA that have large next to sm properties

MG: RECAP, does not have issue. he likes thoroughness of presentation LF: initially concern, though exciting b/c last large view of DT,

MG: ISSUES OF ELEVATION OF PARKING/GARAGE element. B/c concealed, seems very appropriate. JL: expand on landscape plan

COMMITTEE RECOMMENDATION: APPROVE [ ] DISAPPROVE [ ]  
APPROVE WITH COMMENTS/STIPULATIONS: →

Req present to full HDR Commission

[Signature]  
Committee Chair Signature (or representative)

1/26/16  
Date

MEs: other conflict if the breadth or size, so take better picture of large next door structure

*[Faint, illegible handwritten text, likely bleed-through from the reverse side of the page]*



CITY OF SAN ANTONIO  
OFFICE OF HISTORIC  
PRESERVATION

Historic and Design Review Commission  
Design Review Committee  
Report & Recommendation

DATE: 8/25/2015

HDRC Case# 2015-264

ADDRESS: 810 N OLIVE

Meeting Location: 1401 S ALAMO

APPLICANT: PORTER WILLARD

DRC Members present: MICHAEL CONNOR, MICHAEL GUARINO, PAT AIGIOVANNI

Staff present: EMMA HALL

Others present: STEPHEN GREEN

REQUEST: CONSTRUCTION OF A DUPLEX ON A VACANT LOT - THREE UNITS

COMMENTS/CONCERNS: MC: QUESTIONS OVER SCALE AND PROPORTIONS OF DRAWINGS - , FOCUS ON REAR ELEVATION NEXT, CORRECT APPROACH FOR DESIGN. MC: FULL BALCONIES DIVIDE THE BUILDING INTO INDIVIDUAL UNITS (OPTION A) APPROPRIATE, MASSING AND MATERIALS. MG: OTHER DETAILS ARE APPROPRIATE. MC: ELIMINATE FRONT CABLES OF OPTION A. MG: QUESTIONS OVER MATERIALS OVER PORCH INSET. PROJECT WILL ENHANCE THE NEIGHBORHOOD.

COMMITTEE RECOMMENDATION: APPROVE [] DISAPPROVE []  
APPROVE WITH COMMENTS/STIPULATIONS:

combine options

REVISE ELEVATION & SUBMIT

  
Committee Chair Signature (or representative)

8/25/15  
Date



CITY OF SAN ANTONIO  
**OFFICE OF HISTORIC  
 PRESERVATION**

**Historic and Design Review Commission  
 Design Review Committee  
 Report & Recommendation**

DATE: 10/14/2015 HDRC Case# \_\_\_\_\_

ADDRESS: 810 N OLIVE Meeting Location: 1901 S ALAMO - TRAINING ROOM

APPLICANT: STEPHEN GREEN / PORTER ALLARD

DRC Members present: DANIEL LAZARINE

Staff present: EDWARD HALL, LAUREN SAGE

Others present: LIZ FRANKLIN, BETTY GREEN

REQUEST: CONSTRUCTION OF 3, ATTACHED UNITS ON A VACANT LOT

COMMENTS/CONCERNS: ALL QUESTIONS REGARDING POTENTIAL ALLEGORY  
 STRUCTURES ON SITE/NO. NO PRECEDENT IN AIGNOVITY HILL FOR THE  
 PROPOSED ARCHES - THE PROPOSAL DOES NOT FIT IN WITH THE ~~PROPOSED~~  
 PROPOSED DESIGN. RECOMMENDS THE APPLICANT DEVOTE MORE TIME  
 TO THE PRESENTATION - BETTER PRODUCED RENDERINGS. APPLICANT  
 SHOULD STRESS THROUGH PRESENTATION THE IMPORTANCE OF PROPOSAL  
 AND PROPERTY. RECOMMENDS THE APPLICANT RETURNS TO THE HARC  
 ON NOVEMBER 14.

COMMITTEE RECOMMENDATION: APPROVE [ ] DISAPPROVE [ ]  
 APPROVE WITH COMMENTS/STIPULATIONS:

APPLICANT ADVISED TO ADD MORE INFORMATION TO  
 PRESENTATION & TO LOOK AT PROJECT MORE WHOLISTICALLY

Daniel J. S.  
 Committee Chair Signature (or representative)

10/14/2015  
 Date



CITY OF SAN ANTONIO  
**OFFICE OF HISTORIC  
 PRESERVATION**

**Historic and Design Review Commission  
 Design Review Committee  
 Report & Recommendation**

DATE: MAY 24, 2016 HDRC Case# 2016-049

ADDRESS: 810 N OLIVE Meeting Location: 1901 S ALAMO

APPLICANT: PORTER BILARA - BILARA ARCHITECT GROUP

DRC Members present: JOHN LAFDON, DESIREE SALMON, EDUARDO GARZA

Staff present: EDUARDO HALL

Others present: \_\_\_\_\_

REQUEST: NEW CONSTRUCTION OF THREE ATTACHED MULTI-FAMILY  
 UNITS - FINAL APPROVAL

COMMENTS/CONCERNS: AS: QUESTIONS REGARDING THE PROPOSED  
 SETBACKS IN RELATIONSHIP TO NEIGHBORING STRUCTURES. JL:  
 PROPOSED WIDTH AND MASS IS A CHALLENGE FOR RECEIVING  
 FINAL APPROVAL. AS: USUALLY TREES WOULD BE APPROPRIATE  
 TO EASE MASSING. JL: THE ELIMINATION OF THE GABLES IS  
 APPROPRIATE. NOTE PREVIOUS REVISIONS AT HDRL.

**COMMITTEE RECOMMENDATION:** APPROVE [ ] DISAPPROVE [ ]  
**APPROVE WITH COMMENTS/STIPULATIONS:**

John Lafdon  
 Committee Chair Signature (or representative)

5.24.16  
 Date