



SITE NAME: SA60XC296/ CITY OF SAN ANTONIO

OWNER/APPLICANT FOR

SITE ACQ.:

1 INTERNATIONAL BOULEVARD SUITE #800 MAHWAH. N.J. 07495

728 Shades Creek PKWY

CRAFTON

FCC NUMBER: 1223931

STRUCTURE TYPE: SELF-SUPPORT TOWER

SAN ANTONIO MARKET:

> EQUIPMENT SCHEDULES ARE BASED ON RFD SA60XC296 RFDS vB1 20120712

Homewood, AL 35209 Tel: (205) 682-7525 CONSULTANT: PROJECT SUMMARY LIST OF DRAWINGS DRIVING DIRECTIONS VICINITY MAP SITE GENERAL ARRANGEMENT PLANS FROM SAN ANTONIO, TAKE I-35S TOWARD I-10E/US SITE NAME: SA60XC296/CITY OF SAN ANTONIO ENGINEERING GROUP, INC. 87 S. GO 2.3 MI AND TAKE EXIT 152A/DIVISION AVE TITLE SHEET FCC NUMBER: 1223931 ONTO S PANAMA EXPY. GO 0.5 MI AND TURN RIGHT together planning a better tom ON DIVISION AVE. GO 1 MI AND BEAR LEFT ON NOGALITOS ST. GO 0.1 MI AND BEAR RIGHT ON AMES 911 ADDRESS: 4719 S ZARZAMORA SAN ANTONIO, TX 78225 158 BUSINESS CENTER DRIVE BIRMINGHAM, AL 35244 TEL: 205-252-6985 FAX: 205-320-1504 T-2 GENERAL NOTES AVE. GO 0.2 MI AND TURN RIGHT ON S ZARZAMORA GENERAL NOTES McGargle St Fickel St APN#: N/P ST. ARRIVE AT SITE ON LEFT. losack Ave 353 Division Ave GENERAL NOTES LATTITUDE: 29.37841° SITE NAME: LONGITUDE: -98.53709* ARCHITECTURAL / CIVIL PLANS **SA60XC296** GROUND ELEVATION: 300' AMSL OVERALL SITE PLAN JURISDICTION: BEXAR COUNTY SHERIFF OFFICE Keats St 4-2 ENLARGED SITE PLANS FCC NUMBER: ZONING: Brighton St EQUIPMENT SITE PLANS 1223931 A-4 SITE ELEVATION & ANTENNA DETAILS Elks Dr SITE ADDRESS: Barnett Ave PHASE 1 SCOPE OF WORK 4-5 ANTENNA SCHEDULE 4719 S ZARZAMORA Humboldt St SAN ANTONIO, TX 78225 **EQUIPMENT SCHEDULE** BEXAR COUNTY SHERIFF OFFICE THE WIRELESS COMMUNICATIONS FACILITY IS NOT INTENDED ANTENNA PLUMBING DIAGRAM FOR HUMAN OCCUPANCY THIS FACILITY DOES NOT REQUIRE POTABLE WATER AND WILL 8-A ENLARGED ANTENNA PLANS & COAX RUN DIAGRAM NOT PRODUCE ANY SEWAGE. Berlin Ave THE SCOPE OF WORK CONSISTS OF MODIFYING THE A-9 EXISTING COLOR CODE EXISTING WIRELESS INSTALLATION: A. RELOCATE EXISTING EQUIPMENT CABINETS PER PLANS PROPOSED COLOR CODE CONTACTS **APPROVALS** RE-ROUTE POWER AND TELCO AS SPECIFIED CABINET DETAILS INSTALL NEW RBS & BBS AS SPECIFIED APPLICANT: ROUTE NEW POWER & TELCO AS SPECIFIED A-12 RRU DETAILS INSTALL NEW ANTENNAS, RRU'S, & FIBER CABLE PER SPRINT PCS ELECTRICAL PLANS 1 INTERNATIONAL BOULEVARD ERICSSON CONSTRUCTION MANAGER DEVLIN HARRIS, (832) 876-7929 DATE JEREMY D. SHARIT ROUTE NEW FIBER HYBRID CABLE TO EACH SECTOR AS SUITE #800 ENLARGED UTILITY SITE PLAN MAHWAH, N.J. 07495 UTILITY SITE PLAN -2 201-684-4000 PHASE 2 SCOPE OF WORK ERICSSON RF ENGINEERING ERAY OZKAN, (972) 322-0902 NOT USED. -3 TOWER OWNER BEXAR COUNTY SHERIFF OFFICE THE WIRELESS COMMUNICATIONS FACILITY IS NOT INTENDED GROUNDING PLANS - FINAL FOR HUMAN OCCUPANCY FCC NO. 1223931 ERICSSON SITE ACQUISITION MANAGER DEBRA CHRISTIAN, (208) 794-8899 DATE **ELECTRICAL & GROUNDING DETAILS** THIS FACILITY DOES NOT REQUIRE POTABLE WATER AND WILL PHONE: 210-207-8888 NOT PRODUCE ANY SEWAGE. E-6 GROUNDING DETAILS THE SCOPE OF WORK CONSISTS OF MODIFYING THE TRAWN BY SMW #: EXISTING WIRELESS INSTALLATION: SPRINT CONSTRUCTION MANAGER APPROVED BY: REMOVE 6 EXISTING CDMA ANTENNAS JDS 11-080 REMOVE ALL EXISTING COAX, TMA, ETC. DATE DRAWN: 08/05/11 DRAWING SCALES ARE FOR 24"X36" SHEETS UNLESS OTHERWISE REMOVE EXISTING CABINETS **ENGINEER:** REVISION THE ABOVE PARTIES HEREBY APPROVE AND ACCEPT THESE DOCUMENTS SMW ENGINEERING GROUP, INC. AND AUTHORIZE CONTRACTOR TO PROCEED WITH THE CONSTRUCTION DESCRIBED HEREIN. ALL DOCUMENTS ARE SUBJECT TO REVIEW BY THE NO DESCRIPTION 1550 WOODS OF RIVERCHASE DRIVE Λ SUBMISSION: 90% CD JDS 08/05/1 LOCAL BUILDING DEPARTMENT AND MAY IMPOSE CHANGES OR SUBMISSION: 100% CDJDS 01/15/12 CONTACT: JEREMY SHARIT, P.E. SUB: REV PER RFDS DCP 07/23/1 APPLICABLE CODES & STANDARDS PHONE: 205-453-1892 SUB: REV PER CLIENT DCP 08/16/12 SUB: REV PER STRUC.DCP 10/10/12 SURVEYOR: - INTERNATIONAL BUILDING CODE, 2003 EDITION AS ADOPTED BY LOCAL SUB: SEALED FINALS JDS 10/16/12 NA SUB: REV. FINALS JDS 07/31/1 - NATIONAL ELECTRICAL CODE, 2008 EDITION AS ADOPTED BY LOCAL TELEPHONE COMPANY: JURISDICTION. SHEET TITLE: **TEXAS ONE-CALL** - UNIFORM MECHANICAL CODE, 2000 EDITION AS ADOPTED BY LOCAL SOUTHWESTERN BELL TITLE SHEET STATE WIDE: 811 (210) 821-4105 - INTERNATIONAL ENERGY CONSERVATION CODE, 2008 CITY OF SAN CALL BEFORE YOU DIG SHEET NUMBER: ANTONIO COMMERCIAL ENERGY CODE (ANSI/ASHRAE/IESNA 90.1-2004) POWER COMPANY: CPS (800) 870-1006

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PRODUCTS MD MATERIALS

CONCRETE REINFORCEMENT

CAST-IN PLACE CONCRETE

CONCRETE FORMWORK

STRUCTURAL STEEL

GROUNDING

LANDSCAPING

COMPLY WITH THESE STANDARDS UNLESS OTHERWISE REQUIRED BY APPLICABLE CODES

1.0 CONSTRUCTION TO CONFORM TO SPRINT NEXTEL INTEGRATED CONSTRUCTION STANDARDS

PURPOSE AND INTENT

A. THE DRAWINGS AND SPECIFICATIONS ARE INTENDED TO BE FULLY EXPLANATORY AND SUPPLEMENTARY, HOWEVER, SHOULD ANYTHING BE SHOWN, INDICATED OR SPECIFIED ON ONE AND NOT THE OTHER, IT SHALL BE DONE THE SAME AS IF SHOWN, INDICATED OR SPECIFIED IN BOTH. SHOULD THERE BE ANY DISCREPANCIES BETWEEN REQUIREMENTS SHOWN IN BOTH, THE MORE STRINGENT REQUIREMENTS SHALL APPLY.

THE INTENTION OR THE DOCUMENTS IS TO INCLUDE ALL LABOR AND MATERIALS REASONABLY NECESSARY FOR THE PROPER EXECUTION AND COMPLETION OF THE WORK AS STIPULATED IN THE CONTRACT.

C. THE PURPOSE OF THE SPRINT WIRELESS CONSTRUCTION SPECIFICATIONS IS TO INTERPRET THE INTENT OF THE DRAWINGS AND TO DESIGNATE THE METHOD OF THE PROCEDURE, TYPE AND QUALITY OF MATERIALS REQUIRED TO COMPLETE THE WORK.

1.2 CONFLICTS

A. VERIFY ALL MEASUREMENTS AT THE SITE BEFORE ORDERING MATERIAL OR DOING ANY WORK. NO EXTRA CHARGE OR COMPENSATION WILL BE ALLOWED DUE TO DIFFERENCES BETWEEN ACTUAL DIMENSIONS OR DIMENSIONS SHOWN ON PLANS. SUBMIT NOTICE OF ANY DISCREPANCY IN DIMENSIONS OR OTHERWISE TO SPRINT WIRELESS FOR RESOLUTION BEFORE PROCEEDING WITH THE WORK

B. NO PLEA OF IGNORANCE OF CONDITIONS THAT EXIST OR OF DIFFICULTIES OF CONDITIONS THAT MAY BE ENCOUNTERED, OR OF ANY OTHER RELEVANT MATTER CONCERNING THE EXECUTION OF THE WORK WILL BE ACCEPTED AS AN EXCUSE FOR ANY FAILURE OR OMISSION ON THE PART OF THE CONTRACTOR TO FULFILL EVERY DETAIL OF ALL THE REQUIREMENTS OF THE CONSTRUCTION DOCUMENTS GOVERNING THE WORK.

1.3 CLEANING

KEEP THE SITE FREE FROM ACCUMULATION OF WASTE AND RUBBISH CAUSED BY EMPLOYEES AT THE COMPLETION OF THE WORK. REMOVE ALL WASTE AND NON-CONSTRUCTION MATERIAL INCLUDING ALL CONTRACTOR TOOLS, SCAFFOLDING AND SURPLUS MATERIAL AND LEAVE SITE CLEAN AND READY FOR USE.

CONTRACTOR SHALL. BE RESPONSIBLE FOR FOLLOWING ALL LAWS, REGULATIONS AND RULES PROMULGATED BY FEDERAL STATE AND LOCAL AUTHORITIES WITH JURISDICTION OVER THE SITE. THIS RESPONSIBILITY IS IN EFFECT REGARDLESS OF WHETHER THE LAW, ORDINANCE, REGULATION OR RULE IS MENTIONED IN THESE SPECIFICATIONS.

HAVE AND MAINTAIN A VALID CONTRACTORS LICENSE FOR THE LOCATION IN WHICH THE WORK IS TO BE PERFORMED. FOR JURISDICTIONS THAT LICENSE INDIVIDUAL TRADES, THE TRADESMAN OR SUBCONTRACTORS PERFORMING THOSE TRADES SHALL BE LICENSED. RESEARCH AND COMPLY WITH LICENSING LAWS, PAY LICENSE FEES, AND SELECT AND INFORM SUBCONTRACTORS REGARDING THESE LAWS.

FOLLOW ALL APPLICABLE RULES AND REGULATIONS OF THE OCCUPATIONAL SAFETY AND HEALTH ADMINISTRATIONS, AND STATE LAWS BASED IN THE FEDERAL OCCUPATIONAL SAFETY AND HEALTH ACT. THESE REGULATIONS INCLUDE BUT ARE NOT LIMITED TO REGULATIONS DEALING WITH TOWER CONSTRUCTION AND SAFETY, EXCAVATIONS AND TRENCHING, AND WORK IN CONFINED SPACES. ENSURE THAT EMPLOYEES AND SUBCONTRACTORS WEAR HARD HATS AT All TIMES DURING CONSTRUCTION.

1.7 PHOTOS

PROVIDE PHOTOGRAPHIC EVIDENCE OF ALL FOUNDATION INSTALLATION, GROUNDING AND TRENCHING AFTER PLACEMENT OF UTILITIES PRIOR TO BACKFILL.

SPRINT WIRELESS WILL SUBMIT CONSTRUCTION DOCUMENTS TO THE JURISDICTIONAL AUTHORITY FOR PLAN CHECK AND REVIEW. CONTRACTOR WILL SUBMIT LICENSING AND WORKMAN'S COMPENSATION INFORMATION TO THE JURISDICTION AS REQUIRED TO OBTAIN THE BUILDING PERMIT. CONTRACTOR SHALL COORDINATE AND SCHEDULE REQUIRED INSPECTIONS AND POST REQUIRED PERMITS AT THE JOB SITE. COMPLY WITH SPECIFIC PROJECT—RELATED REQUESTS AND SUGGESTIONS MADE BY BUILDING INSPECTOR AND INFORM CONSTRUCTION MANAGER OF ANY SUCH WORK THAT MAY BE BEYOND THE SCOPE OF THE CONTRACT OR DEVIATE FROM THE CONSTRUCTION DOCUMENTS. SPRINT WIRELESS WILL REIMBURSE THE CONTRACTOR FOR FEES FOR PLAN REVIEW, BUILDING PERMIT. CONNECTIONS AND INSPECTION.

1.9 ZONING REGULATIONS AND CONDITIONAL USE PERMITS

SPRINT WIRELESS WILL SUBMIT FOR AND OBTAIN ALL ZONING AND CONDITIONAL USE PERMITS. SOME USE PERMITS MAY HAVE SPECIFIC REQUIREMENTS RELATED TO THE CONSTRUCTION SUCH AS NOISE REGULATIONS, HOURS OF WORK, ACCESS LIMITATIONS, ETC. THE CONSTRUCTION MANAGER WILL INFORM THE CONTRACTOR OF THESE REQUIREMENTS AT THE PRE-BID MEETING OR AS SHOWN IN CONSTRUCTION DOCUMENTS.

1.10 FM PERMIT AND TOWER LIGHTING

REFER TO CONSTRUCTION DOCUMENTS AND CONSTRUCTION MANAGER FOR FAA AND STATE LIGHTING REQUIREMENTS. CONTRACTOR SHALL PROVIDE TEMPORARY FM APPROVED LIGHTING UNTIL PERMANENT LIGHTING IS OPERATIONAL

1.11 TOWER SECURITY

TOWER MUST BE FENCED, TEMPORARILY OR PERMANENTLY WITHIN 24 HOURS OF ERECTION. DO NOT ALLOW THE GATE ACCESSING THE TOWER AREA TO REMAIN OPEN OR UNATTENDED AT ANY TIME FOR ANY REASON. KEEP THE GATE CLOSED AND LOCKED WHEN NOT IN USE.

1.12 SITE CONTROL

A. THE CONTRACTOR IS COMPLETELY RESPONSIBLE FOR CONTAINMENT OF SEDIMENT AND CONTROL OF EROSION AT THE SITE. ANY DAMAGE TO ADJACENT OR DOWNSTREAM PROPERTIES WILL BE CORRECTED BY THE CONTRACTOR AT NO EXPENSE TO SPRINT WIRELESS.

THE CONTRACTOR IS TO MAINTAIN ADEQUATE DRAINAGE AT ALL TIMES. DO NOT ALLOW WATER TO STAND OR POND. ANY DAMAGE TO STRUCTURES OR WORK ON THE SITE CAUSED BY INADEQUATE MAINTENANCE OF DRAINAGE PROVISIONS WILL BE THE RESPONSIBILITY OF THE CONTRACTOR AND ANY COST ASSOCIATED WITH REPAIRS FOR SUCH DAMAGE WILL BE AT THE CONTRACTOR'S EXPENSE.

C. ALL WASTE MATERIAL SHALL BE PROPERLY DISPOSED OF OFF-SITE OR AS DIRECTED BY THE CONSTRUCTION MANAGER AND IN ACCORDANCE WITH JURISDICTIONAL OWNER/APPLICANT FOR:

SUITE #800 MAHWAH, N.J. 07495

CRAFTON

1 INTERNATIONAL BOULEVARD

728 Shades Creek PKWY Homewood, AL 35209 Tel: (205) 682-7525

CONSULTANT:

SITE ACQ.:



together planning a better tom 158 BUSINESS CENTER DRIVE BIRMINGHAM, AL 35244
TEL: 205-252-6985 FAX: 205-320-1504


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SITE ADDRESS: 4719 S ZARZAMORA SAN ANTONIO, TX 78225 BEXAR COUNTY SHERIFF OFFICE



DRAWN BY!	JHB	SMW #:
APPROVED BY:	JDS	11-0802
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A	SUB: REV. FINALS	JDS	07/31/1
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GENERAL NOTES

4.2 PIPE DETECTION AND IDENTIFICATION

A. UTILIZING WARNING TAPE: ALL ELECTRIC SERVICE TRENCHES SHALL BE MARKED WITH WARNING TAPE.

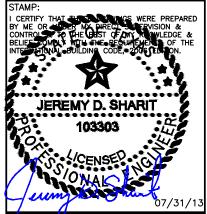4.3 TRENCH EXCAVATION

- A. DIG TRENCH TO LINES AND GRADES SHOWN ON THE PLANS OR AS DIRECTED BY CONSTRUCTION MANAGER.
- B. TRENCH LENGTH SHALL BE SUFFICIENT TO ALLOW FOR SATISFACTORY CONSTRUCTION AND INSPECTION OF THE PROJECT WITHOUT ENDANGERING OTHER CONSTRUCTION WORK OR ADJACENT FACILITIES.
- DISPOSE OF EXCESS AND UNSUITABLE EXCAVATION MATERIAL PROPERLY, AS DIRECTED BY CONSTRUCTION MANAGER.
- D. USE HAND METHODS FOR EXCAVATION THAT CANNOT BE ACCOMPLISHED WITHOUT ENDANGERING EXISTING OR NEW STRUCTURES OR OTHER FACILITIES.

4.4 TRENCH PROTECTION

- A. PROVIDE MATERIALS, LABOR AND EQUIPMENT NECESSARY TO PROTECT TRENCHES AT ALL TIMES.
 - B. SHEETING AND BRACING: MEET OR EXCEED OSHA REQUIREMENTS.

4.5 BACKFILLING

- NOTIFY THE CONSTRUCTION MANAGER AT LEAST 24 HOURS IN ADVANCE OF BACKFILLING.
- B. BACKFILL TRENCH WITH LIFTS UP TO 12 INCHES, LOOSE MEASURE. PROTECT CONDUIT FROM LATERAL MOVEMENT, DAMAGE FROM IMPACT OR UNBALANCED LOADING TO AVOID DISPLACEMENT OF CONDUIT AND/OR STRUCTURES. DO NOT FREE FALL BACKFILL INTO TRENCH UNTIL AT LEAST 12 INCHES OF COVER IS OVER THE CONDUIT.

4.6 COMPACTION

- A. COMPACT BACKFILL TO A 95 PERCENT COMPACTION AT A MAXIMUM DRY DENSITY AS DETERMINED BY ASTM 0-1557 OR WITHIN PLUS OR MINUS 3 PERCENT OF OPTIMUM MOISTURE CONTENT.
- IF REQUIRED COMPACTION DENSITY HAS NOT BEEN OBTAINED, REMOVE THE BACKFILL FROM THE TRENCH OR STRUCTURE, REPLACE WITH APPROVED BACKFILL AND RECOMPACT AS SPECIFIED.
- C. ANY SUBSEQUENT SETTLEMENT OF TRENCH OR STRUCTURE BACKFILL DURING MAINTENANCE PERIOD SHALL BE CONSIDERED THE RESULT OF IMPROPER COMPACTION AND SHALL BE PROMPTLY CORRECTED.

3.11 GRAVEL SURFACING

- CONSTRUCT GRAVEL SURFACING AREAS USING CRUSHED AGGREGATE BASE AND FINISH COURSES AS SPECIFIED BY CONSTRUCTION MANAGER OR CONSTRUCTION DOCUMENTS.
 - SPREAD GRAVEL AND RAKE TO OBTAIN A UNIFORM SURFACE AREA.

4.0 TRENCHING

CALL LOCAL UNDERGROUND UTILITY LOCATING SERVICE BEFORE ANY EXCAVATION OR TRENCHING.

4.1 MATERIALS

FILL MATERIAL SHALL BE OBTAINED, WHEN POSSIBLE FROM MATERIALS EXCAVATED FROM TRENCHES. ON—SITE STRUCTURAL FILL SAND OR SLURRY SHALL BE APPROVED BY THE CONSTRUCTION MANAGER AND SHALL CONFORM TO LOCAL GOVERNING JURISDICTIONS AND UTILITY COMPANY REQUIREMENTS. THE FILL MATERIAL SHALL CONTAIN NO ORGANIC MATERIAL OR ROCKS, NOR SHALL CONTAIN OBJECTIONABLE MATERIALS AND/OR MATERIALS DESIGNATED AS HAZARDOUS OR INDUSTRIAL BY THE ENVIRONMENTAL PROTECTION AGENCY (EPA). THE FILL MATERIAL SHALL CONTAIN FINES SUFFICIENT TO FILL ALL VOIDS IN THE MATERIAL COMPACTION OF BACKFILL OR BORROW SOIL SHALL BE PLACED IN 12 INCH LOOSE LIFTS WHEN UTILIZING HEAVY COMPACTION EQUIPMENT OR 6 INCH LOOSE LIFTS WHEN UTILIZING HAND OPERATED TAMPERS.



1 INTERNATIONAL BOULEVARD MAHWAH, N.J. 07495

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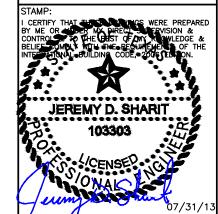
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А	SUB: REV. FINALS	JDS	07/31/1

GENERAL NOTES

SHEET NUMBER:

10.0 STRUCTURAL STEEL

MEET OR EXCEED MANUFACTURER'S RECOMMENDATIONS.

- A. UNLESS OTHERWISE NOTED, ALL DETAILING, FABRICATION AND PLACING OF REINFORCING STEEL SHALL CONFORM TO THE MANUAL OF STANDARD PRACTICE FOR DETAILING REINFORCED CONCRETE STRUCTURES (ACI 315).
- B. ALL REINFORCING STEEL SHALL BE NEW BILLET STEEL, CONFORMING TO ASTM A-615, GRADE 60, DEFORMED.
- C. HEATING AND WELDING OF BARS IS PROHIBITED WITH THE EXCEPTION OF WRITTEN APPROVAL BY THE STRUCTURAL ENGINEER.

 D. ALL REINFORCEMENT BARS TO BE FREE FROM LOOSE RUST AND SCALE.
- D. ALL REINFORCEMENT BARS TO BE FREE FROM LOOSE RUST AND SCALE
 E. UNLESS OTHERWISE NOTED, ALL REINFORCEMENT SHALL HAVE A
 MINIMUM CONCRETE COVERAGE OF 3 INCHES. THIS MAY REQUIRE SPACERS AND
- F. SPLICES IN REINFORCEMENT STEEL ARE PROHIBITED, UNLESS APPROVED BY CONSTRUCTION MANAGER. ALL SPLICES MUST THEN MEET ALL APPLICABLE ASTM STANDARDS FOR SPLICING.

11.0 GROUNDING

MEET ALL APPLICABLE CODES, REQUIREMENTS OF THE CONSTRUCTION DOCUMENTS AND SPRINT WIRELESS CONSTRUCTION SPECIFICATIONS.

CHAIRS AS REQUIRED BY TESTING AGENCY OR CONSTRUCTION MANAGER.

GENERAL NOTE

OLIVE WITH ACCEPTED CONSTRUCTION PRACTICES.

1. THE GENERAL CONTRACTOR MUST VERIFY ALL DIMENSIONS, CONDITIONS AND ELEVATIONS BEFORE STARTING WORK. ALL DISCREPANCIES SHALL BE CALLED TO THE ATTENTION OF THE ENGINEER AND SHALL BE RESOLVED BEFORE PROCEEDING WITH THE WORK. ALL WORK SHALL BE PERFORMED IN A WORKMANLIKE MANNER IN ACCORDANCE WITH ACCEPTED CONSTRUCTION PRACTICES.

- 2. IT IS THE INTENTION OF THESE DRAWINGS TO SHOW THE COMPLETED INSTALLATION. THE CONTRACTOR SHALL BE RESPONSIBLE FOR ALL TEMPORARY BRACING, SHORING, 115, FORM WORK, ETC. IN ACCORDANCE WITH ALL NATIONAL, STATE AND LOCAL ORDINANCES TO SAFELY EXECUTE ALL WORK AND SHALL BE RESPONSIBLE FOR SAME. ALL WORK SHALL BE IN ACCORDANCE WITH LOCAL CODES.
- 3. THE CONTRACTOR SHALL USE ADEQUATE NUMBER OF SKILLED WORKMEN WHO ARE THOROUGHLY TRAINED AND EXPERIENCED IN THE NECESSARY CRAFTS AND WHO ARE COMPLETELY FAMILIAR WITH THE SPECIFIED REQUIREMENTS AND METHODS NEEDED FOR PROPER PERFORMANCE OF THE WORK.
- 4. CONSTRUCTION CONTRACTOR AGREES THAT IN ACCORDANCE WITH GENERALLY ACCEPTED CONSTRUCTION PRACTICES CONSTRUCTION CONTRACTOR WILL BE REQUIRED TO ASSUME SOLE AND COMPLETE RESPONSIBILITY FOR JOB SITE CONDITIONS DURING THE COURSE OF CONSTRUCTION OF THE PROJECT. INCLUDING THE SAFETY OF ALL PERSONS AND PROPERTY. THAT REQUIREMENT SHALL BE MADE TO APPLY CONTINUOUSLY AND NOT BE LIMITED TO NORMAL WORKING HOURS AND CONSTRUCTION CONTRACTOR FURTHER AGREES TO INDEMNIFY AND HOLD DESIGN ENGINEER HARMLESS FROM ANY AND ALL LIABILITY, REAL OR ALLEGED, IN CONNECTION WITH PERFORMANCE OF WORK ON THIS PROJECT.
- 5. SITE GROUNDING SHALL COMPLY WITH SPRINT/NEXTEL GROUNDING STANDARDS, LATEST EDITION AND COMPLY WITH SPRINT/NEXTEL GROUNDING CHECKLIST, LATEST VERSION. WHEN NATIONAL AND LOCAL GROUNDING CODES ARE MORE STRINGENT, THEY SHALL GOVERN. GROUNDING SHALL BE COMPLETED BEFORE ERECTION OF A NEW TOWER.
- 6. ALL WORK SHALL COMPLY WITH OSHA AND STATE SAFETY REQUIREMENTS. PROCEDURES FOR THE PROTECTION OF EXCAVATIONS, EXISTING CONSTRUCTION AND UTILITIES SHALL BE ESTABLISHED PRIOR TO FOUNDATION INSTALLATION. IF TEMPORARY LIGHTING AND MARKING ARE REQUIRED BY THE FEDERAL AVIATION ADMINISTRATION (FAA), IT IS THE CONTRACTOR'S RESPONSIBILITY TO MAINTAIN THE NECESSARY LIGHTS AND NOTIFY THE PROPER AUTHORITIES IN THE EVENT OF A PROBLEM.
- 7. ALL WORK SHALL BE ACCOMPLISHED IN ACCORDANCE WITH ALL LOCAL, STATE AND FEDERAL CODES OR ORDINANCES. THE MOST STRINGENT CODE WILL APPLY IN THE CASE OF DISCREPANCIES OR DIFFERENCES IN THE CODE REQUIREMENTS.
- 8. ANY DAMAGE TO ADJACENT PROPERTIES WILL BE CORRECTED AT THE CONTRACTOR'S EXPENSE
- 9. THE CONTRACTOR IS RESPONSIBLE FOR PROVIDING AMPLE NOTICE TO THE BUILDING INSPECTION DEPARTMENT TO SCHEDULE THE REQUIRED INSPECTIONS. A MINIMUM OF 24 HOURS OF NOTICE SHOULD BE GIVEN AND THE BUILDING INSPECTION DEPARTMENTS HAVE REQUESTED THAT GROUPS OF TWO OR THREE SITES BE SCHEDULED AT ONE TIME IF POSSIBLE.
- 10. FOR NEW TOWERS, SPRINT WILL CONFIRM FAA APPROVAL OF TOWER LOCATION BY ISSUING TOWER RELEASE FORM. NO TOWER SHALL BE CONSTRUCTED UNTIL TOWER RELEASE FORM IS ISSUED TO THE CONTRACTOR.
- 11. THE COMPLETE BID PACKAGE INCLUDES THESE CONSTRUCTION DRAWINGS ALONG WITH THE SPECIFICATIONS AND TOWER DRAWINGS/ANALYSIS. CONTRACTOR IS RESPONSIBLE FOR REVIEW OF THE TOTAL BID PACKAGE PRIOR TO BID SUBMITTAL.
- 12. THE CONTRACTOR SHALL VERIFY LOCATIONS OF ALL EXISTING UTILITIES WITHIN THE CONSTRUCTION LIMITS PRIOR TO CONSTRUCTION.
- 13. THE CONTRACTOR IS RESPONSIBLE FOR MAINTAINING POSITIVE DRAINAGE ON THE SITE AT ALL TIMES. SILT AND EROSION CONTROL SHALL BE MAINTAINED ON THE DOWNSTREAM SIDE OF THE SITE AT ALL TIMES. ANY DAMAGE TO ADJACENT PROPERTIES WILL BE CORRECTED AT THE CONTRACTORS EXPENSE.
- 14. CLEARING OF TREES AND VEGETATION ON THE SITE SHOULD BE KEPT TO A MINIMUM. ONLY THE TREES NECESSARY FOR CONSTRUCTION OF THE FACILITIES SHALL BE REMOVED. ANY DAMAGE TO PROPERTY OUTSIDE THE LEASED PROPERTY SHALL BE REPAIRED BY THE CONTRACTOR.
- 15. ALL SUITABLE BORROW MATERIAL FOR BACKFILL OF THE SITE SHALL BE INCLUDED IN THE BID. EXCESS TOPSOIL AND UNSUITABLE MATERIAL SHALL BE DISPOSED OF OFF SITE AT LOCATIONS APPROVED BY GOVERNING AGENCIES PRIOR TO DISPOSAL.
- 16. SEEDING AND MULCHING OF THE SITE WILL BE ACCOMPLISHED AS SOON AS POSSIBLE AFTER COMPLETION OF THE SITE DEVELOPMENT. THE CONTRACTOR IS RESPONSIBLE FOR PROVIDING AND MAINTAINING AN ADEQUATE COVER OF VEGETATION OVER THE SITE FOR A ONE YEAR PERIOD.
- 17. PERMITS: THE CONTRACTOR SHALL OBTAIN AND PAY FOR ALL REQUIRED PERMITS, LICENSES, FEES, INSPECTIONS, ETC. AND PROVIDE E911 ADDRESS TO SPRINT WIRE FSS.
- 18. RECORD DRAWINGS: MAINTAIN A RECORD OF ALL CHANGES, SUBSTITUTIONS, ETC., BETWEEN THE WORK AS SPECIFIED AND INSTALLED. RECORD CHANGES ON A CLEAN SET OF CONTRACT DRAWINGS WHICH SHALL BE TURNED OVER TO THE CONSTRUCTION MANAGER UPON COMPLETION OF THE PROJECT.

- 11. REPLACE EXISTING GRAVEL SURFACING ON AREAS FROM WHICH GRAVEL SURFACING IS REMOVED DURING CONSTRUCTION OPERATIONS. GRAVEL SURFACING SHALL BE REPLACED TO MATCH EXISTING ADJACENT GRAVEL SURFACING AND SHALL BE OF THE SAME THICKNESS. SURFACES AND GRAVEL SURFACING SHALL BE FREE FROM CORRUGATIONS AND WAVES. EXISTING GRAVEL SURFACING MAY BE EXCAVATED SEPARATELY AND REUSED IF INJURIOUS AMOUNTS OF EARTH, ORGANIC MATTER, OR OTHER DELETERIOUS MATERIALS ARE REMOVED PRIOR TO REUSE. TURNISH ALL ADDITIONAL GRAVEL RESURFACING MATERIAL AS REQUIRED. BEFORE GRAVEL SURFACING IS REPLACED, SUBGRADE SHALL BE GRADE TO CONFORM TO REQUIRED SUBGRADE ELEVATIONS, AND LOOSE OR DISTURBED MATERIALS SHALL BE THOROUGHLY COMPACTED. DEPRESSIONS IN THE SUBGRADE SHALL BE FILLED AND COMPACTED WITH APPROVED SELECTED MATERIAL, GRAVEL SURFACING MATERIAL SHALL NOT BE USED FOR FILLING DEPRESSIONS IN THE SUBGRADE.
- 12. PROTECT EXISTING GRAVEL SURFACING AND SUBGRADE IN AREAS WHERE EQUIPMENT LOADS WILL OPERATE, USE PLANKING OR OTHER SUITABLE MATERIALS DESIGNED TO SPREAD EQUIPMENT LOADS. REPAIR ANY DAMAGE TO EXISTING GRAVEL SURFACING OR SUBGRADE WHERE SUCH DAMAGE IS DUE TO THE CONTRACTOR'S OPERATIONS.
- 13. DAMAGE TO EXISTING STRUCTURES AND UTILITIES RESULTING FROM CONTRACTORS NEGLIGENCE SHALL BE REPAIRED/REPLACED TO OWNER'S SATISFACTION AT CONTRACTOR'S EXPENSE.
- 14. CONTRACTOR SHALL COORDINATE THE CONSTRUCTION SCHEDULE WITH THE PROPERTY OWNER SO AS TO AVOID INTERRUPTIONS TO PROPERTY OWNER'S OPERATIONS.
- 15. ENSURE POSITIVE DRAINAGE DURING AND AFTER COMPLETION OF CONSTRUCTION.



SUITE #800 MAHWAH, N.J. 07495

SITE ACQ.:



728 Shades Creek PKWY Suite 120 Homewood, AL 35209 Tel: (205) 682—7525

CONSULTANT:



158 BUSINESS CENTER DRIVE BIRMINGHAM, AL 35244 TEL: 205–252–6985 FAX: 205–320–1504


SITE NAME:

SA60XC296

FCC NUMBER:

1223931

SITE ADDRESS: 4719 S ZARZAMORA SAN ANTONIO, TX 78225 BEXAR COUNTY SHERIEF OFFICE

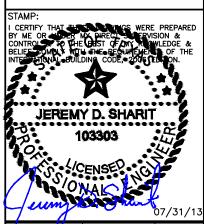

 DRAWN BY:
 JHB
 SMW #:

 APPROVED BY:
 JDS
 11-0802

 DATE DRAWN:
 08/05/11

REVISION TION


	DESCRIPTION		DATE
Δ	SUBMISSION: 90% CD	JDS	08/05/11
	SUBMISSION: 100% C		
\mathbf{A}	SUB: REV PER RFDS	DCP	07/23/12
Δ	SUB: REV PER CLIEN	TDCP	08/16/12
ß	SUB: REV PER STRUC	DCP.	10/10/12
	SUB: SEALED FINALS		
A	SUB: REV. FINALS	JDS	07/31/13

SHEET TITLE:

GENERAL NOTES

SHEET NUMBER

T-4

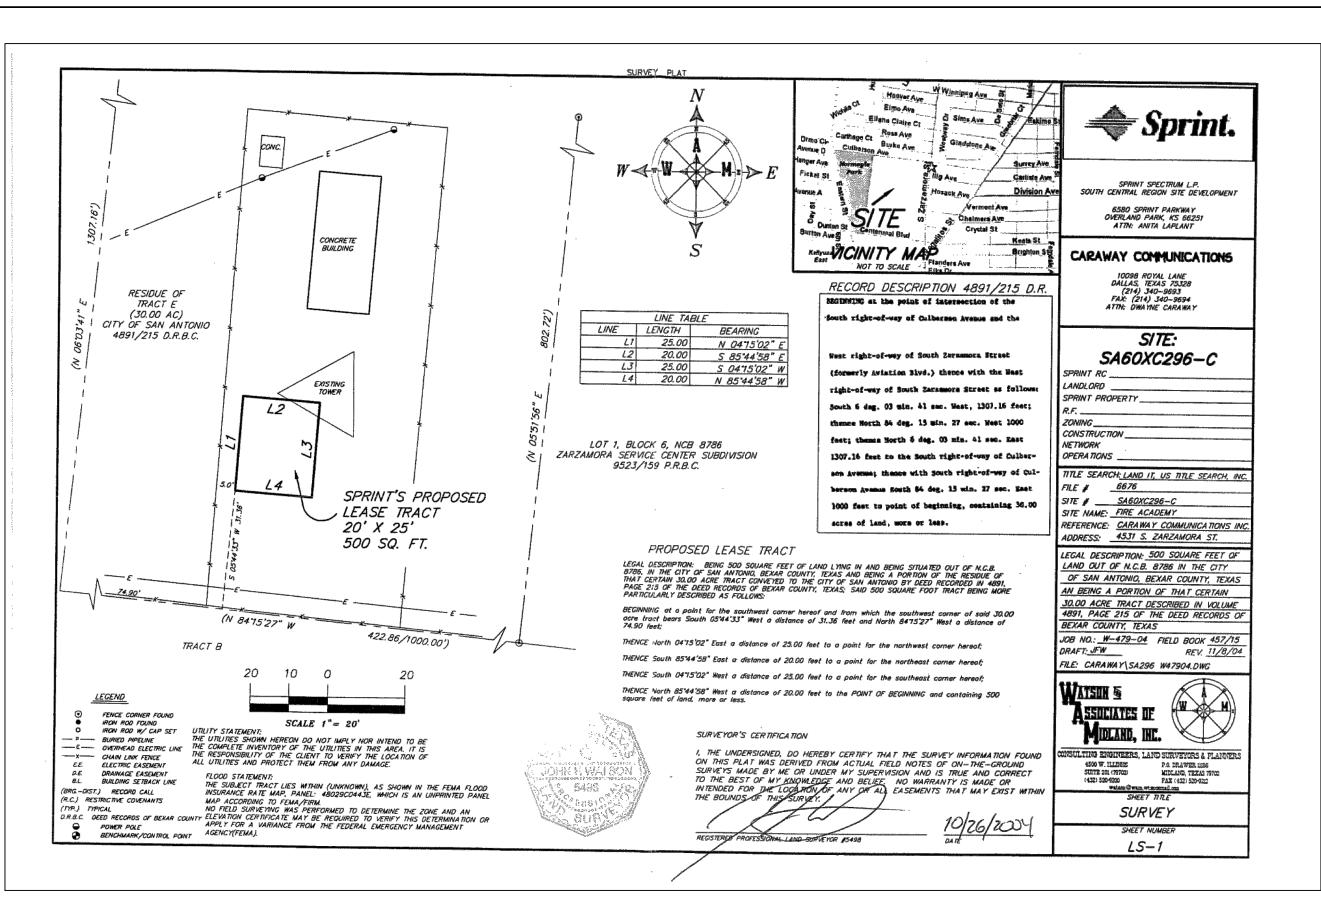

Sprint Sprint

1 INTERNATIONAL BOULEVARD SUITE #800 MAHWAH, N.J. 07495

SITE ACQ.:



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CONSULTANT:



158 BUSINESS CENTER DRIVE BIRMINGHAM, AL 35244 TEL: 205–252–6985 FAX: 205–320–1504


SITE NAME:

SA60XC296

FCC NUMBER:

1223931

SITE ADDRESS: 4719 S ZARZAMORA SAN ANTONIO, TX 78225 BEXAR COUNTY SHERIFF OFFICE

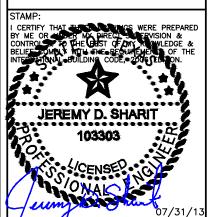

DRAWN BW JHB SMW #:

APPROVED BY: JDS 11-0802

DATE DRAWN: 08/05/11

REVISION

NO DESCRIPTION | 1


SUBMISSION: 90% CD | 1


↑ SUBMISSION: 90% CD JDS 08/05/11
↑ SUBMISSION: 100% CDJDS 01/15/12
↑ SUB: REV PER RFDS DCP 07/23/12
↑ SUB: REV PER CLIENT DCP 08/16/12
↑ SUB: REV PER STRUC DCP 10/10/12
↑ SUB: SEALED FINALS JDS 10/16/12
↑ SUB: REV. FINALS JDS 07/31/13

SHEET TITLE:

OVERALL SITE PLAN

SHEET NUMBER:

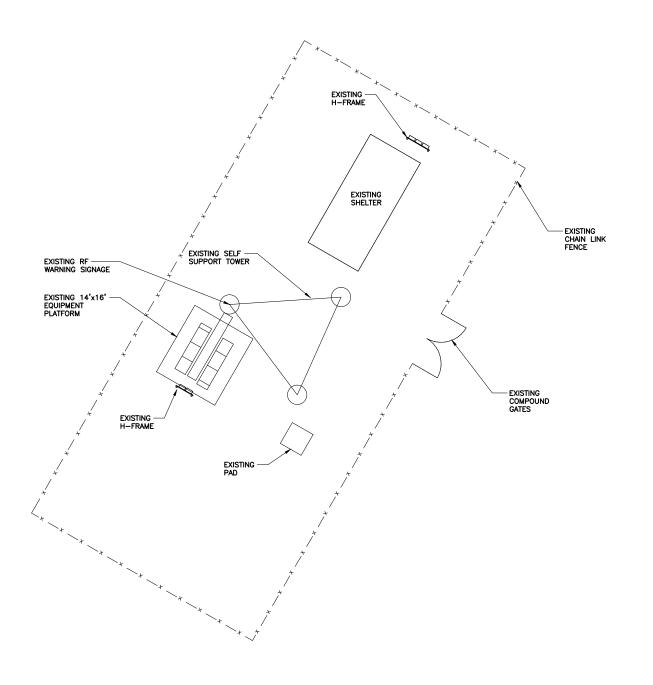

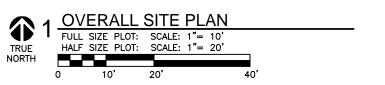



SITE ACQ.:



728 Shades Creek PKWY Suite 120 Homewood, AL 35209 Tel: (205) 682—7525

CONSULTANT:



TOGETHER PLANNING A DETTER TOMOFROW

158 BUSINESS CENTER DRIVE
BIRMINGHAM, AL 35244

TEL: 205-252-6985 FAX: 205-320-1504

SITE NAME:

SA60XC296

FCC NUMBER:

1223931

SITE ADDRESS: 4719 S ZARZAMORA SAN ANTONIO, TX 78225 BEXAR COUNTY SHERIFF OFFICE




DRAWN BY!		JHB	SMW #:
APPROVED E	BY:	JDS	11-080
DATE DRAWN	N:	08/05/11	
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	REVISION		
NO	DESCRIPTION	BY	DATE
	SUBMISSION: 90% CD		
₪	SUBMISSION: 100% CD	JDS	01/15/12
\Im	SUB: REV PER RFDS	DCP	07/23/12
lacktree	SUB: REV PER CLIENT	DCP	08/16/12
Ճ	SUB: REV PER STRUC.	DCP	10/10/12
4	SUB: SEALED FINALS	SQC	10/16/12
А	SUB: REV. FINALS	JDS	07/31/13
0			

SHEET TITLE:

ENLARGED SITE PLAN

SHEET NUMBER:

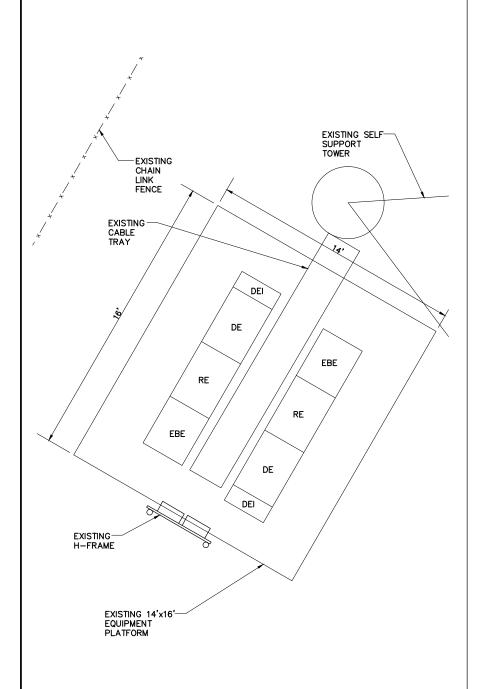

NOTE: COLD SWAP SOLUTION; NO TEMP PHASE

EXISTING SELF-SUPPORT TOWER CHAIN LINK FENCE EXISTING -CABLE TRAY PROPOSED 6102 RBS CABINET PROPOSED, 6102 BBS CABINET **EXISTING** H-FRAME

NOTE:

ALL EXISTING HOLES IN GRATING TO BE COVERED BY 3/8" GALV PLATE. MULTIPLE SMALL HOLES TO BE COVERED BY ONE PLATE. (SEE DETAIL 3/A-8)

NORTH

EQUIPMENT SITE PLAN (FINAL)

FULL SIZE PLOT: SCALE: 3/8"= 1'-0" HALF SIZE PLOT: SCALE: 3/16"= 1'-0"

EXISTING 14'x16'

EQUIPMENT PLATFORM

OWNER/APPLICANT FOR:

1 INTERNATIONAL BOULEVARD SUITE #800 MAHWAH, N.J. 07495

SITE ACQ.:



728 Shades Creek PKWY Suite 120 Homewood, AL 35209 Tel: (205) 682—7525

CONSULTANT:



TOGETHER PLANNING A DETTER TOMORROW

158 BUSINESS CENTER DRIVE
BIRMINGHAM, AL 35244

TEL: 205-252-6985 FAX: 205-320-1504


SITE NAME:

SA60XC296

FCC NUMBER:

1223931

SITE ADDRESS: 4719 S ZARZAMORA SAN ANTONIO, TX 78225 BEXAR COUNTY SHERIFF OFFICE

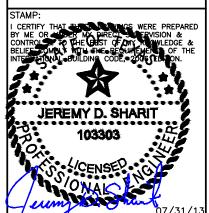

DRAWN BY! SMW #: APPROVED BY: JDS 11-0802 DATE DRAWN: 08/05/11

REVISION NO DESCRIPTION BY DATE

⚠ SUBMISSION: 90% CD JDS 08/05/11 A SUBMISSION: 100% CDJDS 01/15/12 SUB: REV PER RFDS DCP 07/23/1 SUB: REV PER CLIENT DCP 08/16/12 SUB: REV PER STRUC.DCP 10/10/12 SUB: SEALED FINALS JDS 10/16/12 SUB: REV. FINALS JDS 07/31/13

SHEET TITLE: **EQUIPMENT PLANS**


A-3



EQUIPMENT SITE PLAN (EXISTING)

FULL SIZE PLOT: SCALE: 3/8"= 1'-0" HALF SIZE PLOT: SCALE: 3/16"= 1'-0"

2 NOT USED NORTH

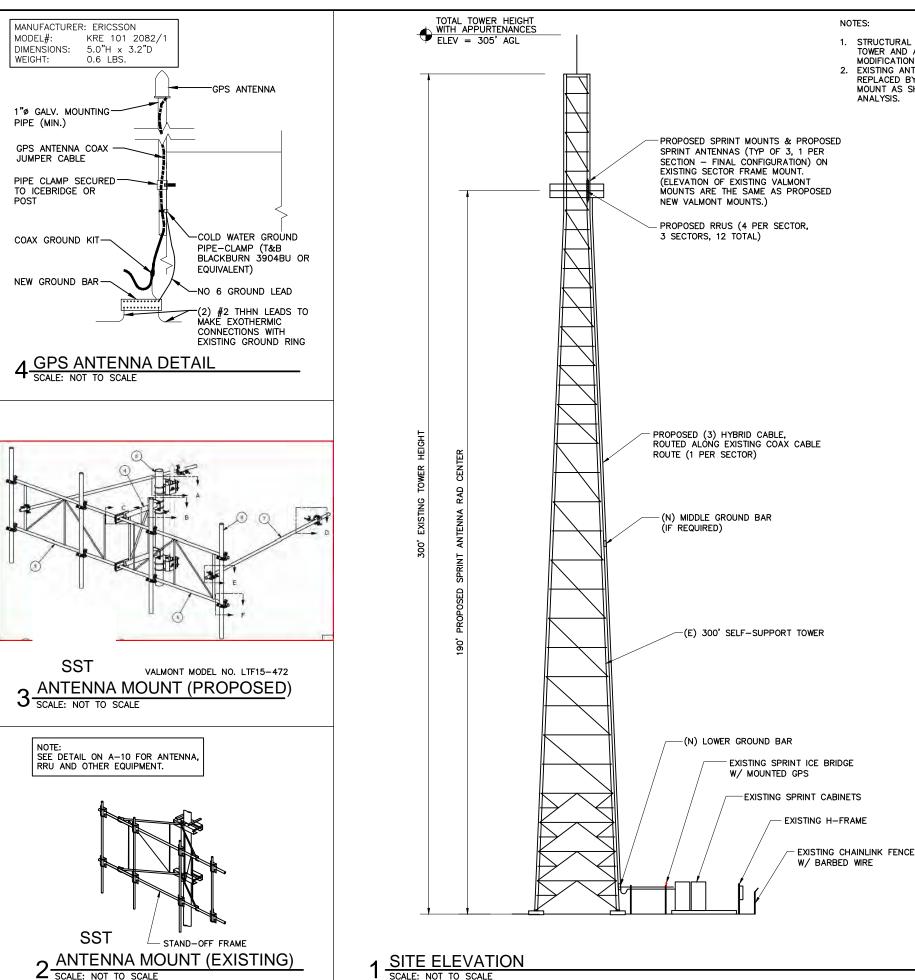

- 1. STRUCTURAL ANALYSIS RESULTS SHOW TOWER AND ANTENNA MOUNT
- MODIFICATIONS ARE NEEDED. 2 EXISTING ANTENNA MOUNTS TO BE REPLACED BY THE PROPOSED ANTENNA MOUNT AS SHOWN ON STRUCTURAL ANALYSIS.

- NOTES:
 1. CONTRACTOR TO FIELD VERIFY ANTENNA CABLE LENGTHS.
- 2. ALL MAIN CABLES WILL BE COLOR CODED AT THREE (3) LOCATIONS.
- 3. COLOR CODE ALL ANTENNA AND COAX WITH 2" WIDE BANDS OF COLORED TAPE WITH 1" SEPARATION BETWEEN BANDS.
- 4. COLOR CODE ALL TOP AND BOTTOM GROUND KITS WITH 1" WIDE BANDS OF COLORED TAPE WITH 1/2"
- 5. START COLOR BANDS 2" BEYOND WEATHERPROOFING. 6. START SECTOR COLOR NEXT TO END CONNECTOR.
- 7. ALL MAIN CABLES WILL BE GROUNDED W/ COAXIAL CABLE GROUND KITS AT:
- THE ANTENNA LEVEL

SEPARATION BETWEEN BANDS.

- MID LEVEL IF TOWER IS OVER 200'
 BASE OF TOWER PRIOR TO TURNING HORIZONTAL TERMINATION OF COAX LINES TO JUMPERS
- 8. ALL NEW GROUND BAR DOWNLEADS ARE TO BE CADWELDED TO THE EXISTING ADJACENT GROUND BAR DOWNLEADS A MINIMUM DISTANCE OF 4FT BELOW GROUND BAR
- 9. PROVIDE BUSS BAR NEAR BTS FOR ATTACHMENT OF WIMAX COAX GROUND KITS

- COAXIAL ANTENNA CABLE NOTES:

 1. THE ANTENNA COAXIAL CABLE INSTALLER SHALL BE RESPONSIBLE FOR PERFORMING AND SUPPLYING SPRINT WITH 3 TYPEWRITTEN SWEEP TESTS (ANTENNA RETURN LOSS TEST). THIS TEST SHALL BE PERFORMED TO THE SPECIFICATIONS AND PARAMETERS OUTLINED BY THE SPRINT RADIO FREQUENCY (RF) ENGINEER. THIS TEST SHALL BE PERFORMED PRIOR TO FINAL ACCEPTANCE OF THE SITE/
- 2. THE COAXIAL ANTENNA CABLE INSTALLER SHALL BE RESPONSIBLE FOR PERFORMING AND SUPPLYING SPRINT WITH 3 TYPEWRITTEN TIME DOMAIN REFLECTOMETER (TDR) TESTS TO VERIFY CABLE LENGTH AND TO CHECK FOR WATER DAMAGE.
- 3. VAPOR WRAP WILL BE USED TO SEAL ALL CONNECTIONS.
- 4. ALL JUMPERS TO THE ANTENNAS FROM THE MAIN TRANSMISSION LINE WILL BE 1/2" JUMPERS AND SHALL NOT EXCEED 6'-0". MAXIMUM LENGTH FOR THE JUMPERS AT WIMAX BTS UNITS WILL BE 6'-0".
- 5. IF COAX IS BEING RE-USED FOR THIS INSTALLATION, PRE AND POST ANTENNA LINE SWEEPS ARE REQUIRED.
- 6. UPON COMPLETION, PROVIDE A HEIGHT VERIFICATION DEPICTING RAD CENTER AND TOP OF ANTENNA.

- ANTENNA MOUNTING NOTES:
 1. DESIGN AND CONSTRUCTION OF ANTENNA SUPPORTS SHALL CONFORM TO CURRENT ANSI/EIA/TIA-222; APPENDIX B FOR WIND LOADING; "STRUCTURAL STANDARDS FOR STEEL ANTENNA TOWERS AND ANTENNA SUPPORTING STRUCTURES" OR APPLICABLE
- LOCAL CODES.

 2. ALL STEEL MATERIALS SHALL BE GALVANIZED AFTER FABRICATION IN ACCORDANCE WITH ASTM A123 "ZINC (HOT-DIPPED GALVANIZED) COATINGS ON IRON AND STEEL PRODUCTS", UNLESS OTHERWISE NOTED.
- 3. ALL BOLTS, ANCHORS AND MISCELLANEOUS HARDWARE SHALL BE GALVANIZED IN ACCORDANCE WITH ASTM A153 "ZINC-COATING (HOT DIP) ON IRON AND STEEL HARDWARE", UNLESS OTHERWISE NOTED.
- 4. DAMAGED GALVANIZED SURFACES SHALL BE REPAIRED BY COLD GALVANIZING IN ACCORDANCE WITH ASTM A780.
- 5. ALL ANTENNA MOUNTS SHALL BE INSTALLED WITH DOUBLE NUTS AND SHALL BE INSTALLED SNUG TIGHT.
- 6. MINIMUM HORIZONTAL SPACING SHALL BE 2'-0" BETWEEN ALL ANTENNAS.

- 1. ALL AZIMUTHS ARE TO BE ESTABLISHED CLOCKWISE FROM THE TRUE NORTH HEADING.
 2. CONTRACTOR SHALL VERIFY PROPOSED ANTENNA RAD
- CENTER AND ORIENTATIONS WITH SPRINT PCS PRIOR TO INSTALLATION OF ANTENNAS.
- 3. PRIOR TO ATTACHING ANTENNAS AND MOUNTING SECTIONS, EXISTING TOWER AND TOWER FOUNDATION MUST BE ANALYZED BY A LICENSED STRUCTURAL ENGINEER TO VERIFY TOWER IS CAPABLE OF SUPPORTING THE PROPSED LOADS. REFER TO STRUCTURAL ANALYSIS BY OTHERS.
- 4. CONTRACTOR SHALL REFER TO TOWER STRUCTURAL CALCULATIONS FOR ADDITIONAL LOADS. NO ERECTION OR MODIFICATION OF TOWER SHALL BE MADE WITHOUT APPROVAL OF STRUCTURAL ENGINEER.
- 5. CONTRACTOR TO REFER TO MOUNT MAPPING, P.E. LETTER AND STRUCTURAL ANALYSIS PRIOR TO



1 INTERNATIONAL BOULEVARD SUITE #800 MAHWAH, N.J. 07495

SITE ACQ.:



728 Shades Creek PKWY Suite 120 Homewood, AL 35209 Tel: (205) 682-7525

CONSULTANT:



ither planning a better tom 158 BUSINESS CENTER DRIVE BIRMINGHAM, AL 35244 TEL: 205-252-6985 FAX: 205-320-1504


SITE NAME:

SA60XC296

FCC NUMBER:

1223931

SITE ADDRESS: 4719 S ZARZAMORA SAN ANTONIO, TX 78225 BEXAR COUNTY SHERIFF OFFICE

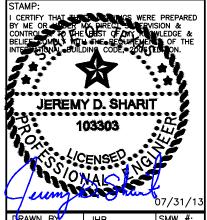

DRAWN BY!	JHB	SMW #:
APPROVED BY:	JDS	11-0802
DATE DRAWN: 08/05/11		
DD (ICION		

REVISION NO DESCRIPTION

BY DATE ↑ SUBMISSION: 90% CD | JDS | 08/05/11 SUBMISSION: 100% CDJDS 01/15/12 SUB: REV PER RFDS DCP 07/23/1 SUB: REV PER CLIENT DCP 08/16/12 SUB: REV PER STRUC.DCP 10/10/12 SUB: SEALED FINALS JDS 10/16/12 SUB: REV. FINALS JDS 07/31/13

SITE ELEVATION &

ANTENNA DETAILS

SHEET NUMBER:

Revision:	B1
Date:	7/12/2012

Cascade	SA60XC296
Market	ŞanAntonio
MTX/BSC	SA-SAN_ANTONIO-BSC_2.1
Lat	29.3791
Lon	-98.53660
Structure Type	SELF SUPPORT

REDS Phase	RFDS Phase	
------------	------------	--

	RBS1	RBS2
Existing BTS #		
New BTS #		
Existing Cell ID	596	
New Cell ID		
RBS Cabinet Type	Outdoor	

Number of Sectors: 3

			MHz & 1900 MHz Dual Band	1		
	Sector1	Sector2	Sector3	Sector4	Sector5	Sector6
Vendor	RFS	RFS	RFS			
Model	APXVERR18-C-2-1910I	APXVERR18-C-4-1910l	APXVERR18-C-7-1910			
Antenna Band Type	Dual	Dual	Dual			
Antenna Count	1	1	1			
Gain (dBi)	17.8	17.8	17.8			
Beamwidth	69	69.4	69.4			
Azimuth	330	60	160			
Height (ft)	190	190	190			
Mech. Downtilt	0	0	0			
Elect. Downtilt 1900	2	4	7			
Elect. Downtill 800	10	6	10			
EIRP (W)	250	250	250			
RET Count	3	3	3			
RET Manufacturer	RFS	RFS	RFS	†		
RET Model	ACU-A20-N	ACU-A20-N	ΛCU-Λ20-N			
INC (MODG)	//OO-//20-N		For GM No Touch Sites Only	<u> </u>	l	
	Sector1	Sector2	Sector3	Sector4	Sector5	Sector6
16	Securi	Qet.itii2	Sectora	Sectora	Secrois	Sectoro
Vendor				ļ		
Model						
Antenna Band Type						
Antenna Count						
Gain (dBi)						
Beamwidth						
Azimuth						
Height						
Mech. Downtilt						
Elect. Downtilt						
EIRP (W)						
RET Count						
RET Manufacturer						
RET Model						
		ANTE	NNA #3 (B00 MHz)			
	Sector1	Sector2	Sector3	Sector4	Sector5	Sector6
Vendor						
Model	i l			†		
Antenna Band Type						
Antenna Count						
Gain (dBi)				<u> </u>		
Beamwidth						
Azimuth						
Height						
Mech. Downtilt				†		
Elect. Downtilt				1		
EIRP (W)						
RET Count	1			†	ł	
RET Manufacturer						
RET Model						
Antenna Count Per	+			1		
Sector	1 1	1	1	0	0	O

EQUIPMENT SCHEDULES ARE BASED ON RFD SA60XC296_RFDS_vB1_20120712



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SITE ACQ.:



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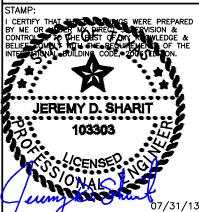
SITE NAME:

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DRAWN BY		JHB	SMW #:
APPROVED	BY:	JDS	11-0802
DATE DRAW	N:	08/05/11	

REVISION

DESCRIPTION

SUBMISSION: 90% CD JDS 08/05/11

SUBMISSION: 100% CD JDS 01/15/12

SUB: REV PER RFDS DCP 07/23/12

SUB: REV PER CLIENT DCP 08/16/12

SUB: REV PER STRUC DCP 10/10/12

SUB: SEALED FINALS JDS 10/16/12

SUB: REV. FINALS JDS 07/31/13

SHEET TITLE:

ANTENNA SCHEDULE

SHEET NUMBER:

EQUIPMENT SCHEDULES ARE BASED ON RFD SA60XC296_RFDS_vB1_20120712

	C	ABLING				
	Sector1	Sector2	Sector3	Sector4	Sector5	Sector
Est. Cable Length (feet)	205	205	206			
Number of Cables	1	1	1			
Cable1 Drameter	39 mm	39 mm	39 mm		l '	Ī
Cable1 Type	Hybrid Cable	Hybrid Cable	Hybrid Cable			
Cable1 Manufacturer	H+S	H+S	H+S			
Cable1 Model	TSZ 999 067/xxxM	TSZ 999 067/xxxM	TSZ 999 067/xxxM			
Number of Cables	0	a	0			
Cable2 Drameter	39 mm	39 min	39 mm			
Cable2 Type	Hybrid Cable	Hybrid Cable	Hybrid Cable			
Cable2 Manufacturer	H+\$	H+S	H+\$			
Cable2 Model	T\$Z 999 066/xxxM	TSZ 999 066/xxxM	TSZ 999 066/xxxM			
Top Jumper Length	3 m	3 m	3 m			
Top Jumper Type	TSR 951 70/3	TSR 951 70/3	TSR 951 70/3			
Cable Type						
Cable Manufacturer						
Cable Model						
Total Power Cables						
Cable Type	Fiber OPTO	Fiber OPTO	Filter OPTO			
Cable Manufacturer	Encsson	Encsson	Encason			
Cable Model	RPM 253 469 2/mxx	RPM 253 469 2/xxxx	RPM 253 469 299xx			
Total Opto Cables	8	8	8			
Coax Cable - Main - Type						
Coax Cable - Main - Length						
Coax Cable - Main - Count						
Coax Cable - Main - Manufacturer						
Coax Cable - Main - Model						
Coax Cable - Top Jumper - Type						
Coax Cable - Top Jumper - Length						
Coax Cable - Top Jumper - Court						
Coax Cable - Top Jumper - Manufacturer						
Coax Cable - Top Jumper - Model						
Coax Cable - Bottom Jumper - Type						
Coax Cable - Bottom Jumper - Length						
Coax Cable - Bottom Jumper - Count						
Coax Cable - Bottom Jumper - Manufacturer						
Coax Cable - Bottom Jumper - Model						

	Count	Vodel
RBS	1	6102
ebs	1	6132
MW 20p		
MW 20p BBS		

GPS INFO	0	
	GPS	Cable
Vencor	Encason	_
Model	GPS-TMG-HR26NCM	•
Туре		-
Diameter		

T1 COUNTS

CDMA 800

CDMA 1900

EVDC 800

EVDC 1900

Carrier Information			Start/Stop Freqs	Channel Element Counts			
	Carriers	Frequencies	Tx (MHz)	Ra (⊎Hz	Total	32 Blocks	Per Carrier
1x ACV-800	1	-	862 275-883.525	817 275-818 525	192	6	192
EVDO-800	3				0	0	3
1x ADV-1900	4	10.25:75:275:	1930 625-1944,375	1850,925-1864 375	768	24	192
EVDO-1988	2	175 225.	1930 625-1944,375	1850.525-1864-375	384	12	192
LTE 1900	1		1990 000-1995,000	1910,000-1915-000			
LTE 1500						•	
Total 900	1		•				
Total 1900	ŝ	1					

RBS Configura	ation				
RBS Modules			RBS Cards		
Count	RBS1	RBS2	Count	RBS1	RBS2
DBU	3	0	XCEMA (1900)	0	С
DBA	3	0	AEM (1900)	0	С
СЕЕМ)	0	XCEMA (800)	0	С
DUL	4	0	AEM (800)	0	С
20711	3	0	1		

1900 3G Radio Config					
Radio Number	Freq Vect				
Radio 1	200:175:75:				
Radio 2	25:275:225:				
Radio 3	1				
Radio 4	0				

			RRU Count			
	Sector 1	Sector2	Sector3	Sector4	Sector5	Sector6
RRUS 11 Single	4	4	4			
RRJS 12 Single	5	0	5			
RRJS 12 Dual		0	э			
ARUS 13 Single	5	0	0			
RRUS 13 Ocal	5	0	0			
RRUS A2 Module	1	1	1			
		RRU Cour	t - Detailed Break	down		
RRJ511	Sector1	Sector2	Sector3	Sector4	Sector5	Sector6
CDIVA - 800	1	1	1			
CDMA - 1900	2	2	. 2		_	
LTE - 800	0	0				
LTE - 1600	0	0	Э		•	
LTE - 1900	1	1	1			
LTE - 2500	0	0	0			
RRJS12	Septor1	Sector2	Sectorà	Sector4	Sector5	Sector6
CDMA/LTE - 800	0	0	. 0			
CDMA/.TE - 1900	0	0	0			
LTE - 1600	0	0	0			
LTE - 2500	0	0	5		-	
RRJS13	Sector1	Sector2	Sector3	Sector4	Sector5	Sector6
CDMA/JE-800	0	0	0			
CDMA/LTE - 1900	0	0	0			
LTE - 1600	0	0				
LTE - 2500	0	0				
RRUS 11 Count	4	٤	4			
RRUS 12 Count	0	0	0	•	•	
RRJS 13 Count	Э	ū	5			

	Combiners							
	Sector1	Sector2	Sector3	Sector4	Sector5	Sector6		
Count	1	1	1					
Manufacturer	RFS	RFS	RFS					
Model	IBC1900HG-1	IBC1900HG-1	IBC1900HG-1					
Gain (dB)	3-9 dB	3-9 dB	3-9 dB					
Gaill (GB)	3-948	J 3-9 UB	3-9 UB					

800 MHz FILTER						
	Sector1	Sector2	Sector3	Sector4	Sector5	Sector6
Count	1	1	1			
Manufacturer	Ericsson	Ericsson	Ericsson			
Model	800 ESMR	800 ESMR	800 ESMR			

					M-CRCA-	INE DISH				
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SITE ACQ.:



728 Shades Creek PKWY Suite 120 Homewood, AL 35209 Tel: (205) 682—7525

CONSULTANT:



TOGETHER FLANNING A SETTER TOMORROW

158 BUSINESS CENTER DRIVE
BIRMINGHAM, AL 35244

TEL: 205-252-6985 FAX: 205-320-1504


SITE NAME:

SA60XC296

FCC NUMBER:

1223931

SITE ADDRESS: 4719 S ZARZAMORA SAN ANTONIO, TX 78225 BEXAR COUNTY SHERIFF OFFICE

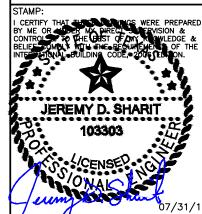

		<u>, , , </u>
DRAWN BY!	JHB	SMW #:
APPROVED BY:	JDS	11-0802
DATE DRAWN:	08/05/11	

REVISION

NO DESCRIPTION BY DATE

↑ SUBMISSION: 90% CD JDS 08/05/11

↑ SUBMISSION: 100% CD JDS 01/15/12

↑ SUB: REV PER RFDS DCP 07/23/12

↑ SUB: REV PER CLIENT DCP 08/16/12

↑ SUB: REV PER STRUC DCP 10/10/12

↑ SUB: REV PER STRUC DCP 10/16/12

↑ SUB: REV. FINALS JDS 07/31/13

SHEET TITLE: EQUIPMENT SCHEDULES

SHEET NUMBER:

A-6

1 EQUIPMENT SCHEDULES
SCALE: NOT TO SCALE

EQUIPMENT SCHEDULES ARE BASED ON RFD SA60XC296_RFDS_vB1_20120712



SITE ACQ.:



SUITE #800 MAHWAH, N.J. 07495

728 Shades Creek PKWY Suite 120 Homewood, AL 35209 Tel: (205) 682-7525

CONSULTANT:



TOGETHER PLANNING A DETTER TOMORROW

158 BUSINESS CENTER DRIVE
BIRMINGHAM, AL 35244

TEL: 205-252-6985 FAX: 205-320-1504

SITE NAME:

SA60XC296

FCC NUMBER:

1223931

SITE ADDRESS: 4719 S ZARZAMORA SAN ANTONIO, TX 78225 BEXAR COUNTY SHERIFF OFFICE





		
DRAWN BY!	JHB	SMW #:
APPROVED BY:	JDS	11-0802
DATE DRAWN:	08/05/11	

SHEET TITLE: ANTENNA PLUMBING DIAGRAMS


SHEET NUMBER:

A-7

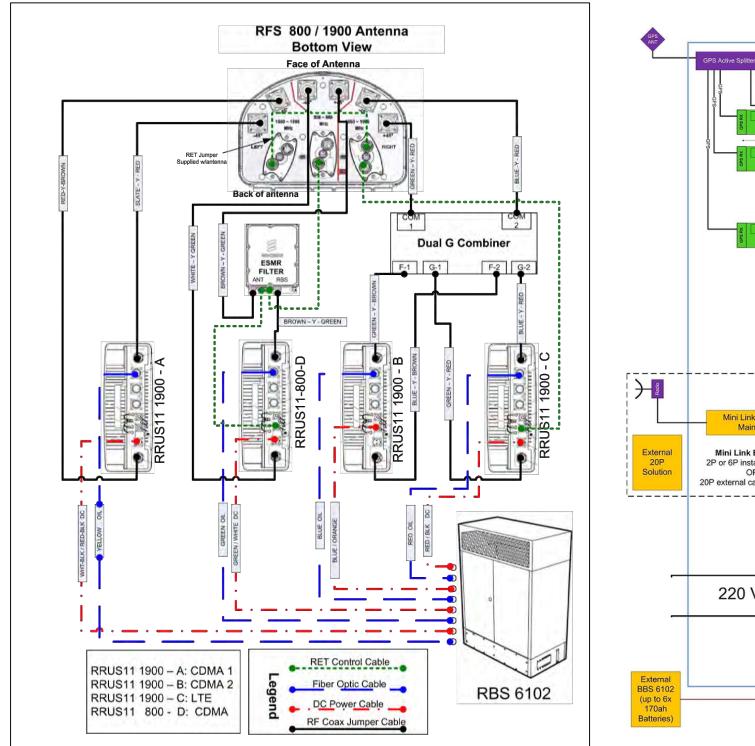

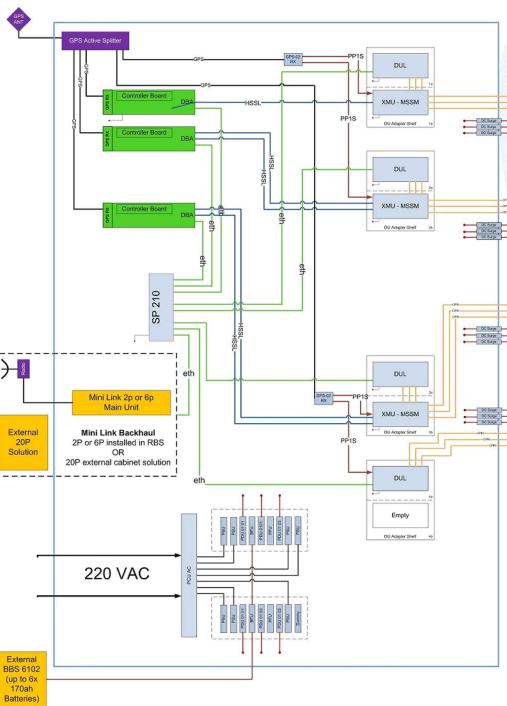

2 RBS PLUMBING DIAGRAM SCALE: NOT TO SCALE

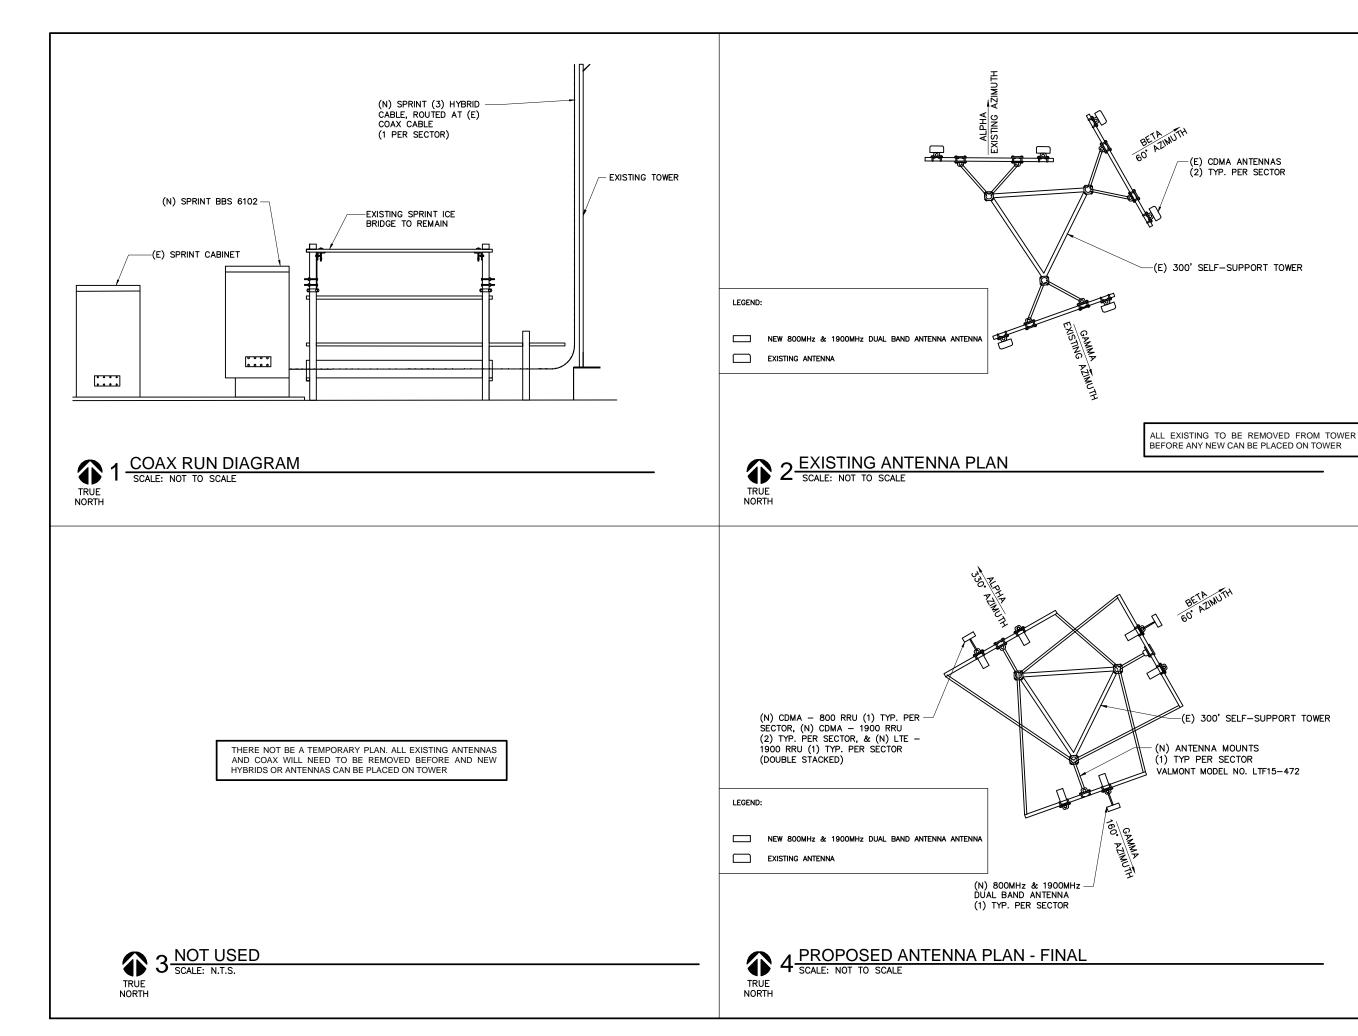

Sprint Sprint

SUITE #800 MAHWAH, N.J. 07495

1 INTERNATIONAL BOULEVARD

SITE ACQ.:

CRAFTON COMMUNICATIONS

728 Shades Creek PKWY Suite 120 Homewood, AL 35209 Tel: (205) 682-7525

CONSULTANT:



158 BUSINESS CENTER DRIVE BIRMINGHAM, AL 35244 TEL: 205-252-6985 FAX: 205-320-1504

SITE NAME:

SA60XC296

FCC NUMBER: 1223931

SITE ADDRESS: 4719 S ZARZAMORA SAN ANTONIO, TX 78225 BEXAR COUNTY SHERIFF OFFICE




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APPROVED E	3Y:	JDS	11-0802
DATE DRAWN	1:	08/05/11	


SHEET TITLE:

ENLARGED ANTENNA PLANS & COAX RUN DIAGRAM

SHEET NUMBER:

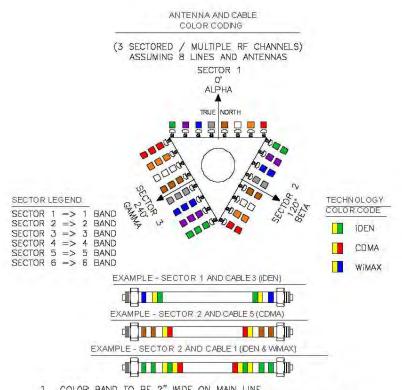

- 1. COLOR BAND TO BE 2" WIDE ON MAIN LINE.
- SPACING TO BE 1" BETWEEN BANDS AND 2" BETWEEN LINE AND TECHNOLOGY BANDS. NO SPACE BETWEEN TECHNOLOGY COLOR BANDS.
- COLOR BAND ON JUMPERS 1" WIDE W/ 1" SPACE.
- 4. START COLOR BANDS 2" BEYOND WEATHERPRODFING.
- 5. START SECTOR COLOR NEXT TO END CONNECTOR.

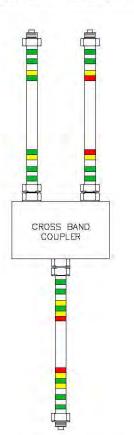

3 ANTENNA & CABLE COLOR CODE SCALE: N.T.S.

SECTOR	CABLE	FIRST RING	SECOND RING	THIRD RING
1 ALPHA	1	GREEN	NO TAPE	NO TAPE
1	2	Sile	NO TAPE	NO TAPE
1	3	BROWN	NO TAPE	NO TAPE
1	4	WHITE	NO TAPE	NO TAPE
1	5	WED	NO TAPE	NO TAPE
1	6	SLATE	NO TAPE	NO TAPE
1-1	7	The state of	NO TAPE	NO TAPE
-1_	8	ORANGE	NO TAPE	NO TAPE
2 BETA	1	CREEN	CREEN	NO TAPE
2	2	BLUC	TILLE	NO TAPE
2	3	BROWN	BROWN	NO TAPE
2	4	WHITE	WHITE	NO TAPE
2	5	MED	REI	NO TAPE
Z	6	SLATE	SLATE	NO TAPE
2	7	THE STATE OF	16	NO TAPE
2	8	ORANGE	ORANGE	NO TAPE
2 BETA	1	GREEN	GREEN	GREEN
2	2	RI.LIE	E IE	BI.(II
2	3	BROWN	BROWN	BROWN
2	4	WHITE	WHITE	WHITE
2	5	WED	FIELD	450
2	6	SLATE	SLATE	SLATE
2	7		1.000	10 10 OI
2	8	ORANGE	ORANGE	ORANGE

5 COAXIAL CABLE COLOR CODE SCALE N.T.S.


FREQUENC	CY COLOR CO	DDE
TECHNOLOGY COLOR CODE	FIRST RING	SECOND RING
IDEN	YELLOW	GREEN
CDMA	YELLOW	911
WiMAX	YELLOW	

2 FREQUENCY COLOR CODE SCALE N.T.S.

	LSB				MSB
CABLE	STRIPE 1 (1) *	STRIPE 2 (2)	STRIPE 3 (4)	STRIPE 4 (8)	STRIPE 6 (16)
1	YELLOW	PURPLE	PURPLE	PURPLE	PURPLE
2	PURPLE	YELLOW	PURPLE	PURPLE	PURPLE
3	YELLOW	YELLOW	PURPLE	PURPLE	PURPLE
4	PURPLE	PURPLE	YELLOW	PURPLE	PURPLE
5	YELLOW	PURPLE	YELLOW	PURPLE	PURPLE
6	PURPLE	YELLOW	YELLOW	PURPLE	PURPLE
7	YELLOW	YELLOW	YELLOW	PURPLE	PURPLE
8	PURPLE	PURPLE	PURPLE	YELLOW	PURPLE
9	YELLDW	PURPLE	PURPLE	YELLOW	PURPLE
10	PURPLE	YELLOW	PURPLE	YELLOW	PURPLE
11	YELLOW	YELLOW	PURPLE	YELLOW	PURPLE
12	PURPLE	PURPLE	YELLOW	YELLOW	PURPLE
13	YELLOW	PURPLE	YELLOW	YELLOW	PURPLE
14	PURPLE	YELLOW	YELLOW	YELLOW	PURPLE
15	YELLOW	YELLOW	YELLOW	YELLOW	PURPLE
16	PURPLE	PURPLE	PURPLE	PURPLE	YELLOW
17	YELLOW	PURPLE	PURPLE	PURPLE	YELLOW
18	PURPLE	YELLOW	PURPLE	PURPLE	YELLOW
19	YELLOW	YELLOW	PURPLE	PURPLE	YELLOW
20	PURPLE	PURPLE	YELLOW	PURPLE	YELLOW
21	YELLOW	PURPLE	YELLOW	PURPLE	YELLOW
22	PURPLE	YELLOW	YELLOW	PURPLE	YELLOW
23	YELLOW	YELLOW	YELLOW	PURPLE	YELLOW
24	PURPLE	PURPLE	PURPLE	YELLOW	YELLOW

* STRIPS 1 (LSD) SHALL BE PLACED CLOSEST TO THE CONNECTOR END OF CABLE.

4 MICROWAVE COLOR CODE CHART SCALE: N.T.S.

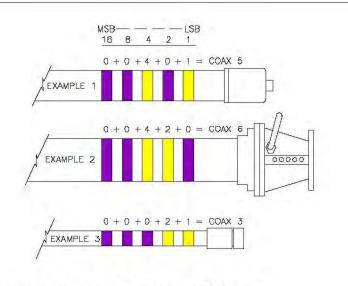

1 MICROWAVE CABLE COLOR CODE SCALE: N.T.S.



SITE ACQ.:



SUITE #800 MAHWAH, N.J. 07495

728 Shades Creek PKWY Suite 120 Homewood, AL 35209 Tel: (205) 682-7525

CONSULTANT:



Together Planning a better tomo 158 BUSINESS CENTER DRIVE BIRMINGHAM, AL 35244 TEL: 205-252-6985 FAX: 205-320-1504


SITE NAME:

SA60XC296

FCC NUMBER:

1223931

SITE ADDRESS: 4719 S ZARZAMORA SAN ANTONIO, TX 78225 BEXAR COUNTY SHERIFF OFFICE

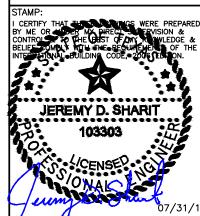


DRAWN BY!		JHB	SMW #:
APPROVED	BY:	JDS	11-0802
DATE DRAW	N:	08/05/11	

REVISION NO DESCRIPTION

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NO	DESC	RIPTIC	N			BY	DATE	
Δ	SUBM	IISSIO	N: 9	0%	CD	JDS	08/05/1	1
Δ	SUBM	IISSIO	N: 1	00%	CD	JDS	01/15/1	2
⅓	SUB:	REV	PER	RF	DS	DCP	07/23/1	2
Δ	SUB:	REV	PER	CL	IENT	DCP	08/16/1	2
⅓	SUB:	REV	PER	ST	RUC.	DCP	10/10/1	2
							10/16/1	
A	SUB:	REV.	FINA	\LS		JDS	07/31/1	3
CH	CCT TI	TI E.						

EXISTING COLOR CODE

Sprint Frequency	Sprint Indicator	Sprint ID	Carrier	Hybrid Fiber & DC ID Color	DC Cable Colors @ RBS
					Side A
800 # 4 RRU "D"	Yellow	Green	CDMA	Green	GREEN / WHITE
1900 # 1 RRU "C"	Yellow	Red	LTE	RED	RED / BLACK
1900 # 2 RRU "A"	Yellow	Brown	CDMA	Yellow	Wht -Bk & Red-Blk Leads
1900 # 3 RRU "B"	Yellow	Blue	CDMA	Blue	Blue & Orange Leads
1900 # 5 RRU "E"	Yellow	Slate	CDMA	Wht	Gn-BK & Or-BK Leads
				Black Fiber Spare	No DC spare

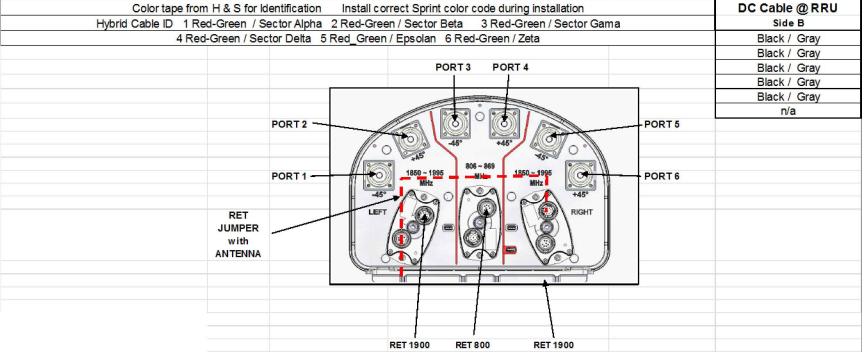


5 RFS ANTENNA & CABLE COLOR CODE SCALE: N.T.S.



FREQUE	NCY COLOR	CODE
FREQLENCY	INDICATOR	ID
800#1	YELLOW	CREEN
1900#1	YELLOW	RED
1900#2	YFLLOW	FIREWN
RESERVED	YELLOW	
RESERVED	YELLOW	SLATE
RESERVED	YELLOW	SPANGE
RESERVED	YELLOW	WHITE
1600#1	YELLOW	DUHELE

3 HYBRID CABLE COLOR CODE SCALE: N.T.S.

2 FREQUENCY COLOR CODE SCALE: N.T.S.

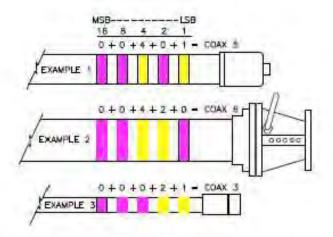

4 MICROWAVE CABLE COLOR CODE

ECTOR A		LOCATION AND INFORMATION O CABLE CONNECTIONS
COLOR CODE	CABLE TYPE	LOCATION
GREEN YELLOW RED	12 COAX JUNIPER	HIOM COMBINER #1 - COM PORT 1 IRS AN IENNA PORT 6 - 1989 COM A
BLUE YELLOW RED	12 COAX JUMPER	HIOM COMBINER 42 - COM PORT 2 IPS AN IENNA PORT 5 - 1986 LTE
CREEN YELLOW BROWN	12 COAX JUNIPER	HIOM COMBINERAL - PORT FI RRU (B) PORT 2 - 1988 COMA
CHEEN YELLOW HED	14 COAX JUNIPER	HIOM COMBINER AT - PORT CT HIND (C) PORT T - 1988 LTE
BLUE YELLOW BROWN	12 COAX JUNITER	HIOM COMBINER AZ - PORT FZ RIKU (B) PORT 1 - 1909 COMA
RIME AFITOM MED	12 COAX JUNIPER	HIOM COMBINER #2 - PORT G2 HIU (C) PORT 2 - 1900 LTE
EKOWN YELLOW CKEN	12 COAX JUNIPER	HIOM HIND (D) - PORT 2 ESMIR PORT TREST - 800 COMA
WHITE YELLOW CREEN	12 COAX JUNITER	HIOM MILIO) - PORES IRIS ANTENNA - PORES - 800 COMA
BROWN YELLOW CREEN	12 COAX JUNITER	FROM ESMR - PORT "ANT" RPS ANTENNA - PORT 4 - 800 CDM /
RED YELLOW BROWN	12 COAX JUMPER	HIOM MILL (A) - PORT 1 HIS ANTENNA - PORT 2 - 1988 COM
STATE YELLOW BROWN	12 COAX JUNITER	HIOM HILL (A) - PORT 2 INS AN IENNA - PORT 1 - 1900 COM
		HIOM INKU (C) NET - TO RESINET
KED YELLOW	REI CABLE 1900 LIE	ACTUATOR #1 - WITH JUNIPER ACTUATOR #3 - 1988 LIE
CREEN YELLOW	REI CABLE 800	HIOM ESMIR HETER REF PORTT - ANTENNA - REFACTUATOR A 2 - 8 COM A
CKEN	REI CABLE 1900 LIE	HROM 1860 (D) RET - TO ESMIR HET RET PORT 2 - 800 COR
BLUE	HYBRIDGABLEFISH	FROM RRU(B) TO JUMPER AT SOURD -
		FROM RRU(B) TO DO LEAD AT SOURCE CONNECTS TO DO TERMINAL BLOCK may
BLUE	HYBRO CABLE DC	OKANCE) = KBS (BLUE
		FROM RRU (A) TO JUNITER AT SOUR -
BROWN	HYBNU CABLE HBER	FROM RRU (A) TO DO LEAD AT SQUID -
BH CAN'N	HYBRO CABLE DC	CONNECTS TO DICTERMINAL BLOCK man TIRLU (A) 1988 COMA" - (WHI-BLK/ RED-BLK LEADS) in RBS
мер	HYBNIO CABLE HIBER	PHOM RRU(C) TO JUMPER AT SOUR - CONNECTS TO DULBLOCK (RED LEAD) in
MED	HYBIND CABLE DC	FROM RIND (C) TO DO LEAD AT SOUR - CONNECTS TO DO FERMINAL BLOCK man FRED (C) 1900 LTE" - (RED / BLACK LE RES
REU	manu Oace od	FROM RIAD (D) (800) TO JUMPER AT SOU
CREEN	HYBRO CABLE HISER	CONNECTS TO BULLBLOCK (CREEN LEAD)
		PROMINING (0) (800) TO DO LEAD ATS CONNECTS TO DO TERMINAL BLOCK IN TRICK STORY OF THE PROPERTY OF THE PROPERT
CHEEN	HYBRO CABLE DC	Res

RFS COAXIAL CABLE COLOR CODE SCALE: N.T.S.





728 Shades Creek PKWY Suite 120 Homewood, AL 35209 Tel: (205) 682—7525

CONSULTANT:



TOGETHER PLANNING A DETTER TOMORROW

158 BUSINESS CENTER DRIVE
BIRMINGHAM, AL 35244

TEL: 205-252-6985 FAX: 205-320-1504


SITE NAME:

SA60XC296

FCC NUMBER:

1223931


SITE ADDRESS: 4719 S ZARZAMORA SAN ANTONIO, TX 78225 BEXAR COUNTY SHERIFF OFFICE

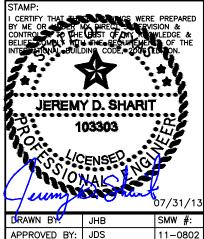


DRAWN BY!	JHB	SMW #:
APPROVED BY:	JDS	11-0802
DATE DRAWN:	08/05/11	
	REVISION	


SHEET TITLE:
PROPOSED COLOR
CODE

HEET NUMBER:

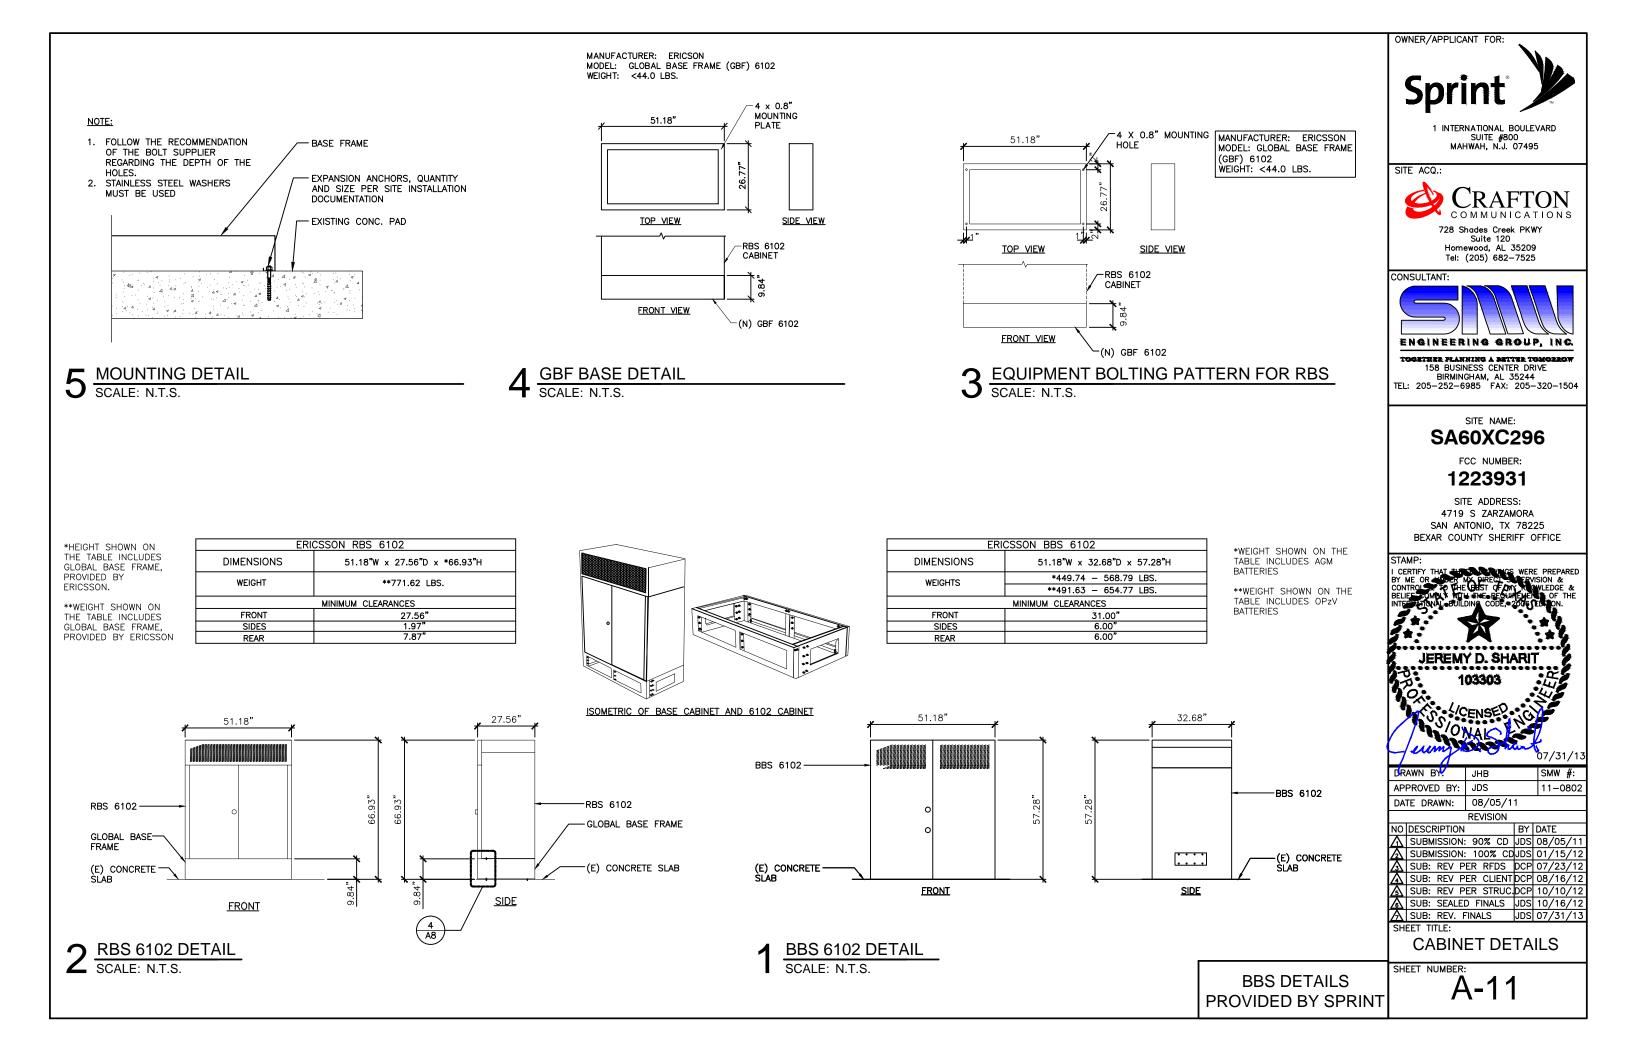


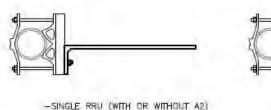


-DOUBLE 1900MHZ FILTERS

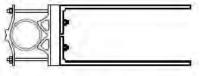

DOUBLE RRU W/A2

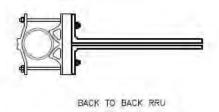

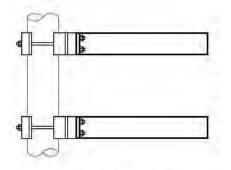

ELEVATION (ALL CONFIGURATIONS)

5 RRUS PDU MOUNTING BRACKET CONFIGURATIONS SCALE: N.T.S.

-DIMENSIONS (H × W × D):


17.8" × 17.0" × 7.2" (INCLUDES SUNSHIELD)

-WEIGHT: 55 LBS

-CLIMATE: -40°C TO +55°C
(SELF CONVECTION SILENT, NO FANS, IP55)

-POWER CONSUMPTION: 200 WATTS (TYP.)

RRU DETAIL
SCALE: N.T.S.

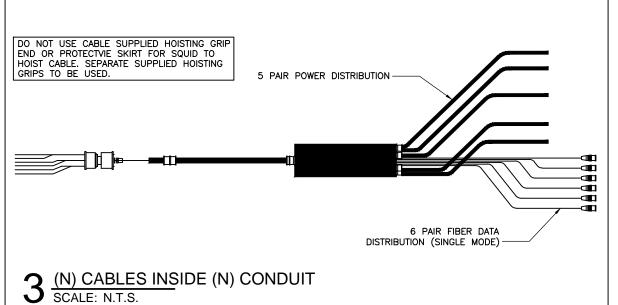


(N) ANTENNA
MOUNTING PIPE
2 1/2" STD. PIPE
(3" O.D.) x 8'-0"
LONG, GALVANIZED
(TYP)

(N) MOUNTING
BRACKET SUPPLIED
W/ANTENNA (TYP)

(N) ANTENNA,
PER PLAN

2 ANTENNA DETAIL SCALE: N.T.S.

ERICSSON RRUS-11

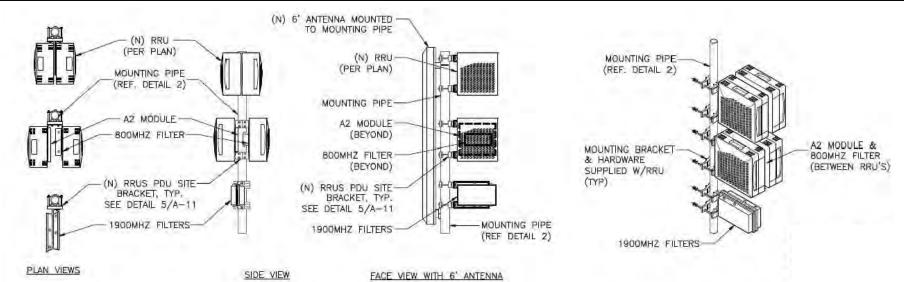

NOTES:

- IF ADDITIONAL MODULES ARE NECESSARY
 USE THE APPROPRIATE CONFIGURATION ON
 MOUNTING PIPES AS SPECIFIED IN THE SITE
 PLAN AND IN ACCORDANCE WIT THE STRUCTURAL
 ANALYSIS OF THE MOUNT.
- 2. GC IS TO INSURE THAT ALL RRU'S RECEIVE ELECTRICAL POWER WITHIN 24 HOURS OF BEING REMOVED FROM THE MANUFACTURES PACKAGING.
- 3. DO NOT OPEN RRU PACKAGING IN THE RAIN.



1 INTERNATIONAL BOULEVARD SUITE #800 MAHWAH, N.J. 07495

SITE ACQ.:



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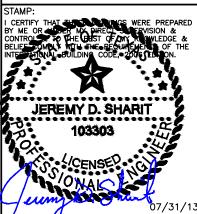
SITE NAME:

SA60XC296

FCC NUMBER:

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SITE ADDRESS: 4719 S ZARZAMORA SAN ANTONIO, TX 78225 BEXAR COUNTY SHERIFF OFFICE



DRAWN BY!	JHB	SMW #:		
APPROVED BY:	JDS	11-0802		
DATE DRAWN:	08/05/11			
DEMISION				

	KEVISION		
NO	DESCRIPTION	BY	DATE
\subseteq	SUBMISSION: 90% CD		
Δ	SUBMISSION: 100% CD	JDS	01/15/12
\Im	SUB: REV PER RFDS	DCP	07/23/12
lacktree	SUB: REV PER CLIENT	DCP	08/16/12
Ճ	SUB: REV PER STRUC.	DCP	10/10/12
4	SUB: SEALED FINALS	SQC	10/16/12
A	SUB: REV. FINALS	JDS	07/31/13
SH	EET TITLE:		

RRU DETAILS

SHEET NUMBER:

Ã-12


RRU 11 PIPE MOUNT DETAIL SCALE: N.T.S.

OUNT DETAIL RRU DETAILS
PROVIDED BY SPRINT

Ericsson MM-BTS RBS 6102		Alarm Contact	Severity	Owner	Comments	Color Code
BTS Scan Point 1	[1000] Utility Power Failure	NC	Major	Service Assurance	RBS/Right OVP1/A4	White/Blue
BTS Scan Point 2	{1200} Generator Failure	NC	Minor	Field Services	RBS/Right OVP1/A5	White/Orang
BTS Scan Point 3	{1201} Generator Running	NC	Minor	DRMS Only	RBS/Right OVP1/A6	White/Green
BTS Scan Point 4	{1202} Generator Low Fuel Threshold Reached	NC	Major	Field Services	RBS/Right OVP1/A7	White / Brown
BTS Scan Point 5	(9000) To wer Top Light Failure, NOTAM Required	NC	Major	Service Assurance	RBS/Right OVP1/A5	White/Slate
BTS Scan Point 6	{9100} To wer Side Light Failure, no NOTAM	NC	Minor	Service Assurance	RBS/Right OVP2/A2	Red/Blue
BTS Scan Point 7	{2008} 1900#1 DBU Fan Failure (cable supplied internal)	NC	Major	Field Services	RBS/Right OVP2/A3	White/Brown
BTS Scan Point 8	{2008} 1900#2 DBU Fan Failure (cable supplied internal)	NC	Major	Field Services	RBS/Right OVP2/A1	White/Brown
BTS Scan Point 9	(2008) 800 DBU Fan Failure (cable supplied internal)	NC	Major	Field Services	RBS/Left OVP1/A1	White/Brown
BTS Scan Point 10	User Defined from Standards Column A Only	NC			RBS/Right OVP1/A8	Red/Orange
BTS Scan Point 11	User Defined from Standards Column A Only	NC			RBS/Right OVP2/A4	Red/Green
BTS Scan Point 12	User Defined from Standards Column A Only	NC			RBS/Right OVP2/A5	Red/Brown
BTS Scan Point 13	User Defined from Standards Column A Only	NC			RBS/Right OVP2/A6	Red/Slate
BTS Scan Point 14	User Defined from Standards Column A Only	NC			RBS/Right OVP2/A7	Black/Blue
BTS Scan Point 15	Climate Alarm BBS 6102 (Cable supplied)	NC		Field Services	RBS/Right OVP1/A2	Red/Orange
BTS Scan Point 16	Open Door BBS 6102 (Cable supplied)	NC		Field Services	RBS/Right OVP1/A1	Black/Brown

3 ALARM DETAIL SCALE: N.T.S.

CONDUIT NOTES: ABBREVIATIONS: ALL FLEX CONDUIT TO BE SEAL **AMPERE** TIGHT CONDUIT OR EQUAL. AMPERE FRAME

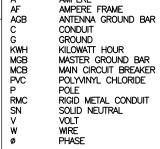

EXISTING SELF-SUPPORT

ELECTRICAL NOTES:

- 1. ALL ELECTRICAL WORK SHALL CONFORM TO THE LATEST EDITION OF THE NATIONAL ELECTRICAL CODE (N.E.C.), AND APPLICABLE LOCAL
- 2. GROUNDING SHALL COMPLY WITH ARTICLE 250 OF NATIONAL ELECTRICAL CODE.
- 3. ALL ELECTRICAL ITEMS SHALL BE U.L. APPROVED OR LISTED.
- 4. ALL WIRES SHALL BE AWG MIN #12 THHN COPPER UNLESS NOTED. 5. CONDUCTORS SHALL BE INSTALLËD IN SCHEDULE 40 PVC CONDUIT
- UNLESS NOTED OTHERWISE. 6. LABEL SPRINT SERVICE DISCONNECT SWITCH AND PPC CABINET
- WITH ENGRAVED LAMACOID LABELS, LETTERS 1" IN HEIGHT.
- 7. ROUTE GROUNDING CONDUCTORS ALONG THE SHORTEST AND STRAIGHTEST PATH POSSIBLE. BEND GROUNDING LEADS WITH A MINIMUM 8" RADIUS.
- 8. ENGAGE AN INDEPENDENT TESTING FIRM TO TEST AND VERIFY THAT RESISTANCE DOES NOT EXCEED 5 OHMS TO GROUND. TEST GROUND RING RESISTANCE PRIOR TO MAKING FINAL GROUND CONNECTIONS TO INFRASTRUCTURE AND EQUIPMENT, GROUNDING AND OTHER OPERATIONAL TESTING SHALL BE WITNESSED BY SPRINTS REPRESENTATIVE.
- 9. PROVIDE PULL BOXES AND JUNCTION BOXES WHERE REQUIRED SO THAT CONDUIT BENDS DO NOT EXCEED 360°.
- 10. OBTAIN PERMITS AND PAY FEES RELATED TO ELECTRICAL WORK PERFORMED ON THIS PROJECT. DELIVER COPIES OF ALL PERMITS TO SPRINT REPRESENTATIVE.
- 11. SCHEDULE AND ATTEND INSPECTIONS RELATED TO ELECTRICAL WORK REQUIRED BY JURISDICTION HAVING AUTHORITY. CORRECT AND PAY FOR ANY WORK REQUIRED TO PASS ANY FAILED INSPECTION.
- 12. REDLINED AS-BUILTS ARE TO BE DELIVERED TO SPRINT REPRESENTATIVE.
- 13. PROVIDE TWO COPIES OF OPERATION AND MAINTENANCE MANUALS IN THREE-RING BINDER.
- 14. FURNISH AND INSTALL THE COMPLETE ELECTRICAL SERVICE, TELCO CONDUIT, AND THE COMPLETE GROUNDING SYSTEM.
- 15. ALL WORK SHALL BE PERFORMED IN STRICT ACCORDANCE WITH ALL APPLICABLE BUILDING CODES AND LOCAL ORDINANCES, INSTALLED IN A NEAT MANNER, AND SHALL BE SUBJECT TO APPROVAL BY SPRINT REPRESENTATIVE.
- 16. CONDUCT A PRE-CONSTRUCTION SITE VISIT AND VERIFY EXISTING SITE CONDITIONS AFFECTING THIS WORK. REPORT ANY OMISSIONS OR DISCREPANCIES FOR CLARIFICATION PRIOR TO THE START OF CONSTRUCTION.
- 17. PROJECT ADJACENT STRUCTURES AND FINISHES FROM DAMAGE. REPAIR TO ORIGINAL CONDITION ANY DAMAGED AREA.
- 18. REMOVE DEBRIS ON A DAILY BASIS. DEBRIS NOT REMOVED IN A TIMELY FASHION WILL BE REMOVED BY OTHERS AND THE RESPONSIBLE SUBCONTRACTOR SHALL BE CHARGED ACCORDINGLY. REMOVAL OF DEBRIS SHALL BE COORDINATED WITH THE OWNER'S REPRESENTATIVE. DEBRIS SHALL BE REMOVED FROM THE PROPERTY AND DISPOSED OF LEGALLY.
- 19. UPON COMPLETION OF WORK, THE SITE SHALL BE CLEAN AND FREE OF DUST AND FINGERPRINTS.
- 20. PRIOR TO ANY TRENCHING, CONTACT LOCAL UTILITY TO VERIFY LOCATION OF ANY EXISTING BURIED SERVICE CONDUITS.

LEGEND:

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(])

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KILOWATT HOUR METER

ON ISULATORS CIRCUIT BREAKER TOGGLE LIGHT SWITCH

JUNCTION BOX GROUND TEST WELL

—F — POWER WIRING

GROUND WIRE

—↑

TELCO WIRING

TELCO W

STEEL GROUND ROD

COPPER GROUND BAR MOUNTED

EXOTHERMIC BONDING CONNECTION 5/8" DIA X 10'-0" COPPER-CLAD

125 VOLT NEMA CONFIGURATION 5-20R DUPLEX RECEPTACLE MOUNTED 16" AFF

21. DOCUMENT GROUND RING INSTALLATION AND CONNECTIONS TO IT WITH PHOTOGRAPHS PRIOR TO BACKFILLING SITE. PRESENT PHOTO ARCHIVE AT SITE "PUNCH LIST" WALK TO SPRINT'S REPRESENTATIVE.

OWNER/APPLICANT FOR:

1 INTERNATIONAL BOULEVARD SUITE #800 MAHWAH, N.J. 07495

SITE ACQ.:



728 Shades Creek PKWY Suite 120 Homewood, AL 35209 Tel: (205) 682-7525

CONSULTANT:



together planning a better tom 158 BUSINESS CENTER DRIVE BIRMINGHAM, AL 35244
TEL: 205-252-6985 FAX: 205-320-1504


SITE NAME:

SA60XC296

FCC NUMBER:

1223931

SITE ADDRESS: 4719 S ZARZAMORA SAN ANTONIO, TX 78225 BEXAR COUNTY SHERIFF OFFICE

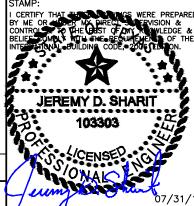

		0//31/13		
DRAWN BY!	JHB	SMW #:		
APPROVED BY:	JDS	11-0802		
DATE DRAWN:	08/05/11			
DEVISION				

		DESCRIPTION		DATE
		SUBMISSION: 90% CD		
		SUBMISSION: 100% CD		
	\Im	SUB: REV PER RFDS	DCP	07/23/12
		SUB: REV PER CLIENT		
	ᡌ	SUB: REV PER STRUC.	DCP	10/10/13
	4	SUB: SEALED FINALS	SQC	10/16/12
	$oldsymbol{\wedge}$	SUB: REV. FINALS	JDS	07/31/13

ËNLARGED UTILITY SITE PLAN

SHEET NUMBER:

EXISTING FENCE EXISTING-PROPOSED 2" POWER-FLEX CONDUIT FROM PROPOSED EQUIPMENT CABINET TO EXISTING (APPROX. 15') PROPOSED 2" TELCO FLEX CONDUIT FROM PROPOSED EQUIPMENT CABINET TO EXISTING PROPOSED SPRINT TELCO BOX (APPROX. 15') CABINE. PROPOSED 1 1/4" ALARM FLEX PROPOSED CONDUIT FROM 6102 BBS PROPOSED CABINET **EQUIPMENT CABINET** TO EXISTING SPRINT TELCO BOX (APPROX. 15') FXISTING-H-FRAME

FXISTING 14'x16'-

EQUIPMENT

PLATFORM


ELECTRICAL / TELCO SITE PLAN (FINAL)

FULL SIZE PLOT: SCALE: 3/8"= 1'-0" HALF SIZE PLOT: SCALE: 3/16"= 1'-0"

NOT USED SCALE: N.T.S TRUE NORTH

TRUE


NORTH

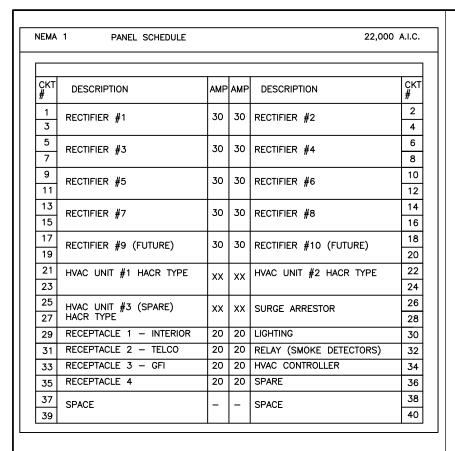


1 EXISTING PANEL SCHEDULE N.T.S.

NEMA	1 PANEL SCHEDULE			22,000	A.I.C.
CKT #	DESCRIPTION	AMP	АМР	DESCRIPTION	CK1
1	RECTIFIER #1	30	30	RECTIFIER #2	2
5 7	RECTIFIER #3	30	30	RECTIFIER #4	6 8
9	RECTIFIER #5	30	30	RECTIFIER #6	10 12
13 15	RECTIFIER #7	30	30	RECTIFIER #8	14 16
17 19	RECTIFIER #9 (FUTURE)	30	30	RECTIFIER #10 (FUTURE)	18 20
21 23	HVAC UNIT #1 HACR TYPE	xx	xx	HVAC UNIT #2 HACR TYPE	22 24
25 27	HVAC UNIT #3 (SPARE) HACR TYPE	xx	xx	SURGE ARRESTOR	26 28
29	RECEPTACLE 1 - INTERIOR	20	20	LIGHTING	30
31 33	RECEPTACLE 2 - TELCO RECEPTACLE 3 - GFI	20	20 20	RELAY (SMOKE DETECTORS) HVAC CONTROLLER	32 34
35	RECEPTACLE 4	20	20	SPARE	36
37 39	PROPOSED RBS (100 AMP)	100	-	SPACE	38 40

3 PROPOSED PANEL SCHEDULE

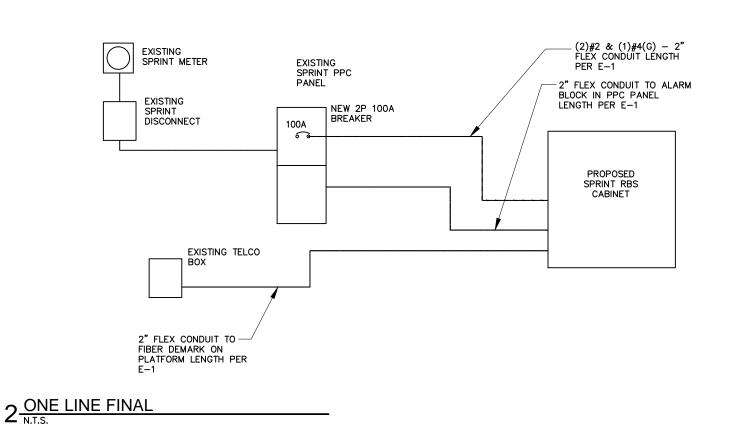

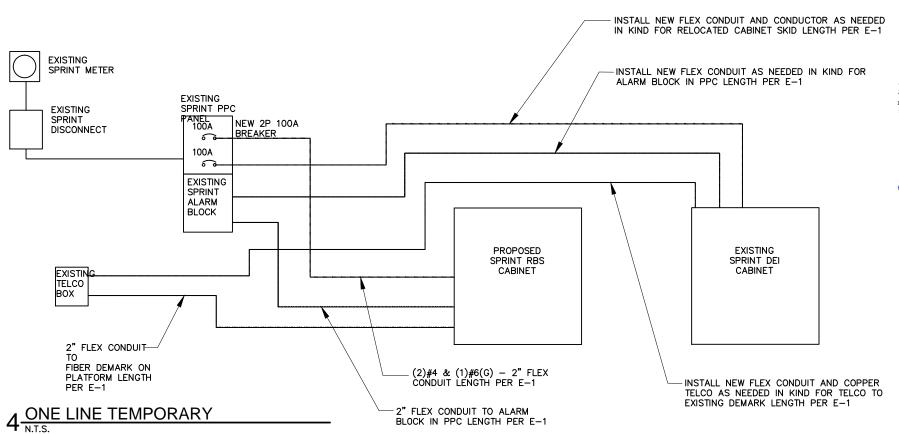



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SITE ACQ.:



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CONSULTANT:



TOGETHER PLANNING A DETTER TOM 158 BUSINESS CENTER DRIVE BIRMINGHAM, AL 35244 TEL: 205-252-6985 FAX: 205-320-1504


SITE NAME:

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FCC NUMBER:

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SITE ADDRESS: 4719 S ZARZAMORA SAN ANTONIO, TX 78225 BEXAR COUNTY SHERIFF OFFICE




1	DRAWN BY:	ILID	SMW #:
	DRAWN BIT	JHB	SMW #:
	APPROVED BY:	JDS	11-0802
	DATE DRAWN:	08/05/11	
		REVISION	

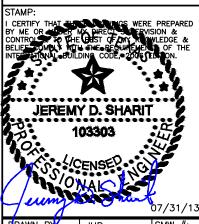NO DESCRIPTION BY DATE SUBMISSION: 100% CDJDS 01/15/12 SUB: REV PER RFDS DCP 07/23/1 SUB: REV PER CLIENT DCP 08/16/12 SUB: REV PER STRUC.DCP 10/10/12 SUB: SEALED FINALS JDS 10/16/12 SUB: REV. FINALS JDS 07/31/13

UTILITY SITE PLAN

SHEET NUMBER:

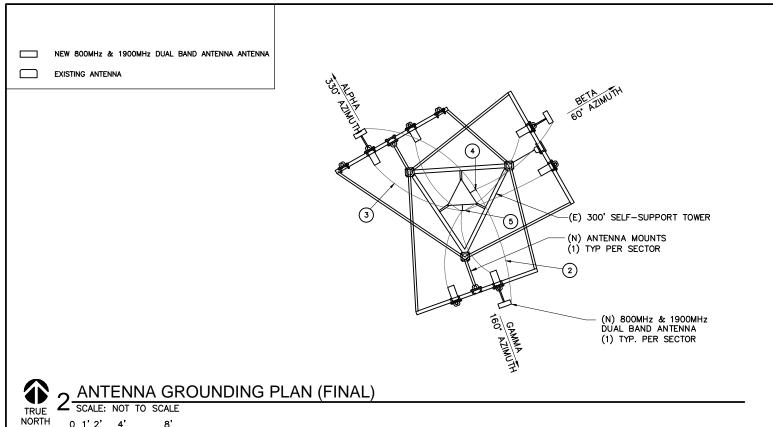

TRUF

TEMPORARY:

- 1 NOT USED
- (2) BOND PROPOSED 1600 LTE ANTENNA PER MANUFACTURER SPECIFICATIONS TO EXISTING ANTENNA GROUND BAR
- 3 BOND PROPOSED RRU PER MANUFACTURER SPECIFICATIONS TO PROPOSED ANTENNA GROUND BAR INSTALLED ON EXISTING MONOPOLE PER DETAIL 1/E-5
- 4 EXISTING ANTENNA GROUND BAR
- 5 PROPOSED ANTENNA GROUND BAR



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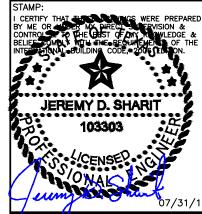
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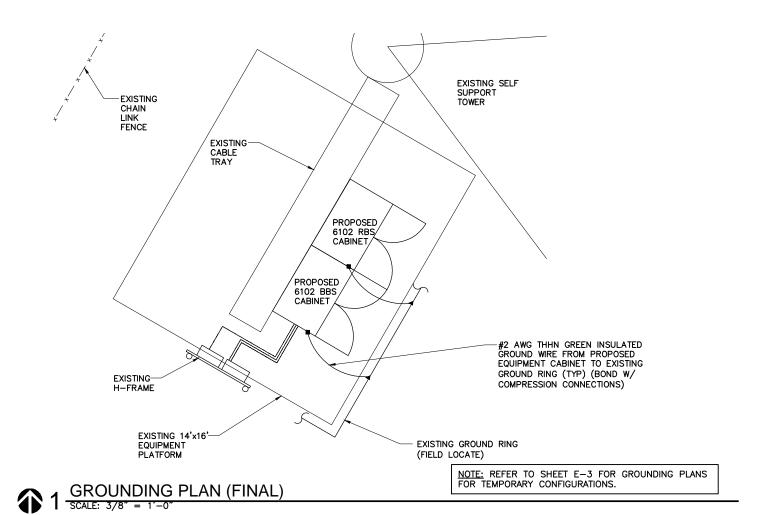
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NO	DESCRIPTION	BY DATE					
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Δ	SUB: REV. FINALS	JDS 07/31/13					
CH	FFT TITLE:						


GROUNDING PLANS (FINAL)

SHEET NUMBER:

E-4



GROUNDING LEGEND:					
SYMBOL	DESCRIPTION				
•	EXOTHERMIC WELD				
	GROUND CONDUCTOR				
=	MECHANICAL CONNECTION				
‡	GROUND ROD EXOTHERMICALLY WELDED TO GROUND RING				
	INTERIOR GROUND LEAD				
×_	CHAIN LINK FENCE				

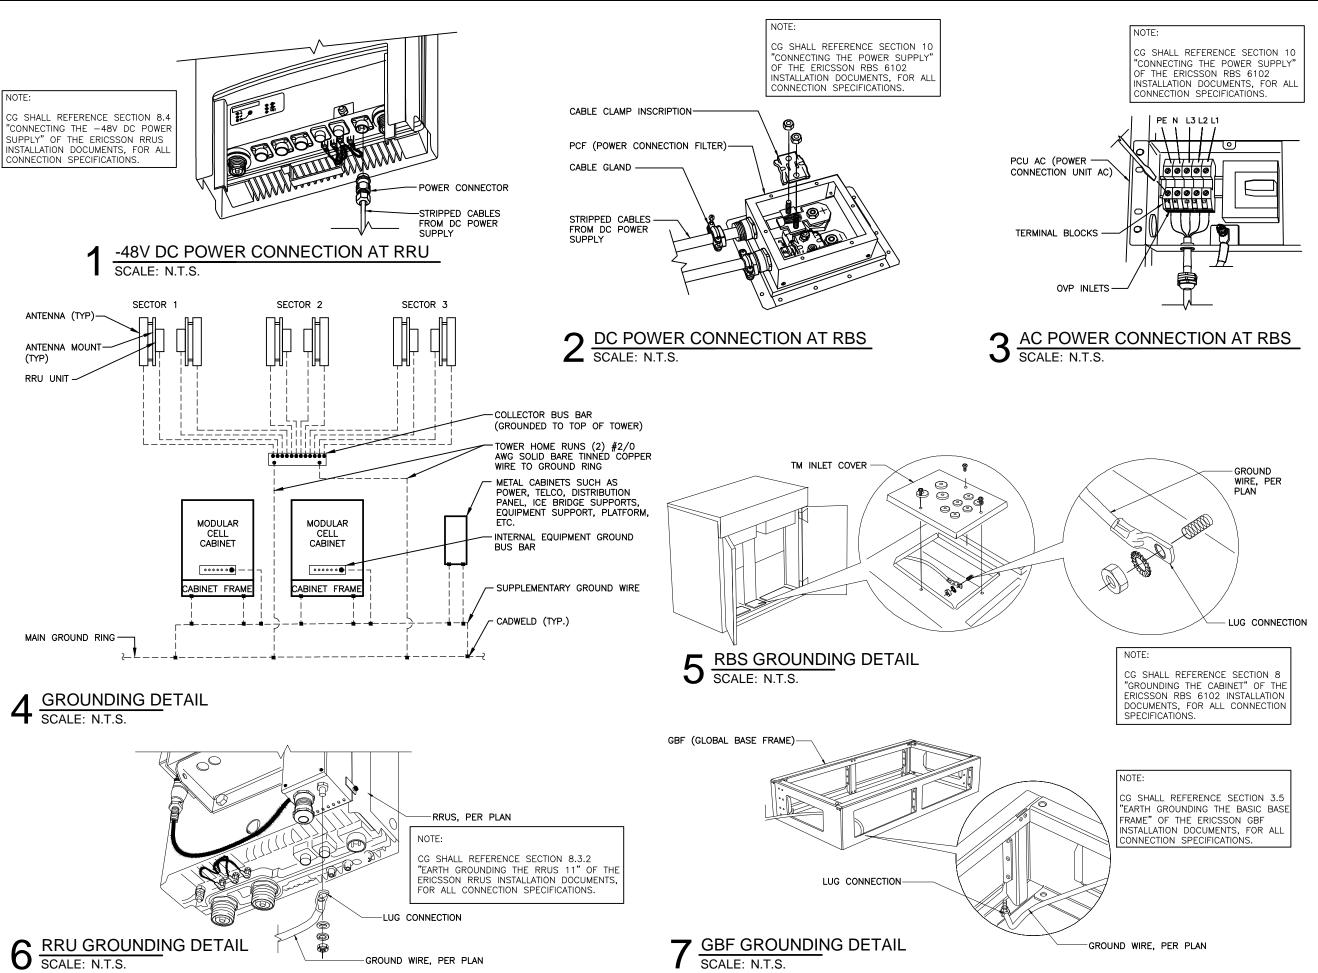

Sprint Sprint

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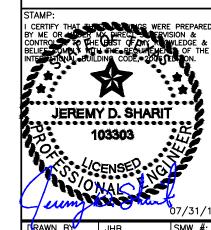
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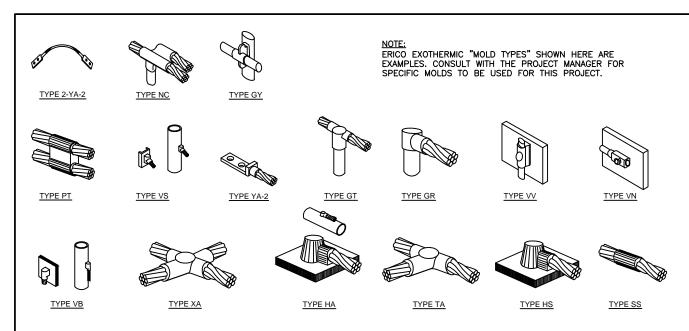
↑ SUB: SEALED FINALS JDS 10/16/12

↑ SUB: REV. FINALS JDS 07/31/13


ELECTRICAL &
GROUNDING DETAILS

SHEET NUMBER:

E-5




EXOTHERMIC WELD DETAILS

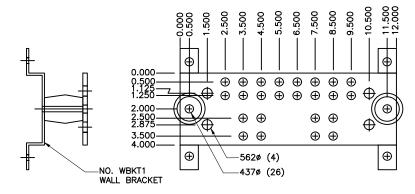

MANUFACTURER: HARGER

3 12" GROUND BAR SCALE: NOT TO SCALE

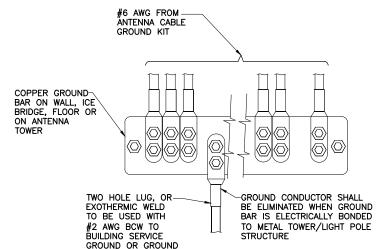

GROUND BAR AT BOTTOM OF TOWERS/LIGHT POLES SHALL ONLY USE EXOTHERMIC WELDS.

5 INSTALLATION OF GROUND WIRE TO GROUND BAR AT GRADE SCALE: NOT TO SCALE

BURNDY LUG WIRE SIZE BOLT SIZE #6 AWG GREEN INSULATED YA6C-2TC38 3/8" - 16 NC S 2 BOLT #2 AWG SOLID TINNED /A3C-2TC38 3/8" - 16 NC S 2 BOLT YA2C-2TC38 3/8" - 16 NC S 2 BOLT #2 AWG STRANDED YA26-2TC38 3/8" - 16 NC S 2 BOLT #2/0 STRANDED YA28-2N 1/2" - 16 NC S 2 BOLT #4/0 STRANDED

NOTES:

- 1. ALL HARDWARE BOLTS, NUTS, LOCK WASHERS SHALL BE STAINLESS STEEL. ALL HARDWARE ARE TO BE AS FOLLOWS: BOLT, FLAT WASHER, GROUND BAR, GROUND LUG, FLAT
- 2. COPPER SHIELD, ANTIOX, OR NO-OX OR EQUIVALENT SHALL BE PLACED WHERE DISSIMILAR METALS CONNECT.
- 3. ALL LUGS ARE TO BE INSTALLED PER MANUFACTURERS SPECIFICATIONS

BURNDY GROUND LUG HEAT SHRINK (SEE TABLE FOR SIZE (CLEAR) AND MODEL) GROUNDING NUT (TYP.)-CONDUCTOR LOCK WASHER (TYP.) FLAT WASHER (TYP.) GROUND BAR-└BOLT (TYP.) BURNDY TWO HOLE LUG WITH LOG BARREL FOR #6 AWG STRANDED OR EQUIVALENT BARE WIRE TO BE NO-OX AT BOTH ENDS #6 AWG STRANDED GREEN ÏNSULATED

2 MECHANICAL LUG CONNECTION SCALE: NOT TO SCALE

NOTES:

- 1. DO NOT INSTALL CABLE GROUND KIT AT A BEND AND ALWAYS DIRECT GROUND WIRE DOWN TO ANTENNA GROUND BAR.
- 2. WEATHER PROOFING SHALL BE TWO-PART TAPE KIT. COLD SHRINK SHALL NOT BE USED.



CONNECTOR -WETHERPROOFING KIT (TYP.) SEE NOTES


ANTENNA CABLE TO RBS EQUIPMENT (TYP.)

> TO GROUND BAR TO GROUND BAR

TX1/RX1

ANTENNA GROUNDING KIT

SCALE: NOT TO SCALE

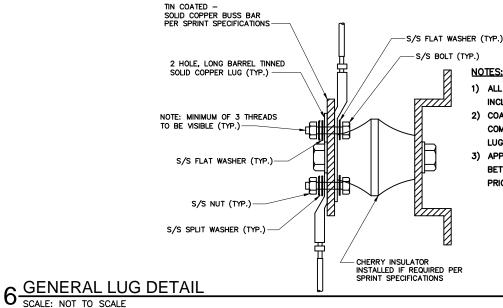

TO ANTENNA

RX2

1) ALL HARDWARE 18-8 STAINLESS STEEL INCLUDING SPLIT WASHERS.

WATERPROOFING

GROUND KIT (TYP.)

COPPER GROUND BAR

WITHOUT INSULATORS

SECTOR MOUNT

MOUNTED ON EXISTING

KIT (TYP.)

#2 AWG

- 2) COAT WIRE END WITH ANTI-OXIDATION COMPOUND PRIOR TO INSERTION INTO LUG BARREL AND CRIMPING.
- 3) APPLY ANTI-OXIDATION COMPOUND BETWEEN ALL LUGS AND BUSS BARS PRIOR TO MATING AND BOLTING.



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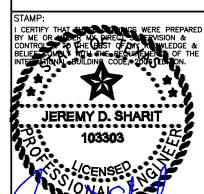
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SMW #: TRAWN BY! JHB APPROVED BY: JDS 11-0802 DATE DRAWN: 08/05/11

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SHEET TITLE:

GROUNDING DETAILS