#### HISTORIC AND DESIGN REVIEW COMMISSION

## June 03, 2015

### Agenda Item No: 28

HDRC CASE NO:	2015-224
COMMON NAME:	7888 Dave Erwin DrBrooks
LEGAL DESCRIPTION:	NCB 10879 P-111 (383.58 AC) 2014) PLAT 9660/130-131
ZONING:	C3 H
CITY COUNCIL DIST.:	3
DISTRICT:	Brooks School of Aerospace Medicine Historic District
APPLICANT:	Gary Dillard/The NRP Group
OWNER:	Brooks Development Authority
TYPE OF WORK:	New Construction
TYPE OF WORK:	New Construction

#### **REQUEST:**

The applicant is requesting final approval to construct Phase II of the Landings apartment complex at brooks City Base.

#### **APPLICABLE CITATIONS:**

The School of Aerospace Medicine Historic Design Guidelines, Chapter 5, Design Guidelines 5.B.2 Location & Orientation of New Buildings

Refer to the Master Plan for appropriate locations of new buildings.

- a. In keeping with the existing development patterns, new buildings should be developed in grouped arrangements around common green space. Site development across the entire campus should not be formal or symmetrical in design.
- b. New buildings should align with existing buildings, being approximately 30 degrees off of north.
- c. New buildings should be sited in such a way as to create green open space on at least one side of the building.
- d. New buildings adjacent to streets or parking should be buffered with street trees and plants.

## 5.A.5 Parking

a. Parking should not encroach on existing greenspaces, except for parking identified in the Master Plan.

b. Parking should be screened from the street with perimeter tree planting, at a rate of 1 tree for every 4 perimeter spaces.

c. Use of trees in the interior of parking lots to provide shade is encouraged. The shade coverage should be no less than what is required by City Code.

d. The parking layout should provide continuous flow of traffic through the lot.

e. The design should allow safe movement of pedestrians from parking to buildings.

f. The design should allow for appropriate landscaping of the parking areas without conflicting with site lighting.

g. The use of pervious materials such as parking pavers or pervious concrete is encouraged.

h. In general, parking lots should be located on the rear or side of buildings. The standard suburban model of parking adjacent to the front door should be avoided.

## 5.C. ARCHITECTURAL DESIGN GUIDELINES

## **5.C.1 GENERAL**

The design of additions and new structures should respond to the character of existing structures, using them as a source of inspiration. New construction should avoid trying to slavishly copy an existing structure or to create an artificial history by duplicating historic styles and designs that are not associated with the campus. For example, even though Spanish Colonial Revival can found at the historic base headquarters, it is not appropriate for School of Aerospace Medicine Historic District which was built primarily in the 1950's and 60's.

## 5.C.3 ADDITIONS AND NEW CONSTRUCTION

Additions and New Construction within the Historic District is encouraged. Over time as new uses are found for older buildings, changes will occur on the campus. The success of attracting new business often leads to a demand for more space. This is good for the long term health of the district. Viable uses and occupied spaces help keep buildings well maintained. New construction adds energy and people to the district. It is the intent of these guidelines to first encourage reuse of existing buildings, secondly to promote additions, and lastly to construct new buildings.

## 5.C.3.a General

4. New construction should blend and balance with the existing buildings by acknowledging and echoing the primary design characteristics of the district.

## 5.C.3.b Location of Additions and New Construction

1. Refer to the Master Plan on page 8 to determine appropriate locations for additions and new construction.

## 5.C.3.c Massing and Height

1. Massing of buildings should be rectilinear.

The massing should be horizontal, rather than vertical. The horizontal dimension should at a minimum be twice as long as the vertical height. It is preferred that the horizontal dimension be three (3) times greater than the height.
 The horizontal massing should be emphasized through the use of strong horizontal hands at top of walls, at rooflines

3. The horizontal massing should be emphasized through the use of strong horizontal bands at top of walls, at rooflines, and at foundations.

4. New construction should be two stories in height, or not to exceed 35 feet.

## 5.C.3.d Roofs

1. Roofs shall be flat. Any slope shall not be visible from the ground.

- 2. Pitched roofs, shed roofs, gable roofs, hipped roofs, mansard roofs, curved roofs, etc. are not allowed.
- 3. Projecting roofs and canopies are allowed as long as the projection is flat.

4. Visual emphasis of a flat roof may be articulated through the use of a strong horizontal band/beam at the parapet.

- 5. Top of parapets shall be flat.
- 6. Mechanical equipment shall be located away from the edge of the roofs and screened with metal panels.

## **5.C.3.e Exterior Wall Materials**

1. All brick used on campus shall match the existing terra-cotta colored brick in color, size, and texture.

2. When constructing an addition the brick shall also match the masonry pattern, spacing and mortar joints of the original building.

3. New construction shall be brick masonry, aluminum storefront, glass, pre-finished metal spandrel panels, or ceramic tile panels similar to materials on the historic campus.

4. Cementious stucco, synthetic stucco, or EIFS systems, tilt wall, fiber cement siding, wood siding, exposed concrete block are prohibited.

5. Stone is prohibited with the exception of limited decorative surrounds that are consistent with existing decorative surrounds in type and size.

6. Metal wall panel systems may be used when adding on to an existing metal sided building. Metal wall panel systems may not be used for any other additions or for new construction.

7. Any other exterior material not expressly prohibited may not be used without the specific approval of the Historic and Design Review Commission.

## 5.C.3.f Foundations

1. Exposed plinth foundations are encouraged.

2. If exposed, foundation walls shall be made of exposed grey concrete to match those found on campus.

3. If exposed, the foundation stem wall shall be set back from the face of the wall construction by no less than one (1) foot.

## 5.C.3.g Windows

4. The spacing and pattern of mass to void, or windows to walls, in new construction should have the same overall pattern as can be found in other historic buildings on campus.

5. In new construction the historic rhythms of mass to void may at times be reversed as long as the overall pattern is sympathetic to the original character of the campus.

6. Uninterrupted wall planes between windows is an important characteristic and should be mimicked in additions and new construction.

7. Windows shall be clear anodized window and/or storefront system, including doors. Bronze and other colored systems are prohibited. Painted hollow metal and wood storefronts are prohibited.

8. In new construction, the common types of windows should be used for general windows and that unique patterns and types should be reserved for use as highlights or accents within a composition.

### 5.C.3.h Exterior Doors

1. Entrance doors should be easily distinguished as a place of entrance.

2. They should be articulated by using glass surrounds, and/or projecting canopies, and/or stone surrounds (as found in Bldg.160.)

3. Entrance doors should be clear anodized aluminum frames with single glass lite panels.

4. A building may have more than one point of entrance. Each pedestrian entrance must be articulated, as defined above.

5. Service doors and emergency exit doors may be painted hollow metal doors without lites.

#### The School of Aerospace Medicine Historic Design Guidelines, Chapter 6, Guidelines for Demolition

#### 6.B. Demolition of Contributing Structures

Demolition of a contributing structure is a serious responsibility and should not be undertaken without serious consideration. Contributing structures are identified in the Brooks Maintenance and Management Manual. Demolitions should be an order of last resort. Each demolition should be considered individually. An earlier demolition should not serve as a precedent for the approval of another demolition.

Below is a list of considerations that can be used to evaluate whether a building may be eligible for demolition. These are not the only considerations for evaluation and in no way supersede the City of San Antonio's Historic Preservation Ordinance.

#### 6.B.1 Historical Significance

The historical significance of a structure refers to the particular historic events, people, construction, design or style associated with a particular building. Is the building a visual reminder of something, or someone or some event associated with the School of Areospace Medicine? A thorough history of the buildings on campus is available in the Historic American Building Survey of the property.

#### **6.B.2** Construction Date

The age of a building is an important consideration regarding the significance of a structure. There are certain events associated with the School of Aerospace Medicine Historic District that stand out as more important than others. The schools relationship and association with early space flight in the United States is important and those buildings associated with the program in the early 1960's are more important than other events that occurred on the campus. Generally the earlier the building was constructed, the more significant. This is not always true and there are other factors besides age, that contribute to the significance.

#### 6.B.3 Environmental and Functional Concerns

Throughout the country, as a result of base closure decisions, many types of military facilities present problems for reuse due to their specific functional design and past activities that cannot be clearly evaluated. Several of the buildings within the School of Aerospace Medicine Historic District primarily functioned in the past as laboratories used for specific scientific research and medical testing. Standard military and scientific programs of the time conducted experiments and research under restrictive covenants and in carefully monitored facilities. Prior to the relocation of the Department of Defense missions, all of The Hill campus buildings were thoroughly assessed for potential environmental impacts associated with past activities, and any necessary clean-up was completed when the facilities were vacated in 2011. Each of these structures was determined to be safe to reutilize. However, continued use of some of the buildings would be extremely difficult because of their highly specific functional design. While appropriate for 1950's and 60's era research, these facilities have become obsolete and would be extremely costly to renovate as modern laboratories or for other uses. Moreover, perceived concerns associated with the types of past research activities (e.g. radiological) that occurred within these facilities remain. Consideration should be given for the limited use of these facilities because of the past military research applications that were performed here, which have no functional counterpart today.

#### 6.B.4 Conformance with the Master Plan

The campus for School of Aerospace Medicine Historic District is part of the larger Brooks City-Base development. It is no longer a military installation. The Master Plan lays out a vision for the future of the campus as part of multi-use complex. Demolition of certain buildings should be considered in the context of the greater complex. Adjacencies are important and how the campus relates to those adjacencies will have a long term effect on the viability of the campus. These factors should be carefully considered prior to the consideration for demolition.

## 6.B.5 Mitigation

One alternative for allowing demolition is providing a mitigation for the loss. If a demolition is to occur, mitigation for demolition might be considered as an alternative. For example, restoration of Building 165, (a non-contributing building) might be considered in lieu of a demolition of another building.

## FINDINGS:


- a. The request for demolition of building 185 and conceptual approval of new construction was approved on January 21, 2015.
- b. The case has been to the DRC on two different occasions (April 7, 2015 & May 12, 2015).
- c. The southwest corner of the property is within the limits of the School of Aerospace Medicine Historic District. The proposed landings apartment complex will consist of three different style buildings. The new student housing area will be composed of six buildings.
- d. Only a portion of building No. 6 will be located within the School of Aerospace Medicine Historic District. Therefore, only building number six will be subject to design review.
- e. The proposed massing of building No. 6 is rectilinear and horizontal. The horizontal dimension is at least twice as long as the vertical height and this consistent with guideline, 5.C.3.c. 1-3. Based on drawings and renderings submitted by the applicant, the design of the proposed new construction appears to be generally consistent with the character of the existing structures within the district. This is consistent with the School of Aerospace Medicine Design Guidelines 5.C1.
- f. The side parking lot illustrated in the submitted design is consistent with 5.A.5.h.The guideline states that, "parking lots should be located on the rear or side of the building. The standard suburban model of parking adjacent to the front door should be avoided."
- g. The height of the proposed building exceeds 35 feet. This is not consistent with guideline, 5.C.3.c.4., which states that the height of new construction should not exceed 35 feet; however, the strong rectilinear shape still emphasizes the horizontality of the building.
- h. The School of Aerospace Medicine Historic Design Guidelines, Chapter 5, Section *5.C.3.d. states that*, "roofs shall be flat." However, Staff finds that the proposed low-sloped, asphalt-shingled roof would be appropriate. The guidelines recommend a flat roof, but the applicant is proposing a slightly sloped parapet to conceal mechanical equipment. The DRC addressed the issue of the sloped roof and the applicant has worked with the committee to mitigate its visual presence.
- i. The exterior wall materials will consist of brick and stucco. The proposed brick shall match the existing terracotta colored brick used in the surrounding buildings. This is consistent with recommended exterior wall materials as stated in guideline 5.C.3.e.4. The proposed stucco finish is prohibited per guideline 5.C.3.e.4., which states that, "Cementious stucco, synthetic stucco, or EIFS systems, tilt wall, fiber cement siding, wood siding, exposed concrete block are prohibited." The design guidelines state, "New construction shall be brick masonry, aluminum storefront, glass, pre-finished metal spandrel panels, or ceramic tile panels similar to materials on the historic campus." Though the guidelines do not permit the use of stucco, the proposed finish and colors of the stucco appear to be compatible within the historic district.
- j. The window patterns are appropriate and are more vertical than horizontal and are sympathetic to the original character of the campus. This is consistent with 5.C.3.g.4-5. The proposed aluminum windows are consistent with the guideline, 5.C.3.7. This guideline states that, "Windows shall be clear anodized window and/or storefront systems, including doors."

## **RECOMMENDATION:**

Staff recommends approval based on items a through j.


## CASE MANAGER:

Alyson Smith

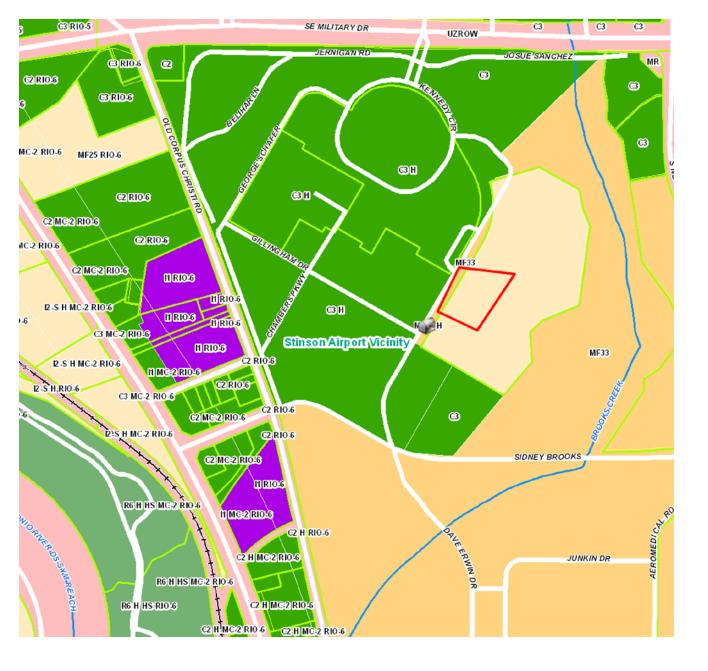

Printed:May 28, 20	N	7888 Dave Erwin Drive	
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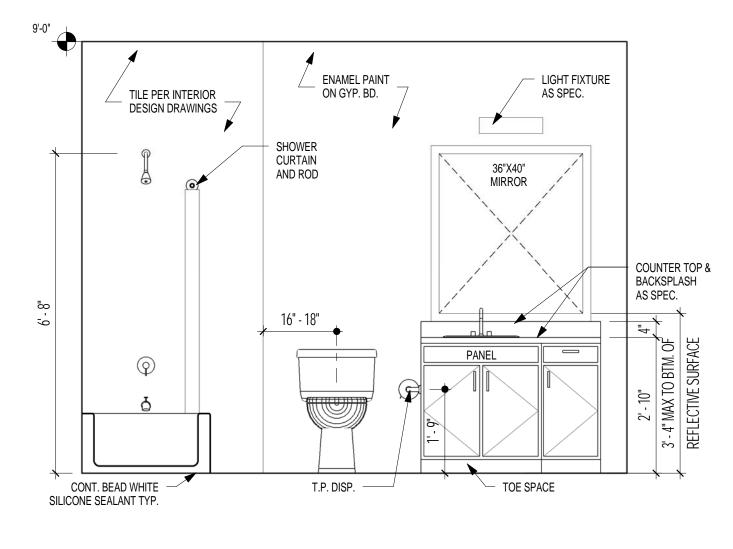
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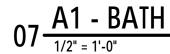
# **NRP GROUP LLC BROOKS APARTMENTS II**


# SAN ANTONIO, TEXAS
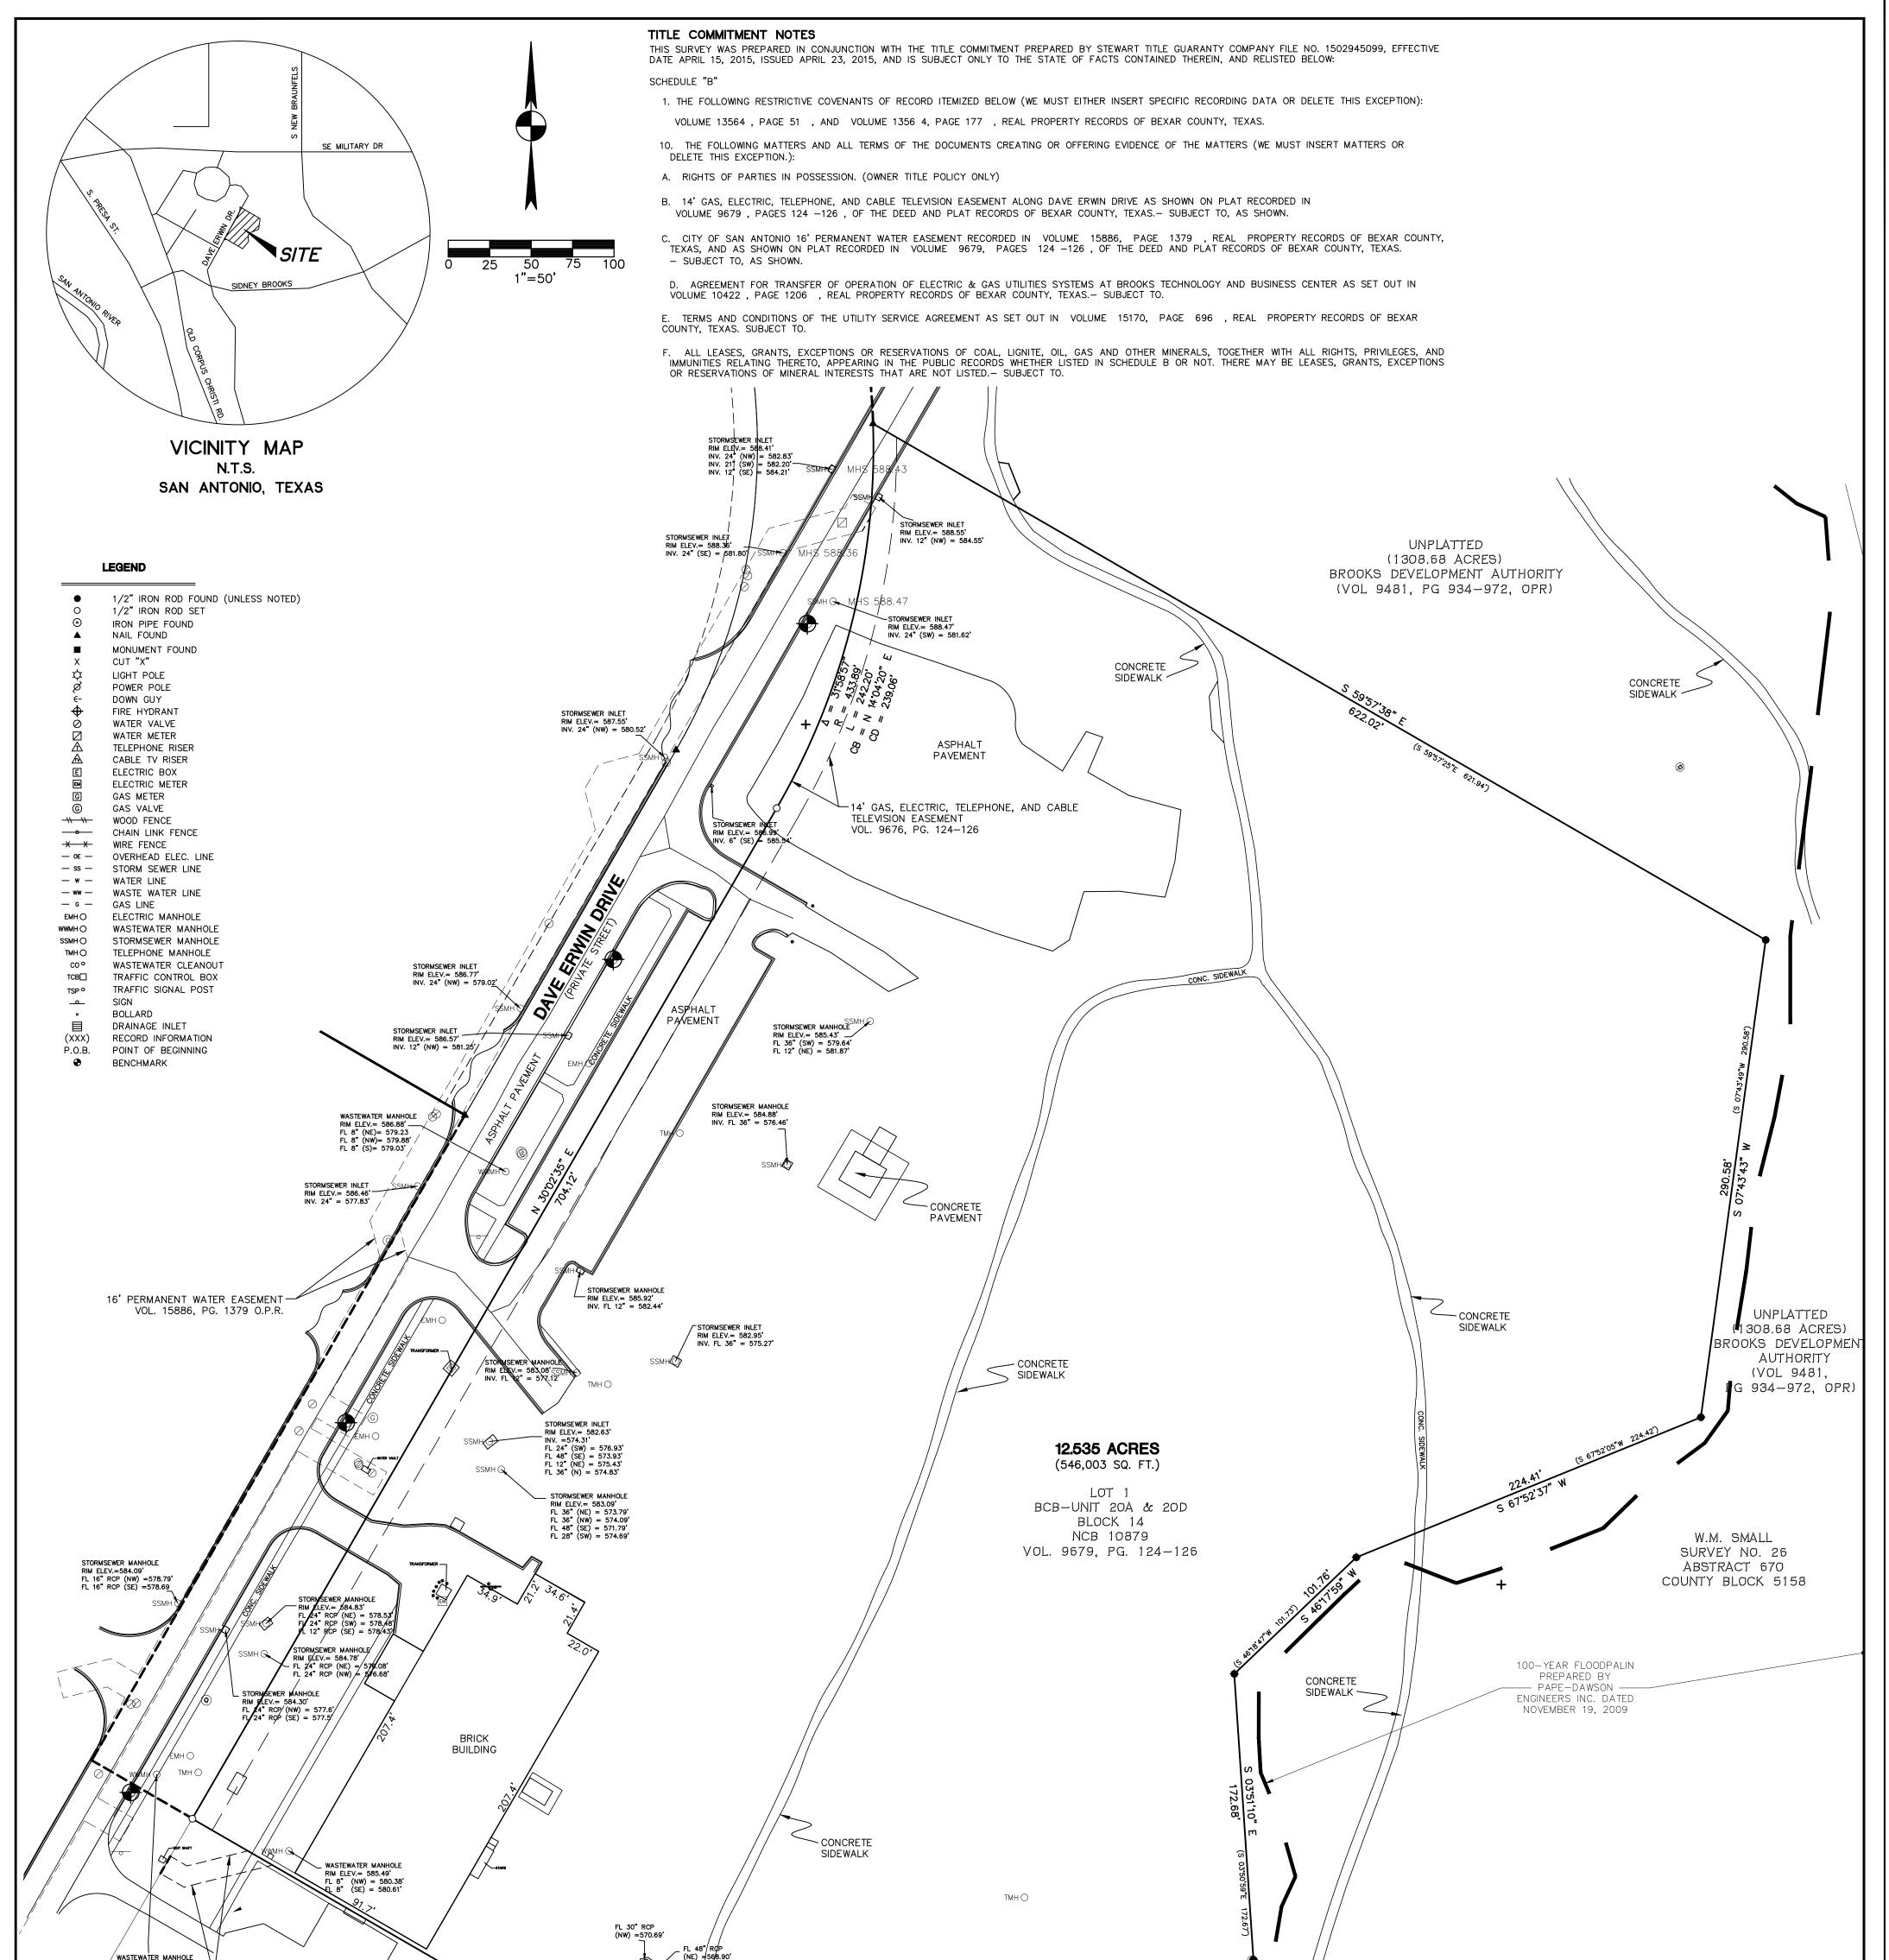
# HDRC SUBMITTAL







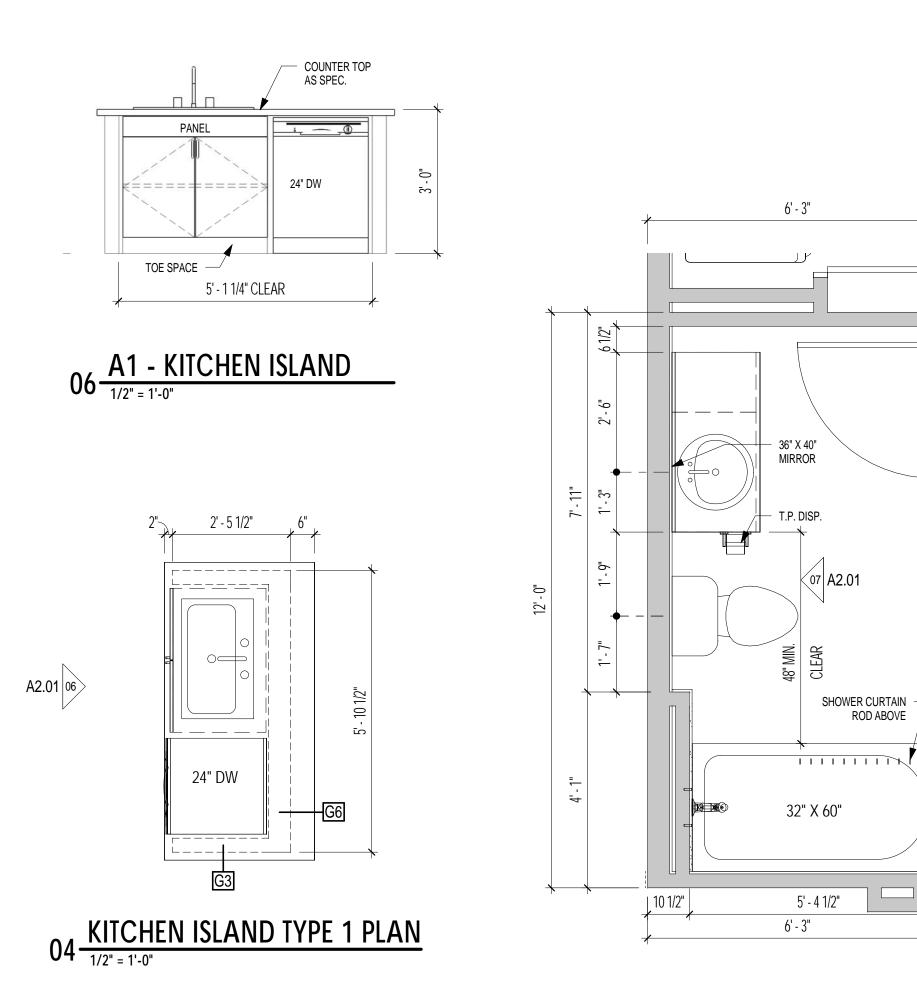


03 A1 - ENLARGED BATH PLAN


## **CABINETRY LEGEND** UNIT PLAN GENERAL NOTES


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VD XX	VANITY DRAWER BANK CAB
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W XX DENOTES DENOTES CAB. CAB. TYPE-WIDTH IN INCHES

NOTE: G.C. TO SUBMIT BASE CAB. HEIGHT. IF SELF-RIMMING SINK IS USED, G.C. TO ENSURE THAT T.O. SINK DOES NOT EXCEED 36" A.F.F. AT TYPICAL UNITS AND 34" A.F.F. AT HANDICAP UNITS.



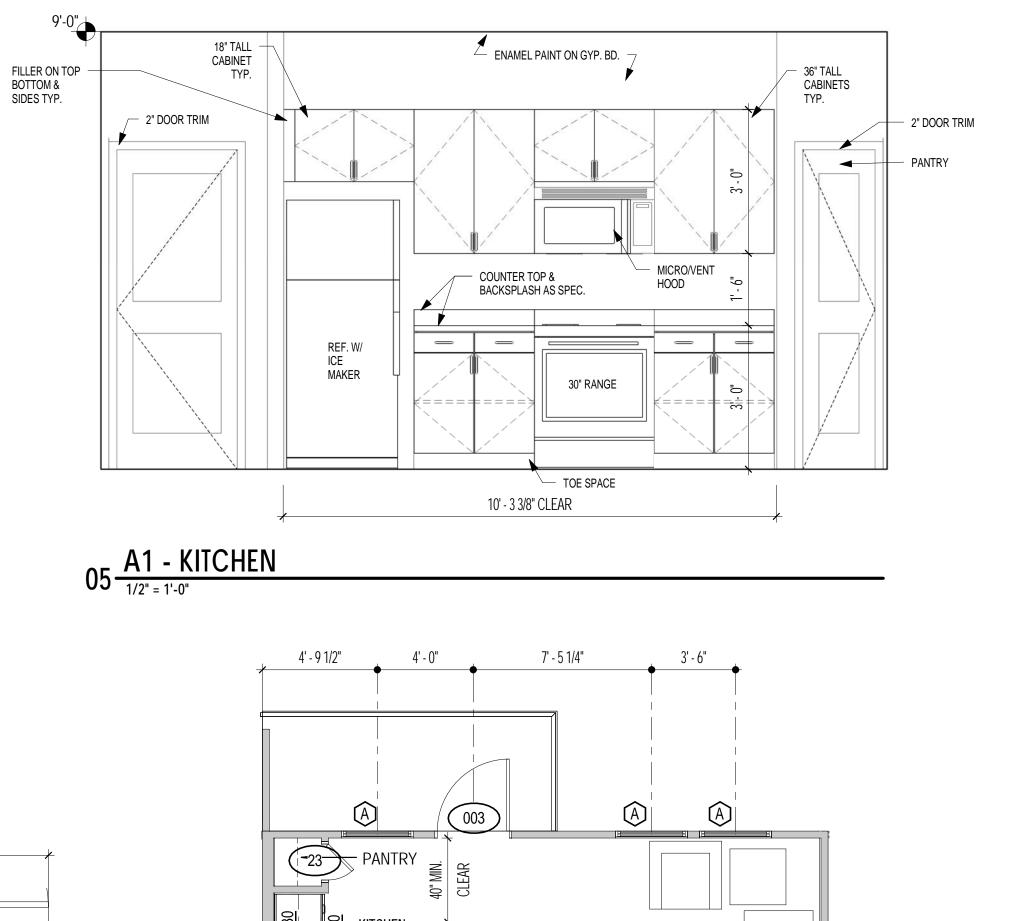

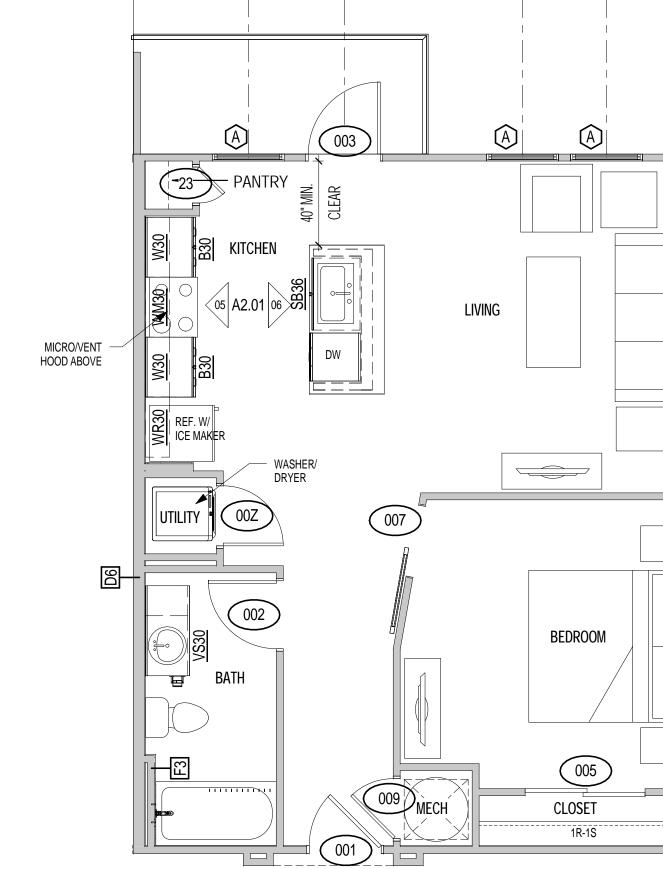
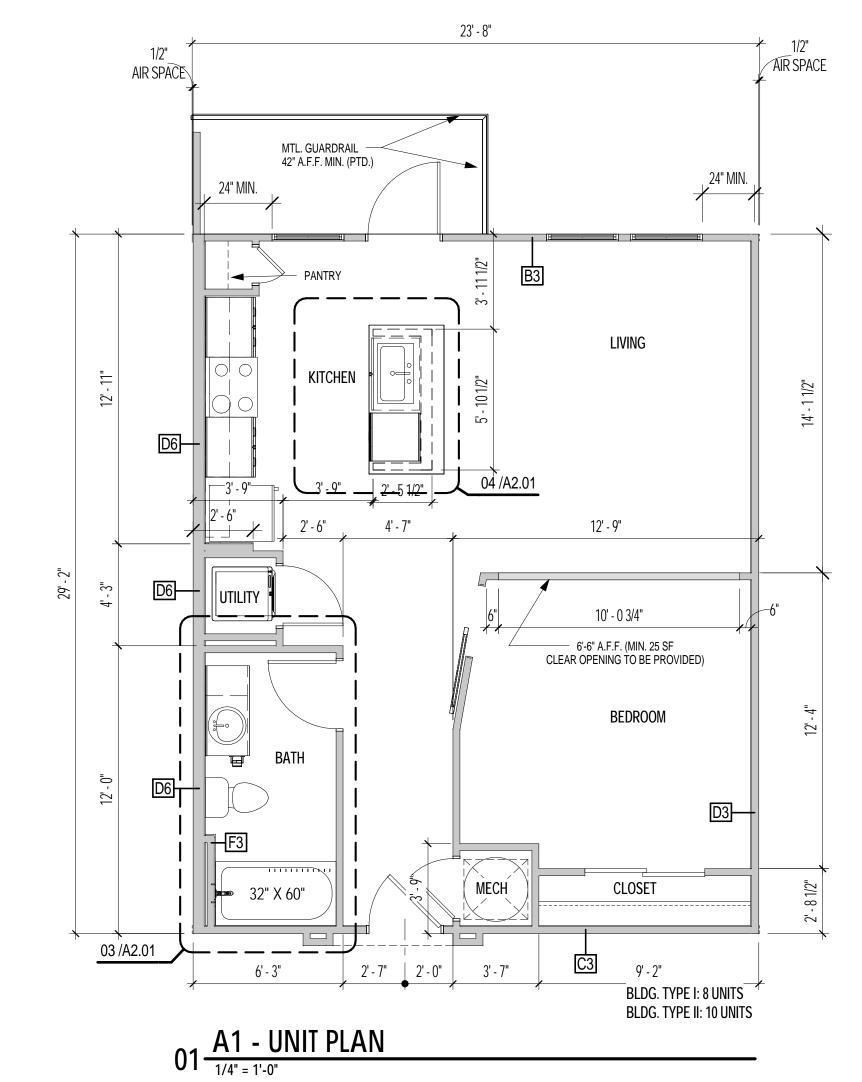
## 02 <u>A1 - FURNITURE PLAN</u>

· ·	2.	ALL DIMENSIONS ARE TO FACE OF STUD U.N.O., 2X4 (ACTUAL SIZE 1 1/2"X3 1/2") OR 2X6 (ACTUAL
		SIZE 1 1/2"X 5 1/2").
	3.	PROVIDE WOOD BLOCKING FOR ALL ACCESSORIES AS REQ'D, INCLUDING TOWEL BARS, GRAB BARS,
		ELECTRICAL FIXTURES AND SHOWER SEATS. REF. 04/A2.00 FOR GRAB BAR BLOCKING LOCATIONS.
NET	4.	DOOR SCHEDULE & WINDOW SCHEDULE ARE LOCATED ON SHEET A 7.10.
	5.	ALL ANGLES ARE 45 DEG. TO HORIZONTAL & VERTICAL TYP, ALL UNITS, U.N.O.
	6.	HATCH INDICATES FURR DOWN TO 8'-0" U.N.O.
	7.	REF. ID DRAWINGS FOR FINISH SCHEDULE
IET	8.	REFER TO SHEET A7.01 FOR HORIZONTAL ASSEMBLIES.
	9.	REF. SHEETS A0.01A-A0.03C FOR ACCESSIBILITY DESIGN STANDARDS AND MOUNTING HEIGHTS.
	10.	WASHER TO BE ON LEFT SIDE AT ALL UTIL. LOCATIONS U.N.O.
	11.	PROVIDE ONE 2A:10B:C FIRE EXTINGUISHER AT EACH UNIT.
	12.	ALL INTERIOR UNIT PARTITIONS ARE WALL TYP 'A3' U.N.O.; REF TO SHEET A7.00 FOR ASSEMBLY

1. INTERIOR WALLS TO HAVE R-11 FIBERGLASS INSULATION AS INDICATED.

- DESCRIPTION. 13. ALL ENTRY DOOR ROUGH OPENINGS ARE TO BE LOCATED 5" OFF FACE OF FRAMING FROM HINGE
- SIDE OF DOOR, U.N.O. 14. ALL ROUGH DOOR OPENINGS W/IN UNITS ARE TO BE LOCATED 4" OFF FACE OF FRAMING FROM HINGE SIDE OF DOOR, U.N.O.
- 15. ALL UTILITY, COAT, PANTRY, & LINEN CLOSET DOORS TO BE CENTERED W/IN THE INTERIOR DIMENSION OF CLOSETS, U.N.O.
- 16. ALL HATCH INDICATES LOAD BEARING WALL CONSTRUCTION; G.C. TO VERIFY W/ STRUCTURAL DRAWINGS.
- 17. ALL LINES & EQUIPMENT TO BE HOUSED IN FIRE-RATED BOXES WHEN LOCATED IN FIRE-RATED WALL ASSEMBLIES. BOXES TO HAVE MIN. FIRE RATING OF WALL ASSEMBLY. 18. REFER TO UNIT PLANS FOR CABINET WIDTHS.
- 19. ALL BASE CABINETS UNDER SINK/LAVATORY IN HC-DESIGNATED UNITS ARE TO BE ADJUSTABLE OR REPLACEABLE TO MEET ANSI A117.1 ALL EXPOSED PIPES ARE TO BE PROTECTED (COVERED OR INSULATED). FLOOR FINISH TO EXTEND UNDER SUCH CABINETRY, WALLS BEHIND AND SURROUNDING SUCH CABINETRY ARE TO BE FINISHED
- 20. ALL H.C. UNITS TO COMPLY WITH ANSI A117.1, REF A0.01A & A0.01B.
- 21. REFERENCE OVERALL THIRD LEVEL PLANS FOR AREAS OF RAISED CEILINGS.
- 22. REINFORCEMENT FOR GRAB BARS SHALL BE INSTALLED PER ANSI ICC A117.1 SECTION 1003.11.4.

**ARTMENTS** S TEXA SAN ANTONIO, AP BROOKS NRP Group LLC 200 Concord Plaza Drive, Suite

## <u>OWNER</u>

900 San Antonio, TX 78216 Mark Johnson P: 972.899.6140

CIVIL ENGINEER

STRUCTURAL ENGINEER Lalonde Engineering Inc. 6617 Red Bud Road Fort Worth, Tx 76135 Phillippe Lalonde 817.307.8266

MEP ENGINEER Lwanda & Company, LLC 6136 Frisco Square Blvd. Suite 400 Frisco, TX 75034 Joe Nyanjom 469.287.5488

## gsr and rad ARCHITECT

4121 Commerce St. Ste.

Dallas, Texas 75226 P 214.824.7040

F 214.887.0559

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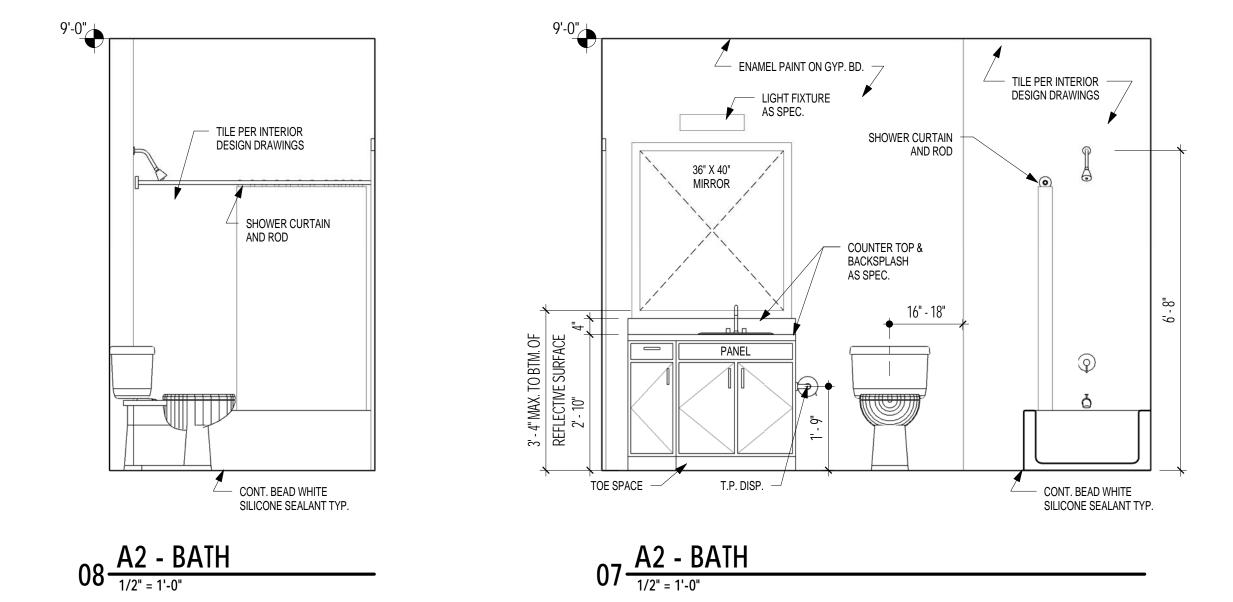
INTERIM REVIEW DOCUMENTS This document is preliminary and is not intended for Regulatory Approval, Permit, or Construction Purposes. This document is issued under the authority of Fernando J. Andrade, 17868 on 05-15-15.


Revisions:							


## Date: HDRC Submittal 05-15-15 Project No. 2310 Drawn By: Author Checked By: MB Sheet Title:

A1 - UNIT PLAN

Drawing No. A2.01



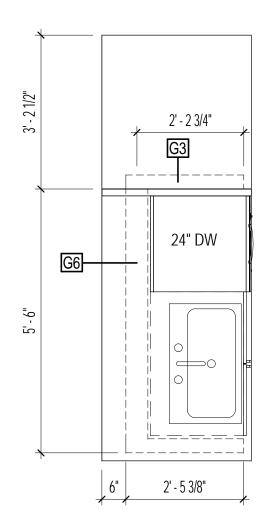

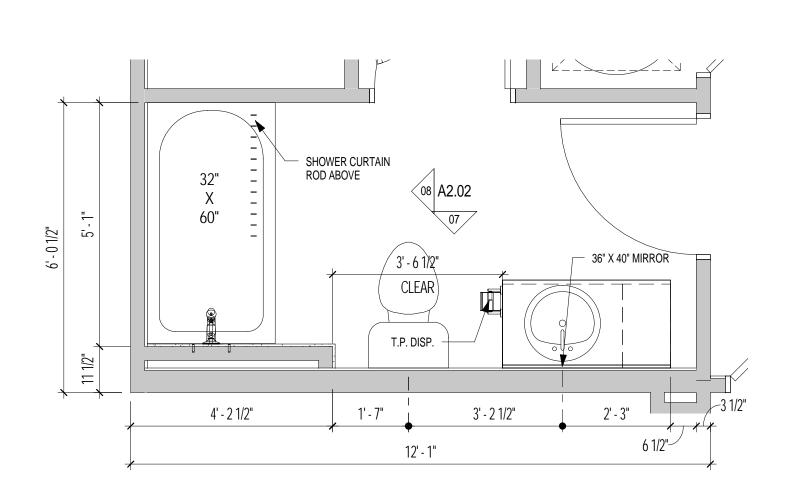

04 KITCHEN ISLAND TYPE 2 PLAN




## **CABINETRY LEGEND**


W XX	WALL CABINET
WM XX	WALL CABINET ABOVE MICI
WR XX	WALL CABINET ABOVE REF
B XX	BASE CABINET
RB XX	REMOVABLE BASE CABINE
SB XX	SINK BASE CABINET
RSB XX	REMOVABLE SINK BASE CA
P XX	PANTRY CABINET
VB XX	VANITY BASE CABINET
VS XX	VANITY SINK BASE CABINE
VD XX	VANITY DRAWER BANK CAE
LXX	LINEN CABINET

WXX DENOTES DENOTES CAB. CAB. TYPE-WIDTH IN INCHES

NOTE: G.C. TO SUBMIT BASE CAB. HEIGHT. IF SELF-RIMMING SINK IS USED, G.C. TO ENSURE THAT T.O. SINK DOES NOT EXCEED 36" A.F.F. AT TYPICAL UNITS AND 34" A.F.F. AT HANDICAP UNITS.

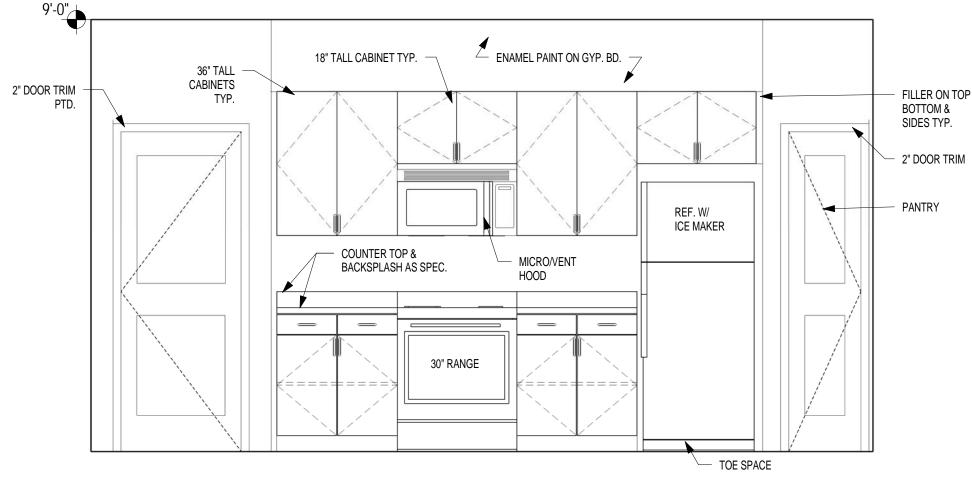

06 <u>A2 - KITCHEN</u>

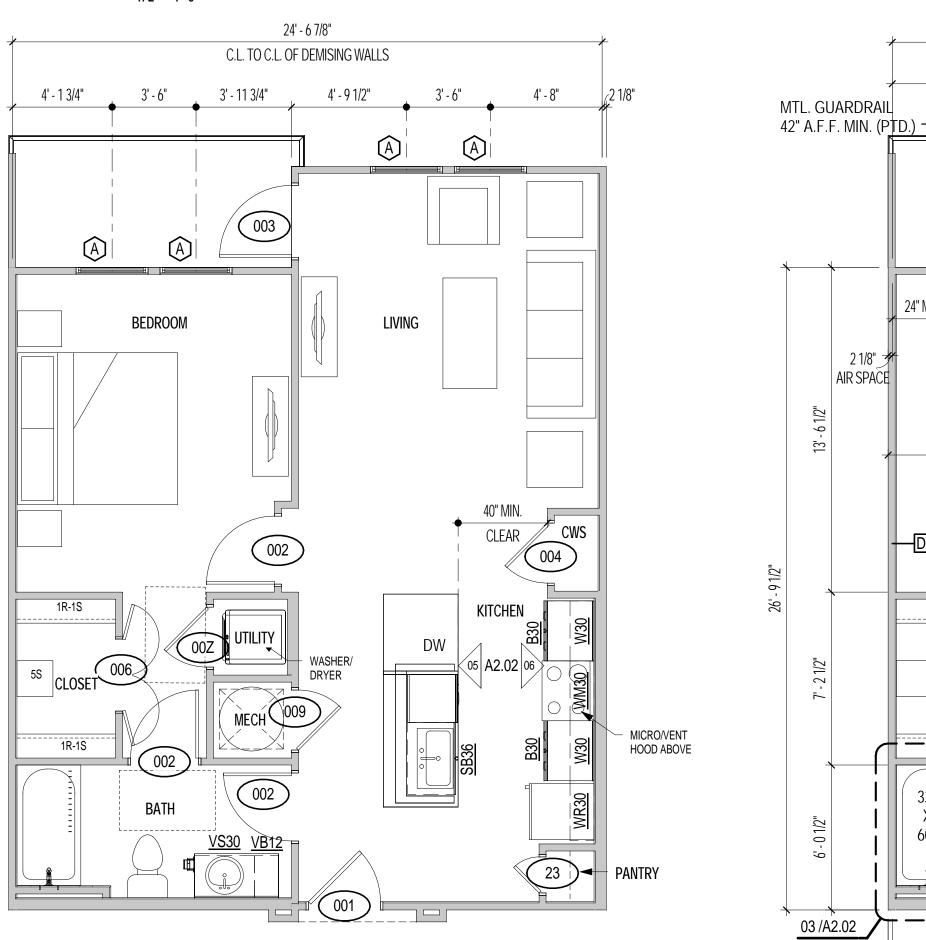

## 02<u>A2 - FURNITURE PLAN</u>

## CRO.

- ABINET


ABINET

## UNIT PLAN GENERAL NOTES

1. INTERIOR WALLS TO HAVE R-11 FIBERGLASS INSULATION AS INDICATED.

- 2. ALL DIMENSIONS ARE TO FACE OF STUD U.N.O., 2X4 (ACTUAL SIZE 1 1/2"X3 1/2") OR 2X6 (ACTUAL SIZE 1 1/2"X 5 1/2"). 3. PROVIDE WOOD BLOCKING FOR ALL ACCESSORIES AS REQ'D, INCLUDING TOWEL BARS, GRAB BARS, ELECTRICAL FIXTURES AND SHOWER SEATS. REF. 04/A2.00 FOR GRAB BAR BLOCKING LOCATIONS. 4. DOOR SCHEDULE & WINDOW SCHEDULE ARE LOCATED ON SHEET A 7.10. 5. ALL ANGLES ARE 45 DEG. TO HORIZONTAL & VERTICAL TYP, ALL UNITS, U.N.O. 6. HATCH INDICATES FURR DOWN TO 8'-0" U.N.O. 7. REF. ID DRAWINGS FOR FINISH SCHEDULE 8. REFER TO SHEET A7.01 FOR HORIZONTAL ASSEMBLIES. 9. REF. SHEETS A0.01A-A0.03C FOR ACCESSIBILITY DESIGN STANDARDS AND MOUNTING HEIGHTS. 10. WASHER TO BE ON LEFT SIDE AT ALL UTIL. LOCATIONS U.N.O. 11. PROVIDE ONE 2A:10B:C FIRE EXTINGUISHER AT EACH UNIT. 12. ALL INTERIOR UNIT PARTITIONS ARE WALL TYP 'A3' U.N.O.; REF TO SHEET A7.00 FOR ASSEMBLY DESCRIPTION. 13. ALL ENTRY DOOR ROUGH OPENINGS ARE TO BE LOCATED 5" OFF FACE OF FRAMING FROM HINGE SIDE OF DOOR, U.N.O. 14. ALL ROUGH DOOR OPENINGS W/IN UNITS ARE TO BE LOCATED 4" OFF FACE OF FRAMING FROM HINGE SIDE OF DOOR, U.N.O.
  - 15. ALL UTILITY, COAT, PANTRY, & LINEN CLOSET DOORS TO BE CENTERED W/IN THE INTERIOR DIMENSION OF CLOSETS, U.N.O.
  - 16. ALL HATCH INDICATES LOAD BEARING WALL CONSTRUCTION; G.C. TO VERIFY W/ STRUCTURAL DRAWINGS.
  - 17. ALL LINES & EQUIPMENT TO BE HOUSED IN FIRE-RATED BOXES WHEN LOCATED IN FIRE-RATED WALL ASSEMBLIES. BOXES TO HAVE MIN. FIRE RATING OF WALL ASSEMBLY. 18. REFER TO UNIT PLANS FOR CABINET WIDTHS.
  - 19. ALL BASE CABINETS UNDER SINK/LAVATORY IN HC-DESIGNATED UNITS ARE TO BE ADJUSTABLE OR REPLACEABLE TO MEET ANSI A117.1 ALL EXPOSED PIPES ARE TO BE PROTECTED (COVERED OR INSULATED). FLOOR FINISH TO EXTEND UNDER SUCH CABINETRY, WALLS BEHIND AND SURROUNDING SUCH CABINETRY ARE TO BE FINISHED
  - 20. ALL H.C. UNITS TO COMPLY WITH ANSI A117.1, REF A0.01A & A0.01B.
  - 21. REFERENCE OVERALL THIRD LEVEL PLANS FOR AREAS OF RAISED CEILINGS. 22. REINFORCEMENT FOR GRAB BARS SHALL BE INSTALLED PER ANSI ICC A117.1 SECTION 1003.11.4.

2" DOOR TRIM

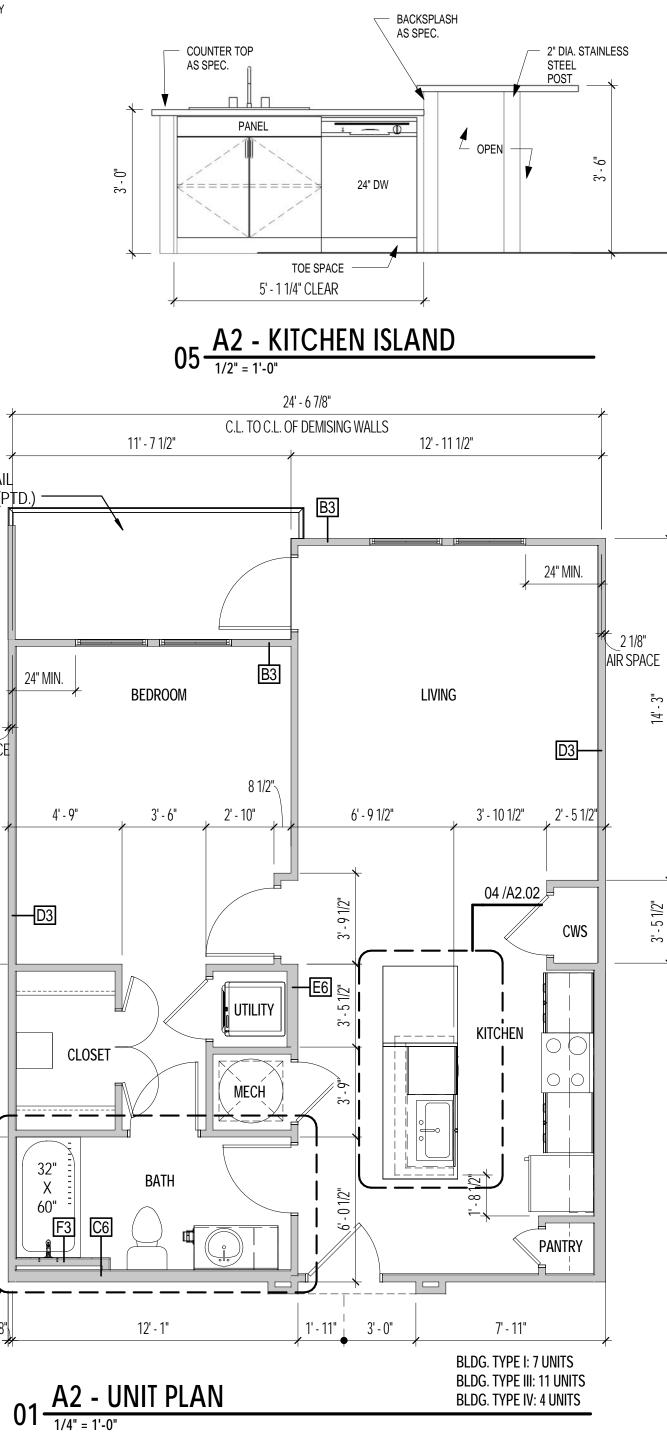

## **ARTMENTS** S TEXA ANTONIO BROOKS SAN <u>OWNER</u> NRP Group LLC 200 Concord Plaza Drive, Suite 900 San Antonio, TX 78216 Mark Johnson P: 972.899.6140 CIVIL ENGINEER STRUCTURAL ENGINEER Lalonde Engineering Inc. 6617 Red Bud Road Fort Worth, Tx 76135 Phillippe Lalonde 817.307.8266 MEP ENGINEER Lwanda & Company, LLC 6136 Frisco Square Blvd. Suite 400 Frisco, TX 75034 Joe Nyanjom 469.287.5488 gsr and rad ARCHITECT 4121 Commerce St. Ste. Dallas, Texas 75226 P 214.824.7040 F 214.887.0559 copyright 2010 © gsr | andrade architects, inc. INTERIM REVIEW DOCUMENTS This document is preliminary and is not intended for Regulatory Approval, Permit, or Construction Purposes. This document is issued under the authority of Fernando J. Andrade, 17868 on 05-15-15. **Revisions:**

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hecker
heet Title:
2 - UNIT PLAN
rowing No

Date:

05-15-15

Project No.


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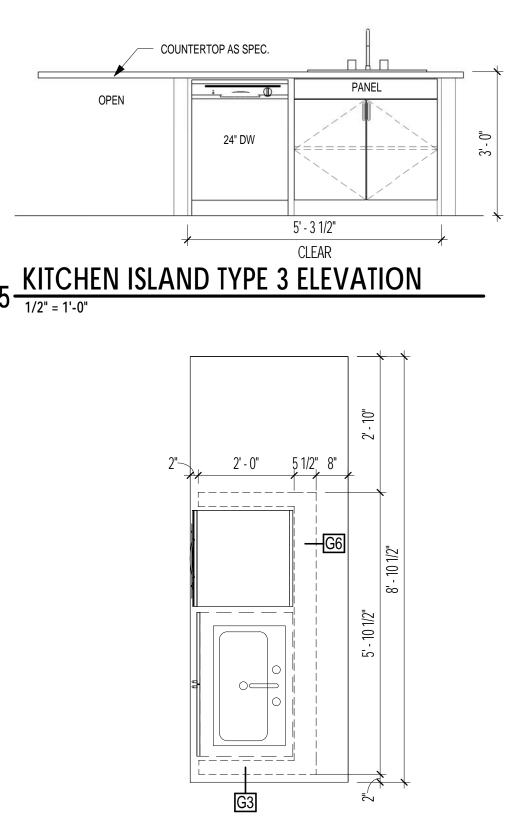
Author


Drawn By:

HDRC Submittal





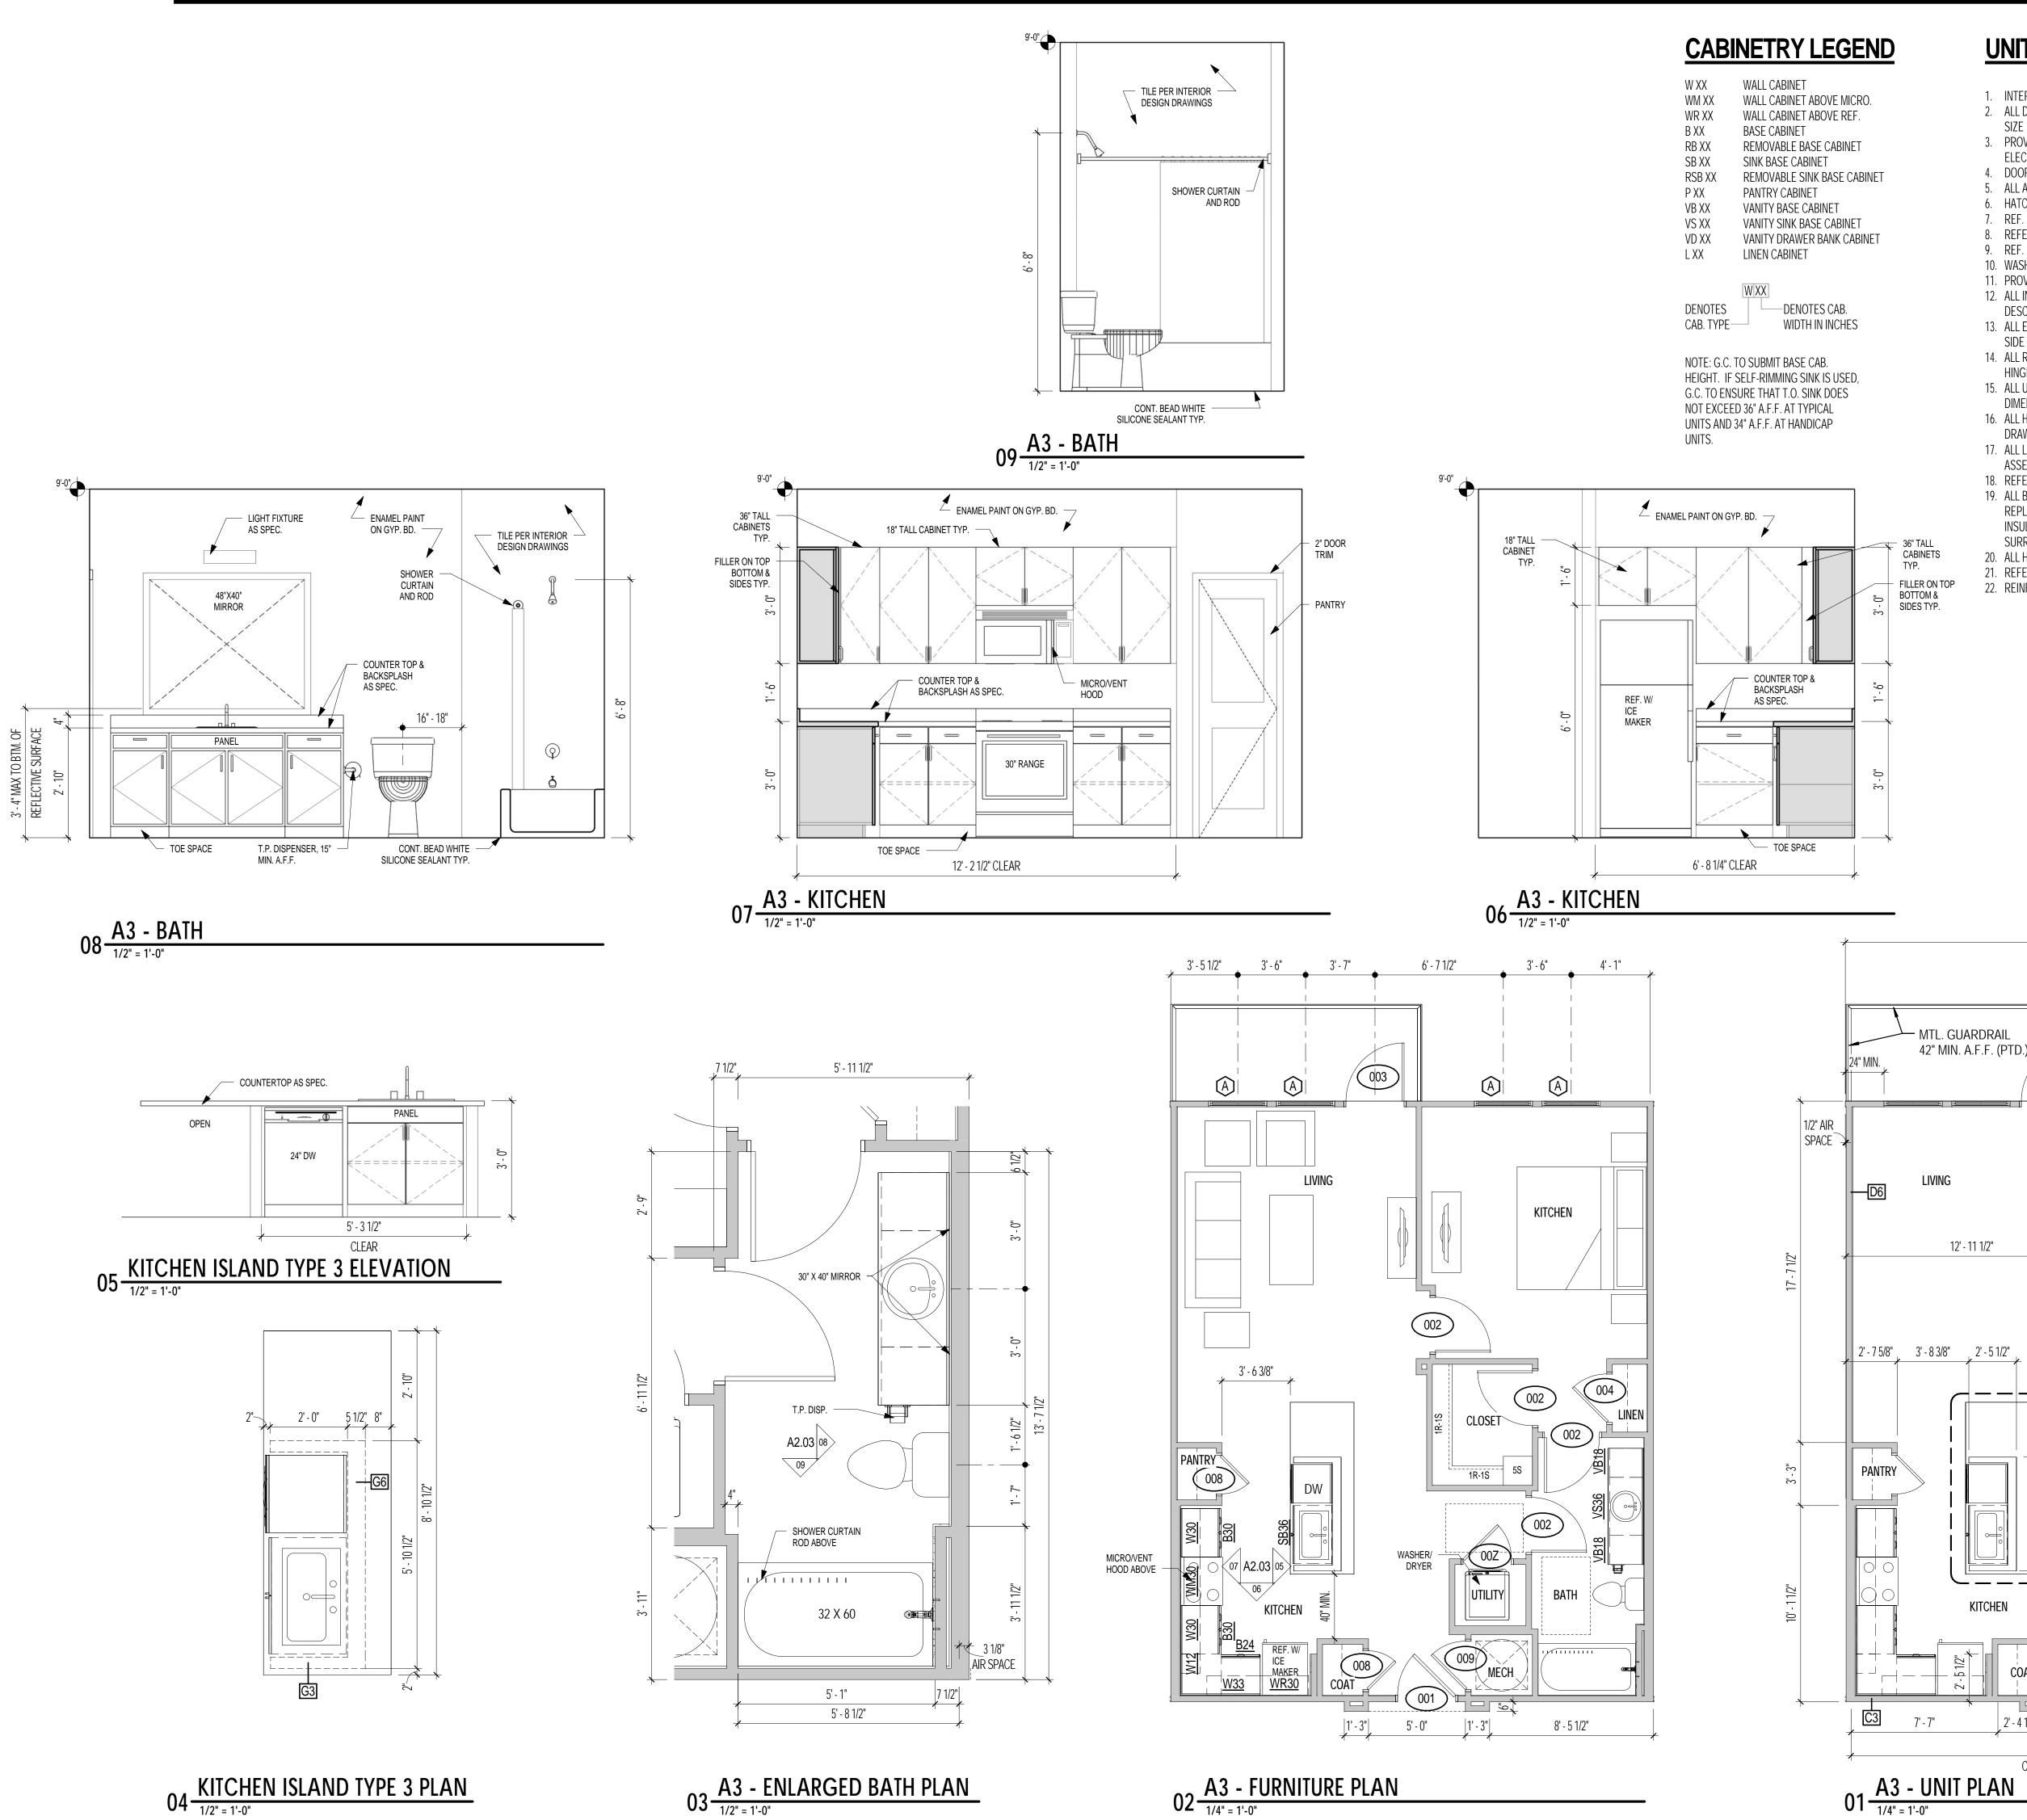

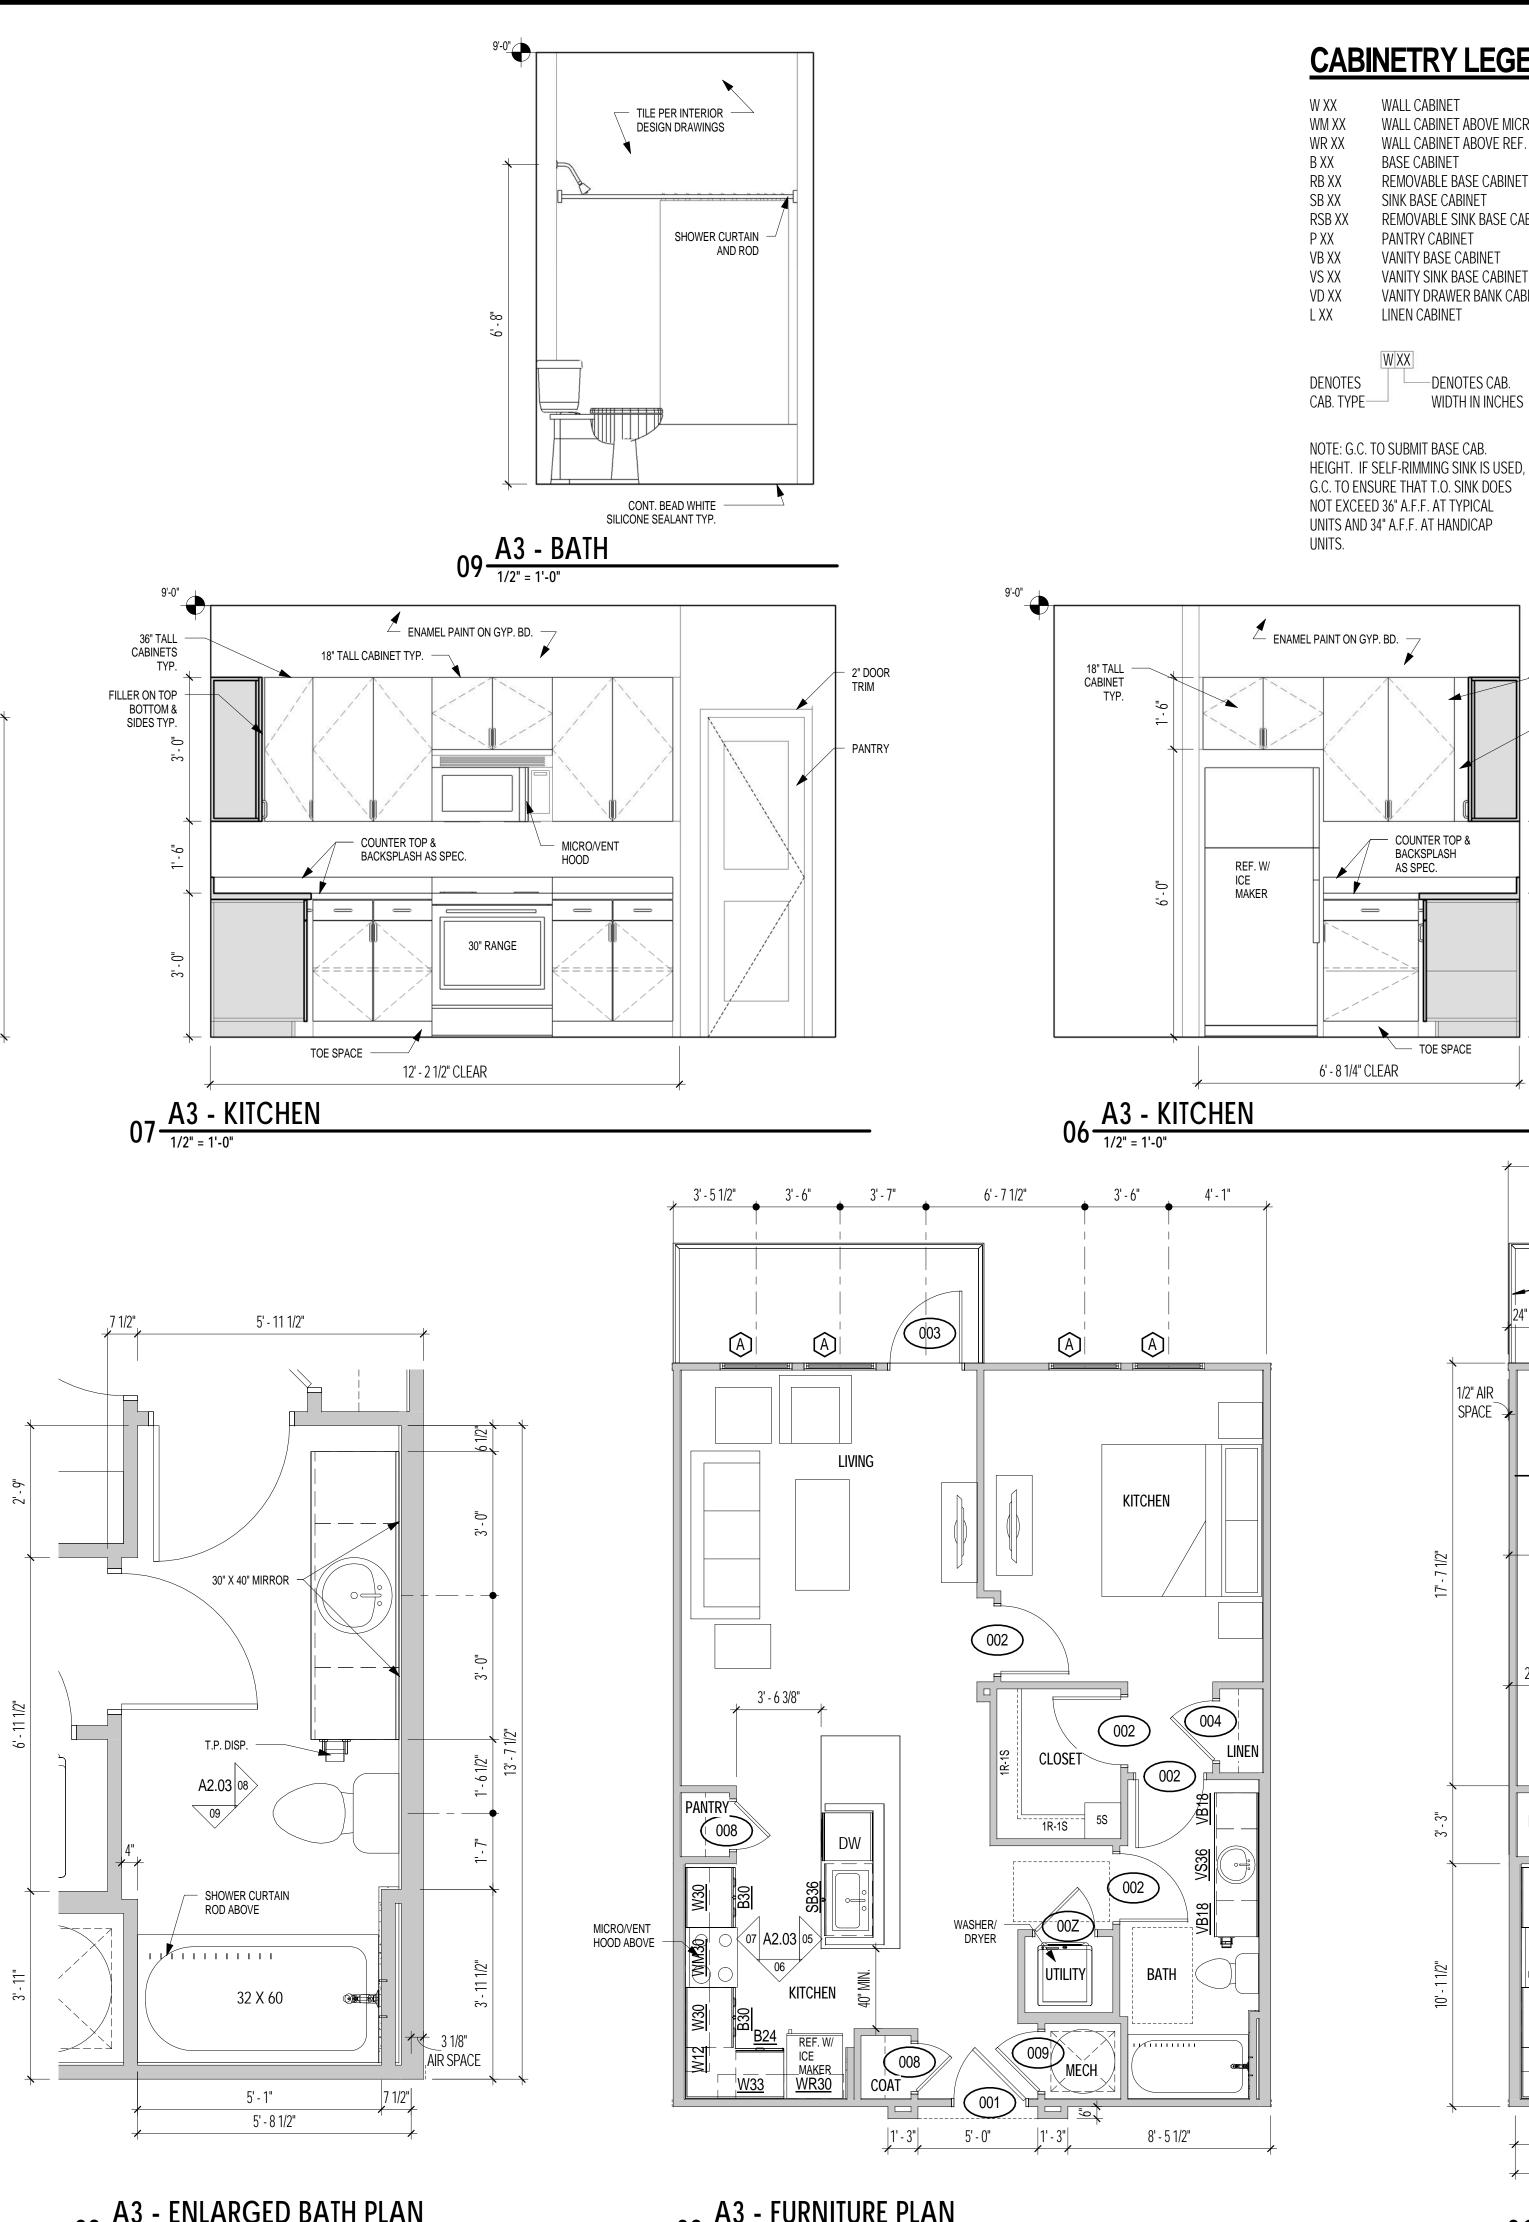






## UNIT PLAN GENERAL NOTES

O. BINET NET NET	<ol> <li>ALL DIMENSIONS ARE TO FAUSIZE 1 1/2"X 5 1/2").</li> <li>PROVIDE WOOD BLOCKING FELECTRICAL FIXTURES AND SELECTRICAL FIXTURES FOR FINIS</li> <li>ALL ANGLES ARE 45 DEG. TO</li> <li>HATCH INDICATES FURR DOW</li> <li>REF. ID DRAWINGS FOR FINIS</li> <li>REFER TO SHEET A7.01 FOR</li> <li>REF. SHEETS A0.01A-A0.03C FI</li> <li>WASHER TO BE ON LEFT SIDIE</li> <li>PROVIDE ONE 2A:10B:C FIRE</li> <li>ALL INTERIOR UNIT PARTITION DESCRIPTION.</li> <li>ALL ENTRY DOOR ROUGH OF SIDE OF DOOR, U.N.O.</li> <li>ALL ROUGH DOOR OPENINGS HINGE SIDE OF DOOR, U.N.O.</li> <li>ALL ROUGH DOOR OPENINGS HINGE SIDE OF DOOR, U.N.O.</li> <li>ALL UTILITY, COAT, PANTRY, DIMENSION OF CLOSETS, U.N.</li> <li>ALL HATCH INDICATES LOAD DRAWINGS.</li> <li>ALL LINES &amp; EQUIPMENT TO HASSEMBLIES. BOXES TO HAV</li> <li>REFER TO UNIT PLANS FOR CO</li> <li>ALL BASE CABINETS UNDER SERVICE AND AND AND AND AND AND AND AND AND AND</li></ol>	OR ALL ACCESSORIES AS REQ' SHOWER SEATS. REF. 04/A2.00 F SCHEDULE ARE LOCATED ON S HORIZONTAL & VERTICAL TYP, VN TO 8'-0" U.N.O. HORIZONTAL ASSEMBLIES. FOR ACCESSIBILITY DESIGN ST/ E AT ALL UTIL. LOCATIONS U.N.O. EXTINGUISHER AT EACH UNIT. NS ARE WALL TYP 'A3' U.N.O.; R PENINGS ARE TO BE LOCATED 5 S W/IN UNITS ARE TO BE S A S S S S S S S S S S S S S S S S S	L SIZE 1 1/2"X3 1/2") OR 2X6 D, INCLUDING TOWEL BARS FOR GRAB BAR BLOCKING L SHEET A 7.10. ALL UNITS, U.N.O. ANDARDS AND MOUNTING H D. EF TO SHEET A7.00 FOR AS " OFF FACE OF FRAMING FR ED 4" OFF FACE OF FRAMING FR ED 4" OFF FACE OF FRAMING CENTERED W/IN THE INTER N; G.C. TO VERIFY W/ STRUC ES WHEN LOCATED IN FIRE SSEMBLY. TED UNITS ARE TO BE ADJU RE TO BE PROTECTED (COV ETRY, WALLS BEHIND AND A0.01B. RAISED CEILINGS.	, GRAB BARS, OCATIONS. HEIGHTS. SEMBLY ROM HINGE G FROM RIOR CTURAL E-RATED WALL JSTABLE OR ERED OR	NRP Group LLC 200 Concord Plaza Drive, Suite 90 SAM ANDONIO, TX 78216 Mark Johnson P: 972.899.6140
3'-0"					<u>CIVIL ENGINEER</u> <u>STRUCTURAL ENGINEER</u> Lalonde Engineering Inc. 6617 Red Bud Road Fort Worth, Tx 76135
	25' - 0"		− 1/2" → AIR SPACI	E	Phillippe Lalonde 817.307.8266 <u>MEP ENGINEER</u> Lwanda & Company, LLC 6136 Frisco Square Blvd. Suite 400 Frisco, TX 75034 Joe Nyanjom 469.287.5488 <b>g s r a n d r a d e</b>
MTL. GUA 42" MIN. A MIN.	A.F.F. (PTD.)	 ∃3]	24" MIN.		4121 Commerce St. Ste. Dallas, Texas 7522 P 214.824.704 F 214.887.055
LIVING 6 12' - 1		KITCHEN <sup>/2"</sup> 5' - 3 1/2" 3' - 6 1/2	D3 "		copyright 2010 © gsr   andrade architects, inc. INTERIM REVIEW DOCUMENTS This document is preliminary and is not intended for Regulatory Approval, Permit, or Construction Purposes. This document is issued under the authority of Fernando J. Andrade, 17868 on 05-15-15.
2 - 7 5/8" 3' - 8 3/8" PANTRY	2'-51/2" 04 /A2.03 10" 04 /A2.03 10" 10" 10" 10" 10" 10" 10" 10"	CLOSET 5'-11/2" 3'-111/2" BATH		31'-0"	Revisions:         Image: HDRC Submittal 05-15-15         Project No. 2310         Drawn By:
	COAT	→ BLDG. TYPE	< 60" 	A2.03	Author Checked By: Checker Sheet Title: A3 - UNIT PLAN Drawing No.



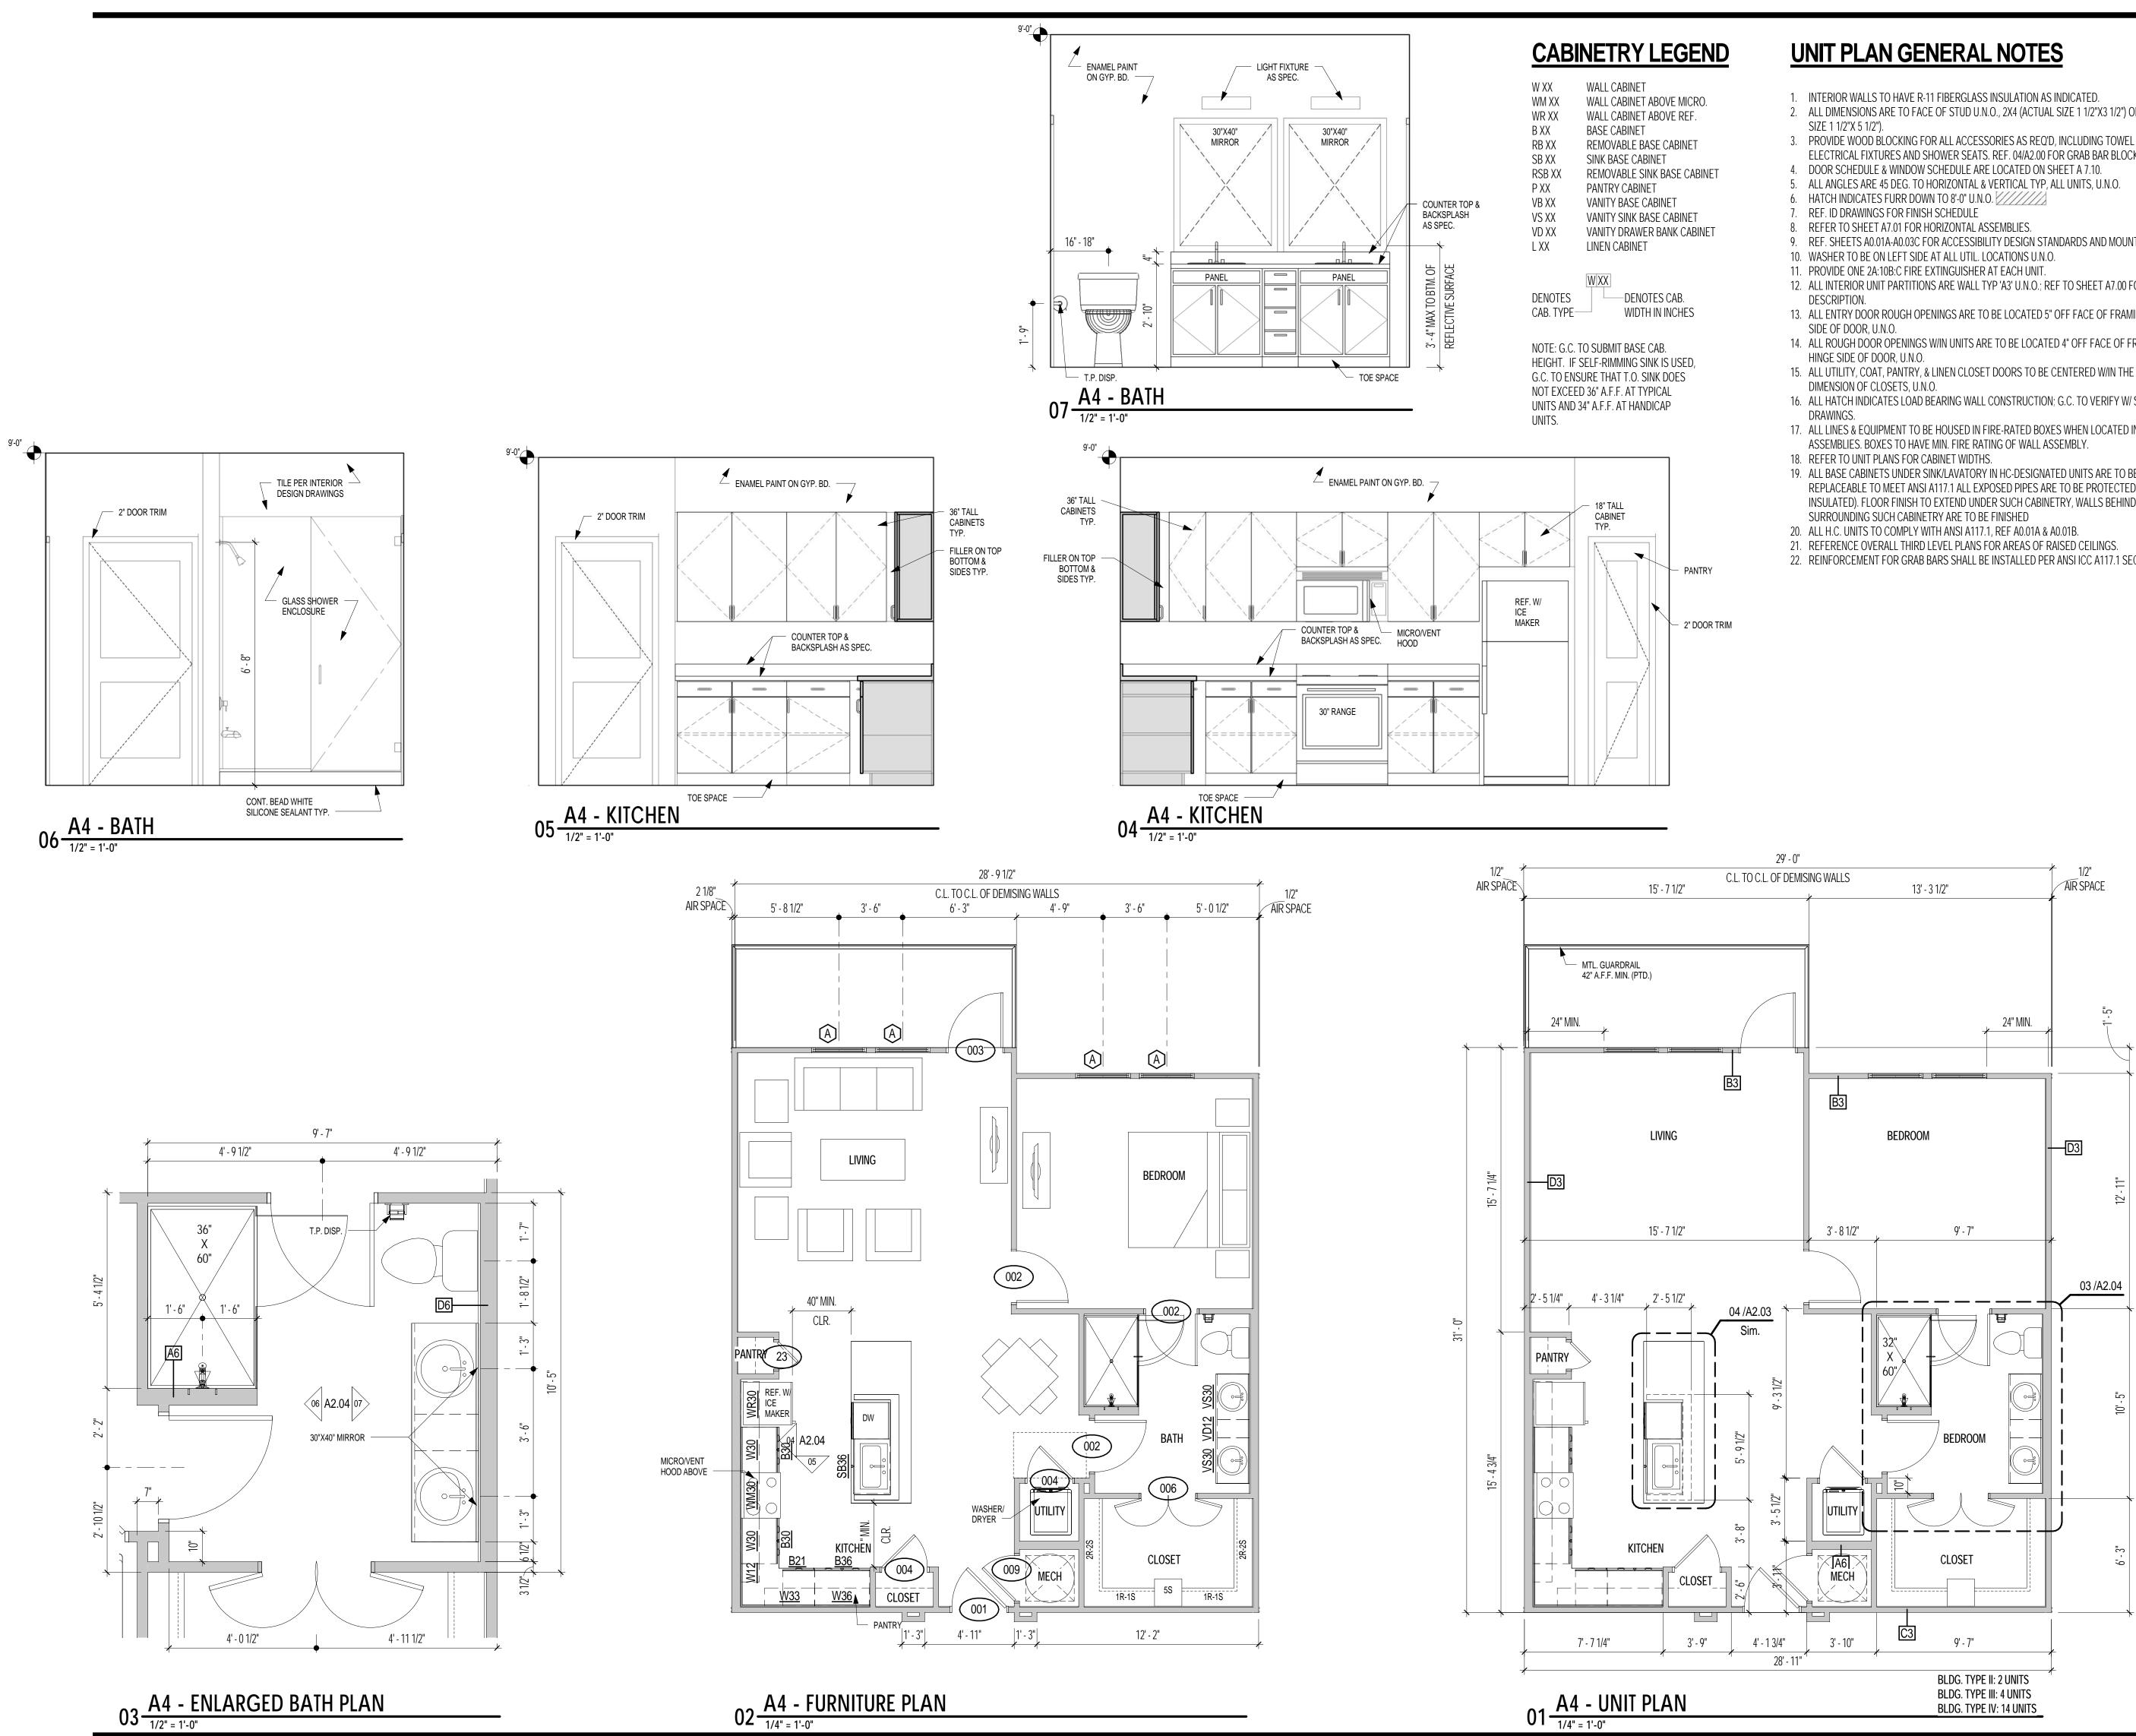

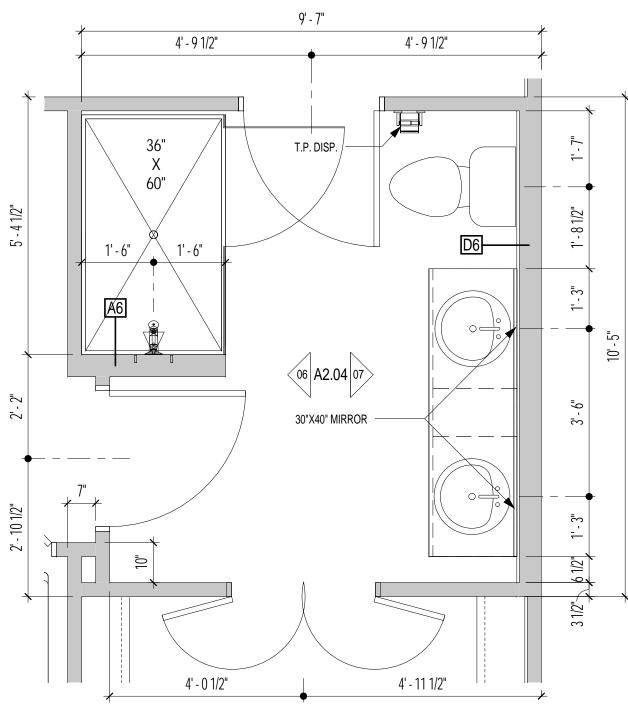

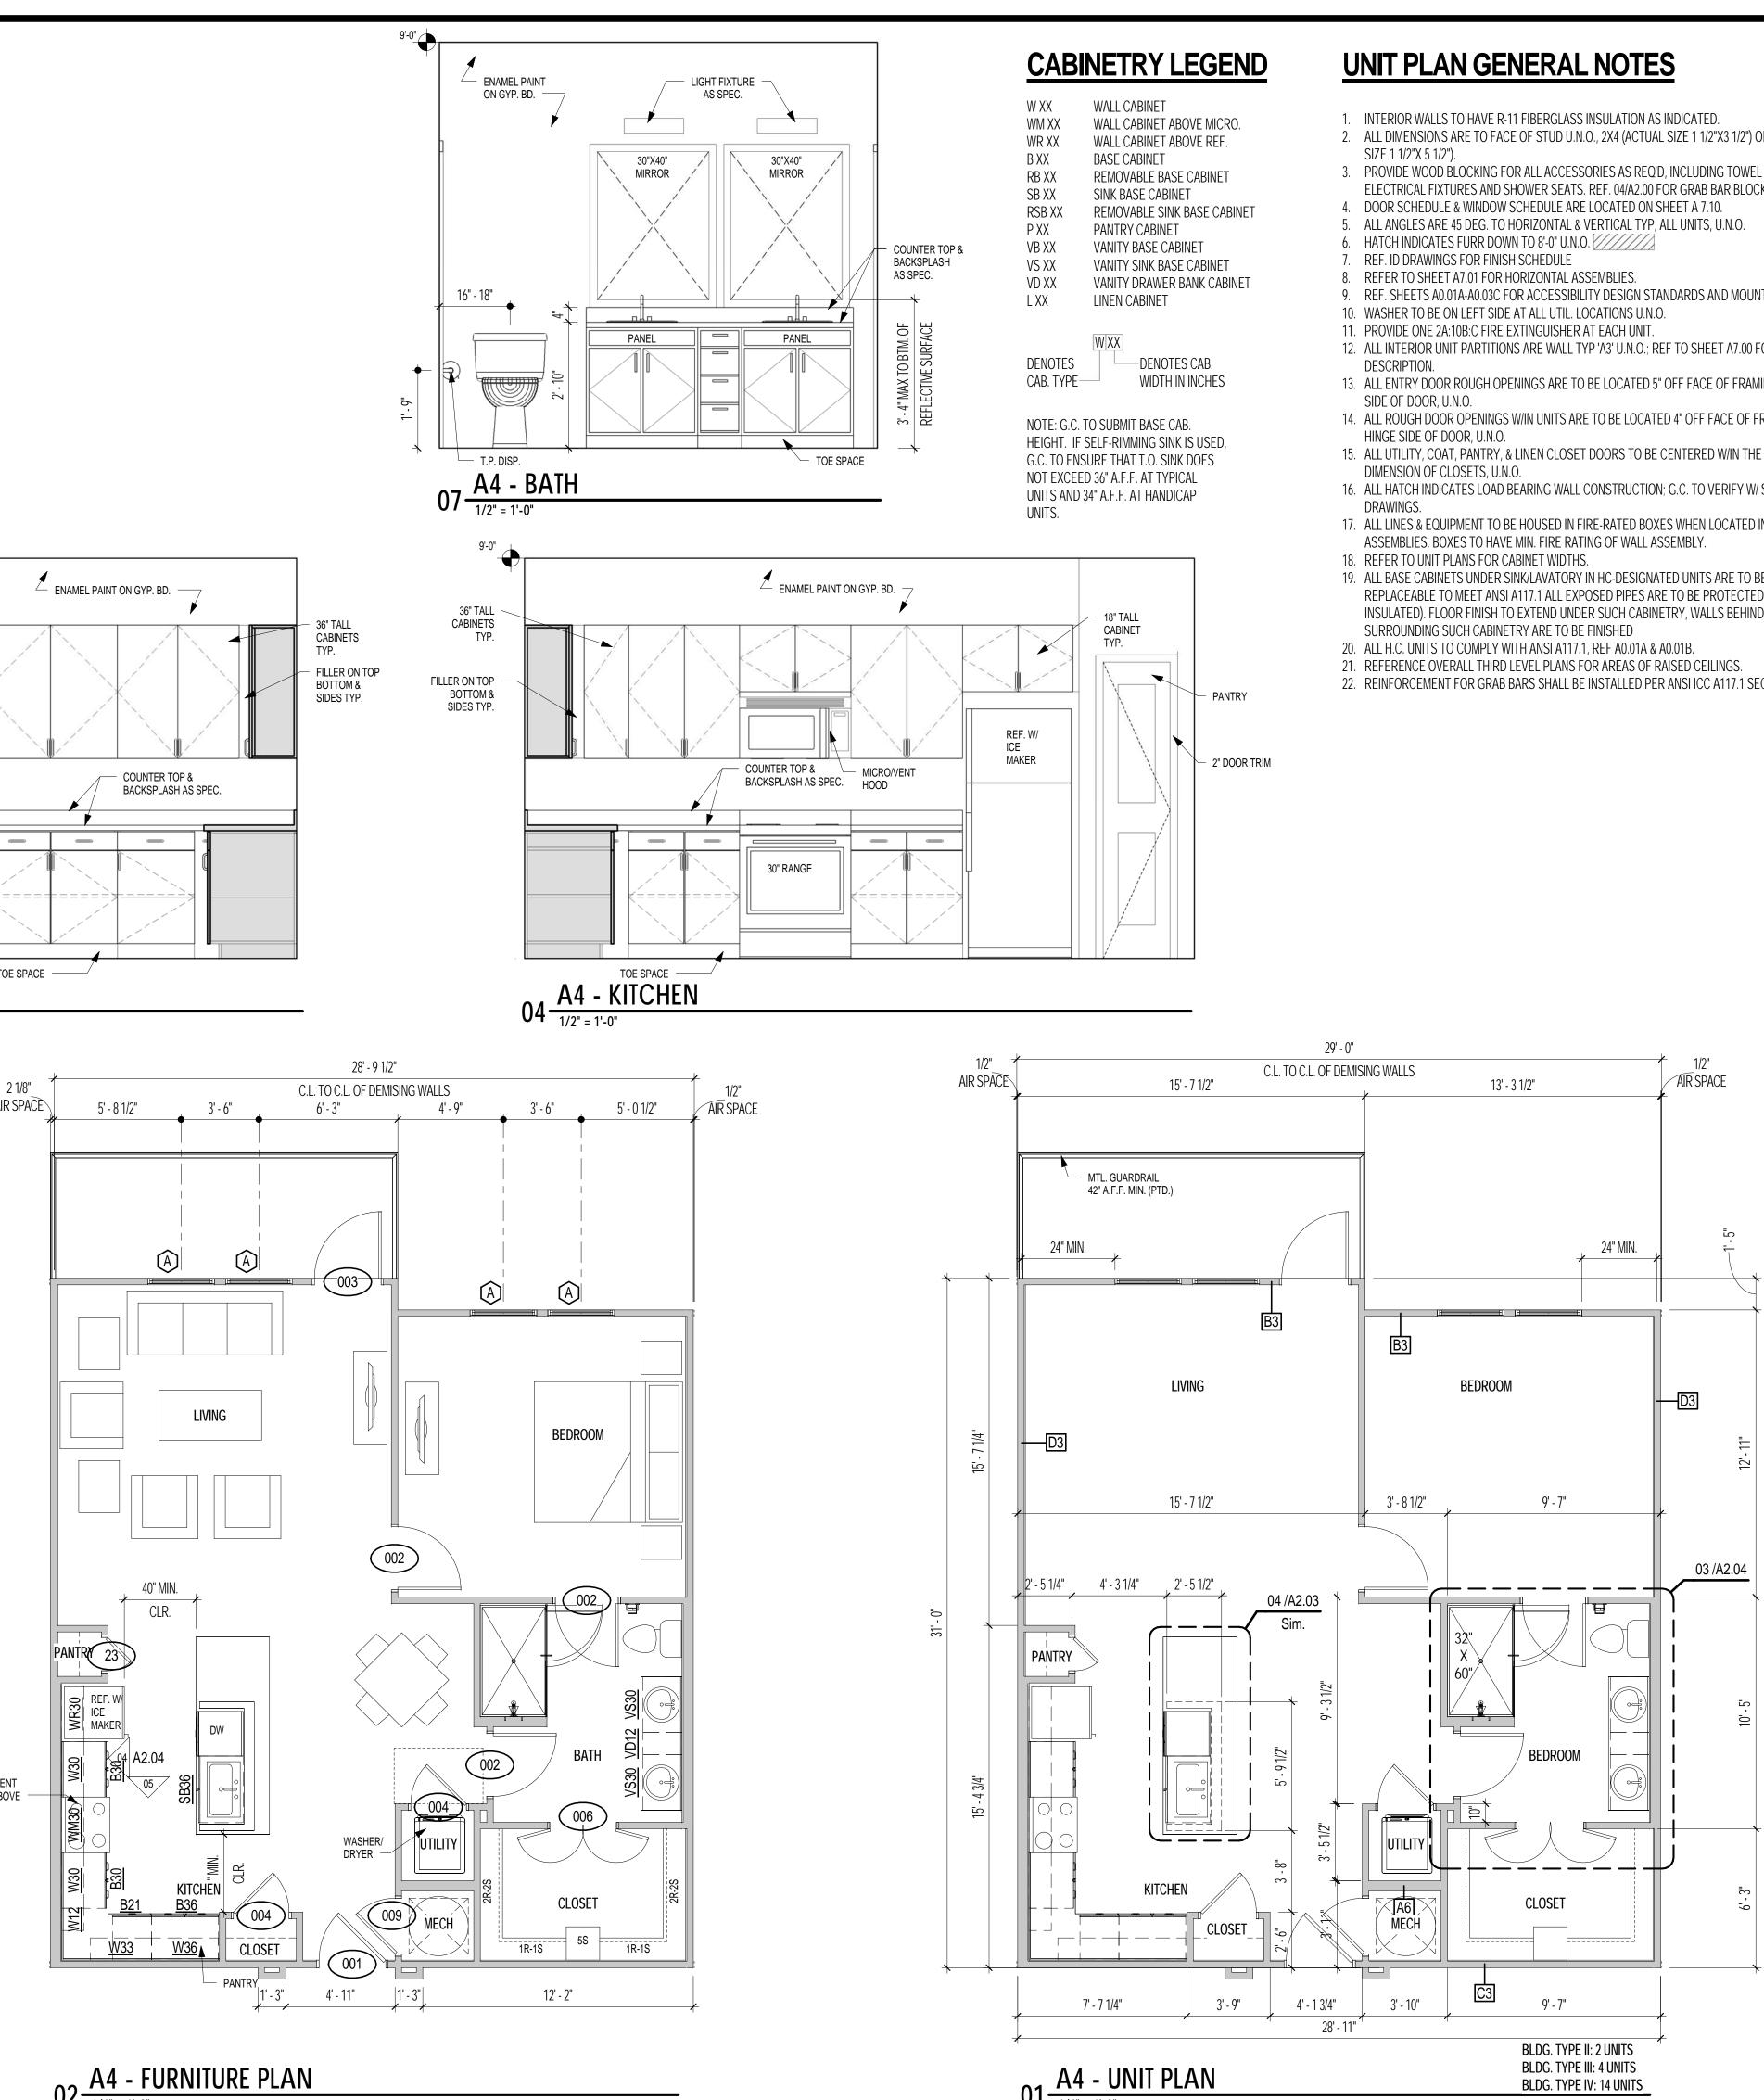

ICRO. EF.	<ol> <li>INTERIOR WALLS TO HAVE R-11 FIBERGLASS INSULATION AS INDICATED.</li> <li>ALL DIMENSIONS ARE TO FACE OF STUD U.N.O., 2X4 (ACTUAL SIZE 1 1/2"X3 1/2") OR 2X6 (ACTUAL</li> </ol>
	SIZE 1 1/2"X 5 1/2").
NET	3. PROVIDE WOOD BLOCKING FOR ALL ACCESSORIES AS REQ'D, INCLUDING TOWEL BARS, GRAB BARS, ELECTRICAL FIXTURES AND SHOWER SEATS. REF. 04/A2.00 FOR GRAB BAR BLOCKING LOCATIONS.
CABINET	4. DOOR SCHEDULE & WINDOW SCHEDULE ARE LOCATED ON SHEET A 7.10.
	<ol> <li>ALL ANGLES ARE 45 DEG. TO HORIZONTAL &amp; VERTICAL TYP, ALL UNITS, U.N.O.</li> <li>HATCH INDICATES FURR DOWN TO 8'-0" U.N.O.</li> </ol>
VET	7. REF. ID DRAWINGS FOR FINISH SCHEDULE
CABINET	8. REFER TO SHEET A7.01 FOR HORIZONTAL ASSEMBLIES.
	<ol> <li>REF. SHEETS A0.01A-A0.03C FOR ACCESSIBILITY DESIGN STANDARDS AND MOUNTING HEIGHTS.</li> <li>WASHER TO BE ON LEFT SIDE AT ALL UTIL. LOCATIONS U.N.O.</li> </ol>
	11. PROVIDE ONE 2A:10B:C FIRE EXTINGUISHER AT EACH UNIT.
	12. ALL INTERIOR UNIT PARTITIONS ARE WALL TYP 'A3' U.N.O.; REF TO SHEET A7.00 FOR ASSEMBLY
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	SIDE OF DOOR, U.N.O.
	<ol> <li>ALL ROUGH DOOR OPENINGS W/IN UNITS ARE TO BE LOCATED 4" OFF FACE OF FRAMING FROM HINGE SIDE OF DOOR, U.N.O.</li> </ol>
ED,	15. ALL UTILITY, COAT, PANTRY, & LINEN CLOSET DOORS TO BE CENTERED W/IN THE INTERIOR
	DIMENSION OF CLOSETS, U.N.O.
	<ol> <li>ALL HATCH INDICATES LOAD BEARING WALL CONSTRUCTION; G.C. TO VERIFY W/ STRUCTURAL DRAWINGS.</li> </ol>
	17. ALL LINES & EQUIPMENT TO BE HOUSED IN FIRE-RATED BOXES WHEN LOCATED IN FIRE-RATED WALL
	ASSEMBLIES. BOXES TO HAVE MIN. FIRE RATING OF WALL ASSEMBLY. 18. REFER TO UNIT PLANS FOR CABINET WIDTHS.
	19. ALL BASE CABINETS UNDER SINK/LAVATORY IN HC-DESIGNATED UNITS ARE TO BE ADJUSTABLE OR
	REPLACEABLE TO MEET ANSI A117.1 ALL EXPOSED PIPES ARE TO BE PROTECTED (COVERED OR INSULATED). FLOOR FINISH TO EXTEND UNDER SUCH CABINETRY, WALLS BEHIND AND
	SURROUNDING SUCH CABINETRY ARE TO BE FINISHED 20. ALL H.C. UNITS TO COMPLY WITH ANSI A117.1, REF A0.01A & A0.01B.
	21. REFERENCE OVERALL THIRD LEVEL PLANS FOR AREAS OF RAISED CEILINGS.
PANTRY	22. REINFORCEMENT FOR GRAB BARS SHALL BE INSTALLED PER ANSI ICC A117.1 SECTION 1003.11.4.
2" DOOR TRIM	

# **APARTMENTS** TEXAS SAN ANTONIO, BROOKS <u>OWNER</u> NRP Group LLC 200 Concord Plaza Drive, Suite San Antonio, TX 78216 Mark Johnson P: 972.899.6140 CIVIL ENGINEER

STRUCTURAL ENGINEER Lalonde Engineering Inc. 6617 Red Bud Road Fort Worth, Tx 76135 Phillippe Lalonde 817.307.8266

900

## <u>MEP ENGINEER</u> Lwanda & Company, LLC 6136 Frisco Square Blvd. Suite 400 Frisco, TX 75034 Joe Nyanjom 469.287.5488

## gsr and rad ARCHITECT

## 4121 Commerce St. Ste. Dallas, Texas 75226

P 214.824.7040

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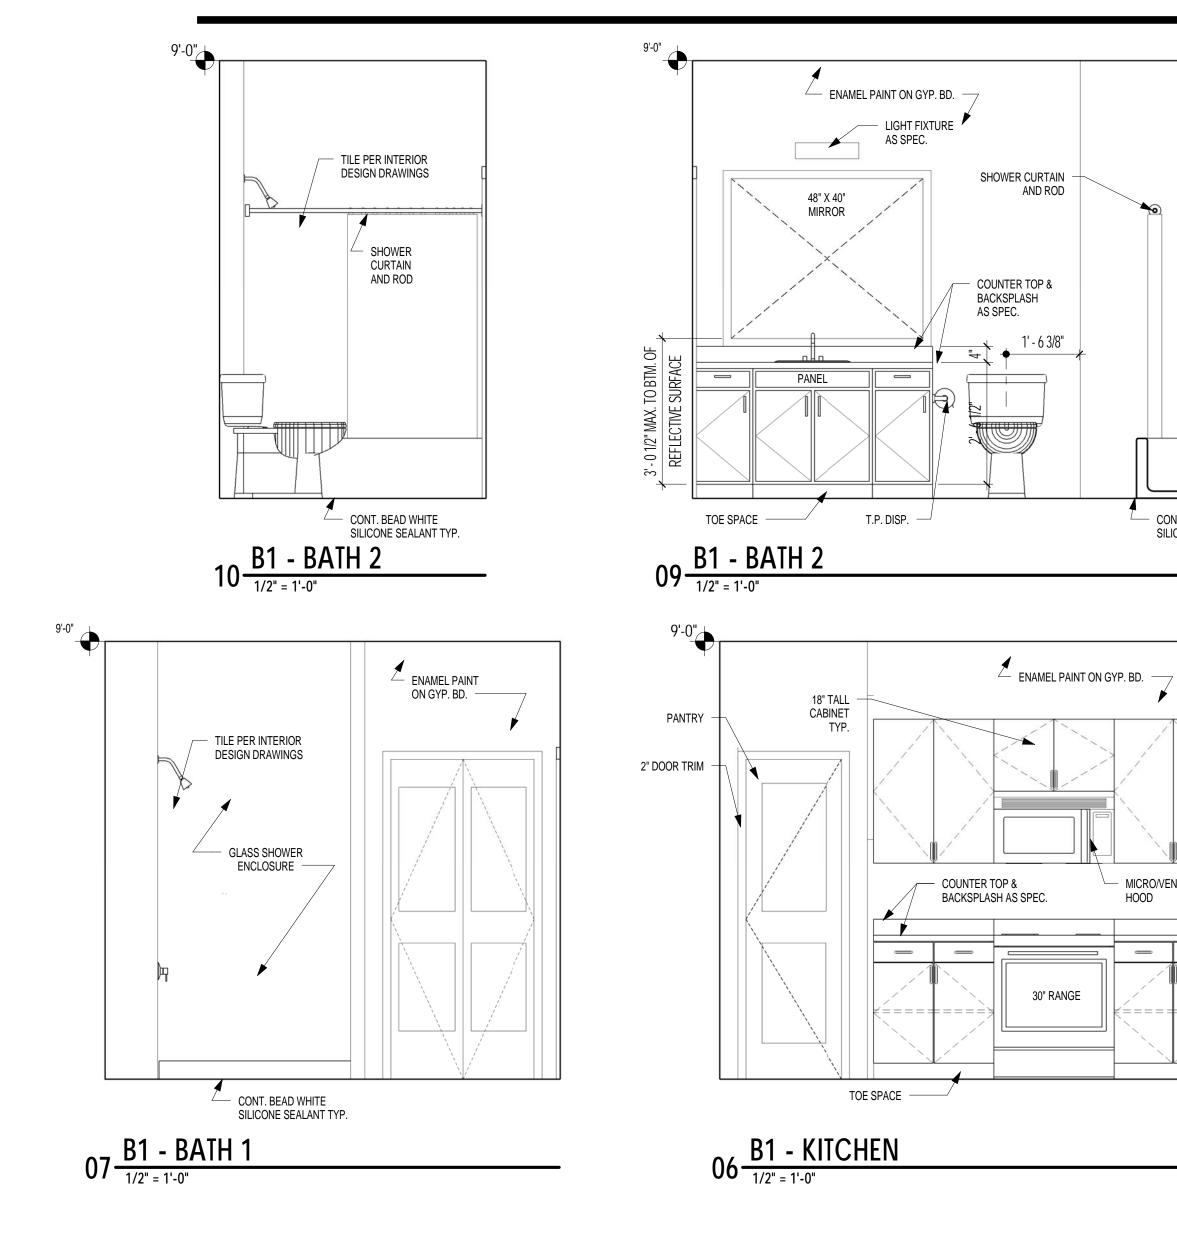
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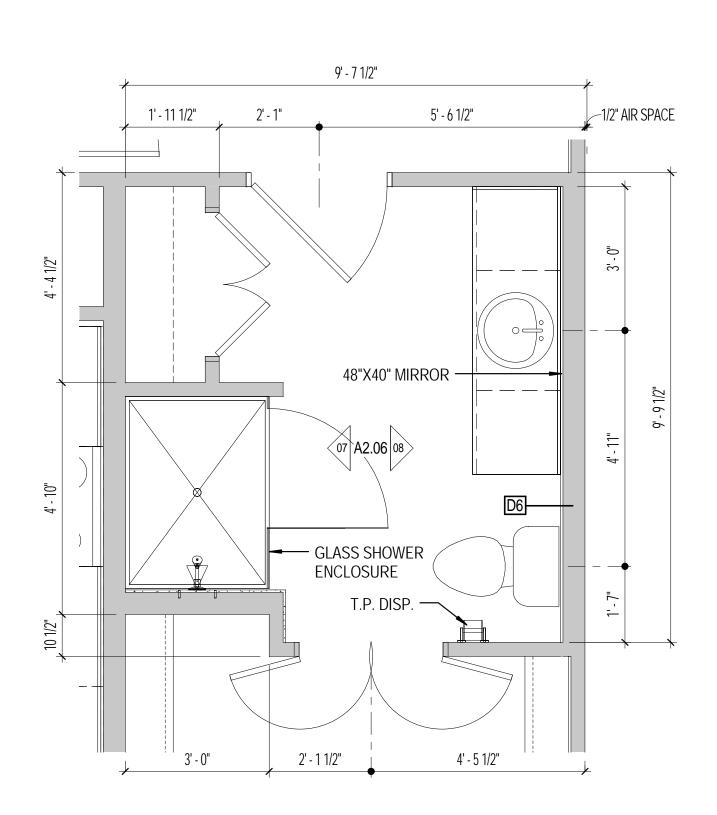
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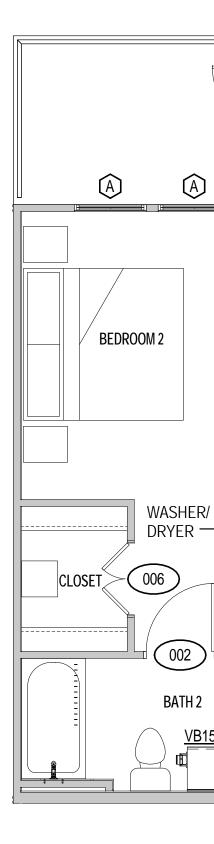
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A4 - UNIT PLAN










03 <u>B1 - BATH 1 PLAN</u>	$-$ 02 $\frac{B}{1}$
	17

B1 - FURNITURE PLAN 1/4" = 1'-0"

9'-0"


LIGHT FIXTURE

AS SPEC.

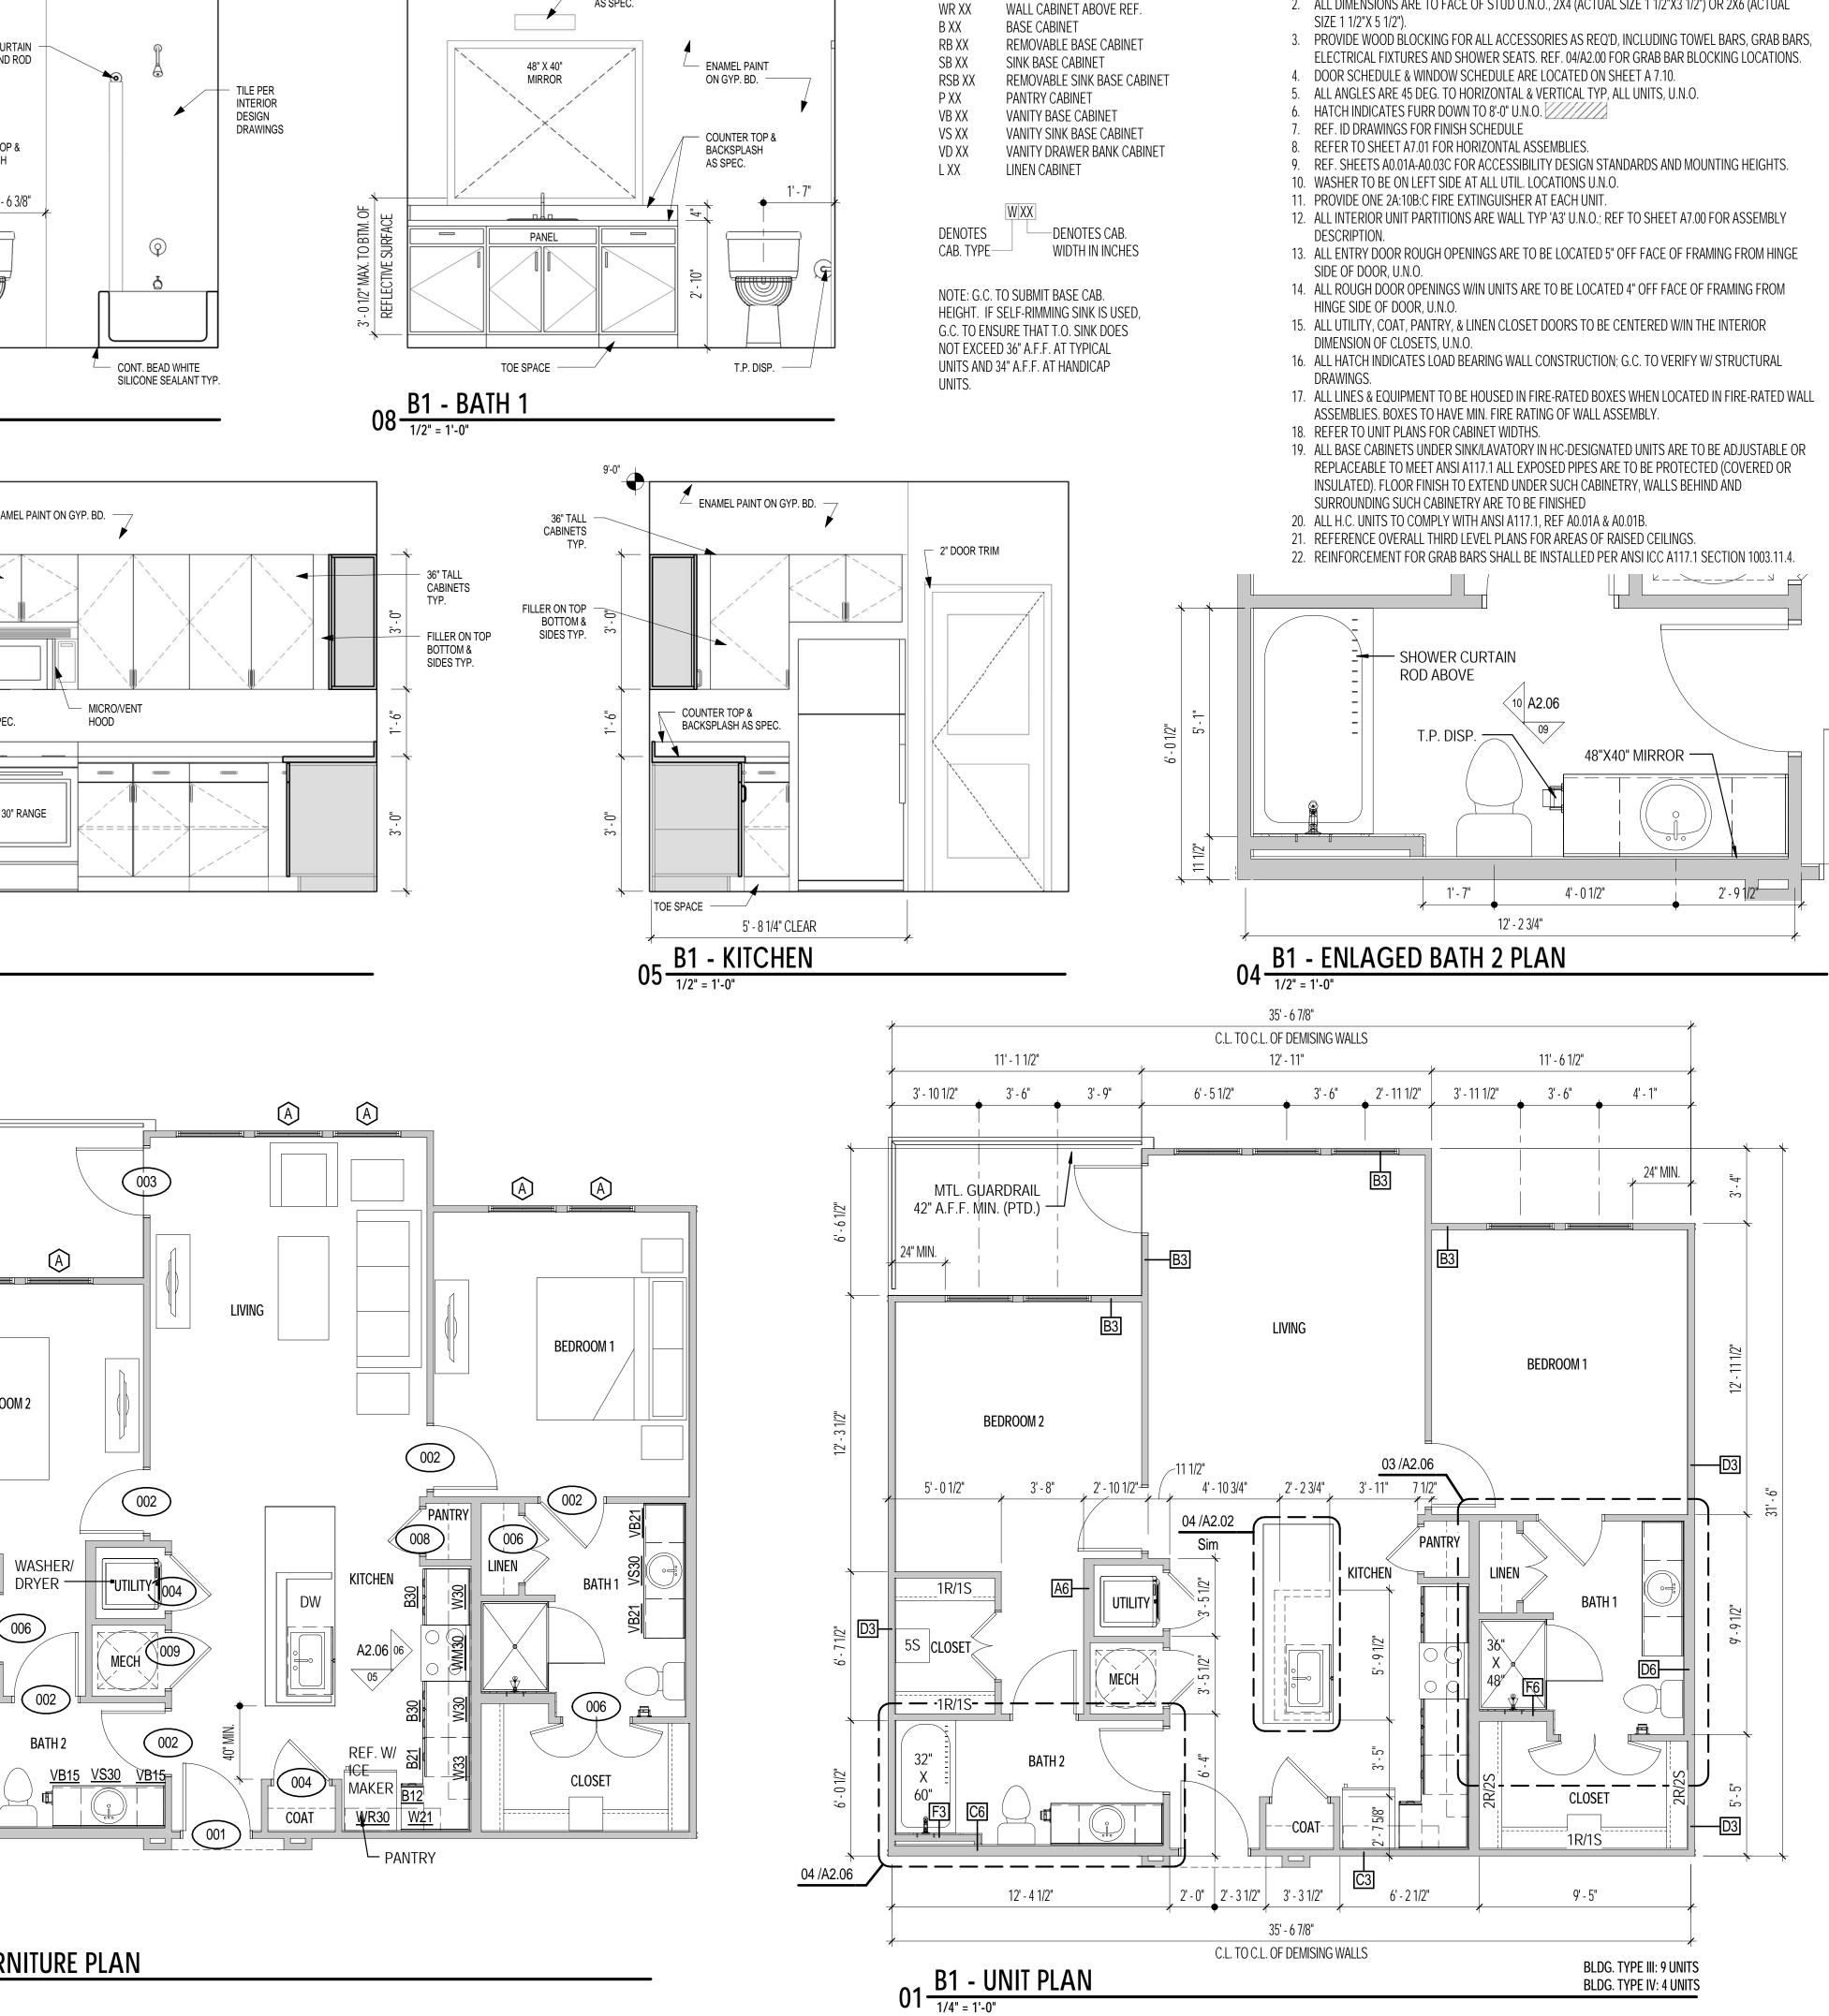

## UNIT PLAN GENERAL NOTES

- 1. INTERIOR WALLS TO HAVE R-11 FIBERGLASS INSULATION AS INDICATED.
- 2. ALL DIMENSIONS ARE TO FACE OF STUD U.N.O., 2X4 (ACTUAL SIZE 1 1/2"X3 1/2") OR 2X6 (ACTUAL

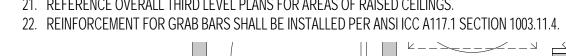

## **ARTMENTS** TEXAS SAN ANTONIO, AP BROOKS <u>OWNER</u> NRP Group LLC 200 Concord Plaza Drive, Suite 900 San Antonio, TX 78216 Mark Johnson P: 972.899.6140 CIVIL ENGINEER STRUCTURAL ENGINEER Lalonde Engineering Inc. 6617 Red Bud Road Fort Worth, Tx 76135 Phillippe Lalonde 817.307.8266 MEP ENGINEER Lwanda & Company, LLC 6136 Frisco Square Blvd. Suite 400 Frisco, TX 75034 Joe Nyanjom 469.287.5488 gsr and rad ARCHITEC 4121 Commerce St. Ste. Dallas, Texas 75226 P 214.824.7040 F 214.887.0559 copyright 2010 © gsr | andrade architects, inc. INTERIM REVIEW DOCUMENTS This document is preliminary and is not intended for Regulatory Approval, Permit, or Construction Purposes. This document is issued under the authority of Fernando J. Andrade, 17868 on 05-15-15. Revisions: Date: HDRC Submittal 05-15-15 Project No.

2310

Drawn By:

Checked By:

Sheet Title:

B1 - UNIT PLAN

A2.06

Drawing No.

BLDG. TYPE IV: 4 UNITS

Author

Checker

CABINETRY LEGEND


WALL CABINET


WALL CABINET ABOVE MICRO

W XX


WM XX


WR XX

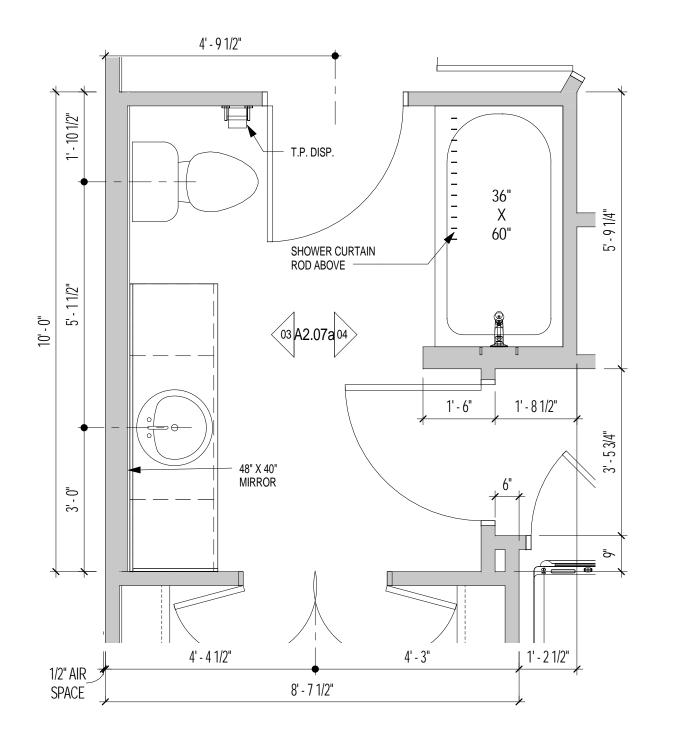

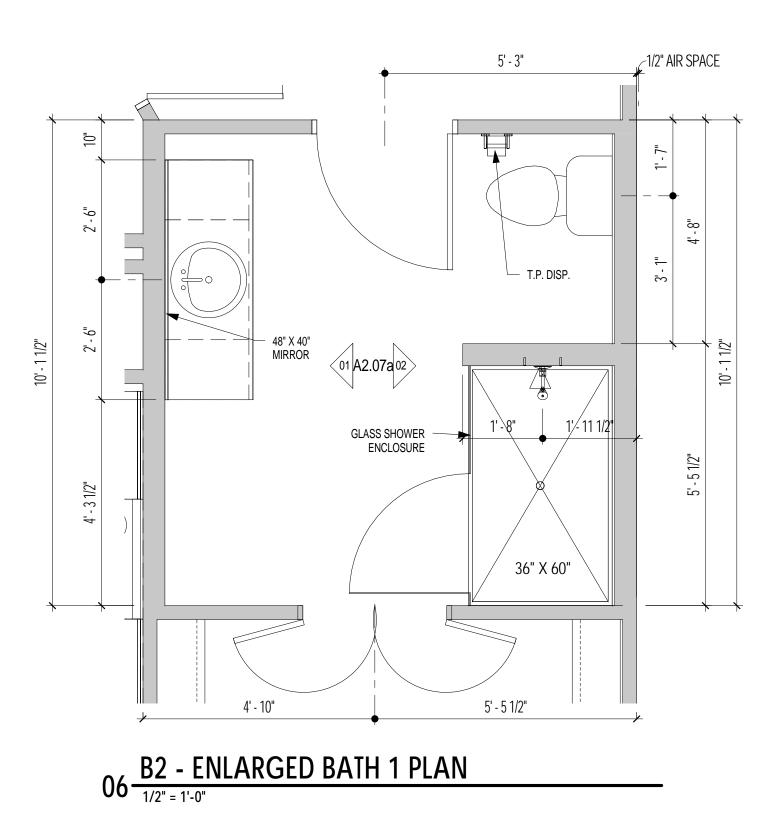




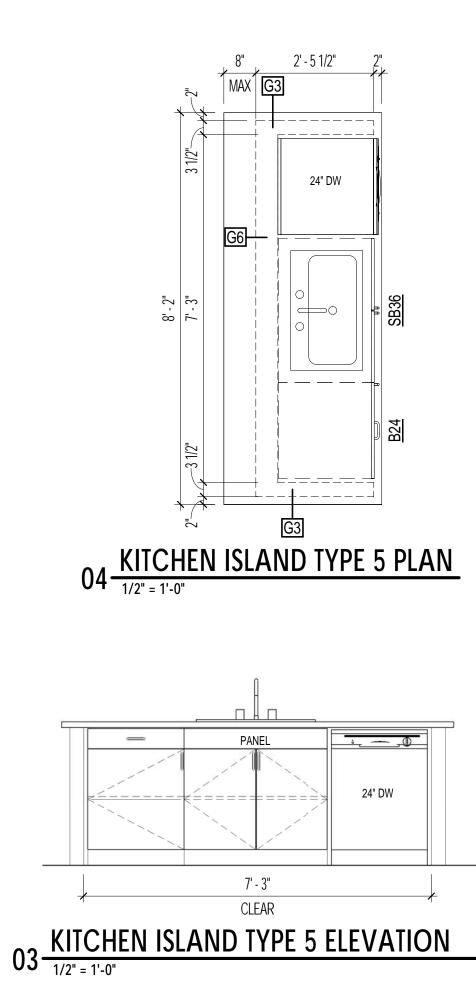


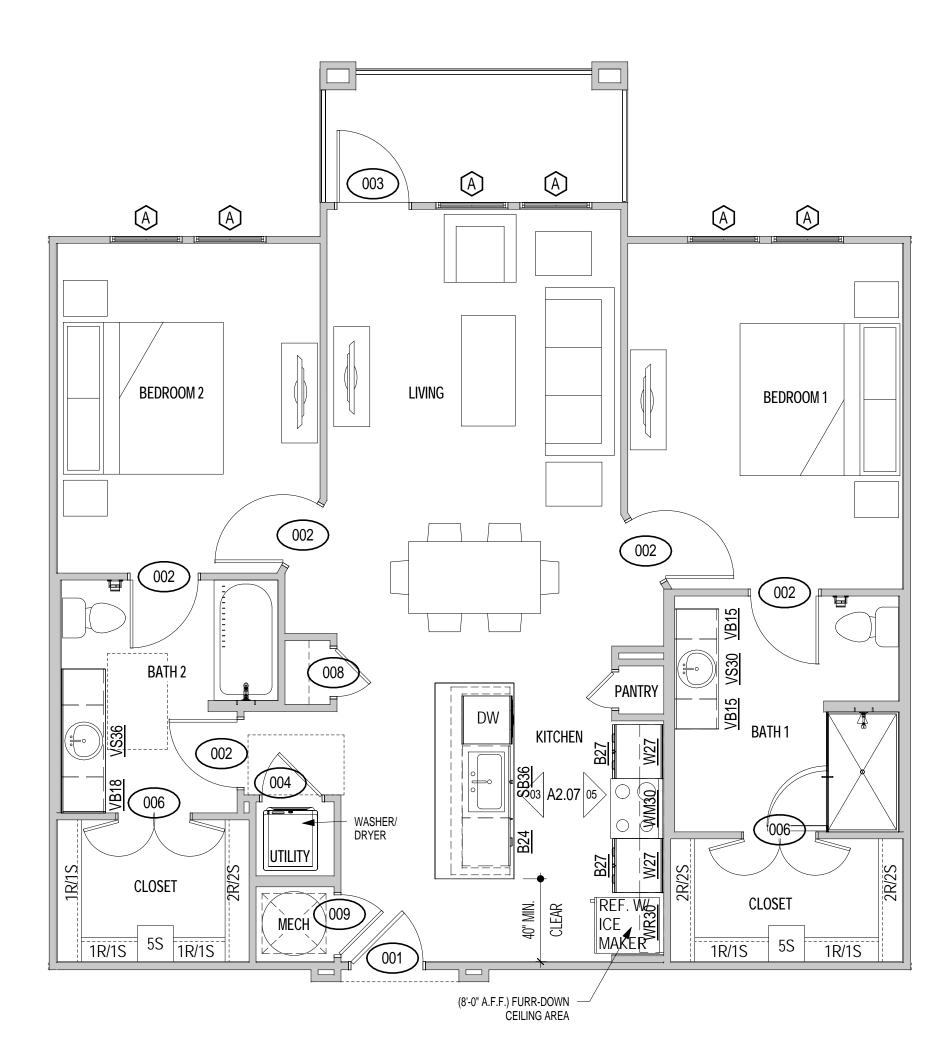



02<u>B2 - FURNITURE PLAN</u>



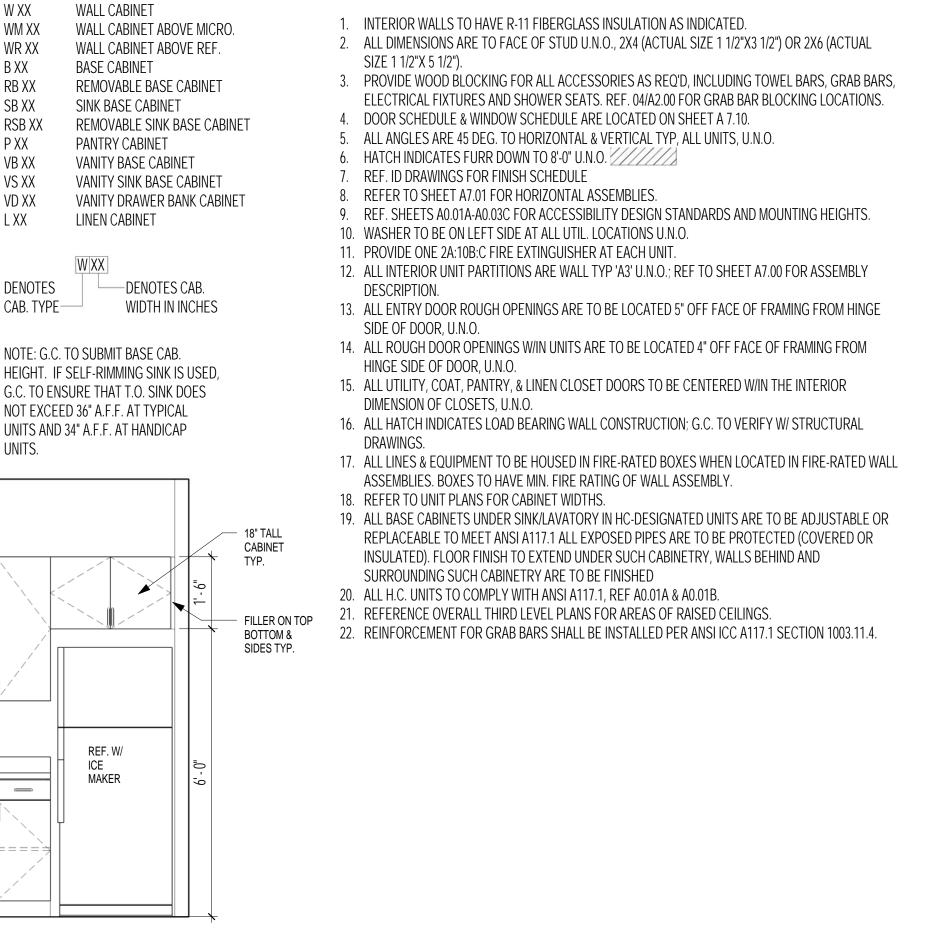

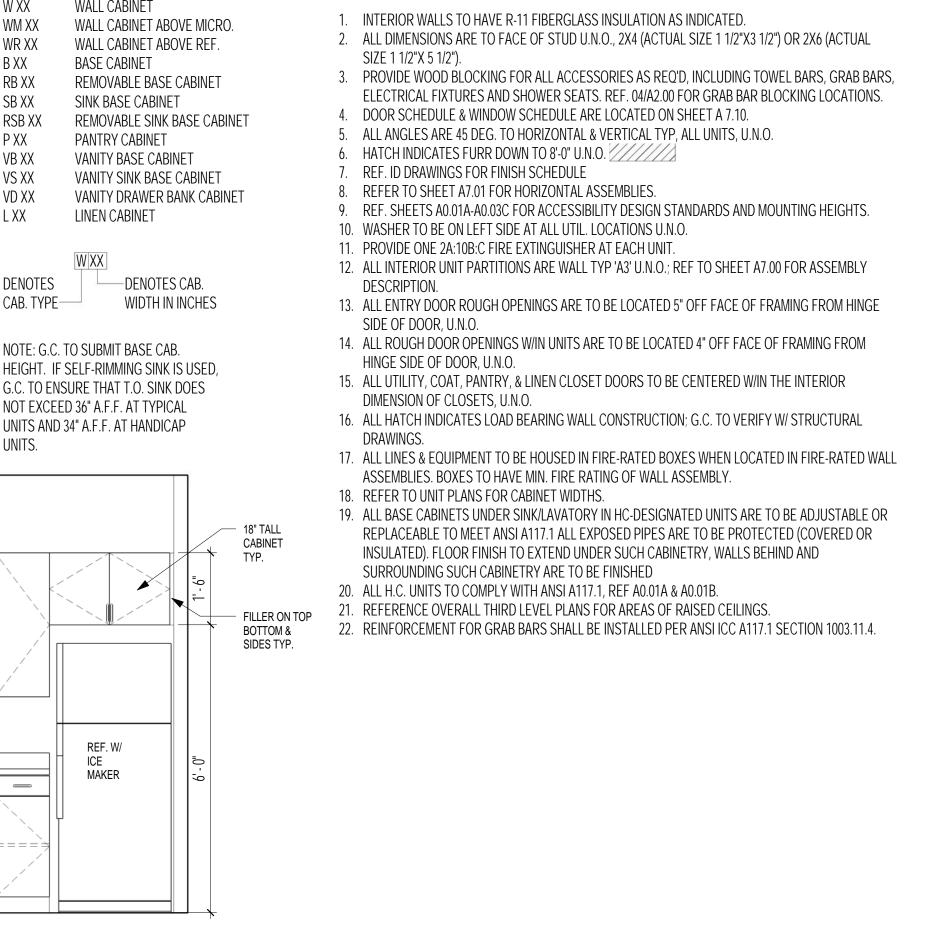

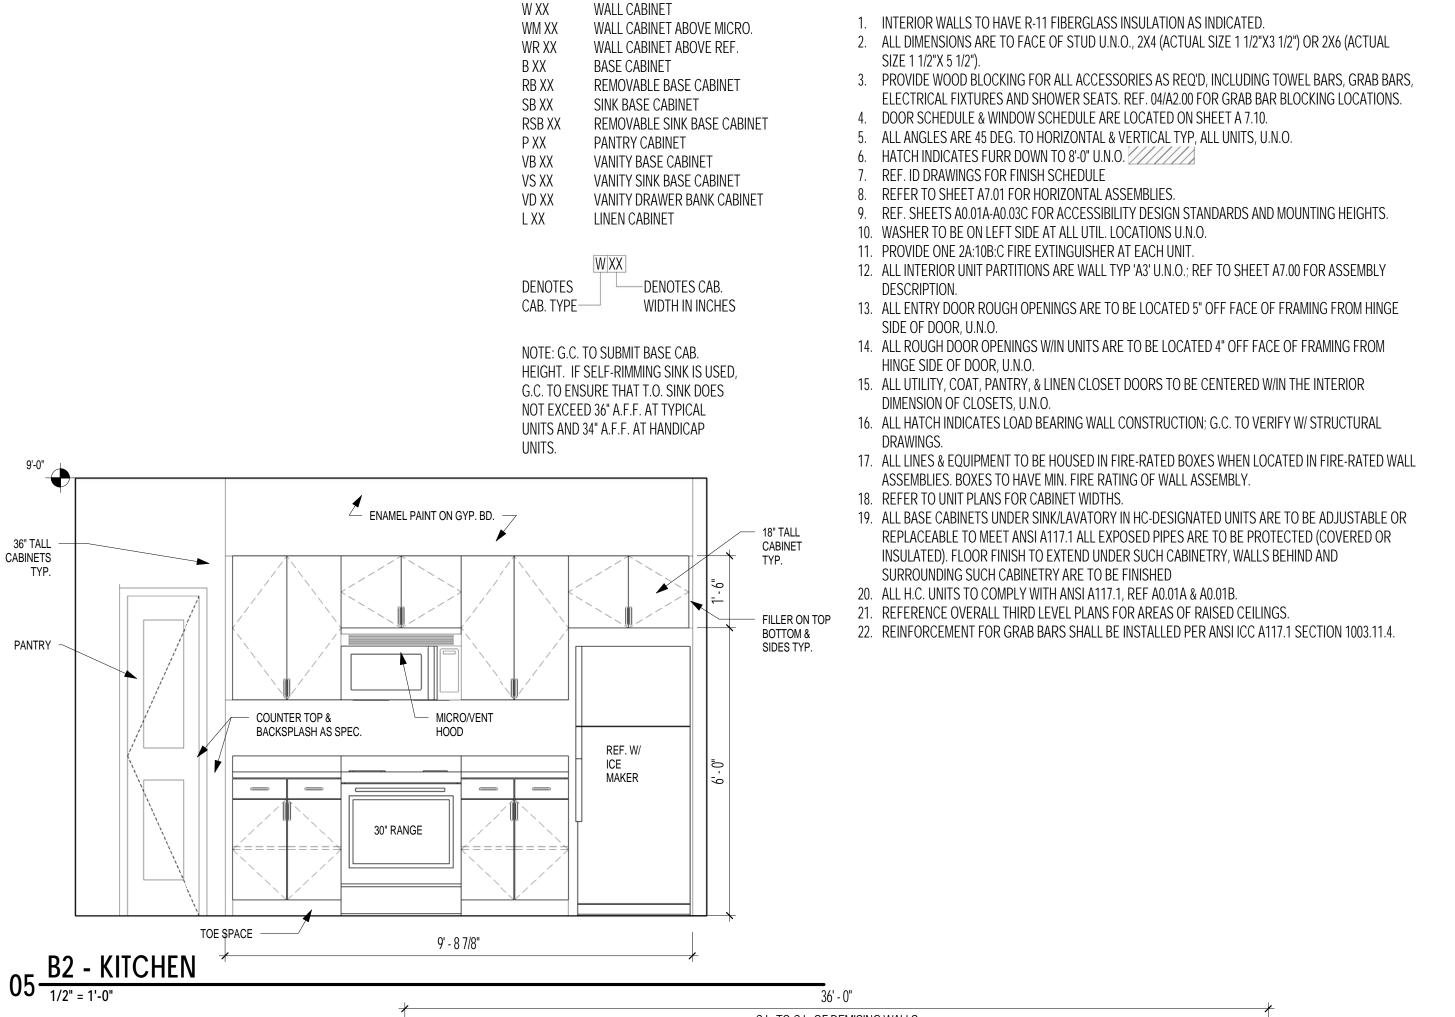

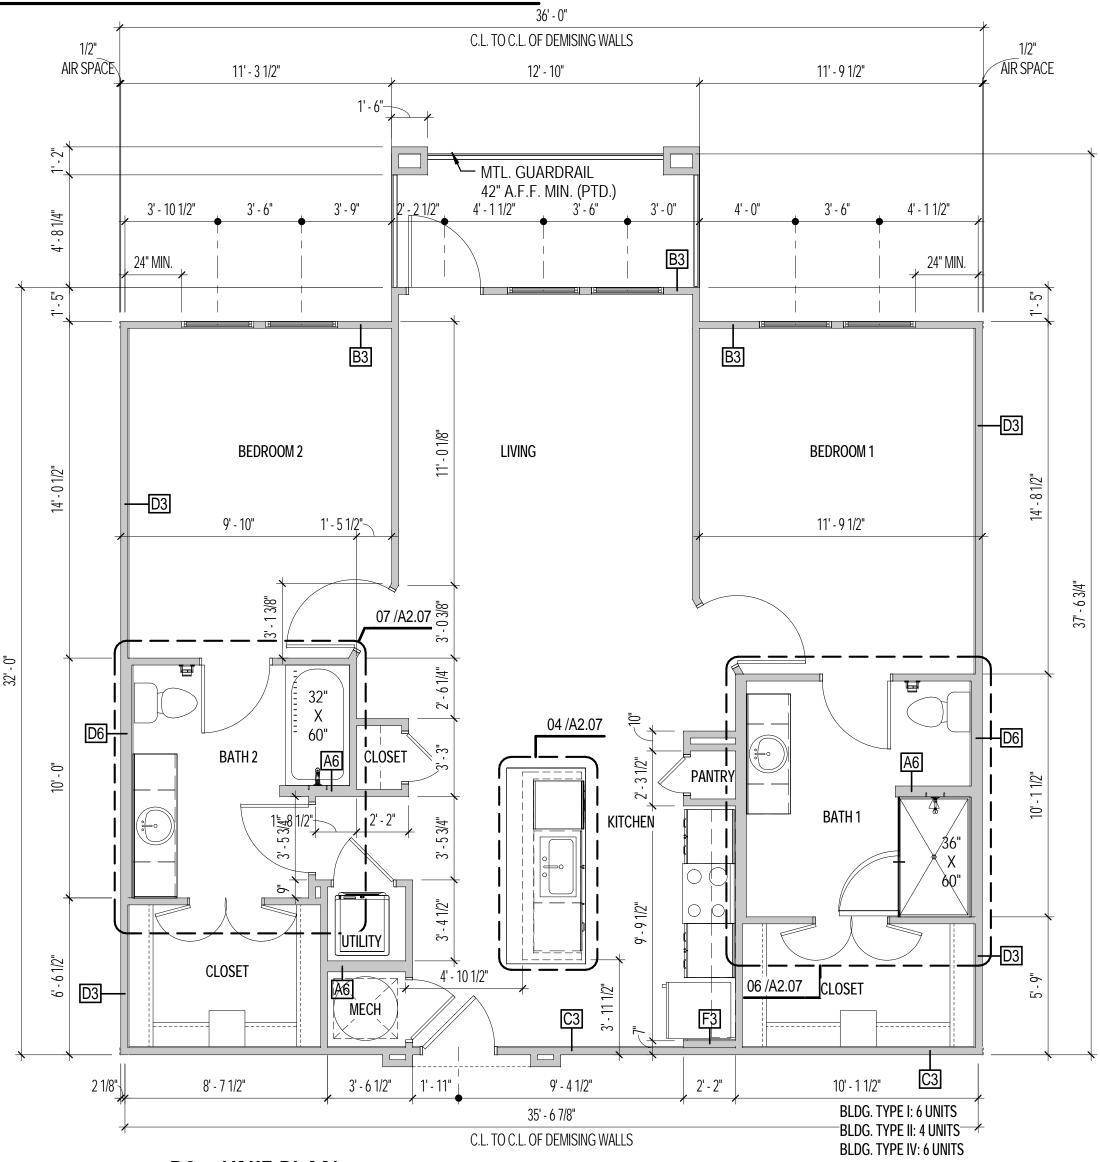

01 <u>B2 - UNIT PLAN</u> 1/4" = 1'-0"



## UNIT PLAN GENERAL NOTES

## **ARTMENTS** S TEXA ANTONIO, BROOKS SAN <u>OWNER</u>

NRP Group LLC 200 Concord Plaza Drive, Suite 900 San Antonio, TX 78216 Mark Johnson P: 972.899.6140

CIVIL ENGINEER

STRUCTURAL ENGINEER Lalonde Engineering Inc. 6617 Red Bud Road Fort Worth, Tx 76135 Phillippe Lalonde 817.307.8266

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## gsr and rad ARCHITECT

## 4121 Commerce St. Ste.

Dallas, Texas 75220 P 214.824.7040

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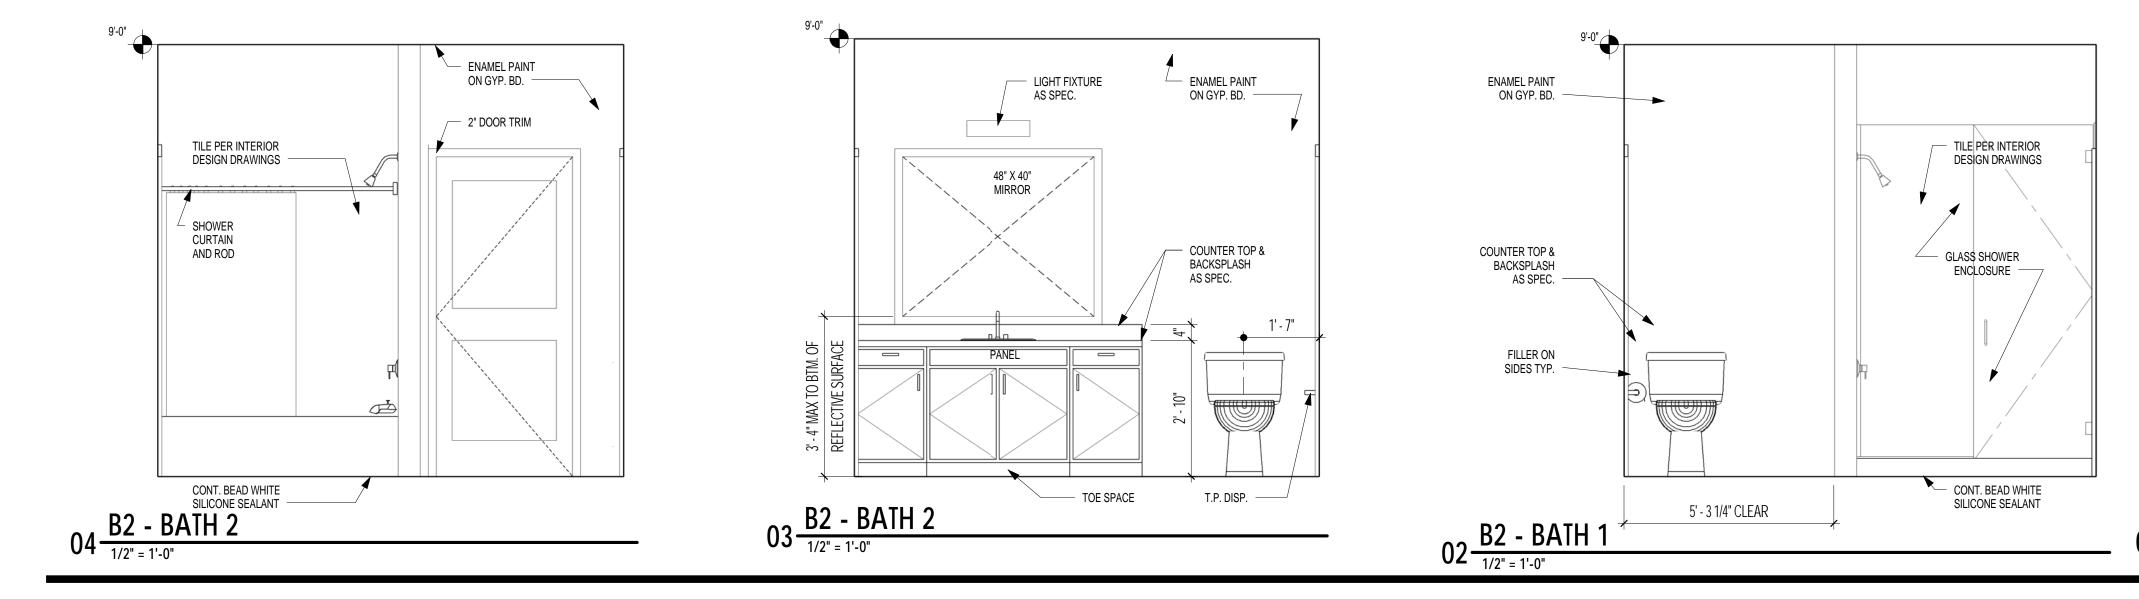
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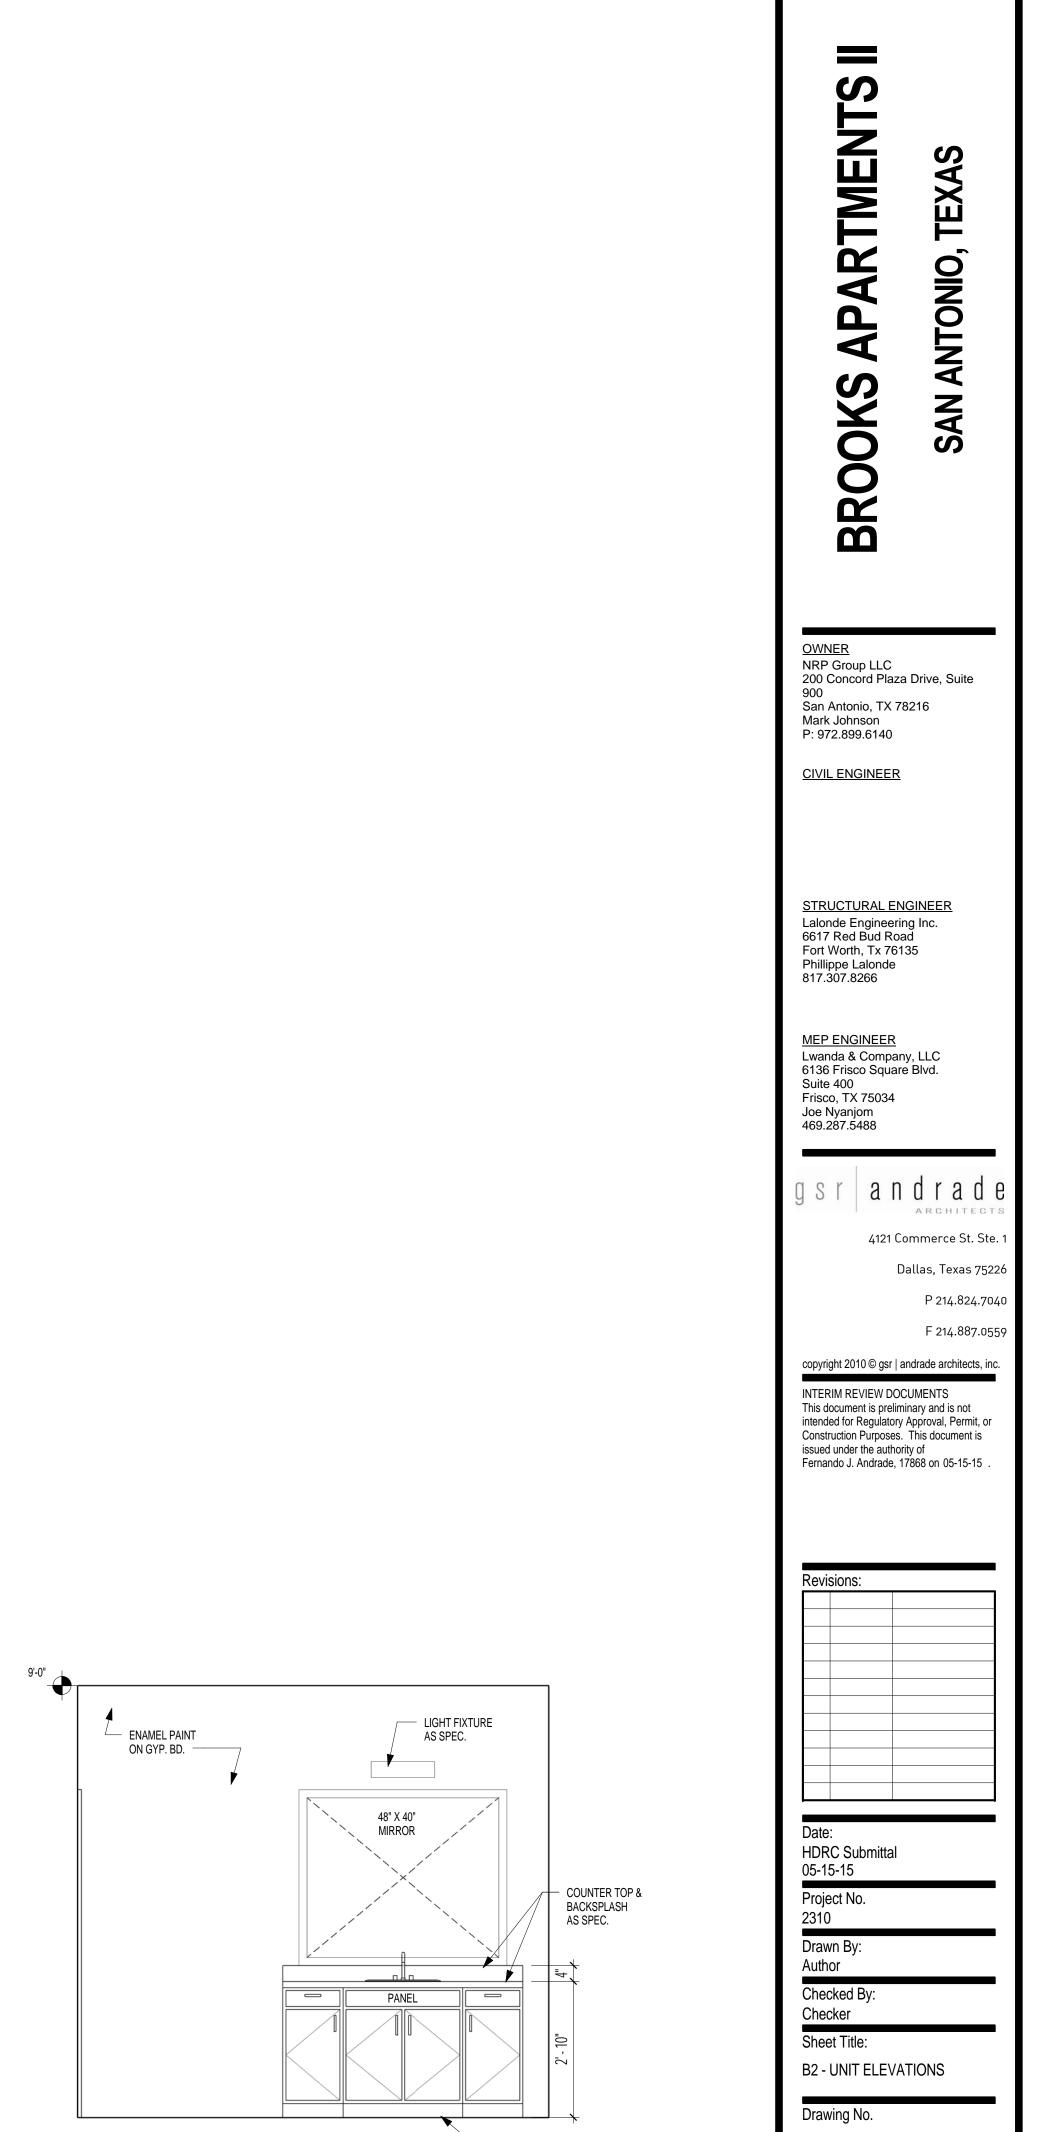
Date: HDRC Submittal 05-15-15 Project No. 2310 Drawn By: Author Checked By: Checker Sheet Title:

B2 - UNIT PLAN

Drawing No.


A2.07





— TOE SPACE

01 <u>B2 - BATH 1</u> 1/2" = 1'-0" A2.07a

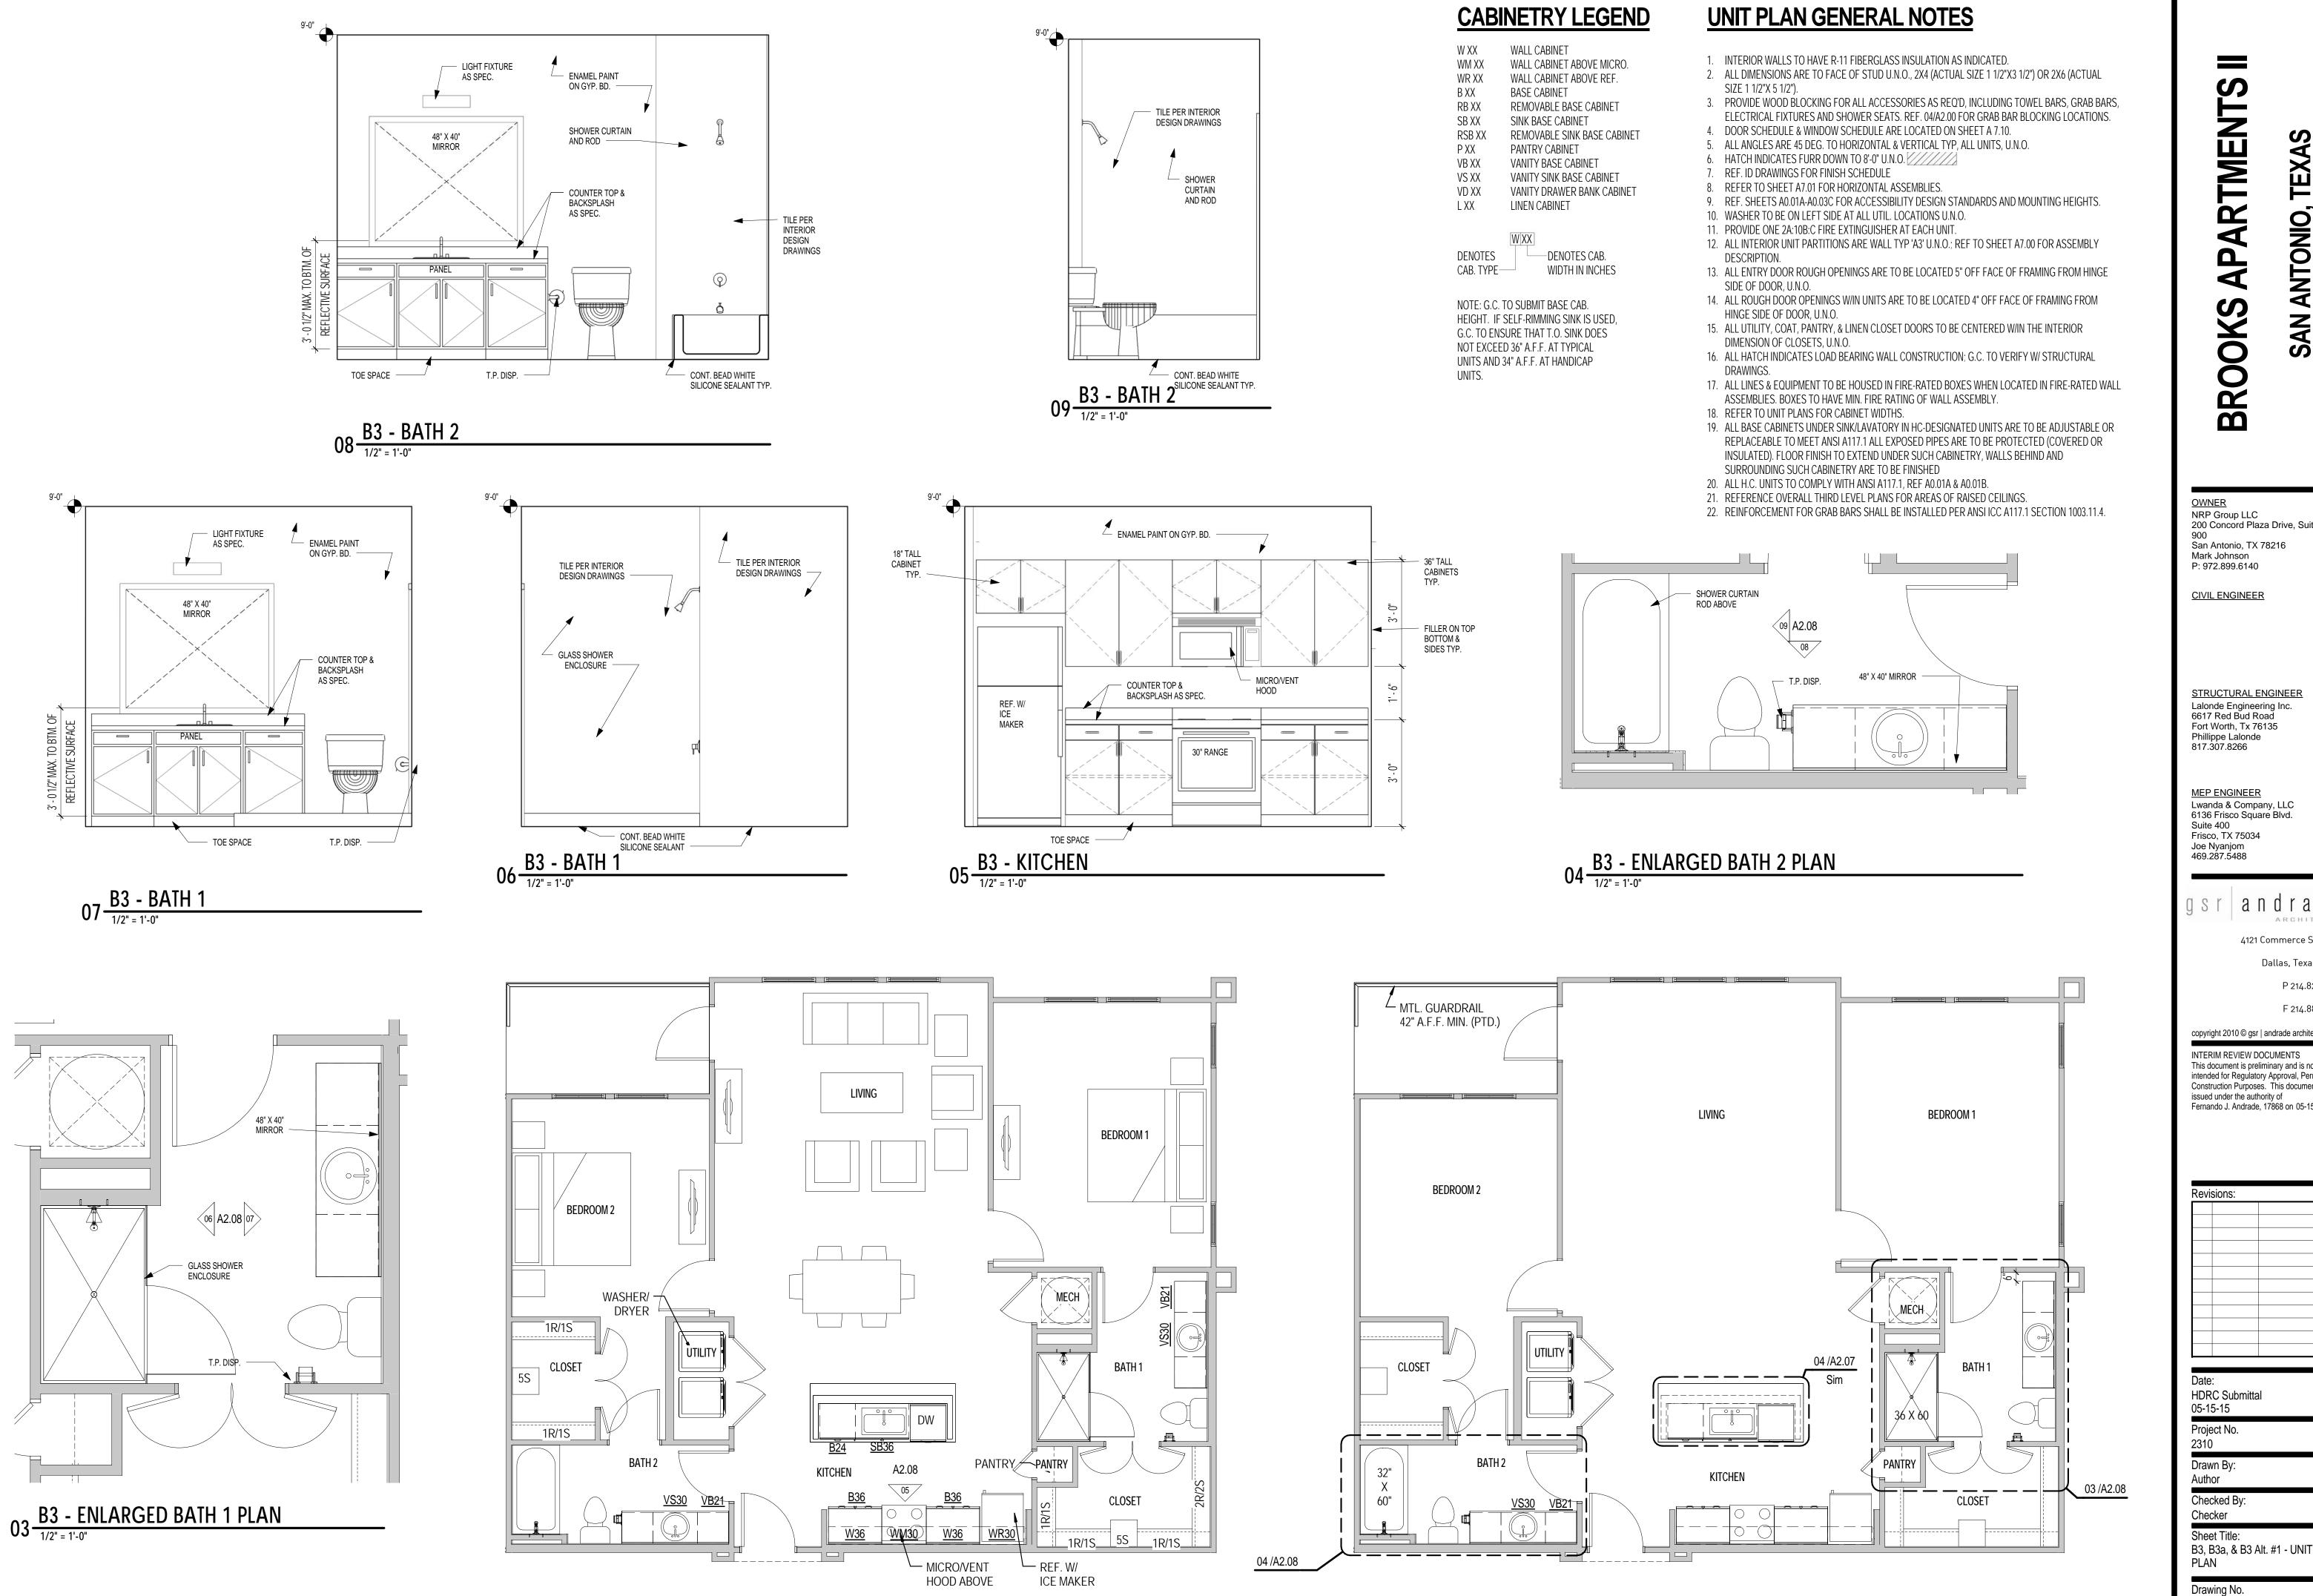


02 B3 - FURNITURE PLAN

01 B3 - UNIT PLAN

BLDG. TYPE I: 2 UNITS BLDG. TYPE II: 4 UNITS BLDG. TYPE III: 2 UNITS

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Date: HDR( 05-15	C Submitta i-15	al	
Projec 2310	ct No.		
Drawı Autho	•		
Checl Checl	ked By: ker		
		Alt. #1 - UNIT	
Drawi	ing No.		
A	2.	80	

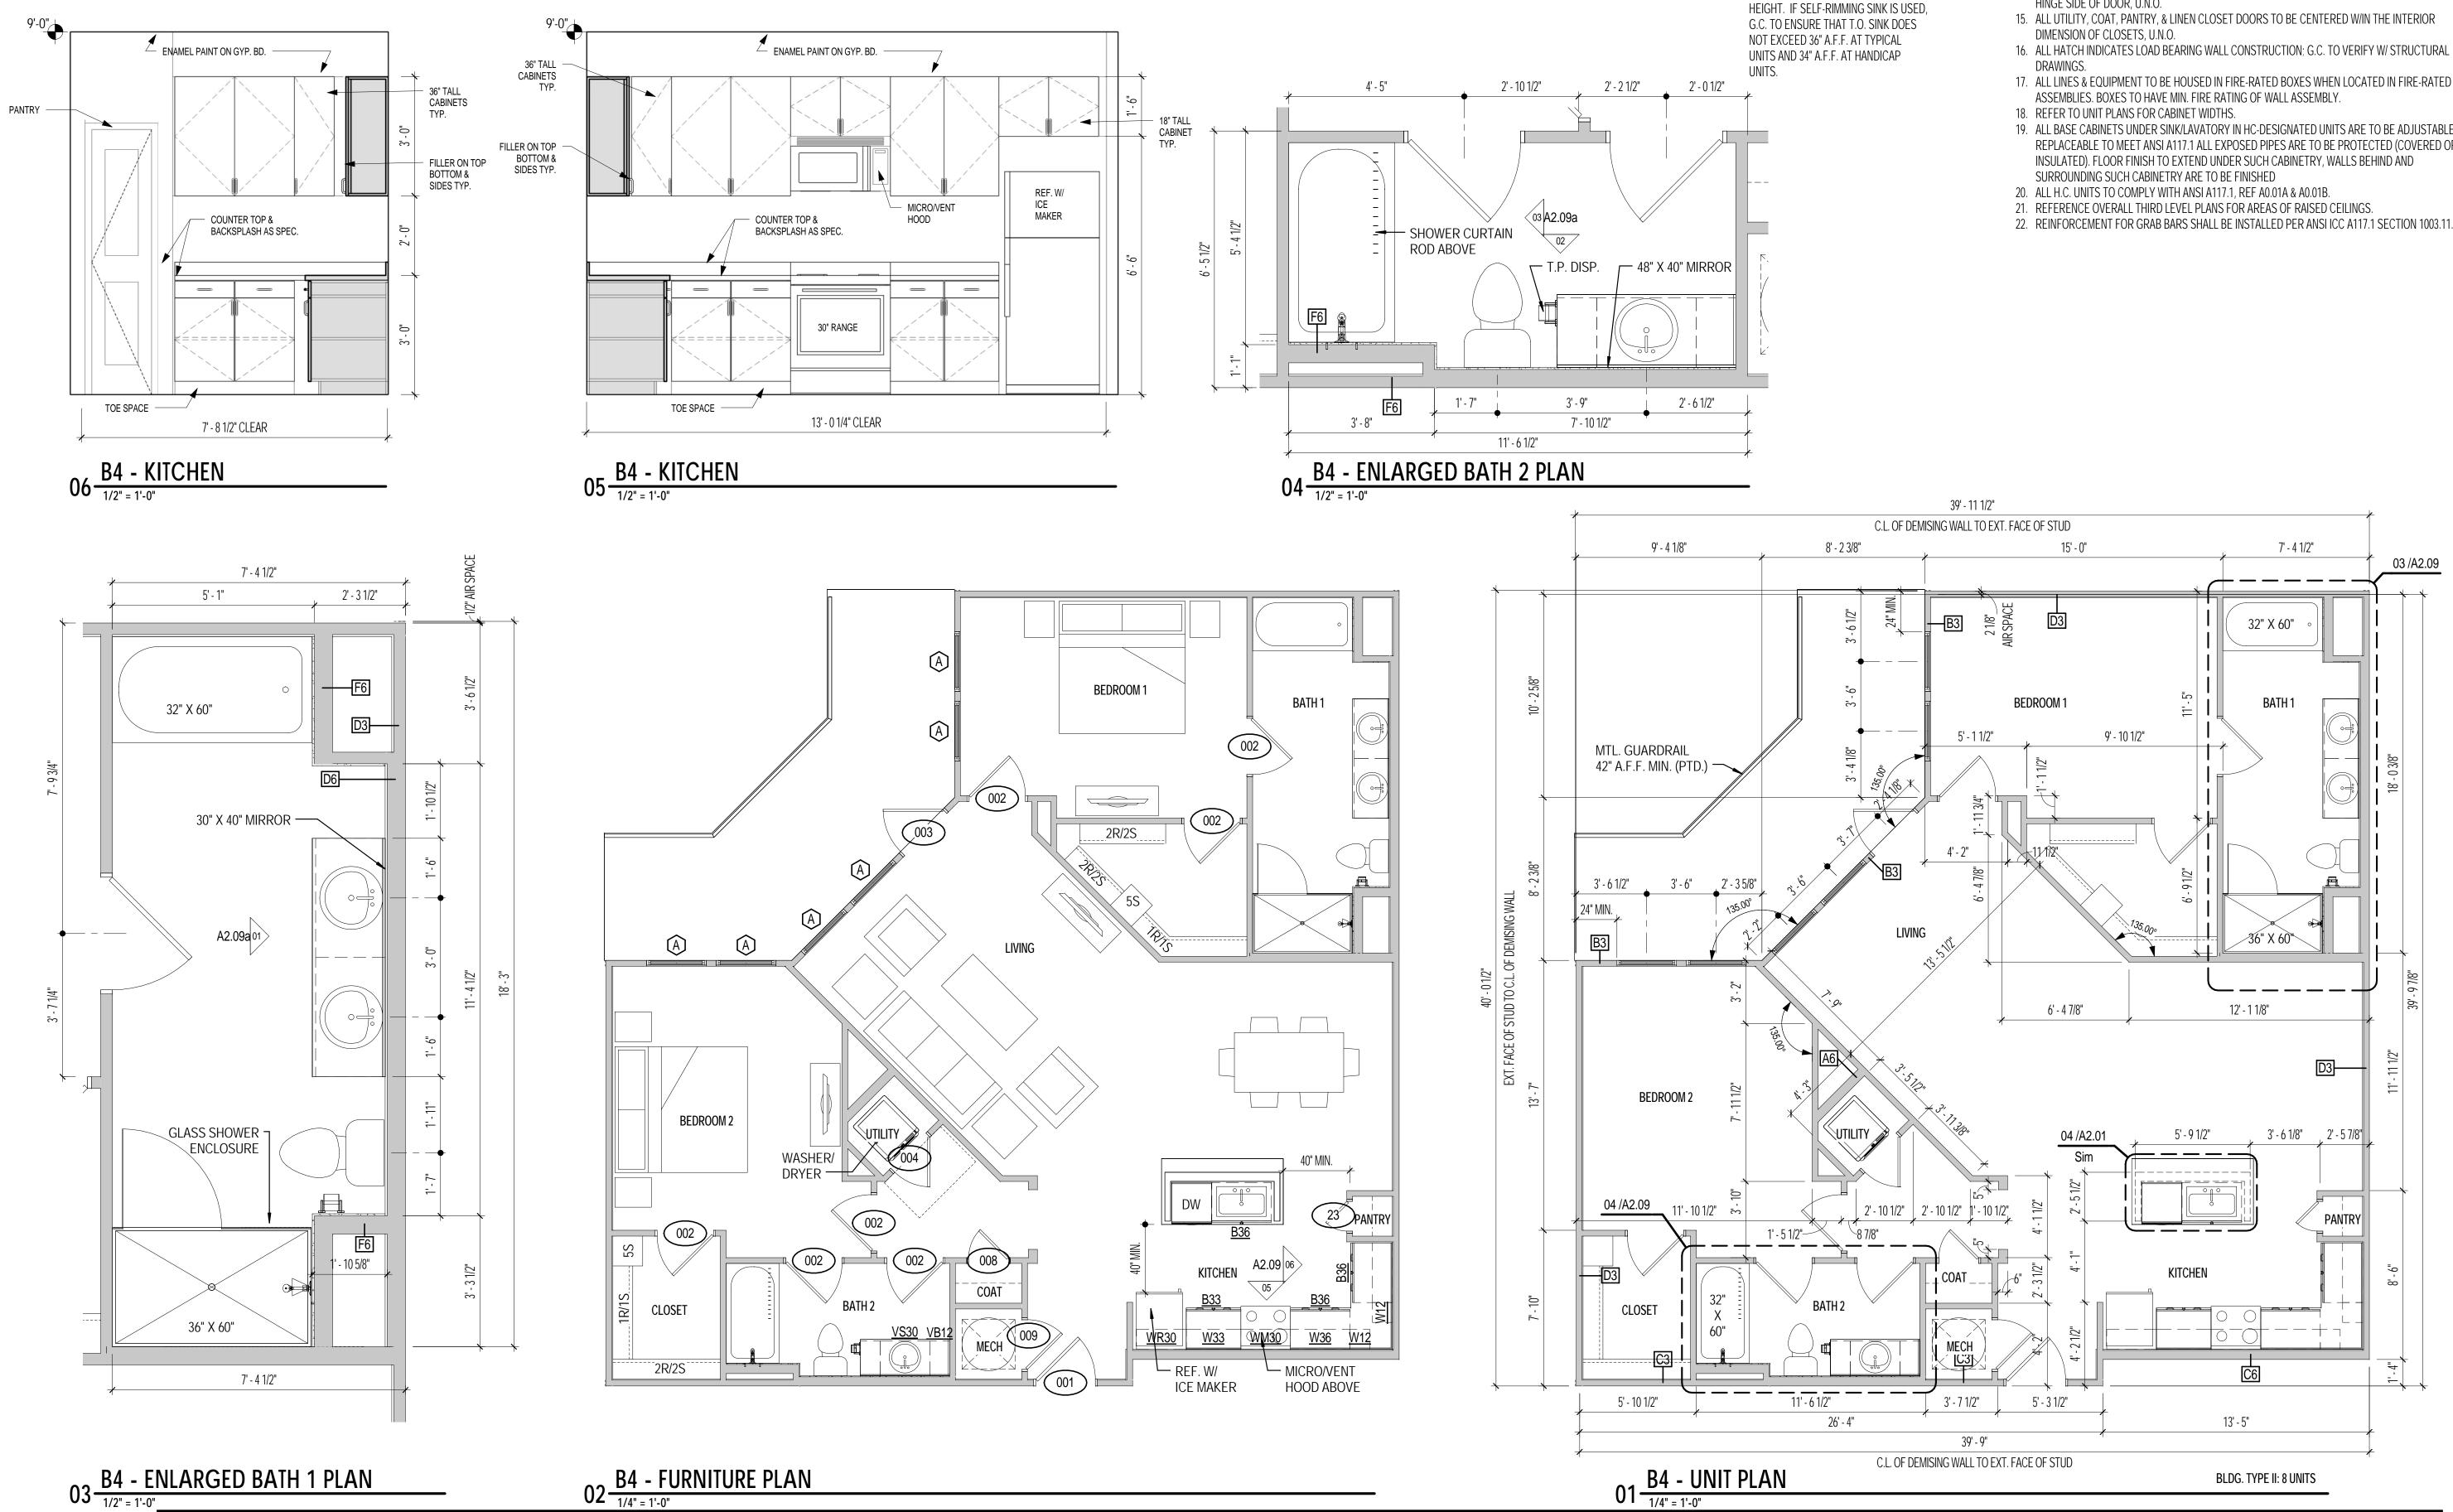

## CABINETRY LEGEND

W XX	WALL CABINET
WM XX	WALL CABINET A
WR XX	WALL CABINET A
B XX	BASE CABINET
RB XX	REMOVABLE BAS
SB XX	SINK BASE CABI
RSB XX	REMOVABLE SIN
P XX	PANTRY CABINE
VB XX	VANITY BASE CA
VS XX	VANITY SINK BAS
VD XX	VANITY DRAWER
L XX	LINEN CABINET
	WXX

DENOTES DENOTES CAB. CAB. TYPE WIDTH IN INCHES

NOTE: G.C. TO SUBMIT BASE CAB.


ABOVE MICRO. ABOVE REF.

- ASE CABINET NET
- NK BASE CABINET ABINET
- ASE CABINET ER BANK CABINET

## **UNIT PLAN GENERAL NOTES**

- 1. INTERIOR WALLS TO HAVE R-11 FIBERGLASS INSULATION AS INDICATED.
- 2. ALL DIMENSIONS ARE TO FACE OF STUD U.N.O., 2X4 (ACTUAL SIZE 1 1/2"X3 1/2") OR 2X6 (ACTUAL SIZE 1 1/2"X 5 1/2").
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- 6. HATCH INDICATES FURR DOWN TO 8'-0" U.N.O.
- 7. REF. ID DRAWINGS FOR FINISH SCHEDULE
- 8. REFER TO SHEET A7.01 FOR HORIZONTAL ASSEMBLIES.
- 9. REF. SHEETS A0.01A-A0.03C FOR ACCESSIBILITY DESIGN STANDARDS AND MOUNTING HEIGHTS.
- 10. WASHER TO BE ON LEFT SIDE AT ALL UTIL. LOCATIONS U.N.O. 11. PROVIDE ONE 2A:10B:C FIRE EXTINGUISHER AT EACH UNIT.
- 12. ALL INTERIOR UNIT PARTITIONS ARE WALL TYP 'A3' U.N.O.; REF TO SHEET A7.00 FOR ASSEMBLY DESCRIPTION.
- 13. ALL ENTRY DOOR ROUGH OPENINGS ARE TO BE LOCATED 5" OFF FACE OF FRAMING FROM HINGE SIDE OF DOOR, U.N.O.
- 14. ALL ROUGH DOOR OPENINGS W/IN UNITS ARE TO BE LOCATED 4" OFF FACE OF FRAMING FROM HINGE SIDE OF DOOR, U.N.O.
- 17. ALL LINES & EQUIPMENT TO BE HOUSED IN FIRE-RATED BOXES WHEN LOCATED IN FIRE-RATED WALL
- 19. ALL BASE CABINETS UNDER SINK/LAVATORY IN HC-DESIGNATED UNITS ARE TO BE ADJUSTABLE OR REPLACEABLE TO MEET ANSI A117.1 ALL EXPOSED PIPES ARE TO BE PROTECTED (COVERED OR

- 22. REINFORCEMENT FOR GRAB BARS SHALL BE INSTALLED PER ANSI ICC A117.1 SECTION 1003.11.4.

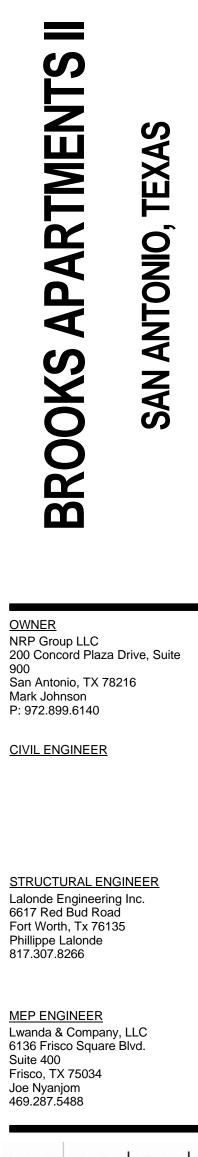

## gsr and rad ARCHITEC

## 4121 Commerce St. Ste. Dallas, Texas 75220

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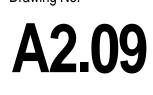
INTERIM REVIEW DOCUMENTS This document is preliminary and is not intended for Regulatory Approval, Permit, or Construction Purposes. This document is issued under the authority of Fernando J. Andrade, 17868 on 05-15-15.


Revisions:			


## Date: HDRC Submittal 05-15-15 Project No. 2310 Drawn By: Author Checked By:

Checker Sheet Title:


B4 - UNIT PLAN



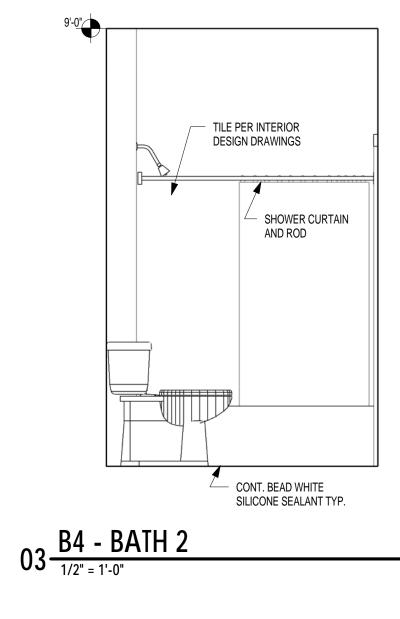

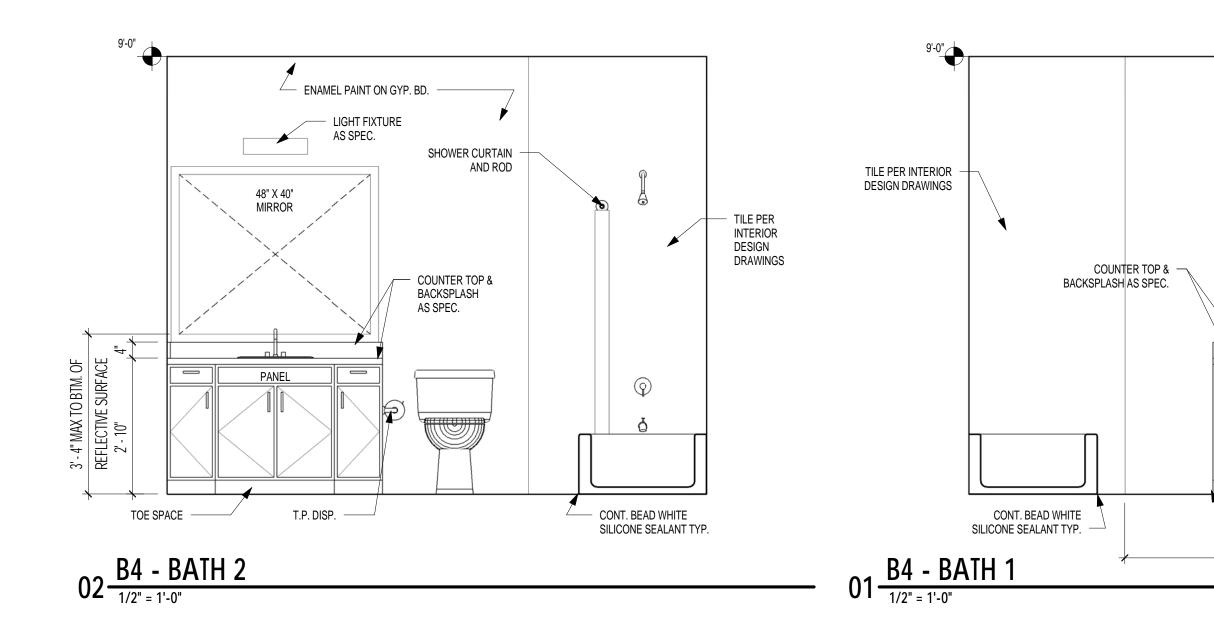



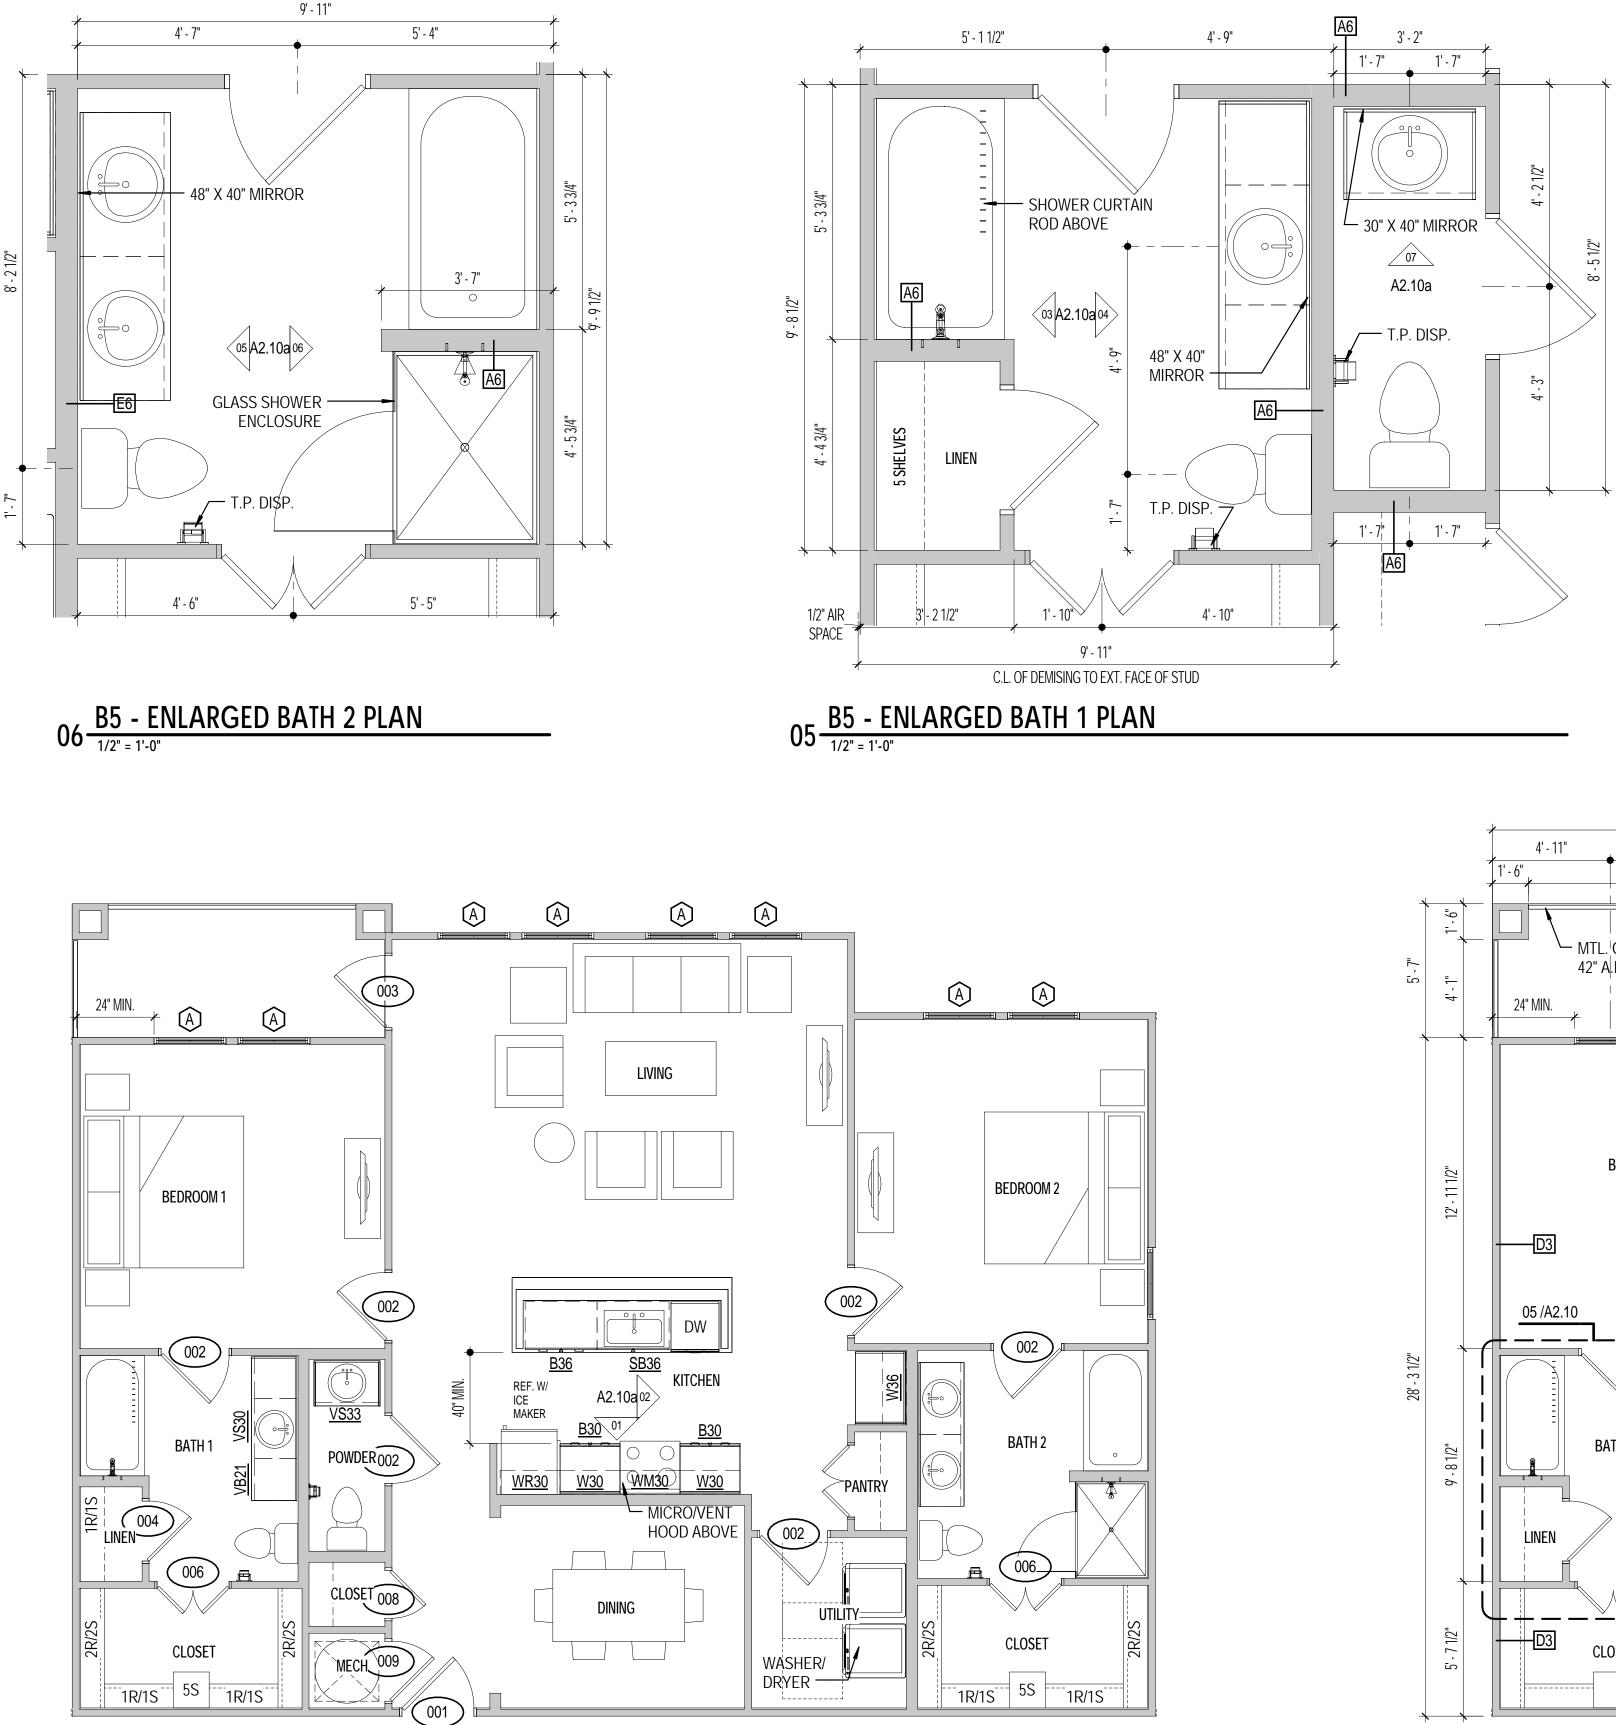


02 UNIT B5 - FURNITURE PLAN

## **CABINETRY LEGEND**


V XX	WALL CABINET
VM XX	WALL CABINET ABO
VR XX	WALL CABINET ABO
3 XX	BASE CABINET
RB XX	REMOVABLE BASE C
SB XX	SINK BASE CABINET
RSB XX	REMOVABLE SINK B
УΧ	PANTRY CABINET
/B XX	VANITY BASE CABIN
/S XX	VANITY SINK BASE C
/D XX	VANITY DRAWER BA
XX	LINEN CABINET
	WXX

DENOTES DENOTES CAB. CAB. TYPE WIDTH IN INCHES

NOTE: G.C. TO SUBMIT BASE CAB. HEIGHT. IF SELF-RIMMING SINK IS USED, G.C. TO ENSURE THAT T.O. SINK DOES NOT EXCEED 36" A.F.F. AT TYPICAL UNITS AND 34" A.F.F. AT HANDICAP UNITS.

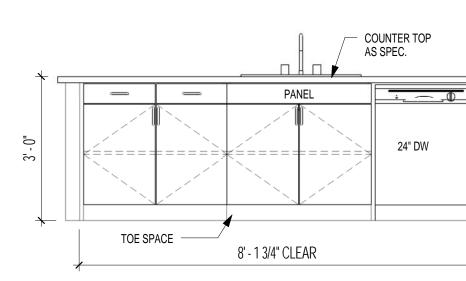

## KITCHEN ISLAND TYPE 6 ELEVATION 04 1/2" = 1'-0"

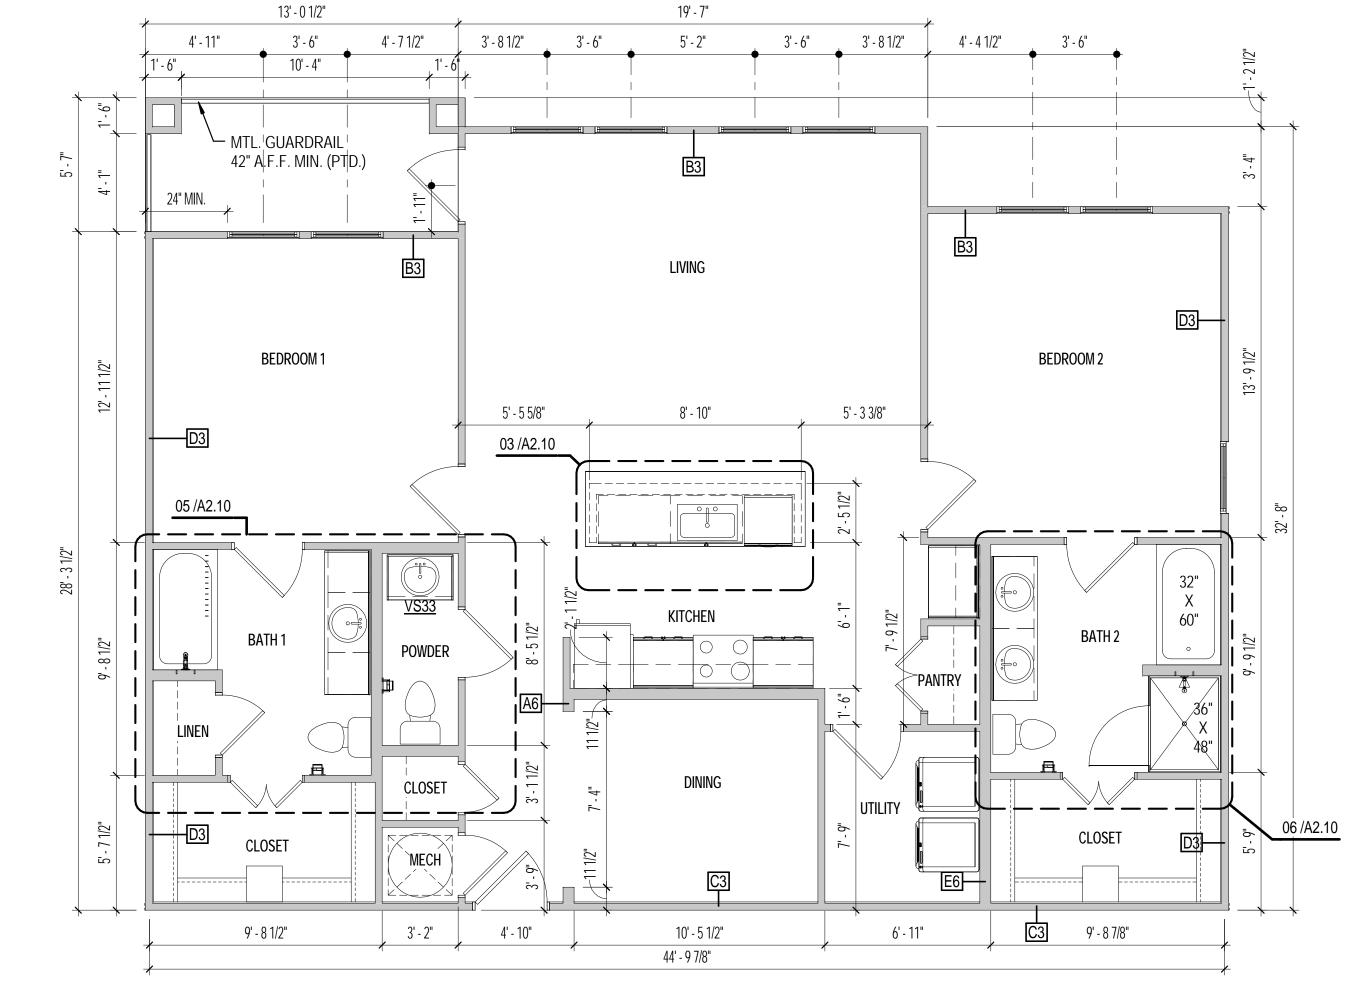

01 <u>B5 - UNIT PLAN</u> 1/4" = 1'-0"

## OVE MICRO. OVE REF.

- BASE CABINET
- CABINET ANK CABINET

- CABINET
- NET

- 13. ALL ENTRY DOOR ROUGH OPENINGS ARE TO BE LOCATED 5" OFF FACE OF FRAMING FROM HINGE SIDE OF DOOR, U.N.O. 14. ALL ROUGH DOOR OPENINGS W/IN UNITS ARE TO BE LOCATED 4" OFF FACE OF FRAMING FROM HINGE SIDE OF DOOR, U.N.O. 15. ALL UTILITY, COAT, PANTRY, & LINEN CLOSET DOORS TO BE CENTERED W/IN THE INTERIOR DIMENSION OF CLOSETS, U.N.O.

DESCRIPTION.

SIZE 1 1/2"X 5 1/2").

- 16. ALL HATCH INDICATES LOAD BEARING WALL CONSTRUCTION; G.C. TO VERIFY W/ STRUCTURAL DRAWINGS.
- 17. ALL LINES & EQUIPMENT TO BE HOUSED IN FIRE-RATED BOXES WHEN LOCATED IN FIRE-RATED WALL ASSEMBLIES. BOXES TO HAVE MIN. FIRE RATING OF WALL ASSEMBLY
- 18. REFER TO UNIT PLANS FOR CABINET WIDTHS. 19. ALL BASE CABINETS UNDER SINK/LAVATORY IN HC-DESIGNATED UNITS ARE TO BE ADJUSTABLE OR REPLACEABLE TO MEET ANSI A117.1 ALL EXPOSED PIPES ARE TO BE PROTECTED (COVERED OR INSULATED). FLOOR FINISH TO EXTEND UNDER SUCH CABINETRY, WALLS BEHIND AND SURROUNDING SUCH CABINETRY ARE TO BE FINISHED
- 20. ALL H.C. UNITS TO COMPLY WITH ANSI A117.1, REF A0.01A & A0.01B.

**UNIT PLAN GENERAL NOTES** 

1. INTERIOR WALLS TO HAVE R-11 FIBERGLASS INSULATION AS INDICATED.

4. DOOR SCHEDULE & WINDOW SCHEDULE ARE LOCATED ON SHEET A 7.10.

6. HATCH INDICATES FURR DOWN TO 8'-0" U.N.O.

10. WASHER TO BE ON LEFT SIDE AT ALL UTIL. LOCATIONS U.N.O. 11. PROVIDE ONE 2A:10B:C FIRE EXTINGUISHER AT EACH UNIT.

8. REFER TO SHEET A7.01 FOR HORIZONTAL ASSEMBLIES.

7. REF. ID DRAWINGS FOR FINISH SCHEDULE

5. ALL ANGLES ARE 45 DEG. TO HORIZONTAL & VERTICAL TYP, ALL UNITS, U.N.O.

2. ALL DIMENSIONS ARE TO FACE OF STUD U.N.O., 2X4 (ACTUAL SIZE 1 1/2"X3 1/2") OR 2X6 (ACTUAL


9. REF. SHEETS A0.01A-A0.03C FOR ACCESSIBILITY DESIGN STANDARDS AND MOUNTING HEIGHTS.

12. ALL INTERIOR UNIT PARTITIONS ARE WALL TYP 'A3' U.N.O.; REF TO SHEET A7.00 FOR ASSEMBLY

3. PROVIDE WOOD BLOCKING FOR ALL ACCESSORIES AS REQ'D, INCLUDING TOWEL BARS, GRAB BARS,


ELECTRICAL FIXTURES AND SHOWER SEATS. REF. 04/A2.00 FOR GRAB BAR BLOCKING LOCATIONS.

- 21. REFERENCE OVERALL THIRD LEVEL PLANS FOR AREAS OF RAISED CEILINGS.
- 22. REINFORCEMENT FOR GRAB BARS SHALL BE INSTALLED PER ANSI ICC A117.1 SECTION 1003.11.4.

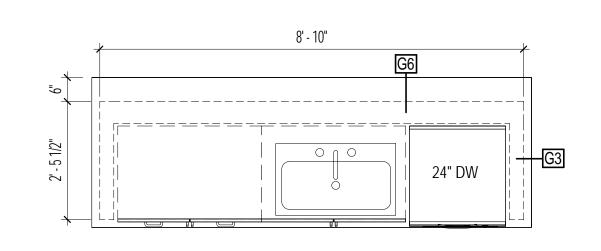



BLDG. TYPE III: 4 UNITS BLDG. TYPE IV: 10 UNITS

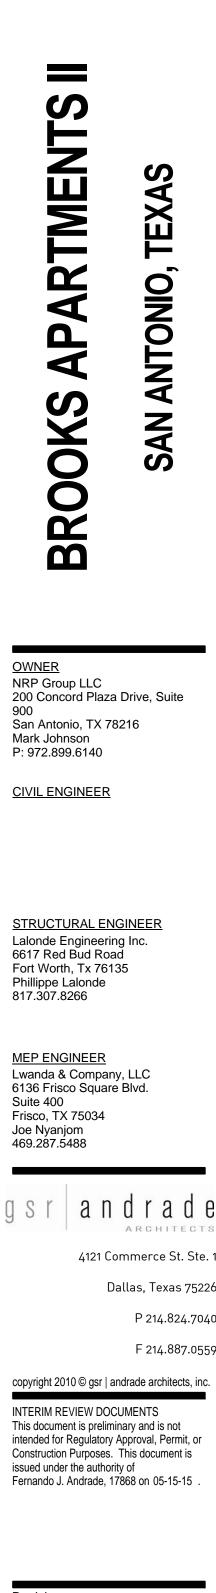


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Date HDR 05-1	C Submitta	ıl
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Cher	cked By:	

Checked By: Checker Sheet Title:

B5 & B5a - UNIT PLAN

Drawing No. A2.10

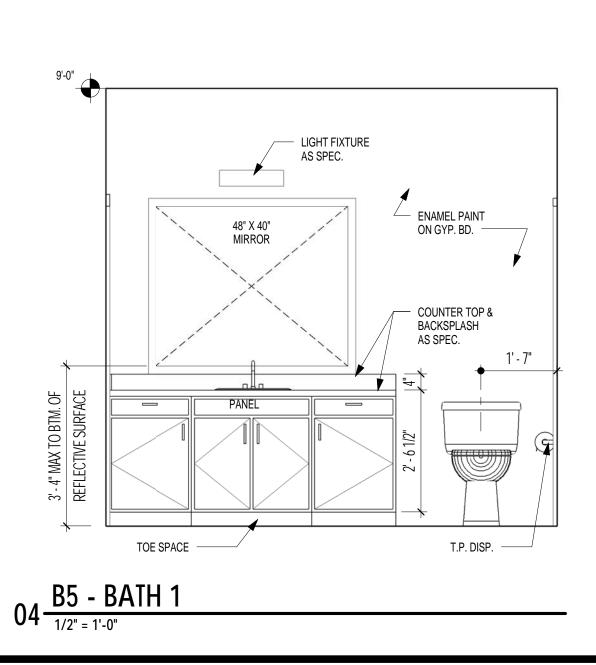



9'-0"


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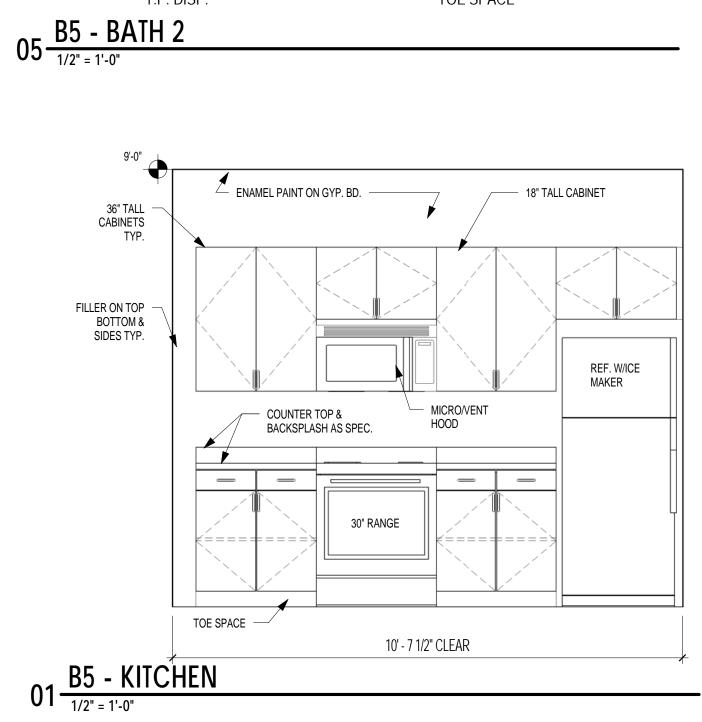
O BTM. SURFA


ENAMEL PAINT --ON GYP. BD.



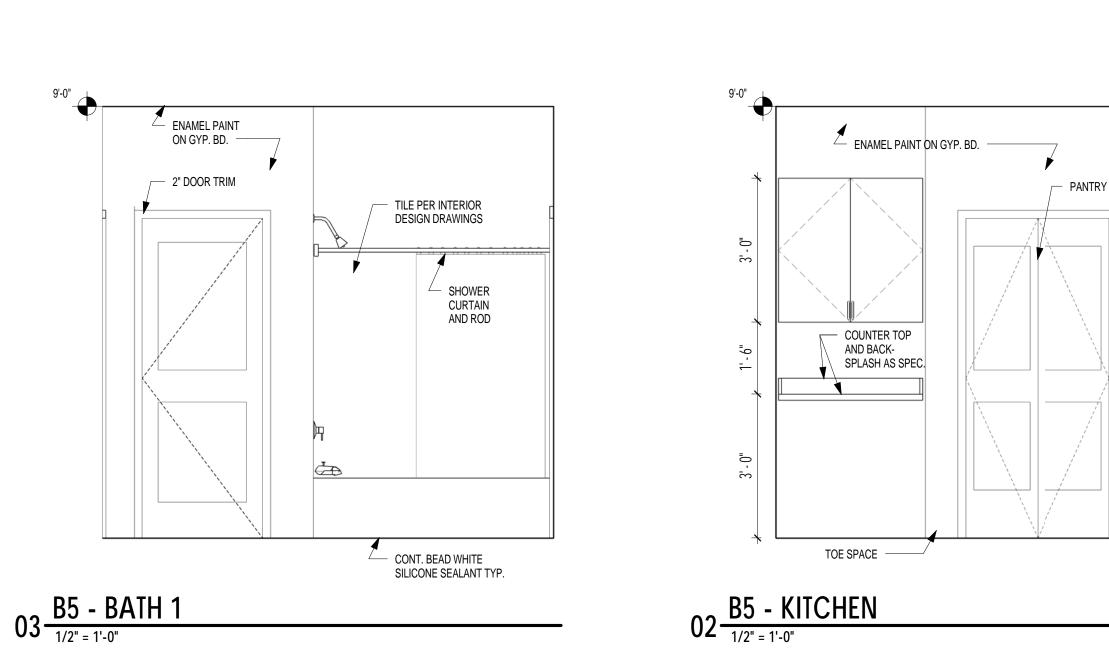

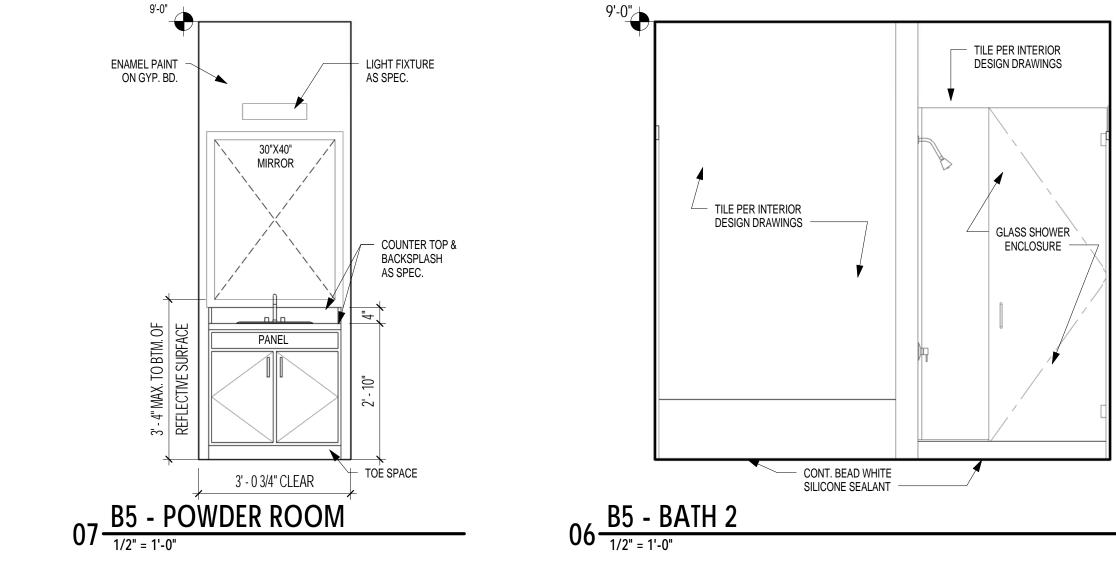

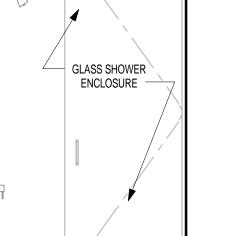

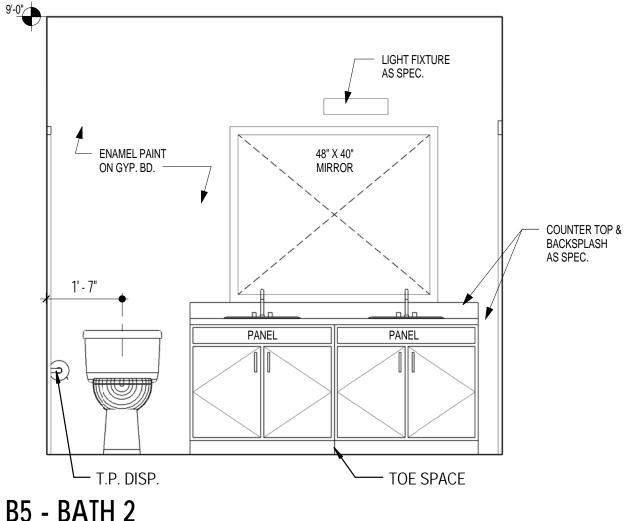

Lalonde Engineering Inc. 6617 Red Bud Road Fort Worth, Tx 76135 Phillippe Lalonde 817.307.8266
<u>MEP ENGINEER</u> Lwanda & Company, LLC 6136 Frisco Square Blvd. Suite 400 Frisco, TX 75034 Joe Nyanjom 469.287.5488
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Revisions:
Date:
HDRC Submittal 05-15-15
Project No.
2310
Drawn By: Author
Checked By:

Sheet Title:

Drawing No.

B5 & B5a - UNIT ELEVATIONS

A2.10a

# BROOKS

**APARTMENTS** 

TEXAS


SAN ANTONIO,

<u>OWNER</u> NRP Group LLC 200 Concord Plaza Drive, Suite 900 San Antonio, TX 78216 Mark Johnson P: 972.899.6140

CIVIL ENGINEER

STRUCTURAL ENGINEER Lalonde Engineering Inc.

## 01 BUILDING TYPE I - GROUND LEVEL FLOOR PLAN

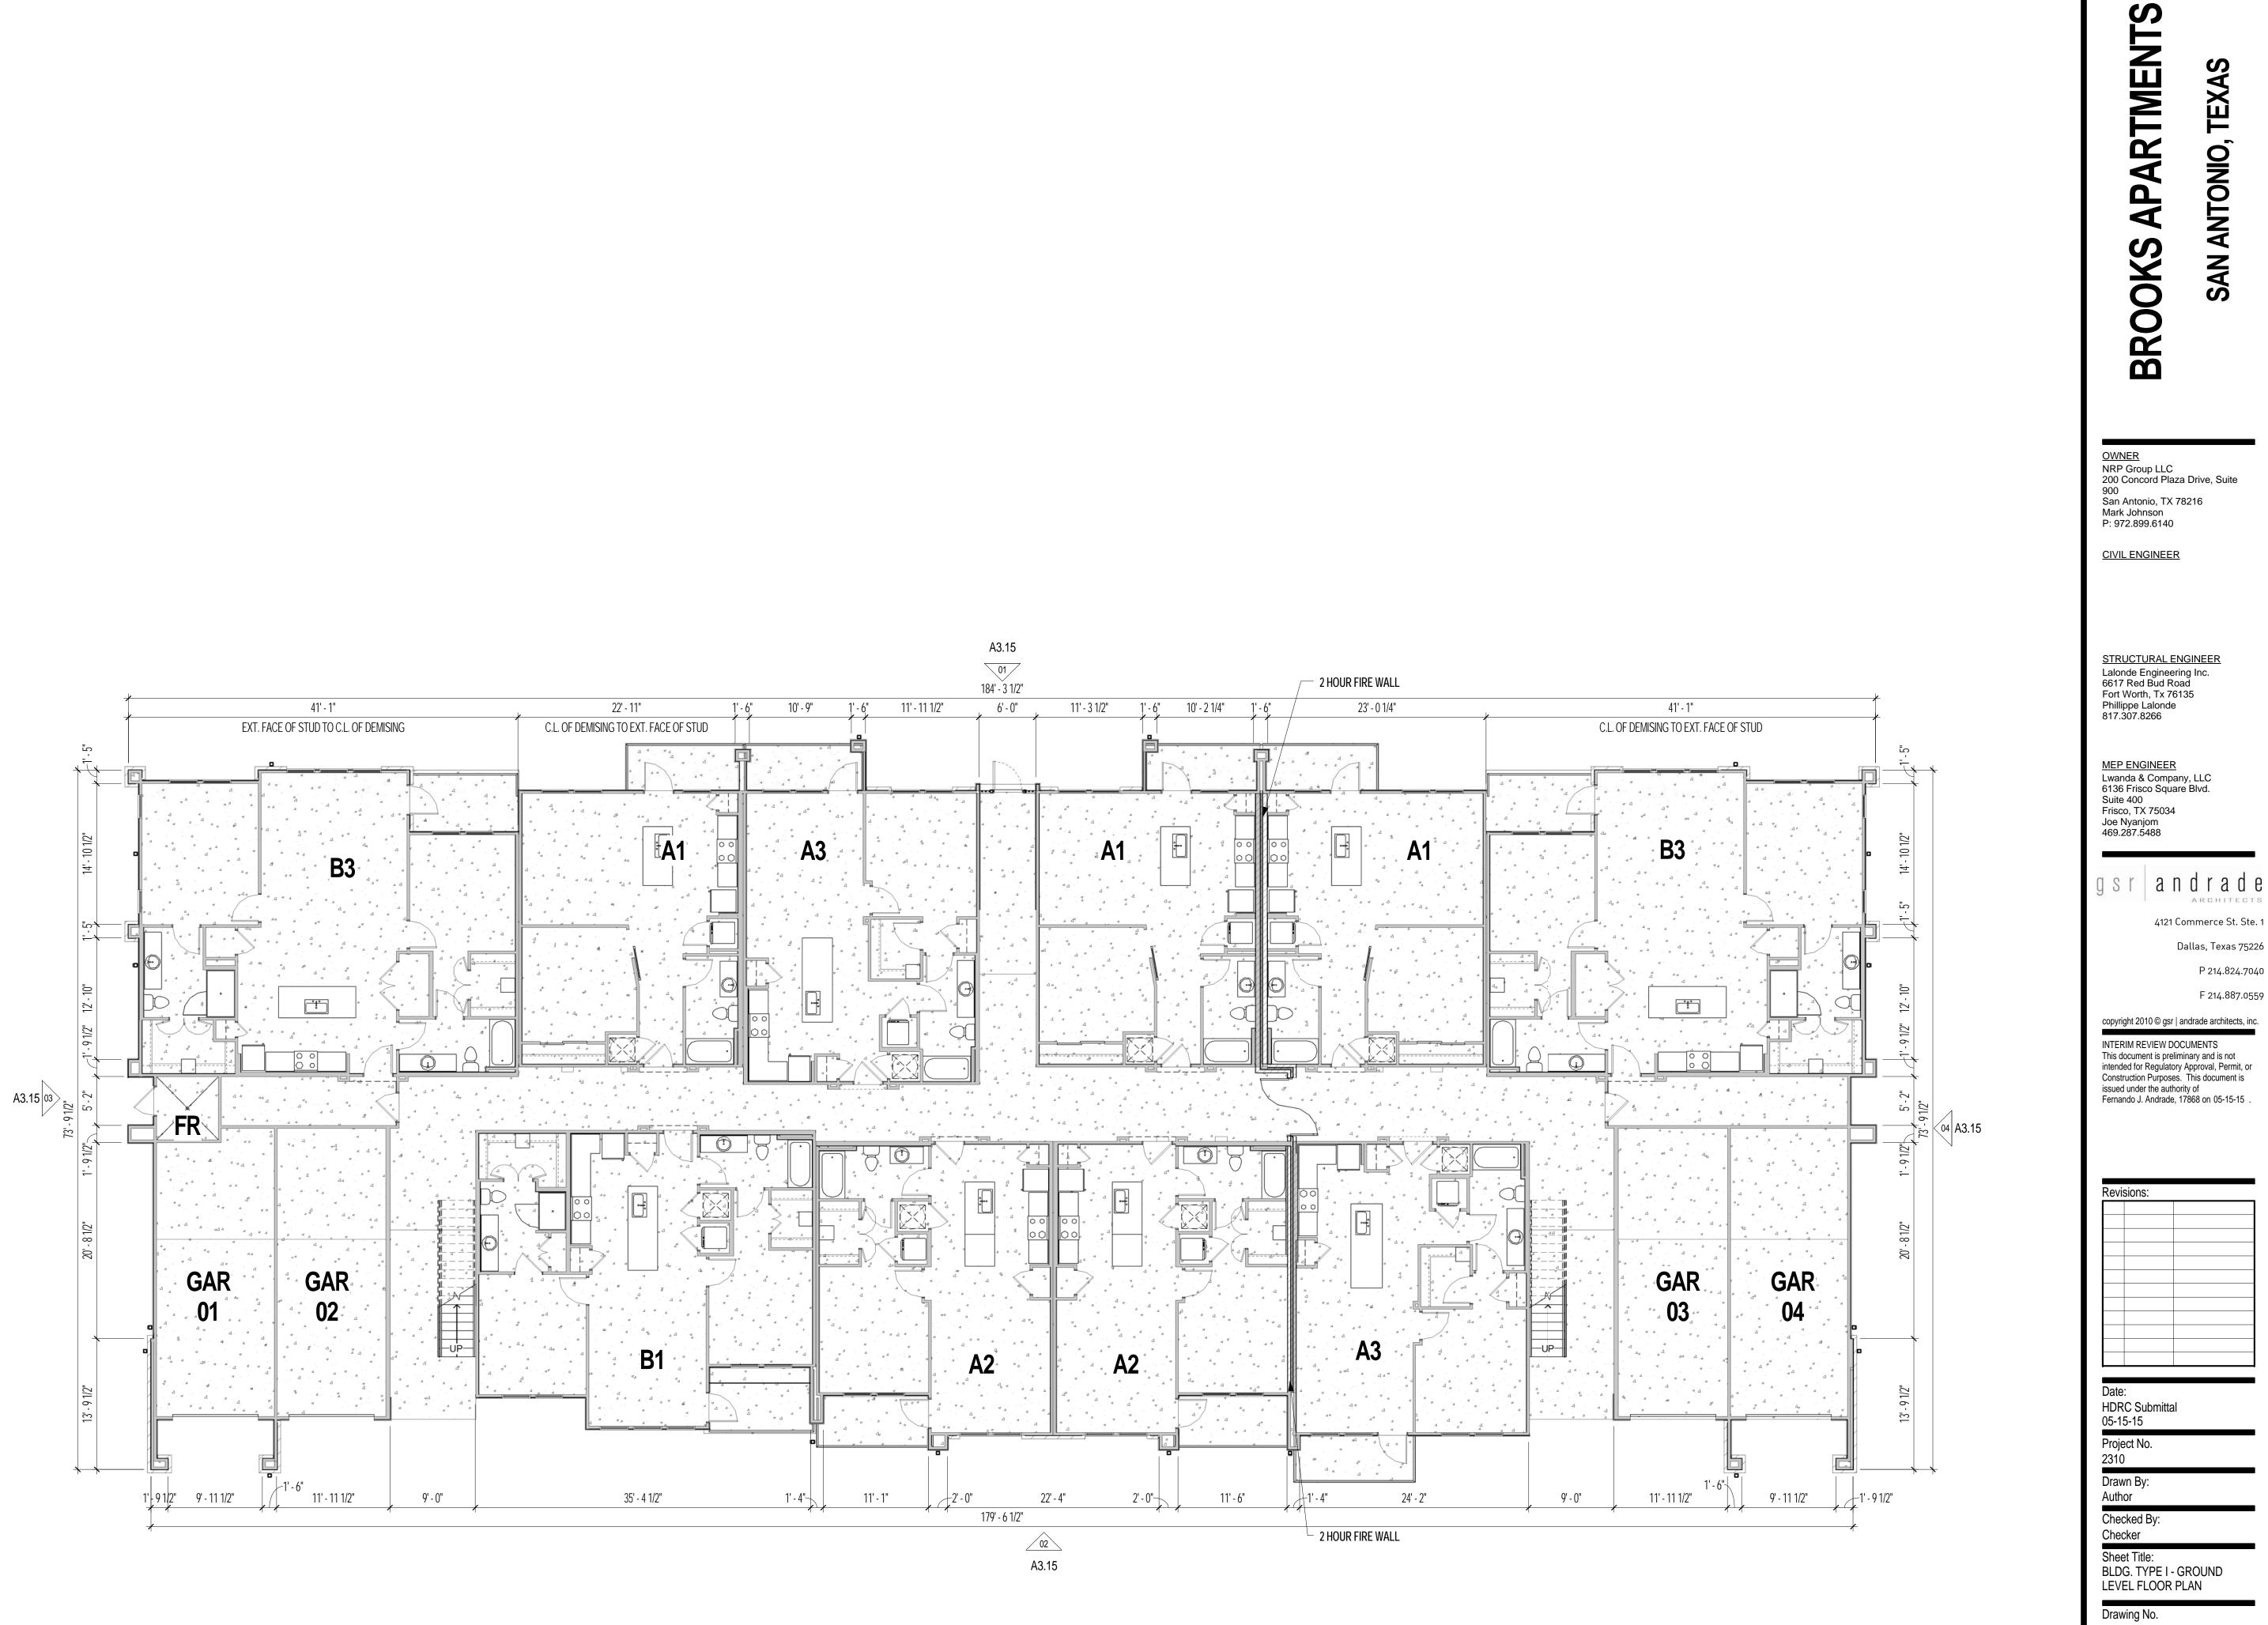




S

TEXA

## 01 BUILDING TYPE I - SECOND LEVEL FLOOR PLAN

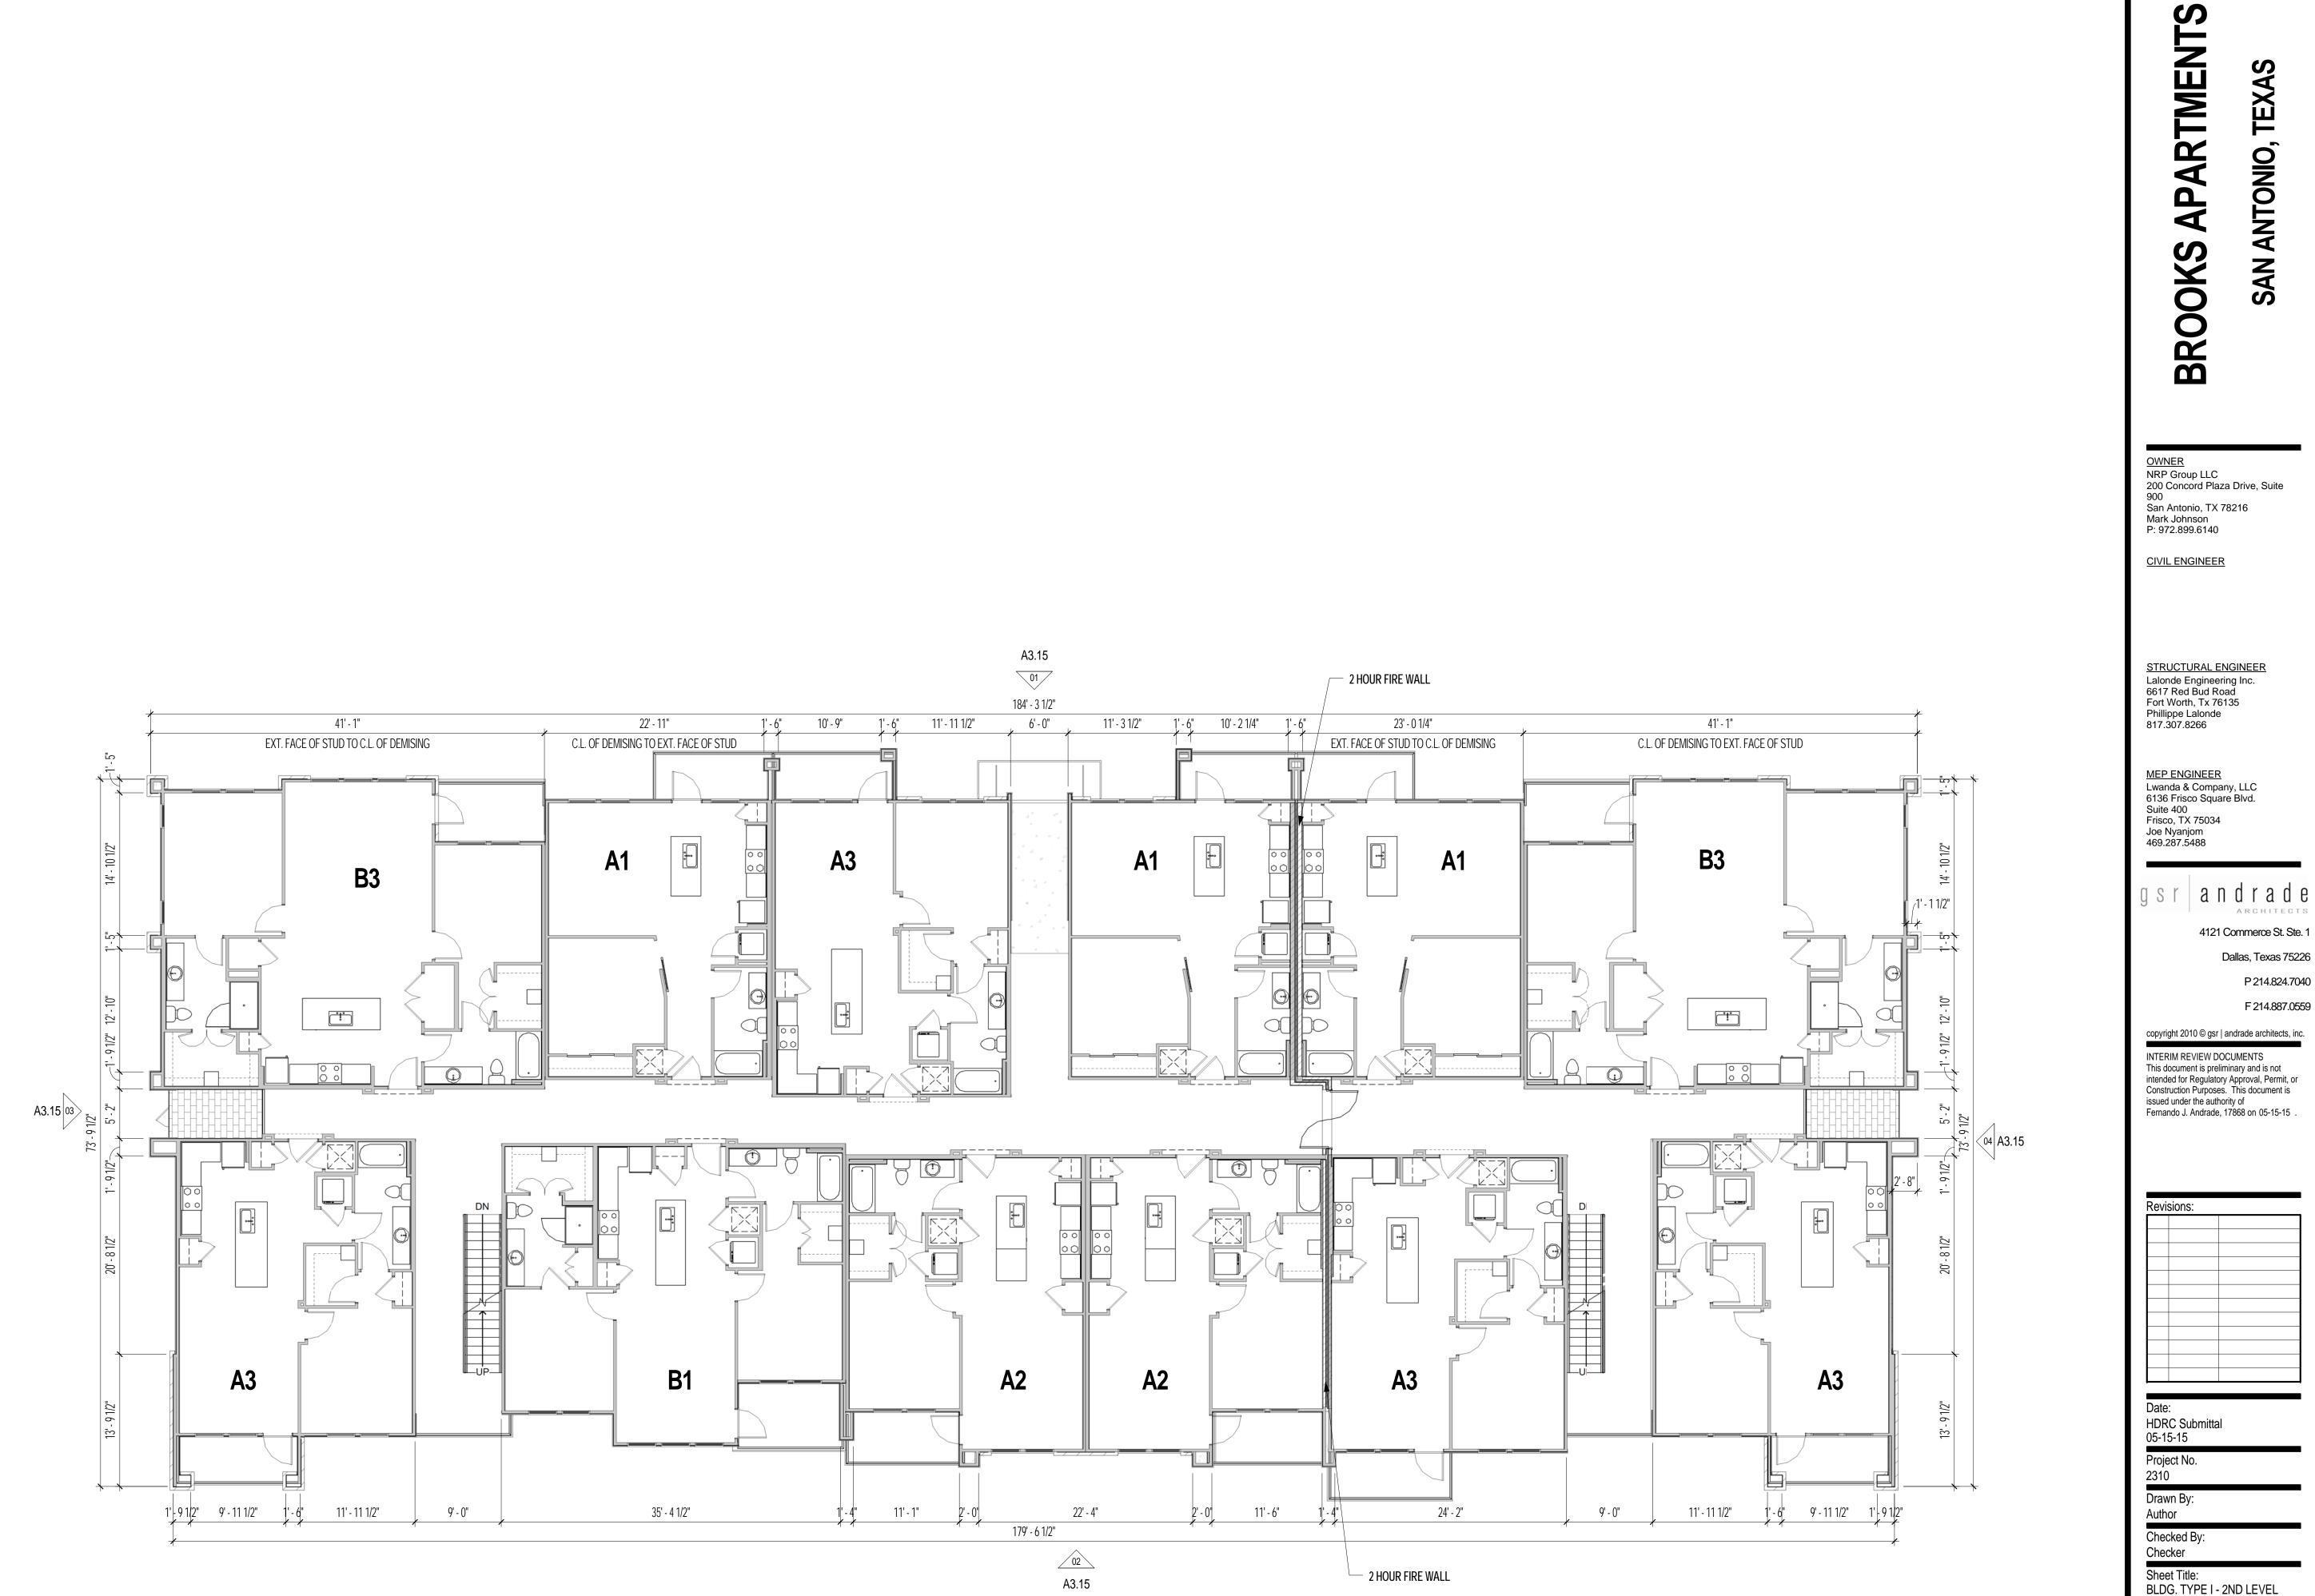


Sheet Title: BLDG. TYPE I - 2ND LEVEL FLOOR PLAN

Drawing No.

S



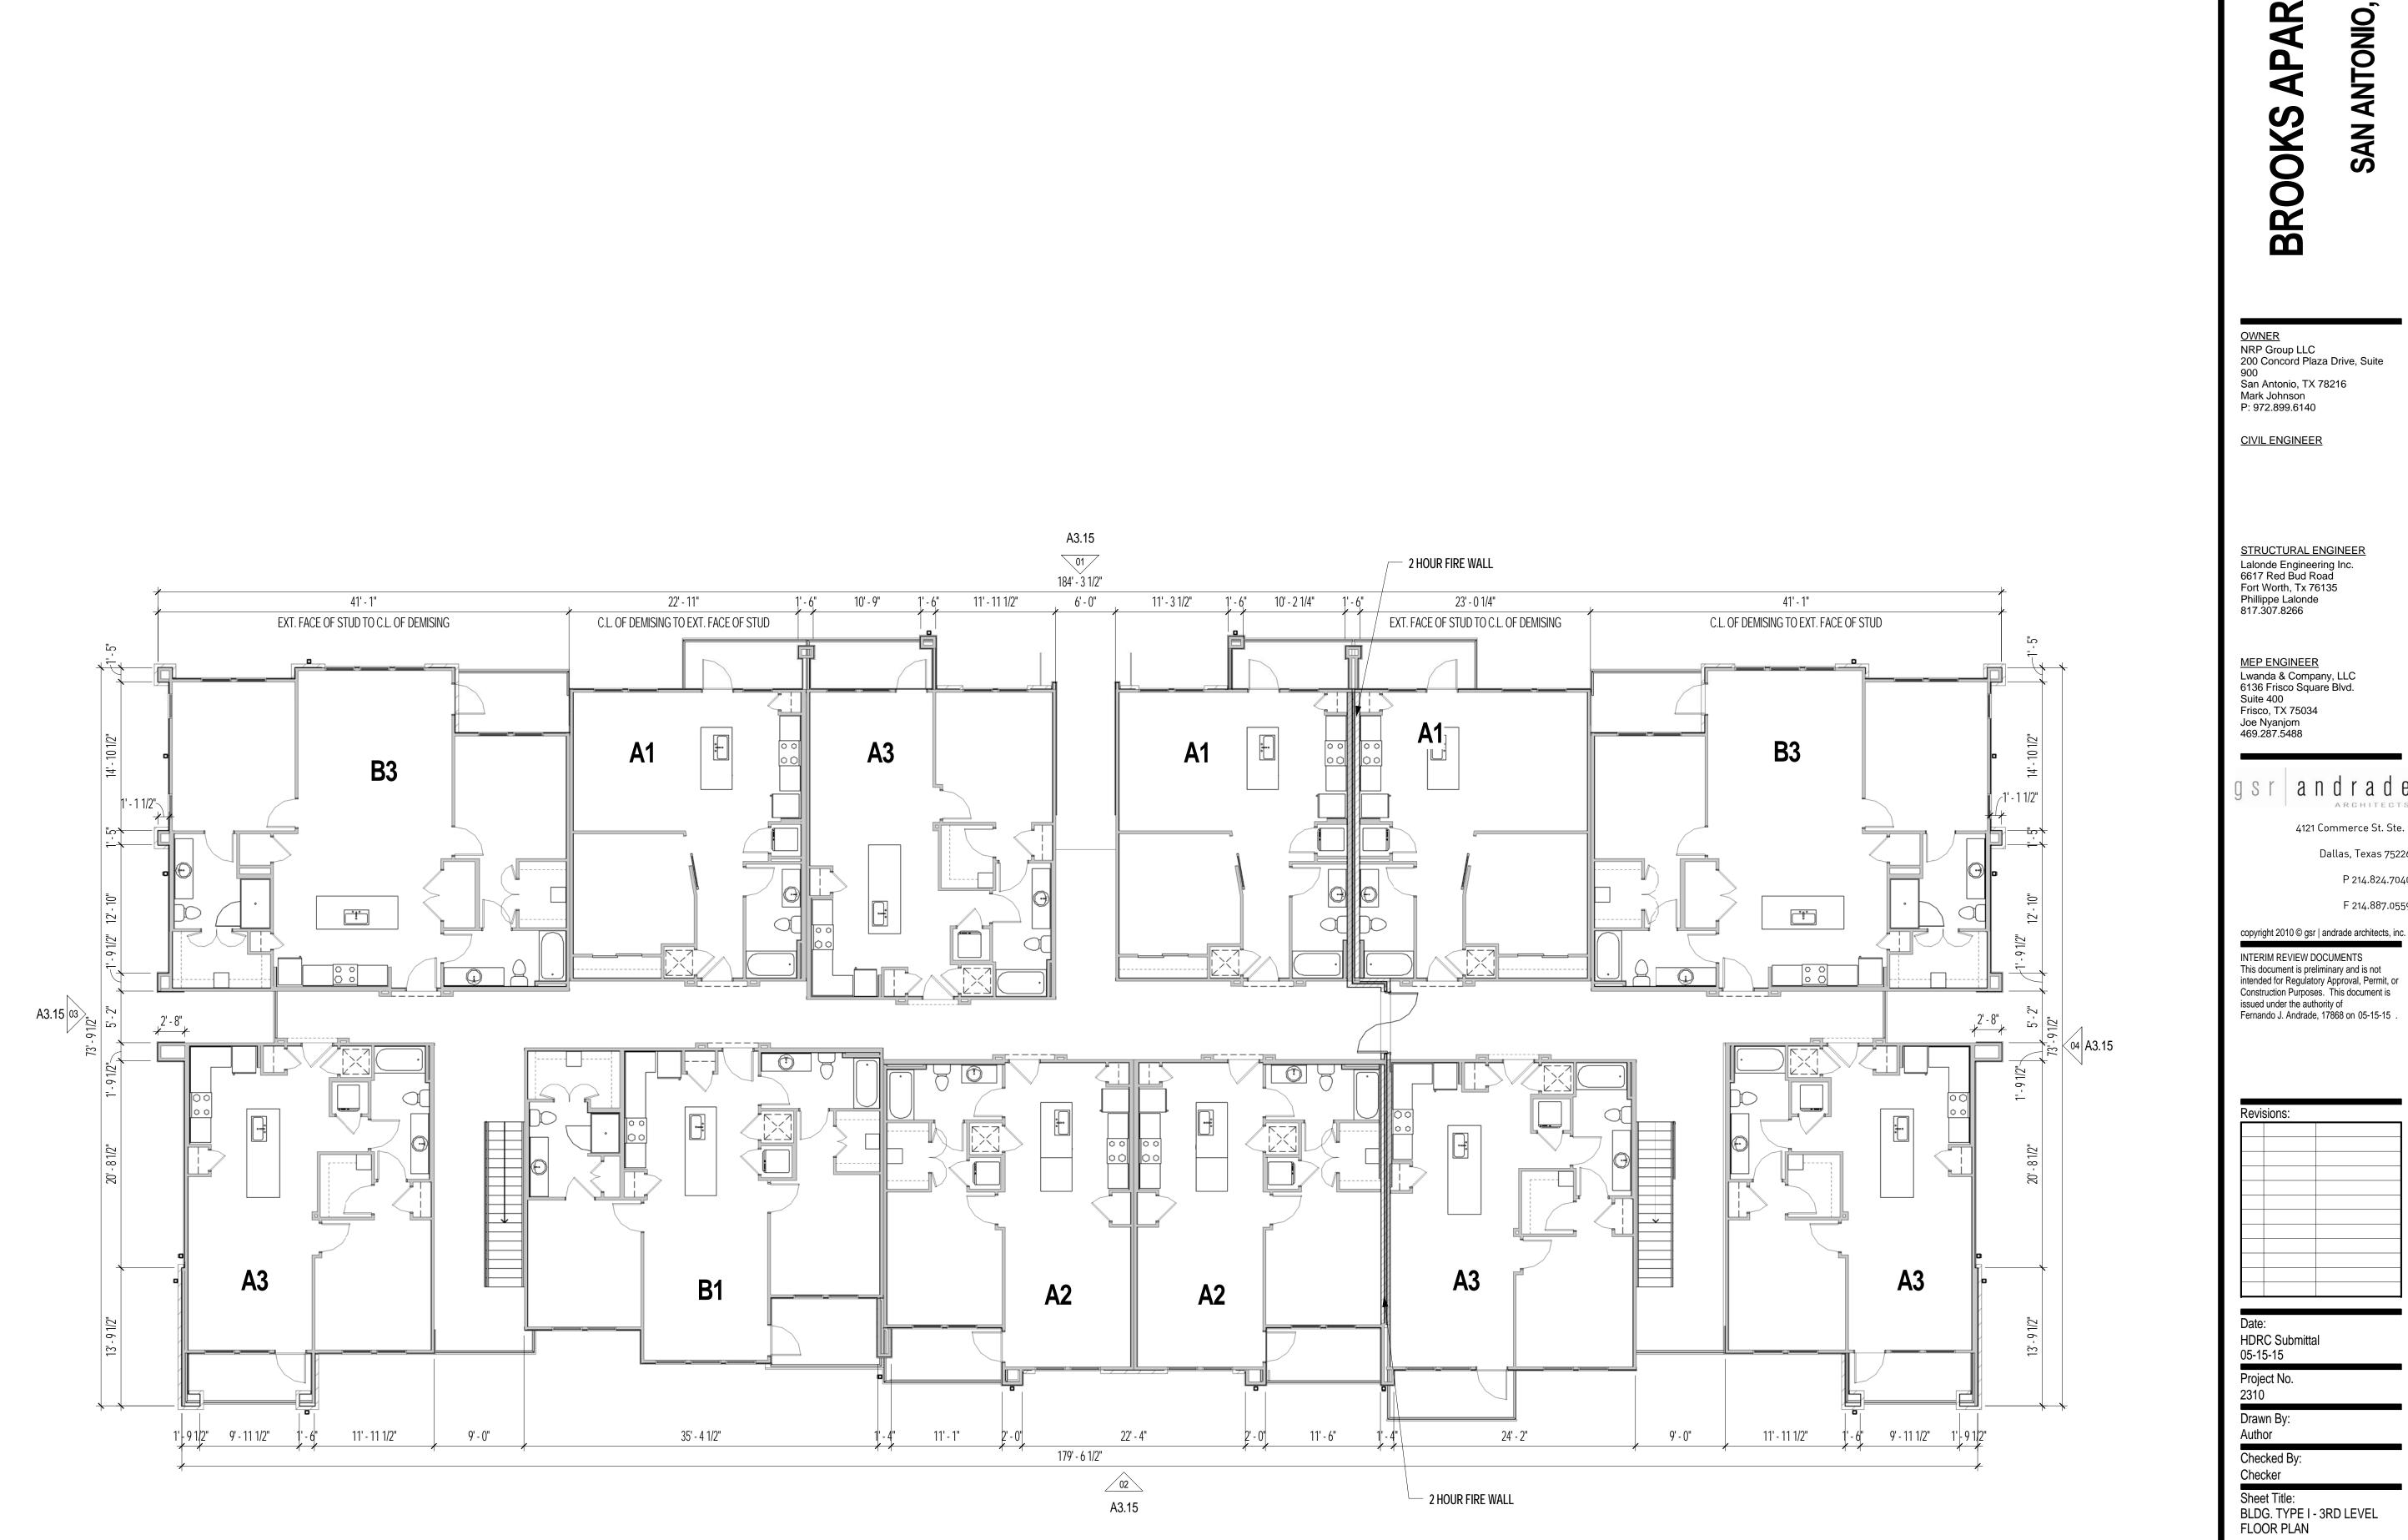

**ARTMENTS** TEXAS AP


## gsr andrade ARCHITECT 4121 Commerce St. Ste.

Dallas, Texas 75226

P 214.824.7040 F 214.887.0559

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Drawing No. A3.13

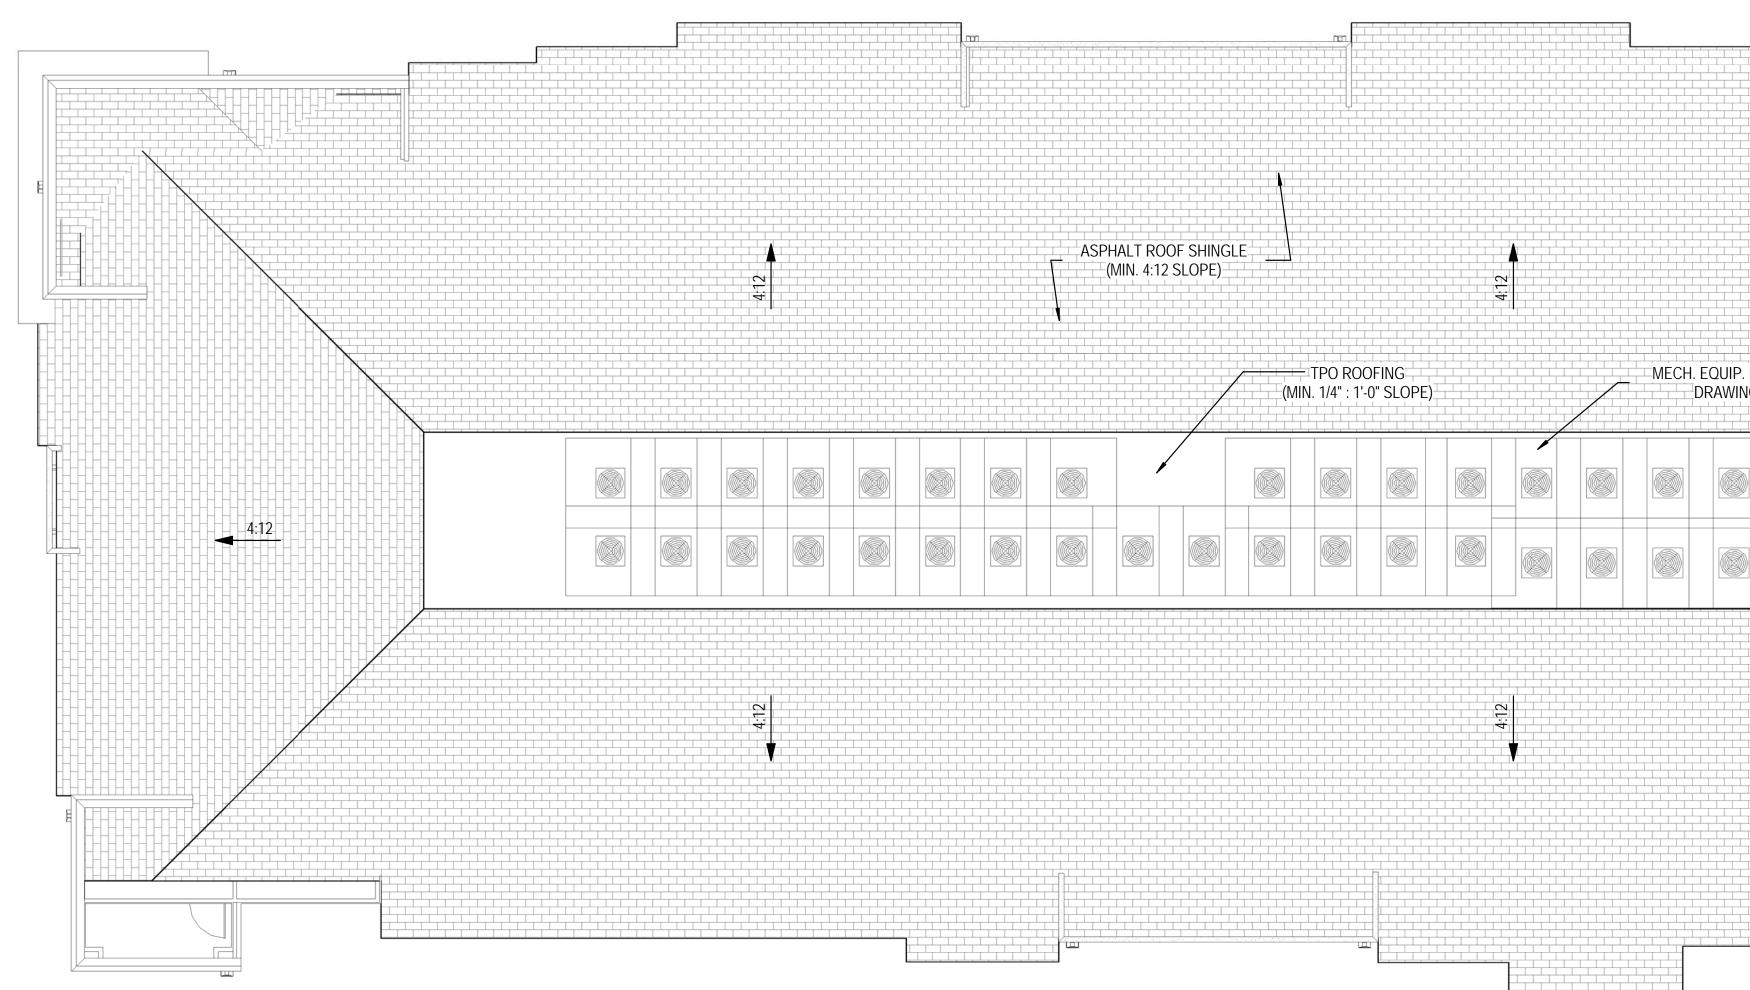

## A3.15 03

# 01 BUILDING TYPE I - ROOF PLAN

## ROOF PLAN GENERAL NOTES

- 1. DOWNSPOUT REQUIRED EVERY 25-0" OF GUTTER.
- 2. MIN. 3'-0"w X 5'-6"h MAINTENANCE ACCESS DOOR REQ'D @ MECH. WELLS. 3. ATTIC SPACES TO BE FULLY SPRINKLERED W/AUTOMATIC SPRINKLER SYSTEM IN
- ACCORDANCE WITH NFPA 13R.
- 4. SLOPE AT ALL TPO ROOFS IS 1/4" PER 1'-0" U.N.O.
- 5. ALL PLUMBING VENT PIPES TO BE PAINTED TO MATCH ROOFING.

## **ROOF PLAN LEGEND**

DRAFTSTOPS (MUST MEET REQ'T. SET FORTH IN 2012 IBC SECTION 718.4)


SOFFIT VENT

LINE OF BUILDING BELOW

LOW PROFILE ROOF VENT (70 SQ. IN. NET FREE AREA PER VENT)

RIDGE VENT (18 SQ. IN. NET FREE AREA PER LINEAR FT.)

4" X 6" PRE-FINISHED METAL DOWNSPOUT

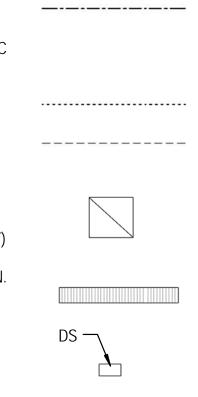




		BROOKS APARTMENTS II SAN ANTONIO, TEXAS
		OWNER NRP Group LLC 200 Concord Plaza Drive, Suite 900 San Antonio, TX 78216 Mark Johnson P: 972.899.6140 <u>CIVIL ENGINEER</u>
		STRUCTURAL ENGINEER Lalonde Engineering Inc. 6617 Red Bud Road Fort Worth, Tx 76135 Phillippe Lalonde 817.307.8266 <u>MEP ENGINEER</u>
		Lwanda & Company, LLC 6136 Frisco Square Blvd. Suite 400 Frisco, TX 75034 Joe Nyanjom 469.287.5488
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	4:12 • 43.15	Revisions:
		Date: HDRC Submittal 05-15-15
		Project No. 2310 Drawn By: Author Checked By: Checker

Sheet Title: BLDG TYPE I - ROOF PLAN








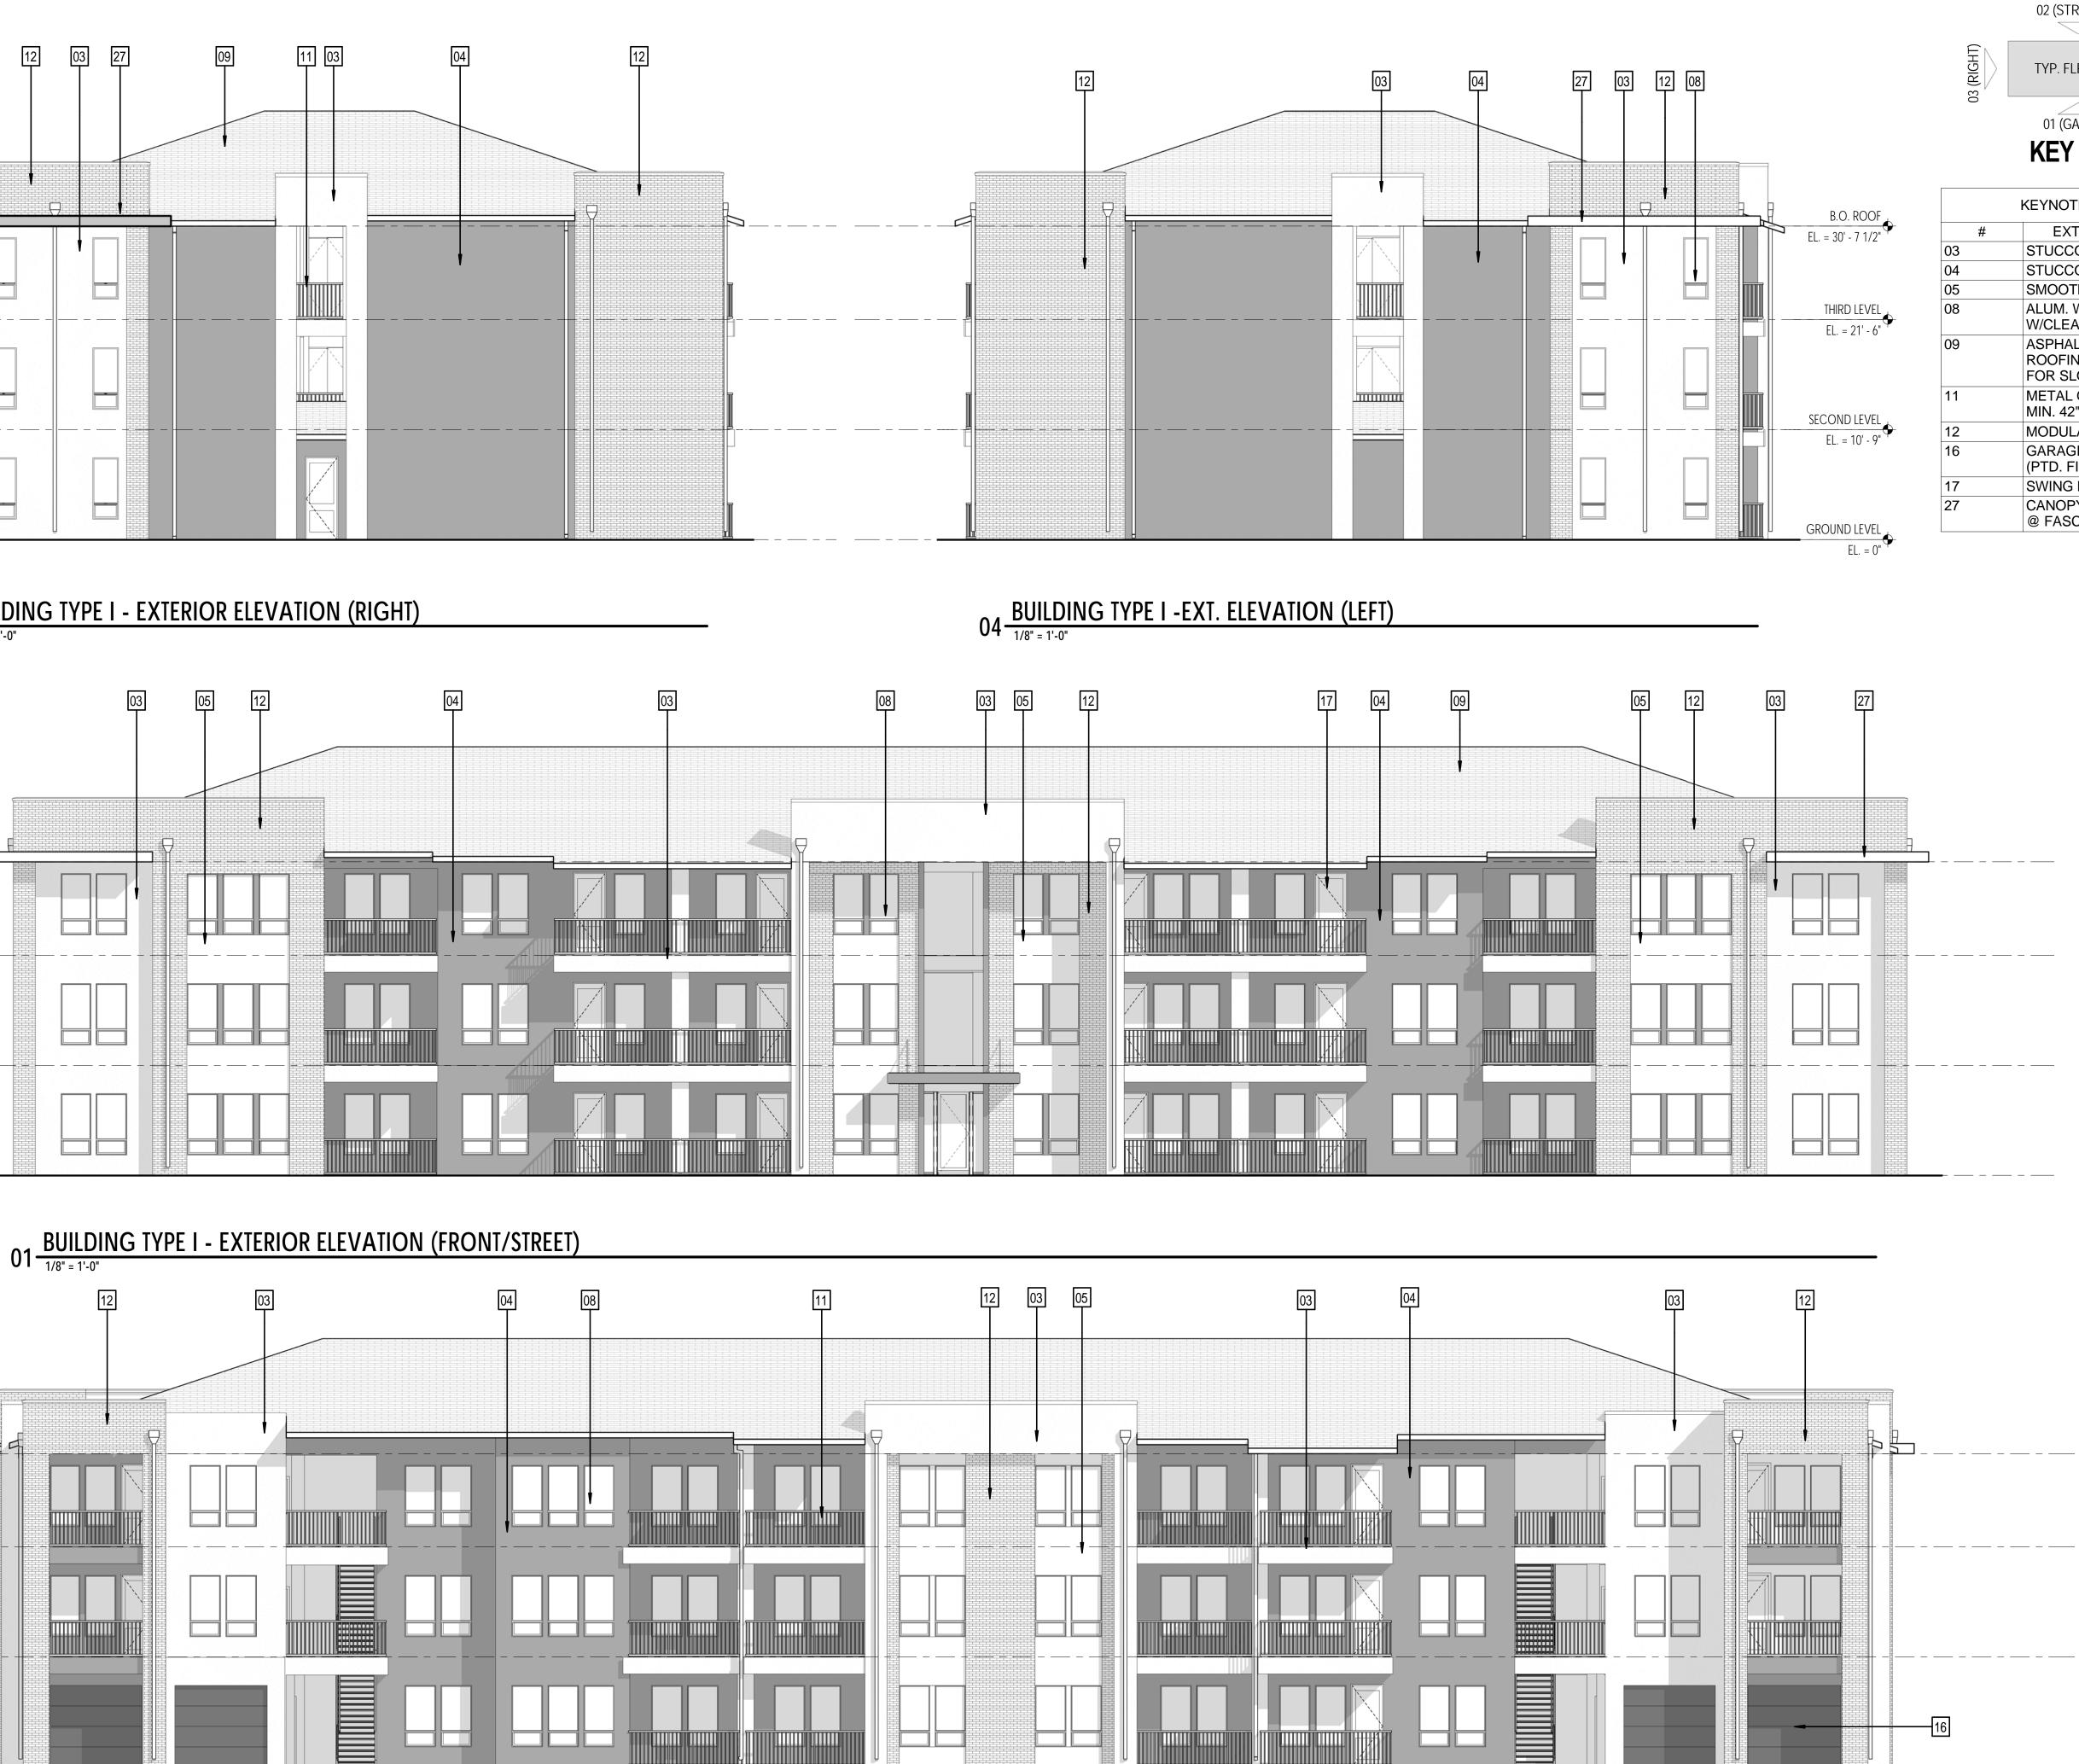







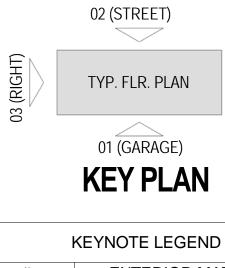


04 (LEFT)


#	EXTERIOR MATERIAL
03	STUCCO FINISH 'A'
04	STUCCO FINISH 'B'
05	SMOOTH STUCCO FINISH 'C'
28	ALUM. WINDOW PER PLAN W/CLEAR ANODIZED FINISH
09	ASPHALT COMPOSITION ROOFING (REF. ROOF PLAN FOR SLOPE)
11	METAL GUARDRAIL (PTD.) - MIN. 42" A.F.F.
12	MODULAR BRICK
16	GARAGE DOOR PER PLAN (PTD. FINISH 'A')
17	SWING DOOR PER PLAN
27	CANOPY W/STUCCO FINISH @ FASCIA

BROOKS APARTMENTS II SAN ANTONIO, TEXAS	
OWNER NRP Group LLC 200 Concord Plaza Drive, Suite 900 San Antonio, TX 78216 Mark Johnson P: 972.899.6140 <u>CIVIL ENGINEER</u>	
STRUCTURAL ENGINEER Lalonde Engineering Inc. 6617 Red Bud Road Fort Worth, Tx 76135 Phillippe Lalonde 817.307.8266 <u>MEP ENGINEER</u> Lwanda & Company, LLC 6136 Frisco Square Blvd. Suite 400 Frisco, TX 75034 Joe Nyanjom 469.287.5488	
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Drawn By: Author	
Checked By: Checker	
Sheet Title: BUILDING TYPE I - E ELEVATIONS	XTERIOR
Drawing No.	
A3.15	5





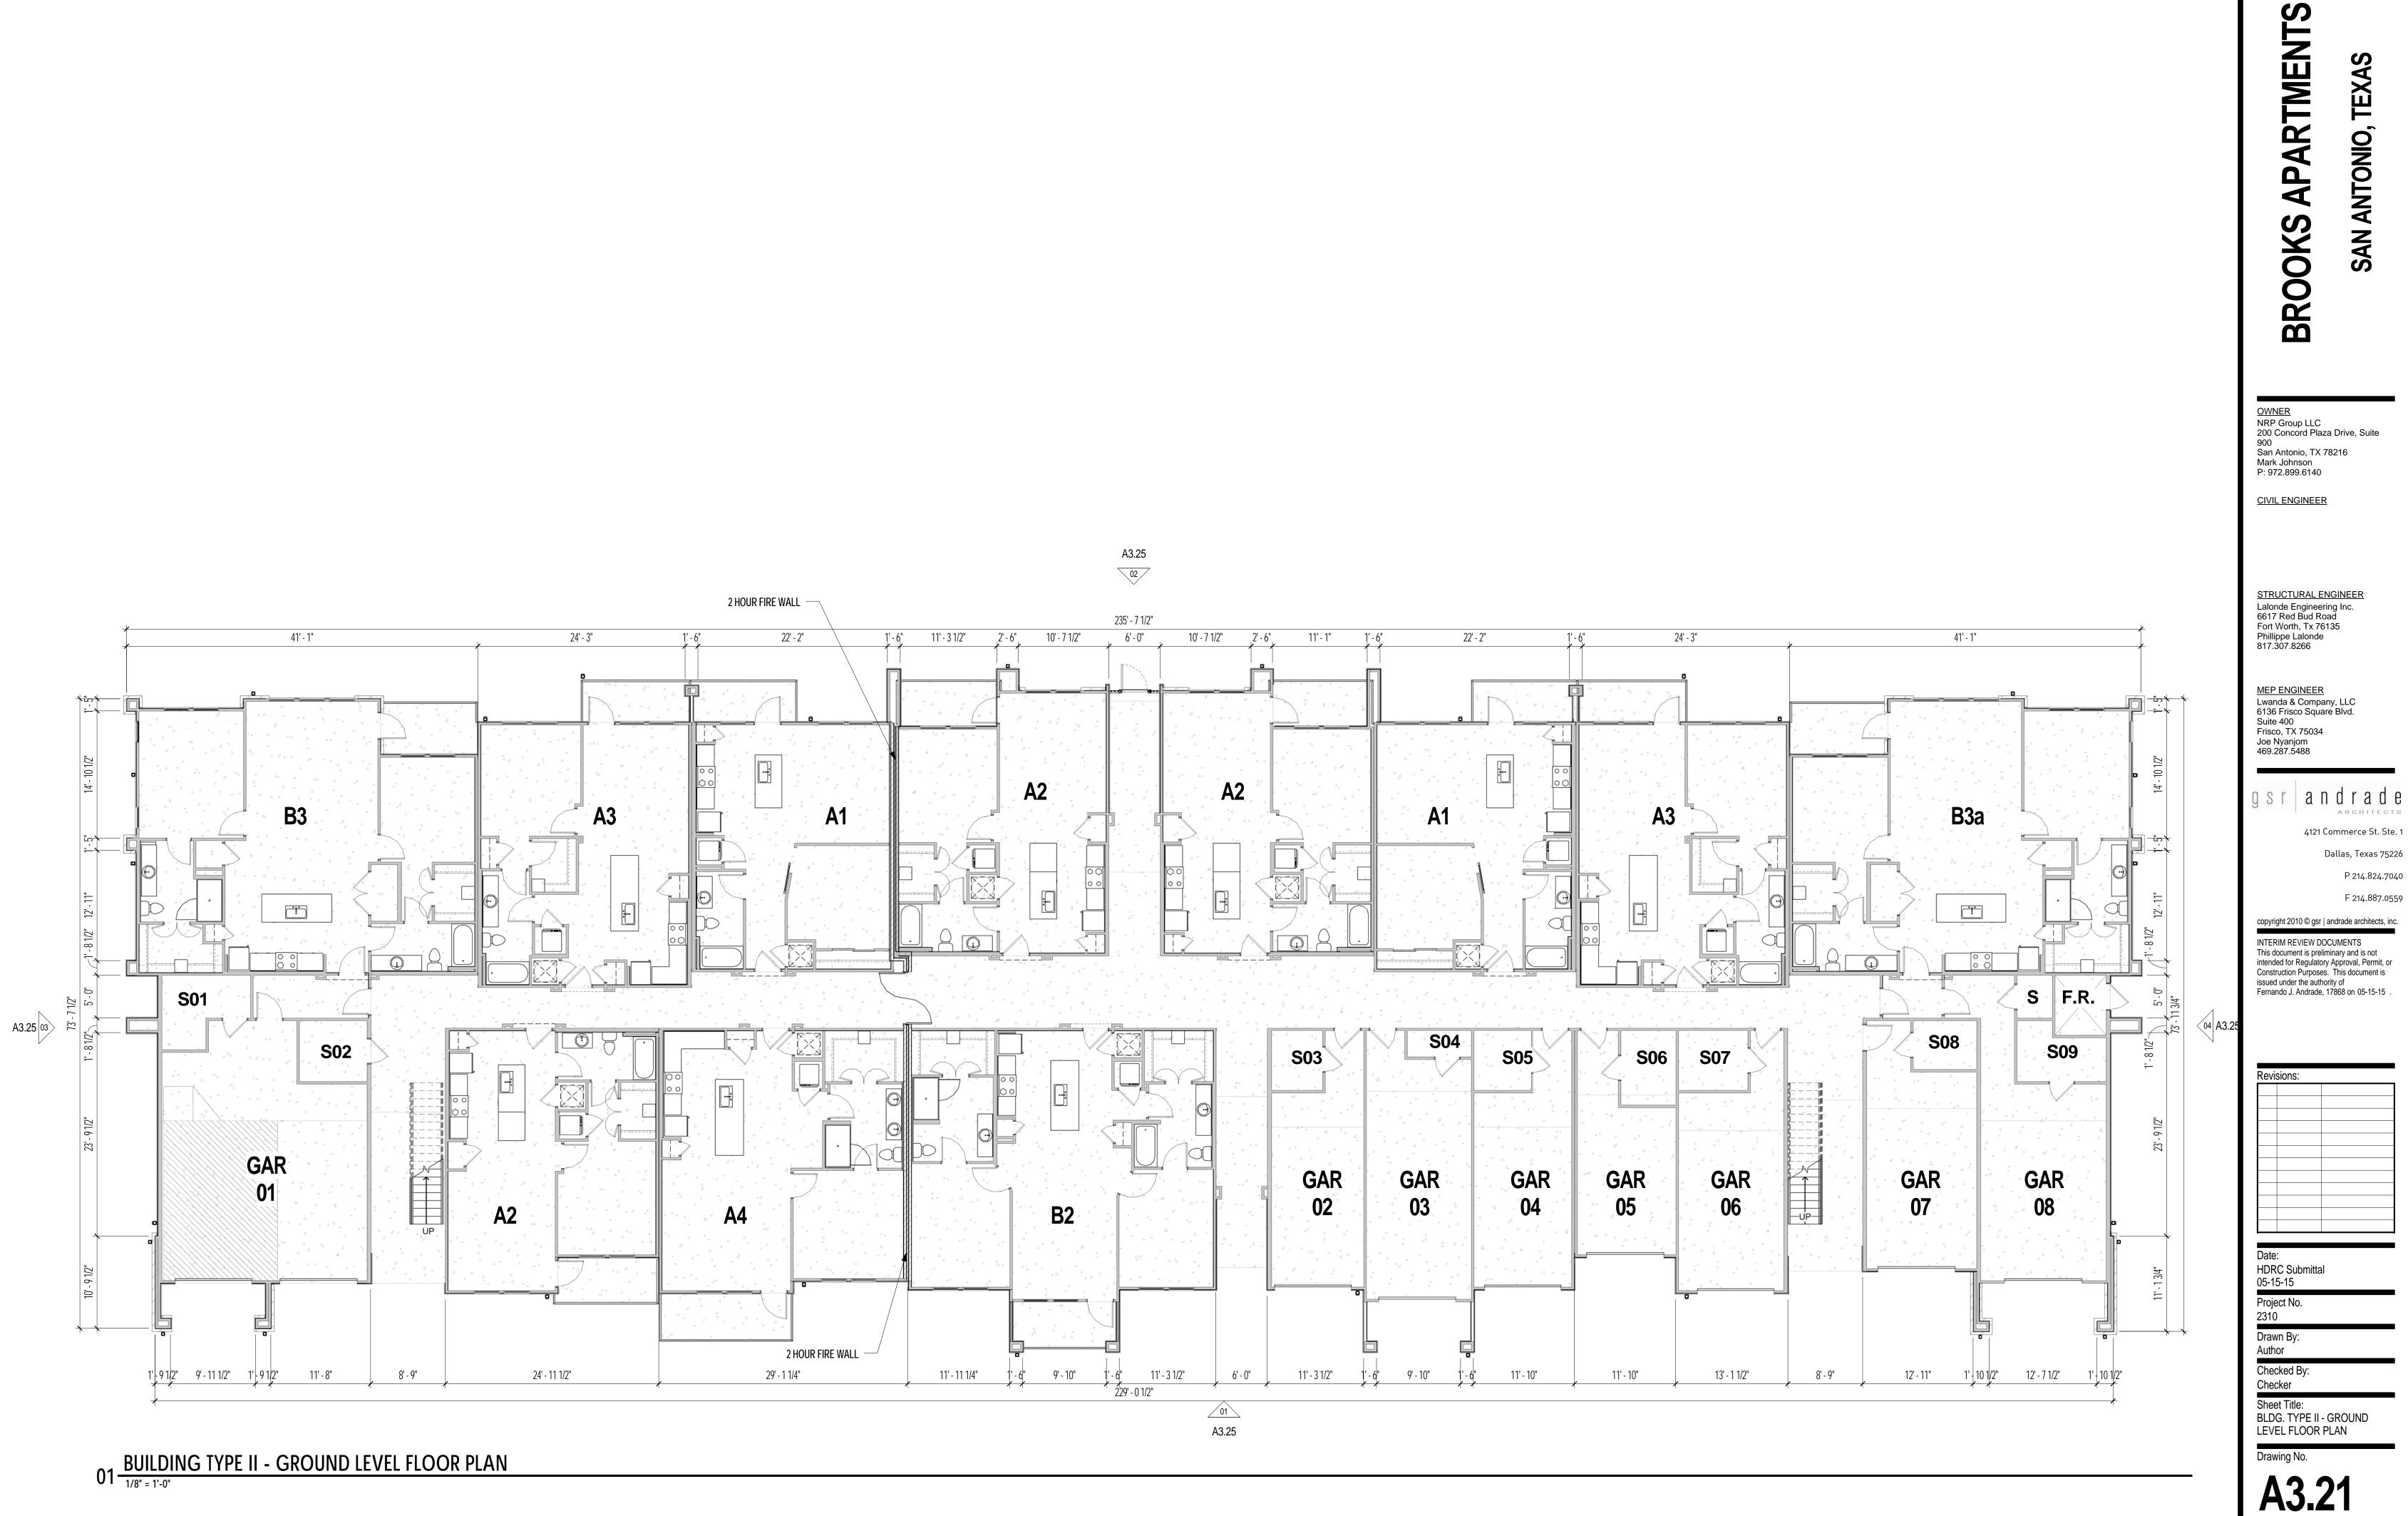

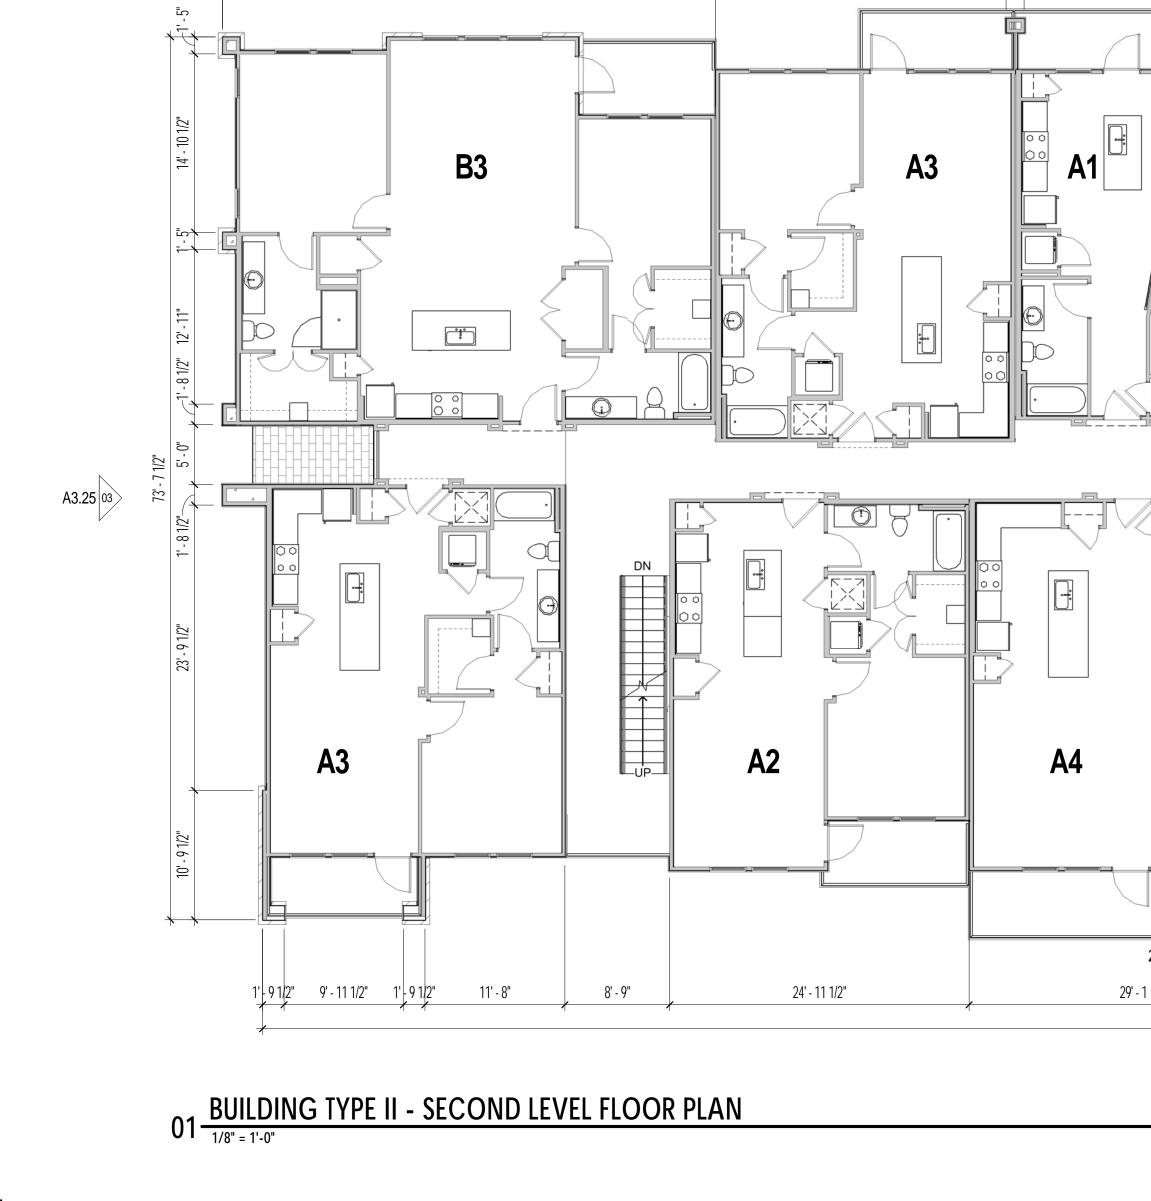41' - 1"

EXT. FACE OF STUD TO C.L. OF DEMISING


29' - 1 1/4"

22' - 2"

2 HOUR FIRE WALL

24' - 3"

C.L. OF DEMISING TO EXT FACE OF STUD

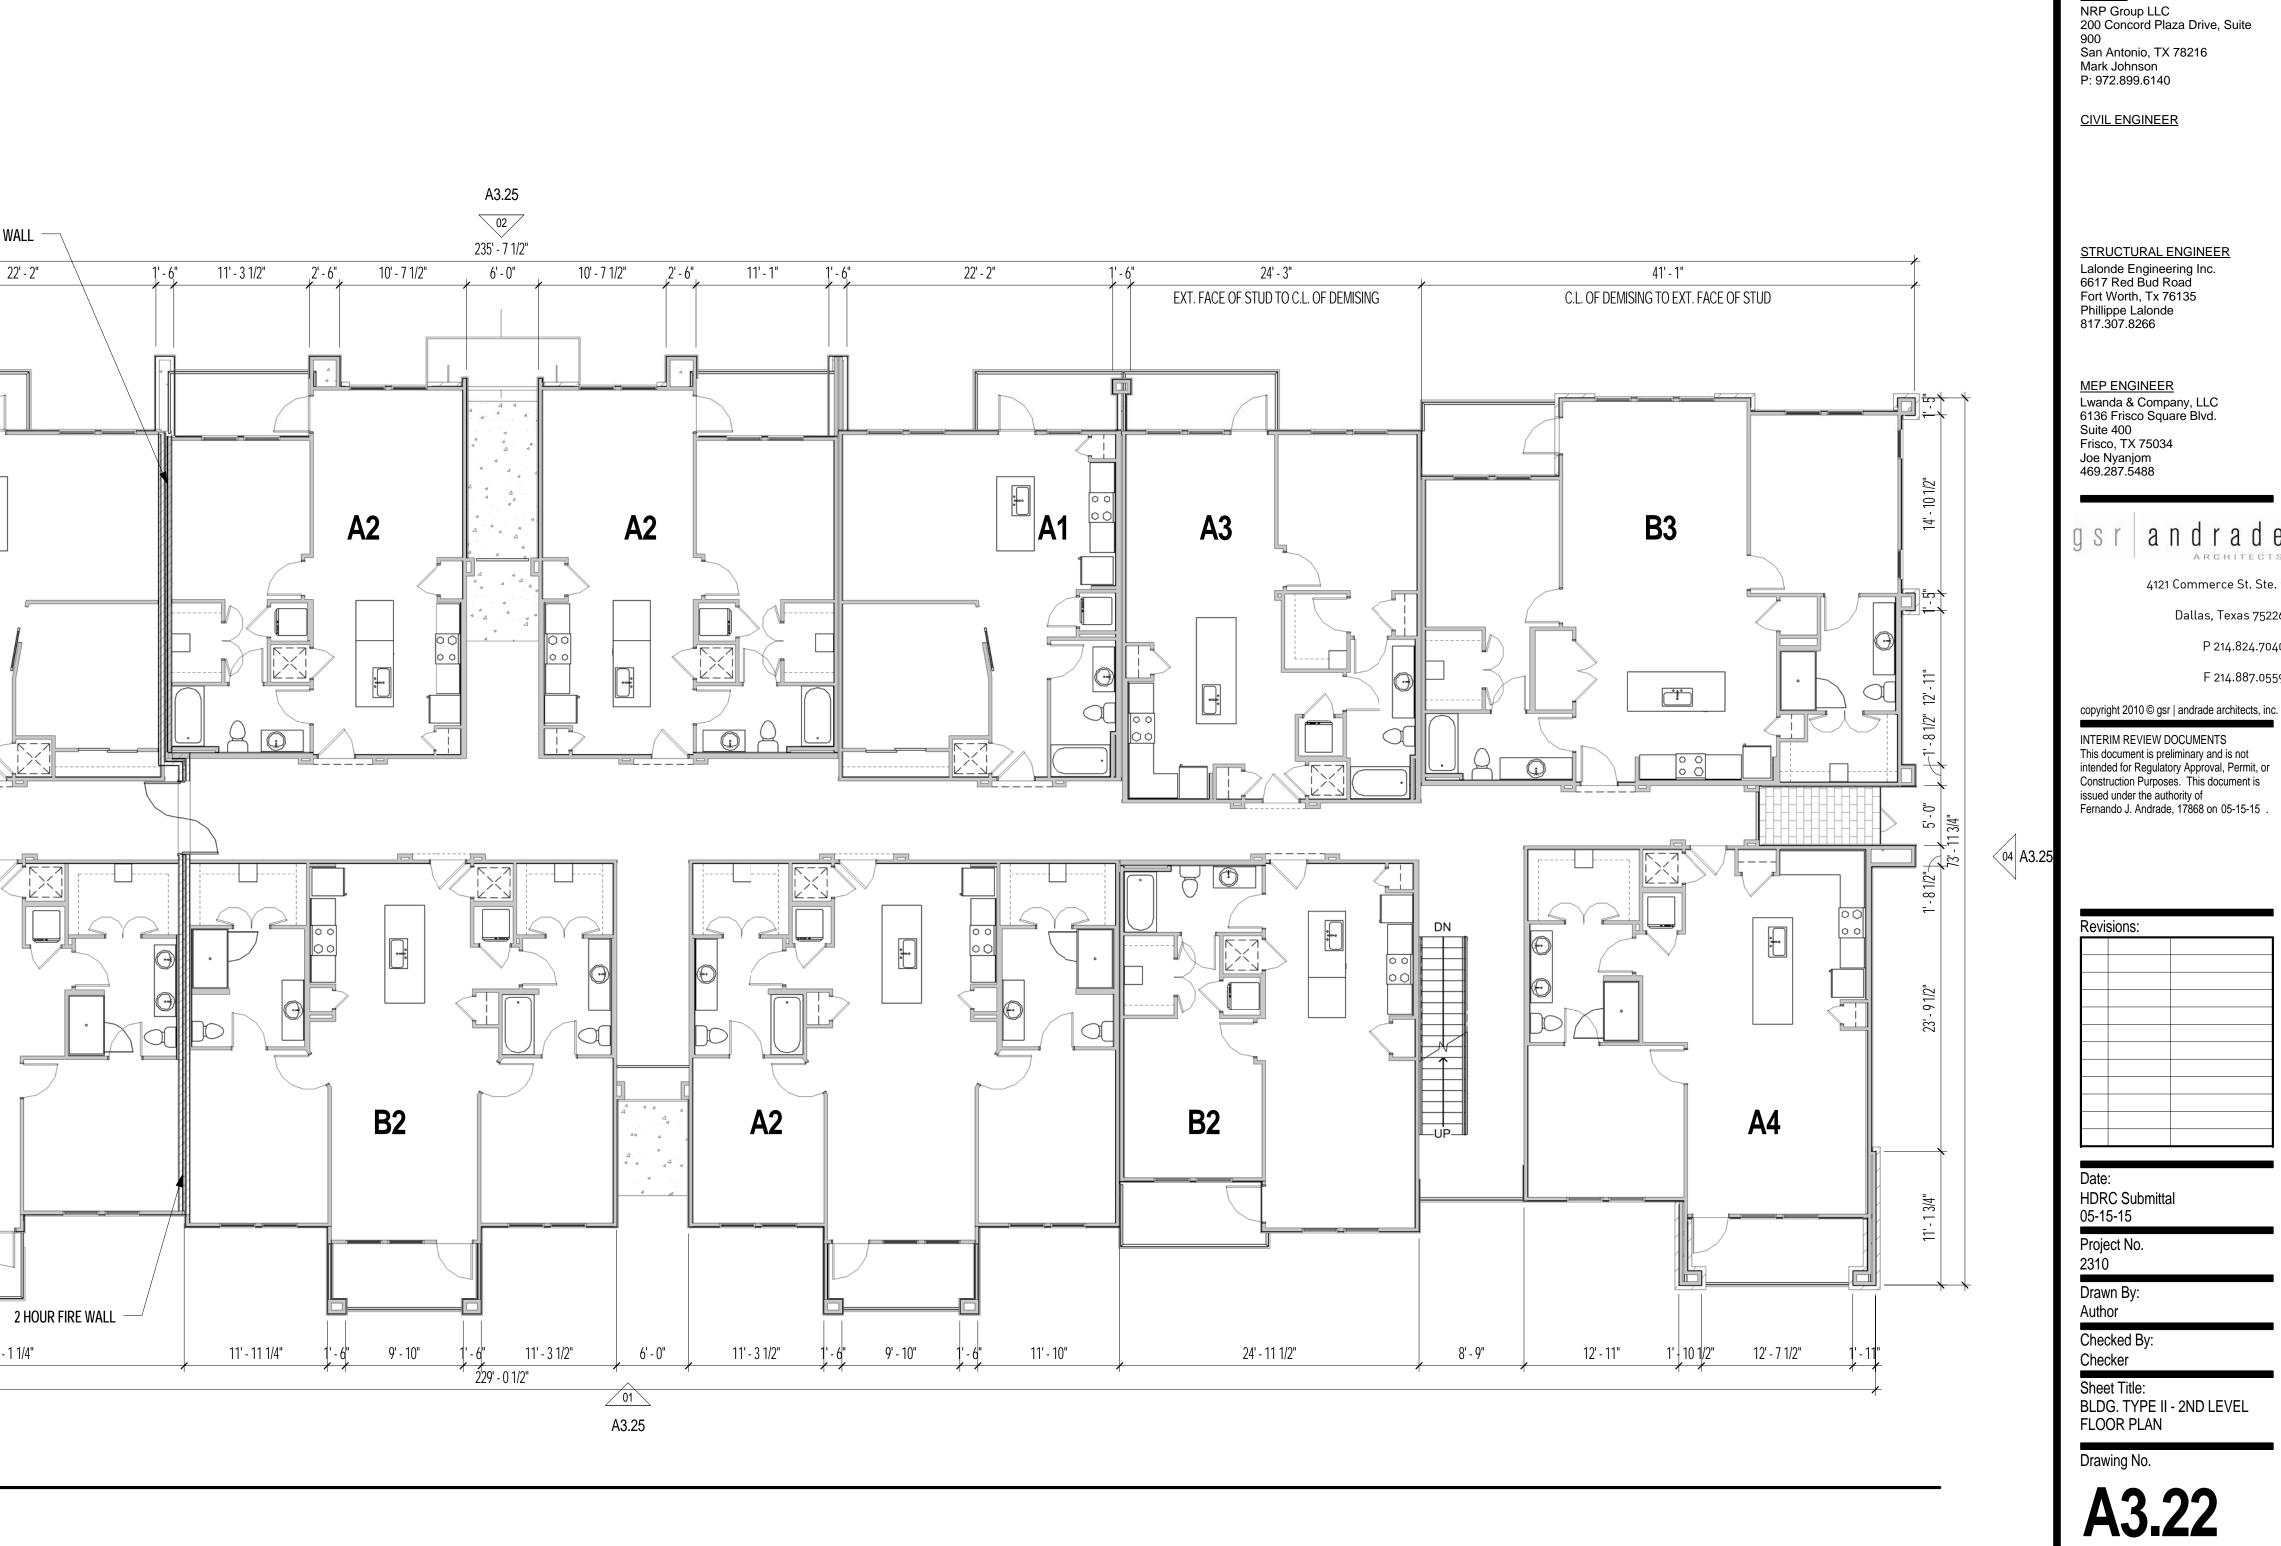

# **APARTMENTS** BROOKS

TEXAS

SAN ANTONIO,

## <u>OWNER</u>

## 4121 Commerce St. Ste. Dallas, Texas 75226 P 214.824.7040 F 214.887.0559

## 01 BUILDING TYPE II - THIRD LEVEL FLOOR PLAN




<b>BROOKS APARTMENTS</b>	SAN ANTONIO, TEXAS
OWNER NRP Group LLC 200 Concord Plaza 900 San Antonio, TX 78 Mark Johnson P: 972.899.6140	

## STRUCTURAL ENGINEER Lalonde Engineering Inc. 6617 Red Bud Road Fort Worth, Tx 76135 Phillippe Lalonde 817.307.8266 <u>MEP ENGINEER</u> Lwanda & Company, LLC 6136 Frisco Square Blvd. Suite 400 Frisco, TX 75034 Joe Nyanjom 469.287.5488 g s r a n d r a d e

CIVIL ENGINEER

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## ROOF PLAN GENERAL NOTES

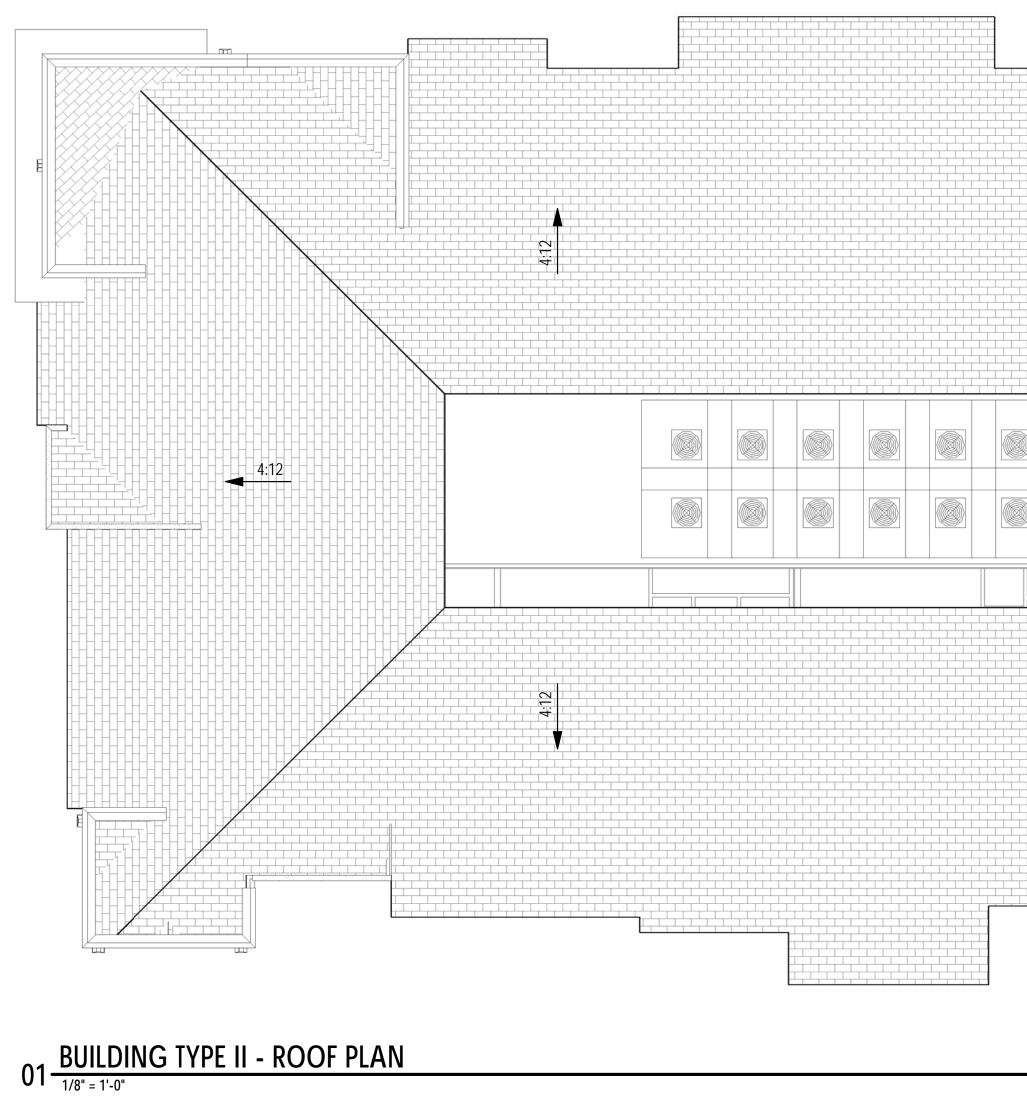- 1. DOWNSPOUT REQUIRED EVERY 25-0" OF GUTTER.
- 2. MIN. 3'-0"w X 5'-6"h MAINTENANCE ACCESS DOOR REQ'D @ MECH. WELLS.
- 3. ATTIC SPACES TO BE FULLY SPRINKLERED W/AUTOMATIC SPRINKLER SYSTEM IN
- ACCORDANCE WITH <u>NFPA 13R.</u> 4. SLOPE AT ALL TPO ROOFS IS 1/4" PER 1'-0" U.N.O.

5. ALL PLUMBING VENT PIPES TO BE PAINTED TO MATCH ROOFING.

## **ROOF PLAN LEGEND**

DRAFTSTOPS (MUST MEET REQ'T. SET FORTH IN 2012 IBC SECTION 718.4)


SOFFIT VENT

Line of Building Below

LOW PROFILE ROOF VENT (70 SQ. IN. NET FREE AREA PER VENT)

RIDGE VENT (18 SQ. IN. NET FREE AREA PER LINEAR FT.)


4" X 6" PRE-FINISHED METAL DOWNSPOUT

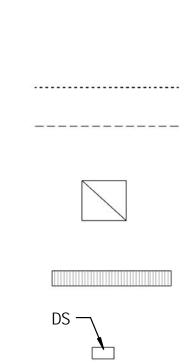


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ASPHALT ROOF SHINGLE (MIN. 4:12 SLOPE)		MECH. EQUIP. PER MEP
	(MIN. 1/4" : 1'-0" SLOPE)	DRAWINGS

m



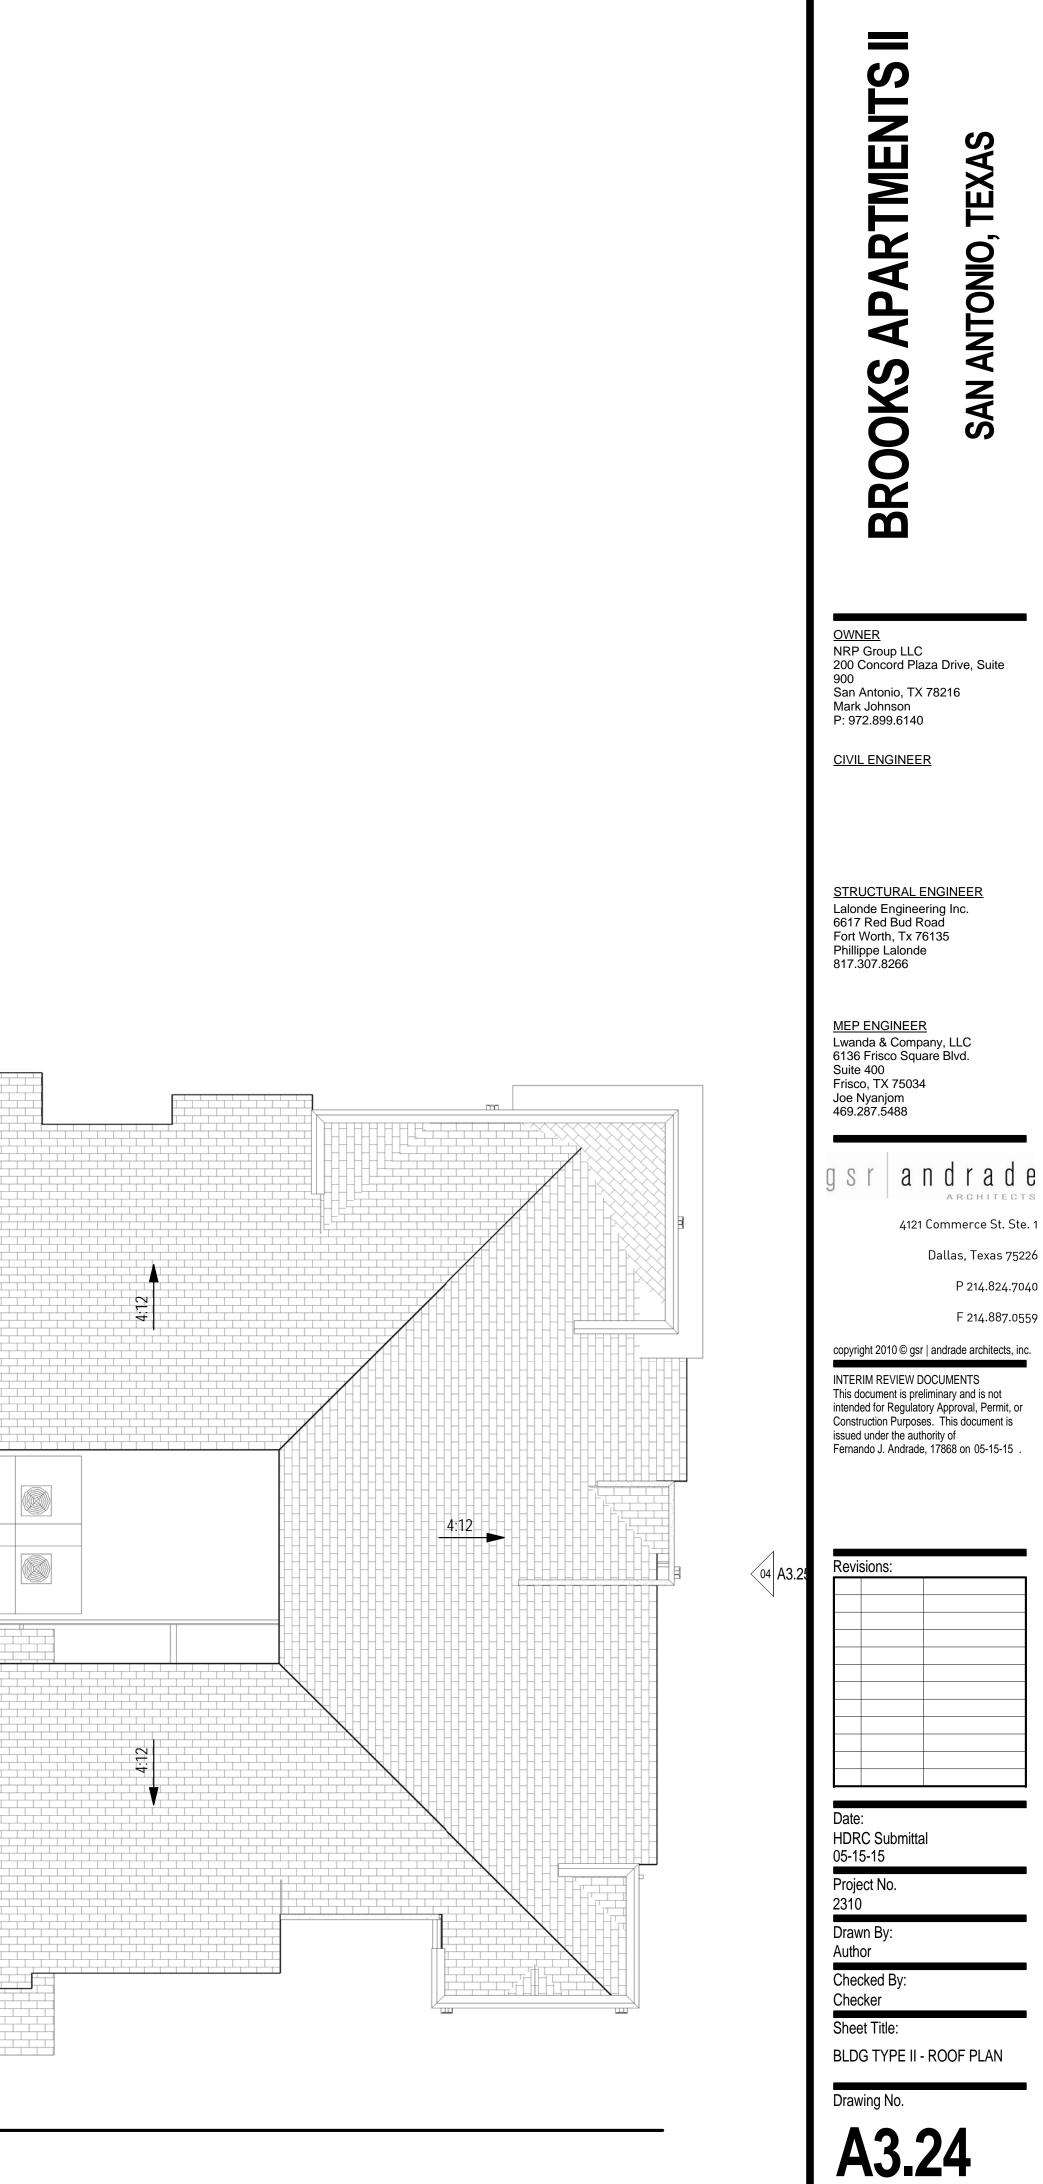
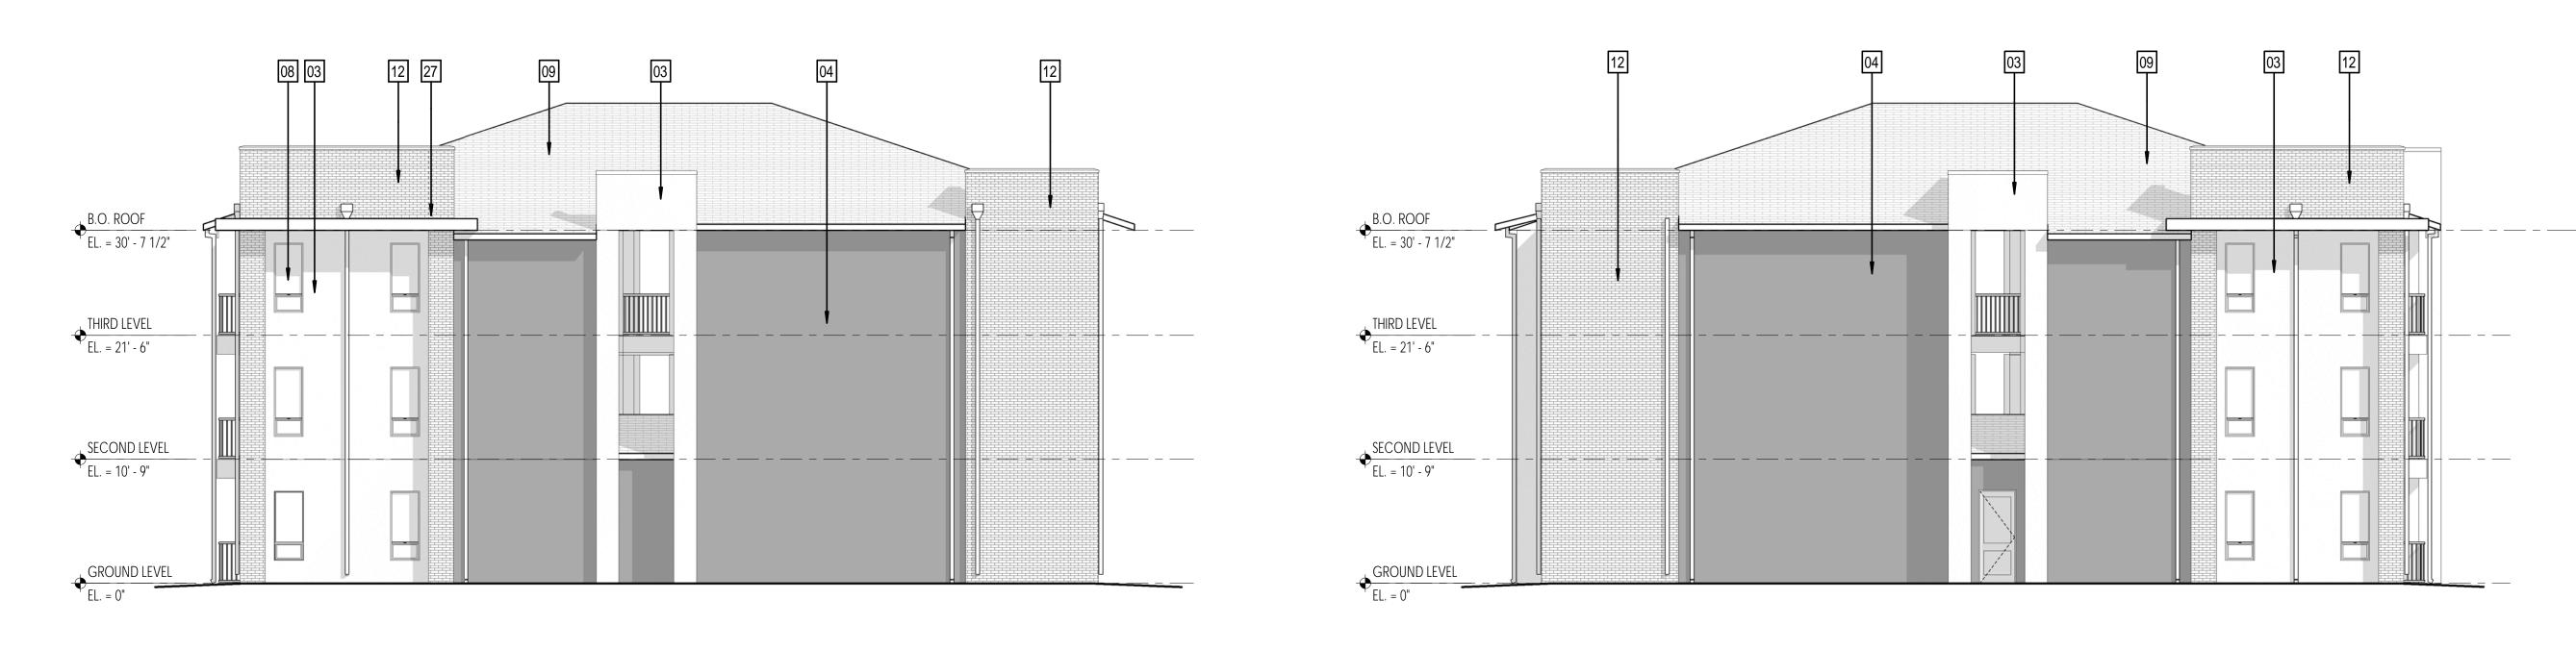
# 03 BUILDING TYPE II - EXTERIOR ELEVATION (RIGHT)




# 02 BUILDING TYPE II - EXTERIOR ELEVATION (FRONT/STREET)



# 04 BUILDING TYPE II - EXTERIOR ELEVATION (LEFT)

	02 (STREET)	
03 (RIGHT)	TYP. FLR. PLAN	
C	01 (GARAGE)	
	KEY PLAN	
	KEYNOTE LEGEND	
#	EXTERIOR MATERIAL	
03 STUCCO FINISH 'A'		
04	STUCCO FINISH 'B'	
05	SMOOTH STUCCO FINISH	
08	ALUM. WINDOW PER PLAN W/CLEAR ANODIZED FINISH	
09	ASPHALT COMPOSITION ROOFING (REF. ROOF PLAN FOR SLOPE)	
11	METAL GUARDRAIL (PTD.) - MIN. 42" A.F.F.	
12	MODULAR BRICK	
16	GARAGE DOOR PER PLAN (PTD. FINISH 'A')	
17		
27	CANOPY W/STUCCO FINISH @ FASCIA	

**BROOKS APARTMENTS** SAN ANTONIO, TEXAS <u>OWNER</u> NRP Group LLC 200 Concord Plaza Drive, Suite 900 San Antonio, TX 78216 Mark Johnson P: 972.899.6140 CIVIL ENGINEER STRUCTURAL ENGINEER Lalonde Engineering Inc. 6617 Red Bud Road Fort Worth, Tx 76135 Divisional Journals Phillippe Lalonde 817.307.8266 MEP ENGINEER Lwanda & Company, LLC 6136 Frisco Square Blvd. Suite 400 \_\_\_\_Frisco, TX 75034 Joe Nyanjom 469.287.5488 gsr andrad ARCHITEC 4121 Commerce St. Ste. 1 Dallas, Texas 75226 P 214.824.7040 F 214.887.0559 copyright 2010  $\ensuremath{\mathbb{C}}$  gsr | and rade architects, inc. INTERIM REVIEW DOCUMENTS This document is preliminary and is not intended for Regulatory Approval, Permit, or Construction Purposes. This document is issued under the authority of Fernando J. Andrade, 17868 on 05-15-15.

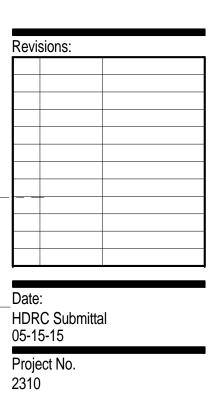


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Drawing No.




00 (STDEET)

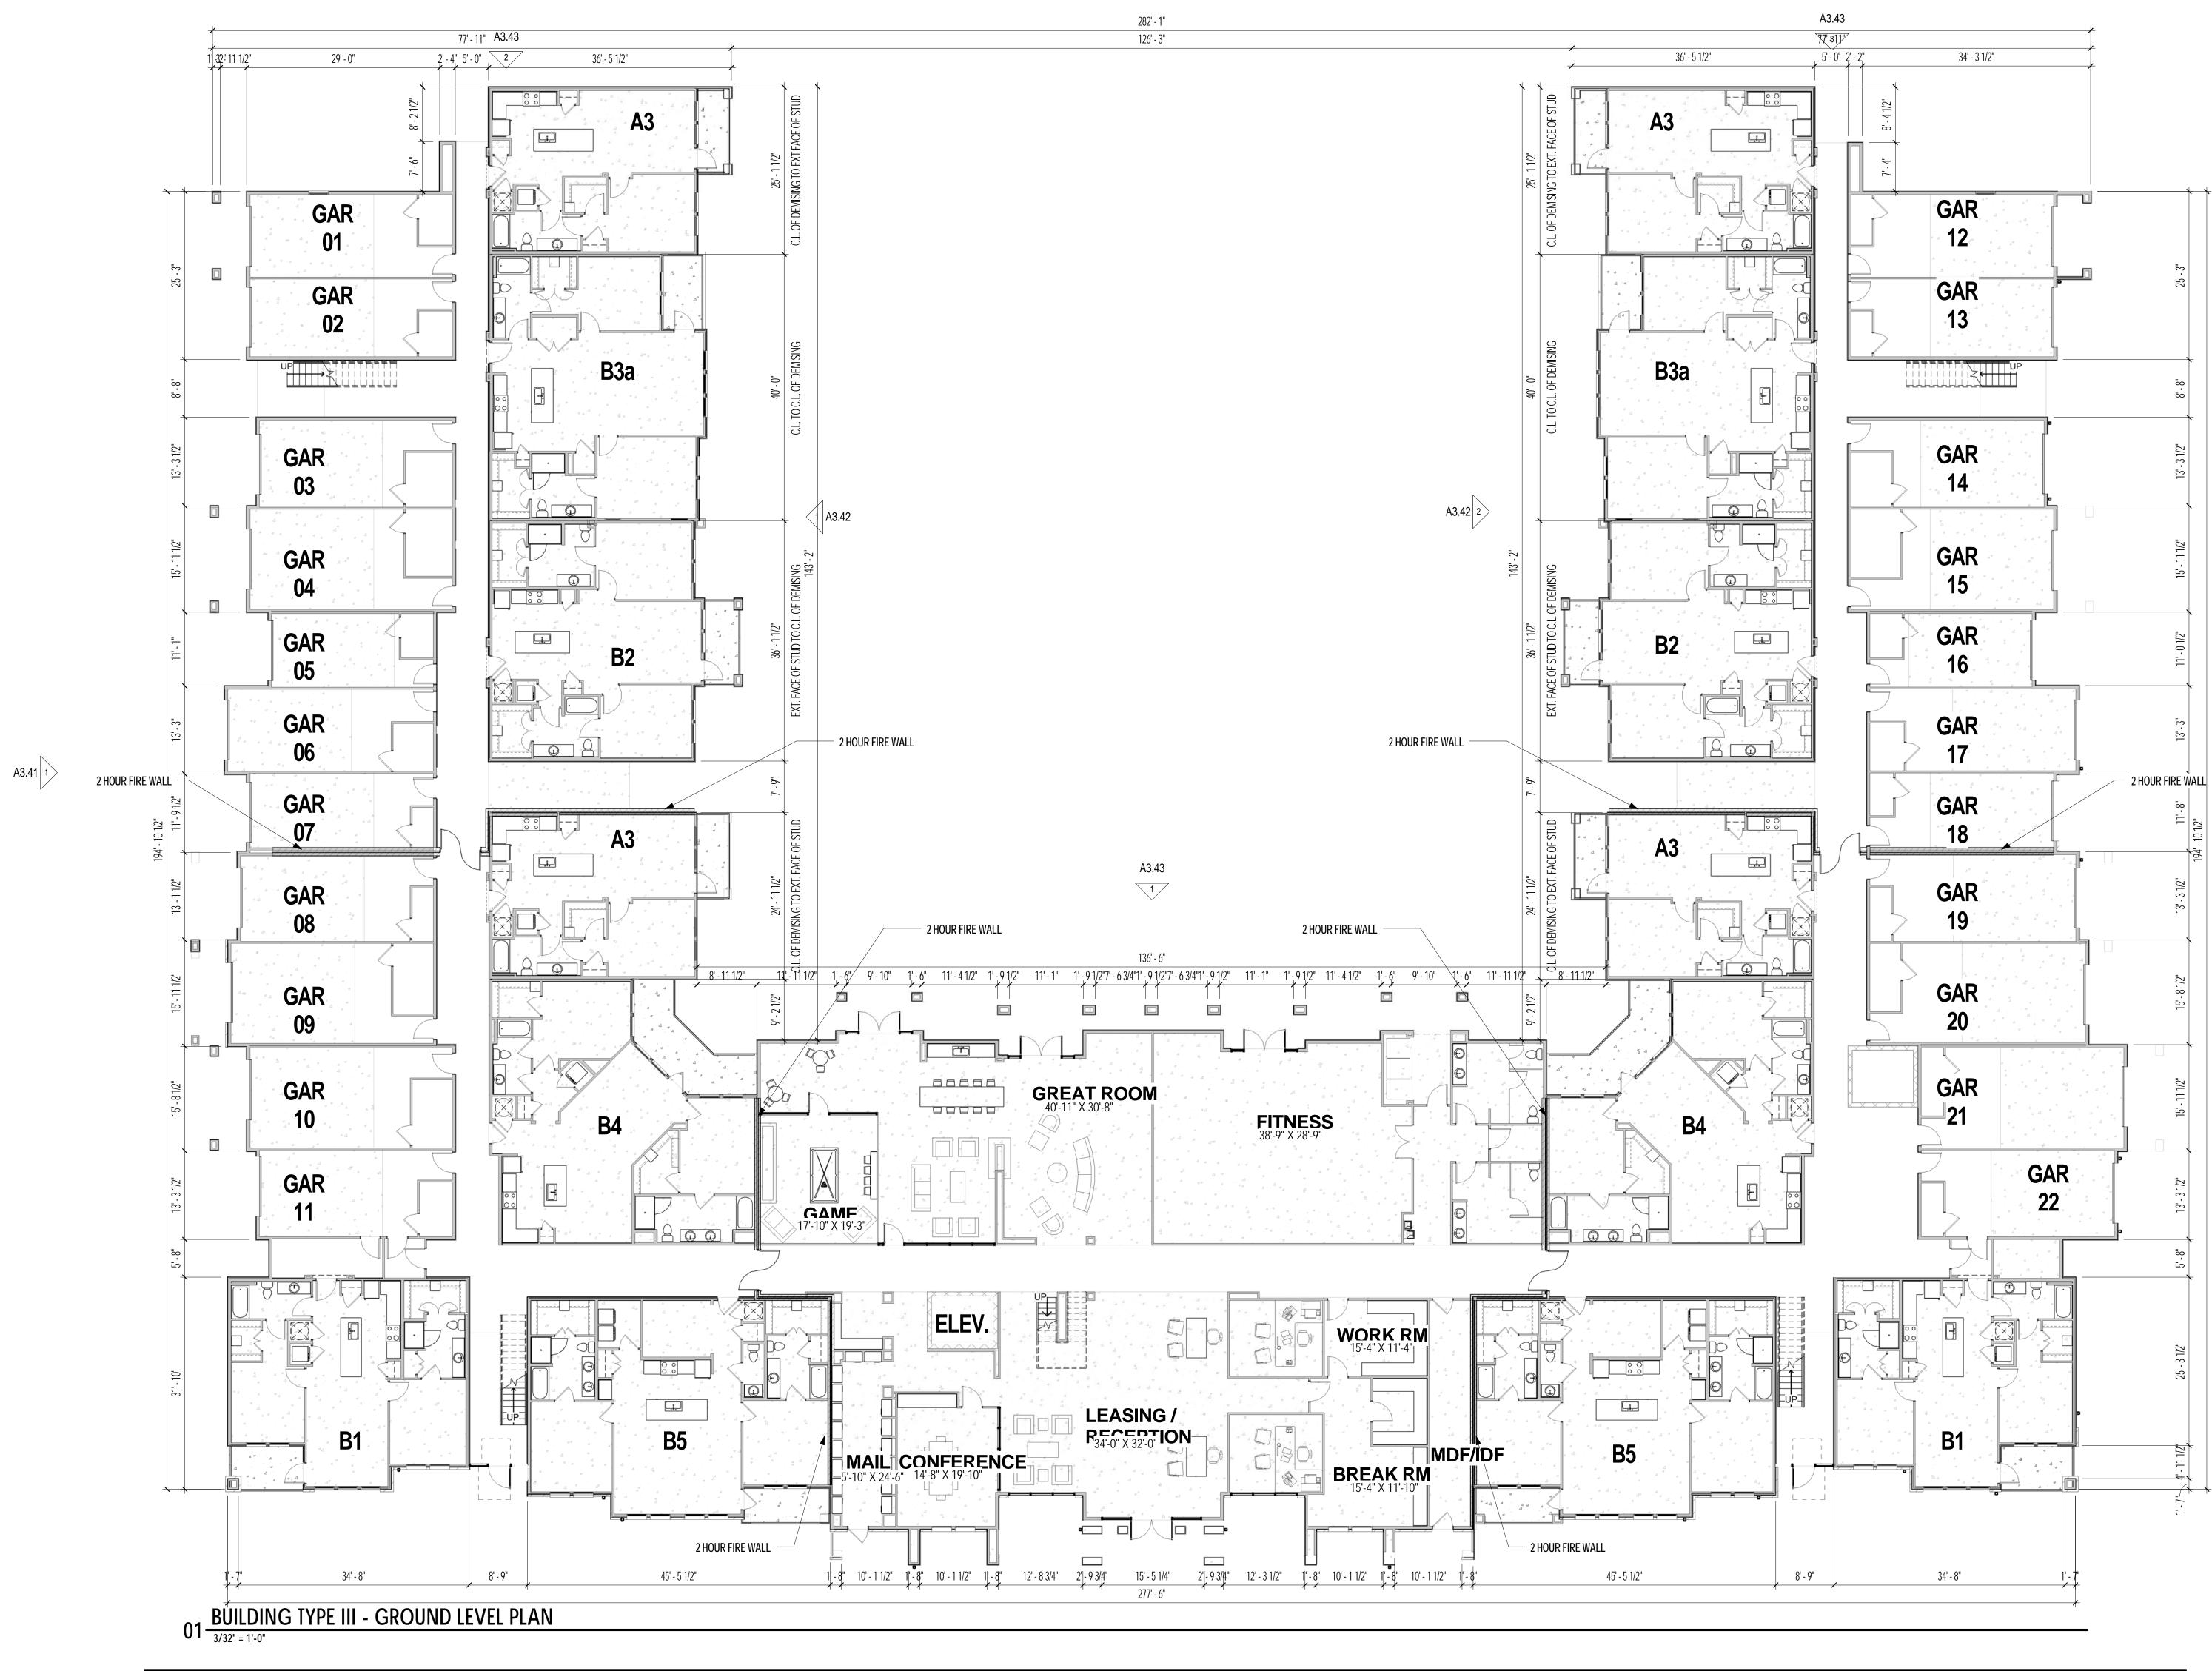

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OWNER NRP Group LLC 200 Concord Pla 900 San Antonio, TX Mark Johnson P: 972.899.6140 CIVIL ENGINEE	78216
STRUCTURAL E Lalonde Enginee 6617 Red Bud R Fort Worth, Tx 7 Phillippe Lalonde 817.307.8266 <u>MEP ENGINEEF</u> Lwanda & Comp 6136 Frisco Squ Suite 400 Frisco, TX 75034 Joe Nyanjom	ering Inc. oad 6135 ∋ <u>≷</u> any, LLC are Blvd.
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Date: HDRC Submitta 05-15-15 Project No. 2310 Drawn By: Author Checked By: Checker	3
Sheet Title: BLDG. TYPE III GROUND LEVE Drawing No.	


A3.31

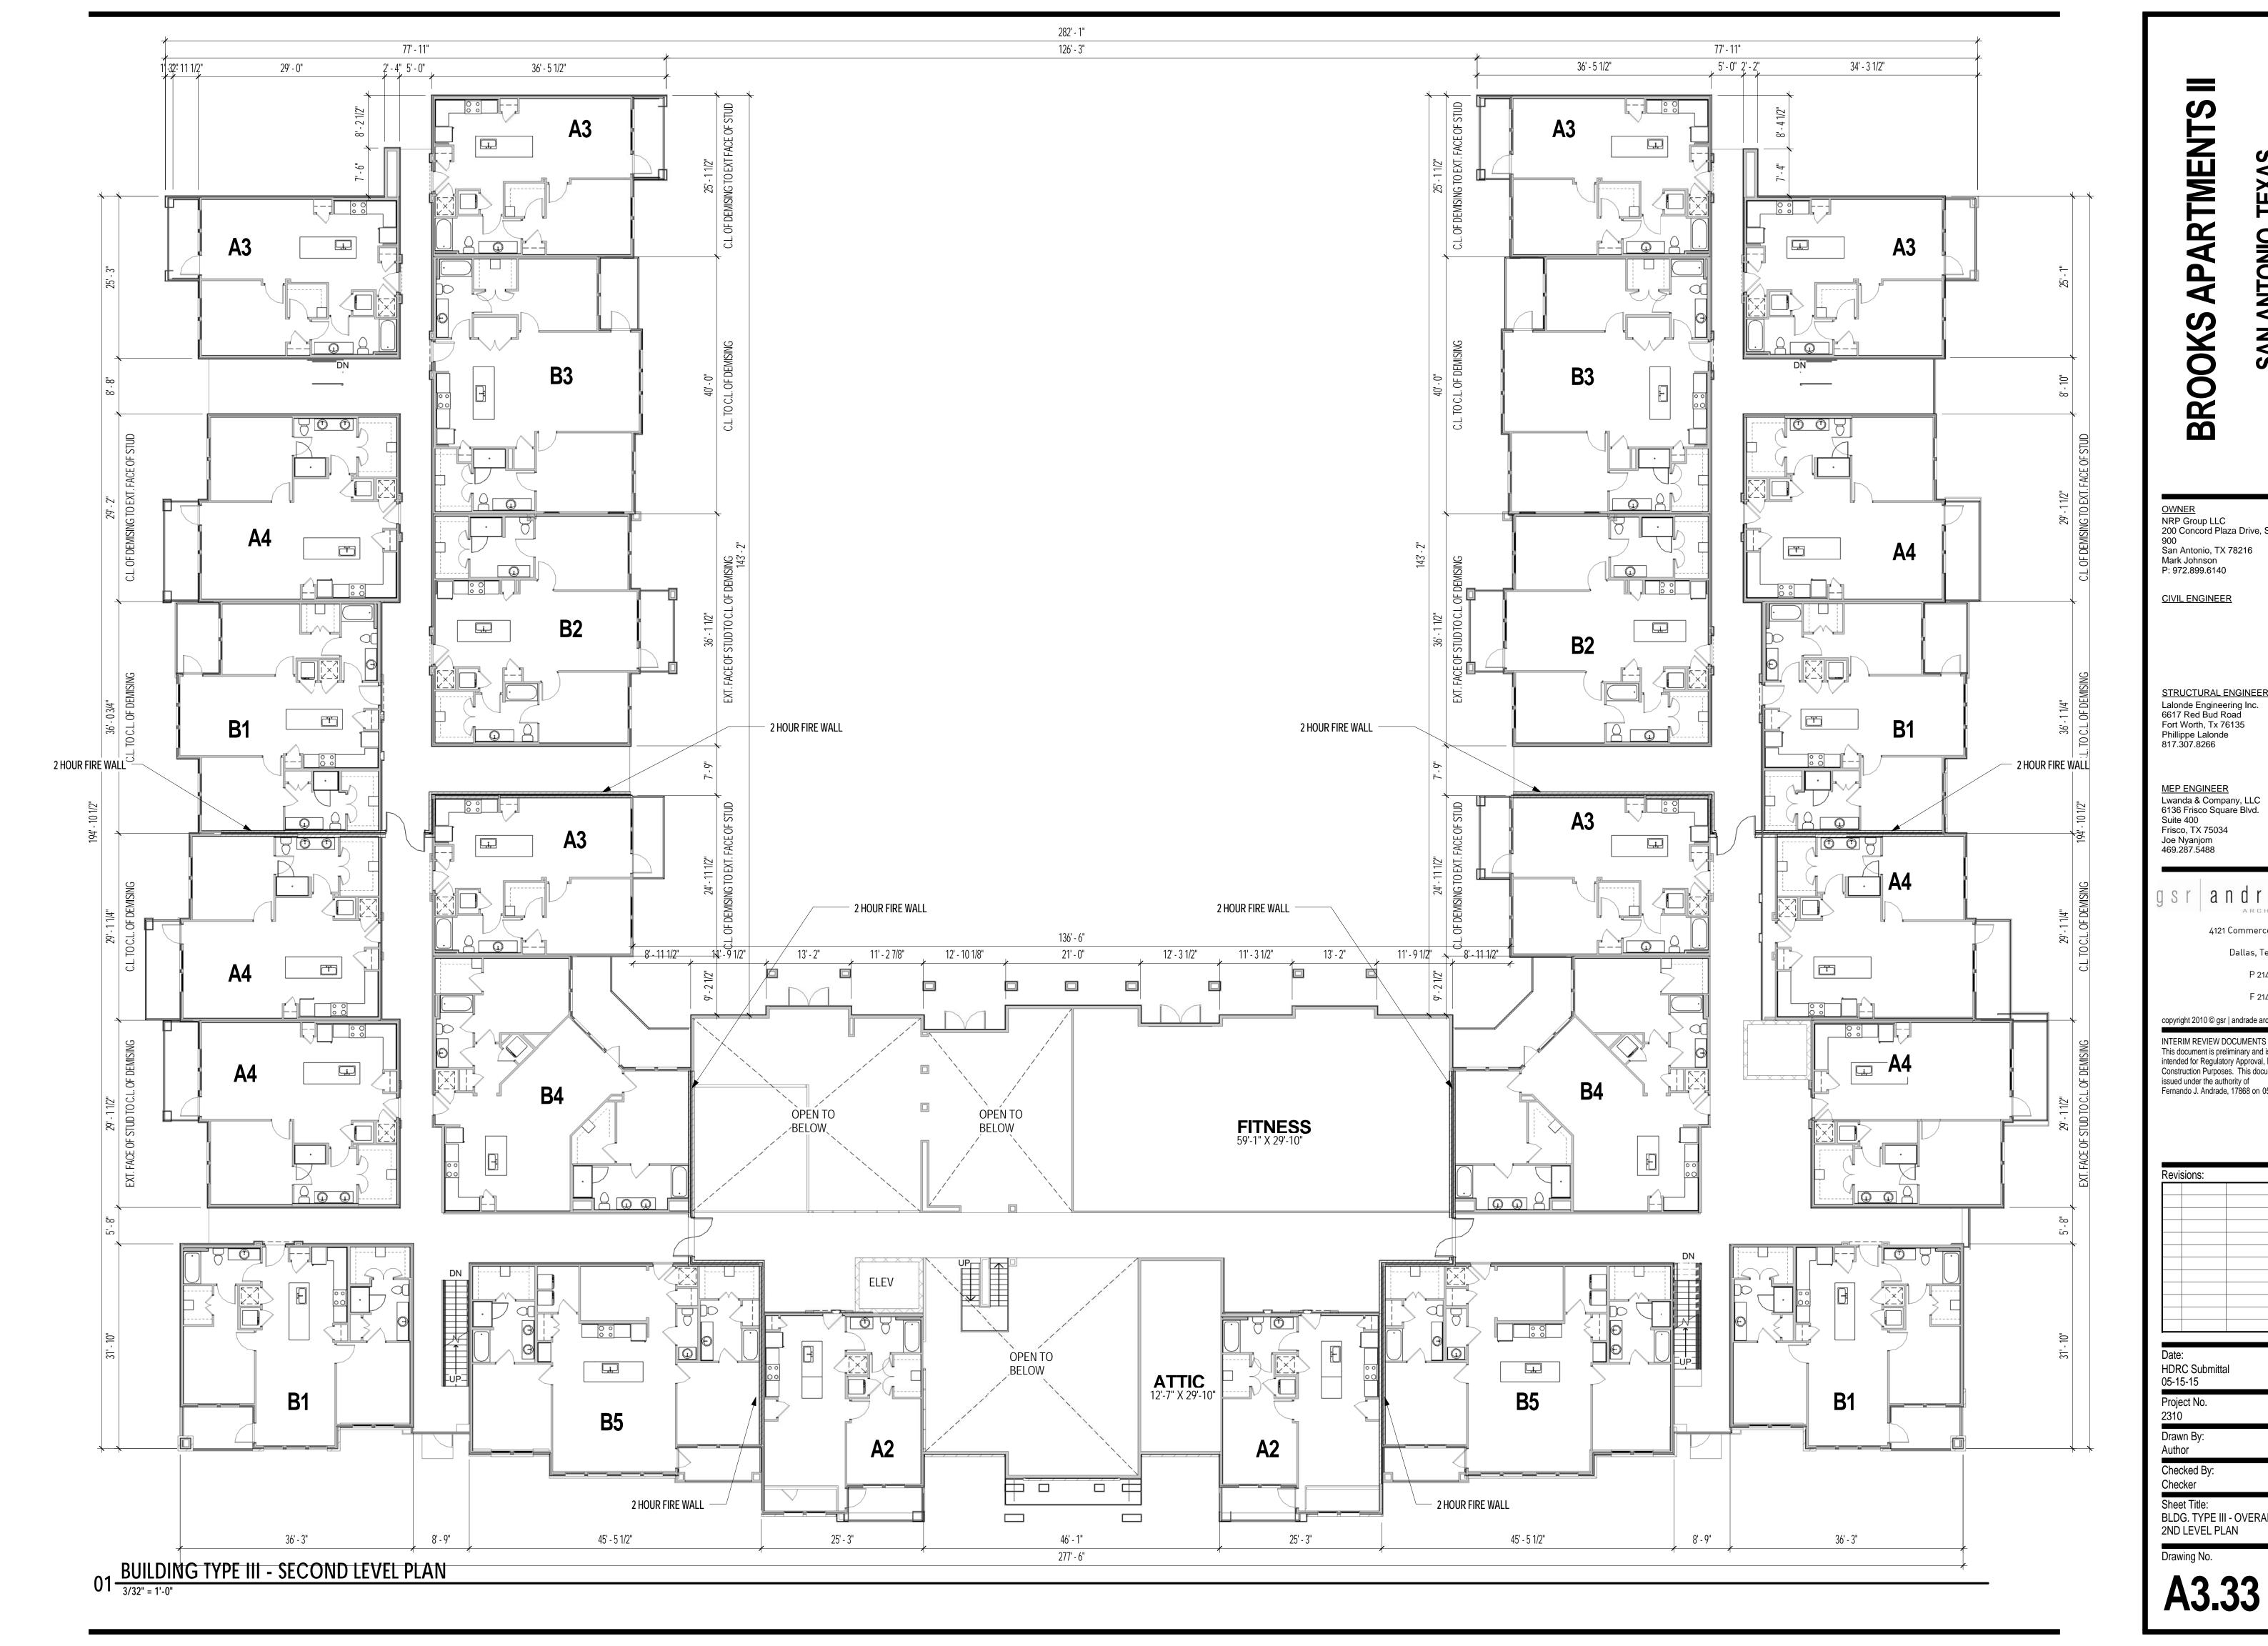



Checked By: Checker Sheet Title:

BLDG. TYPE III - OVERALL 2ND LEVEL PLAN

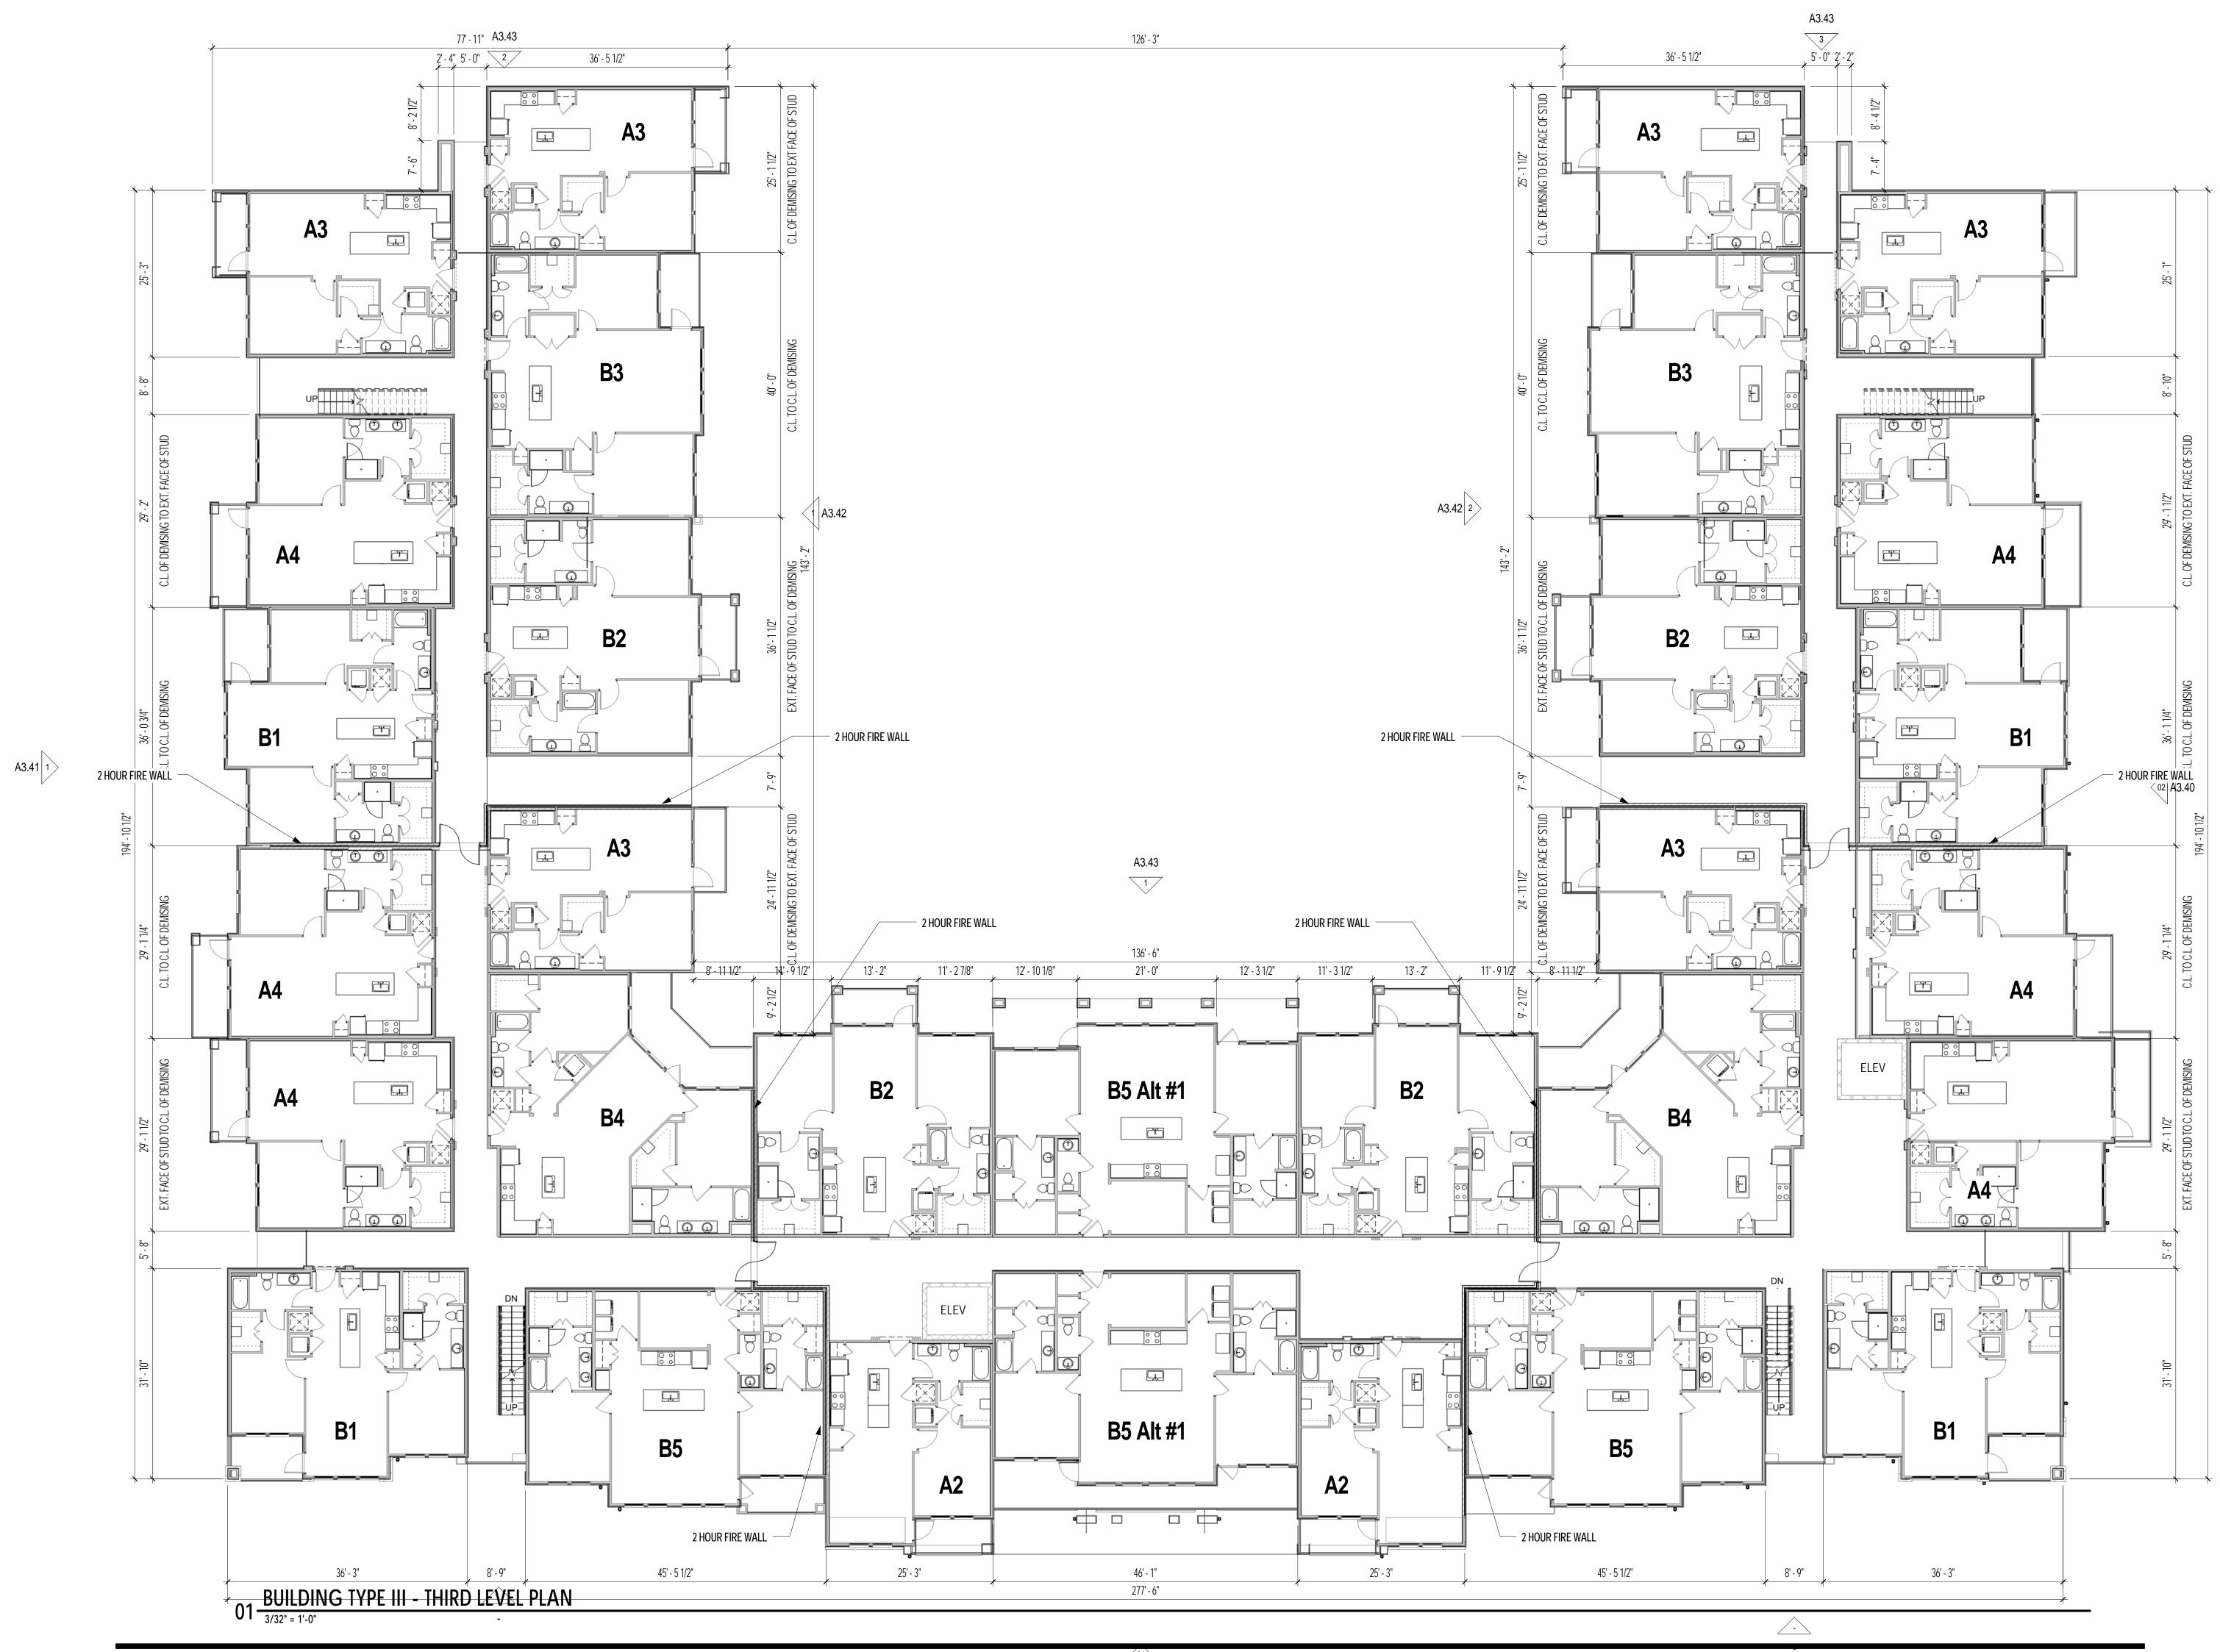






BLDG. TYPE III - OVERALL 3RD LEVEL PLAN

Author Checked By:

Checker Sheet Title:

A3.35

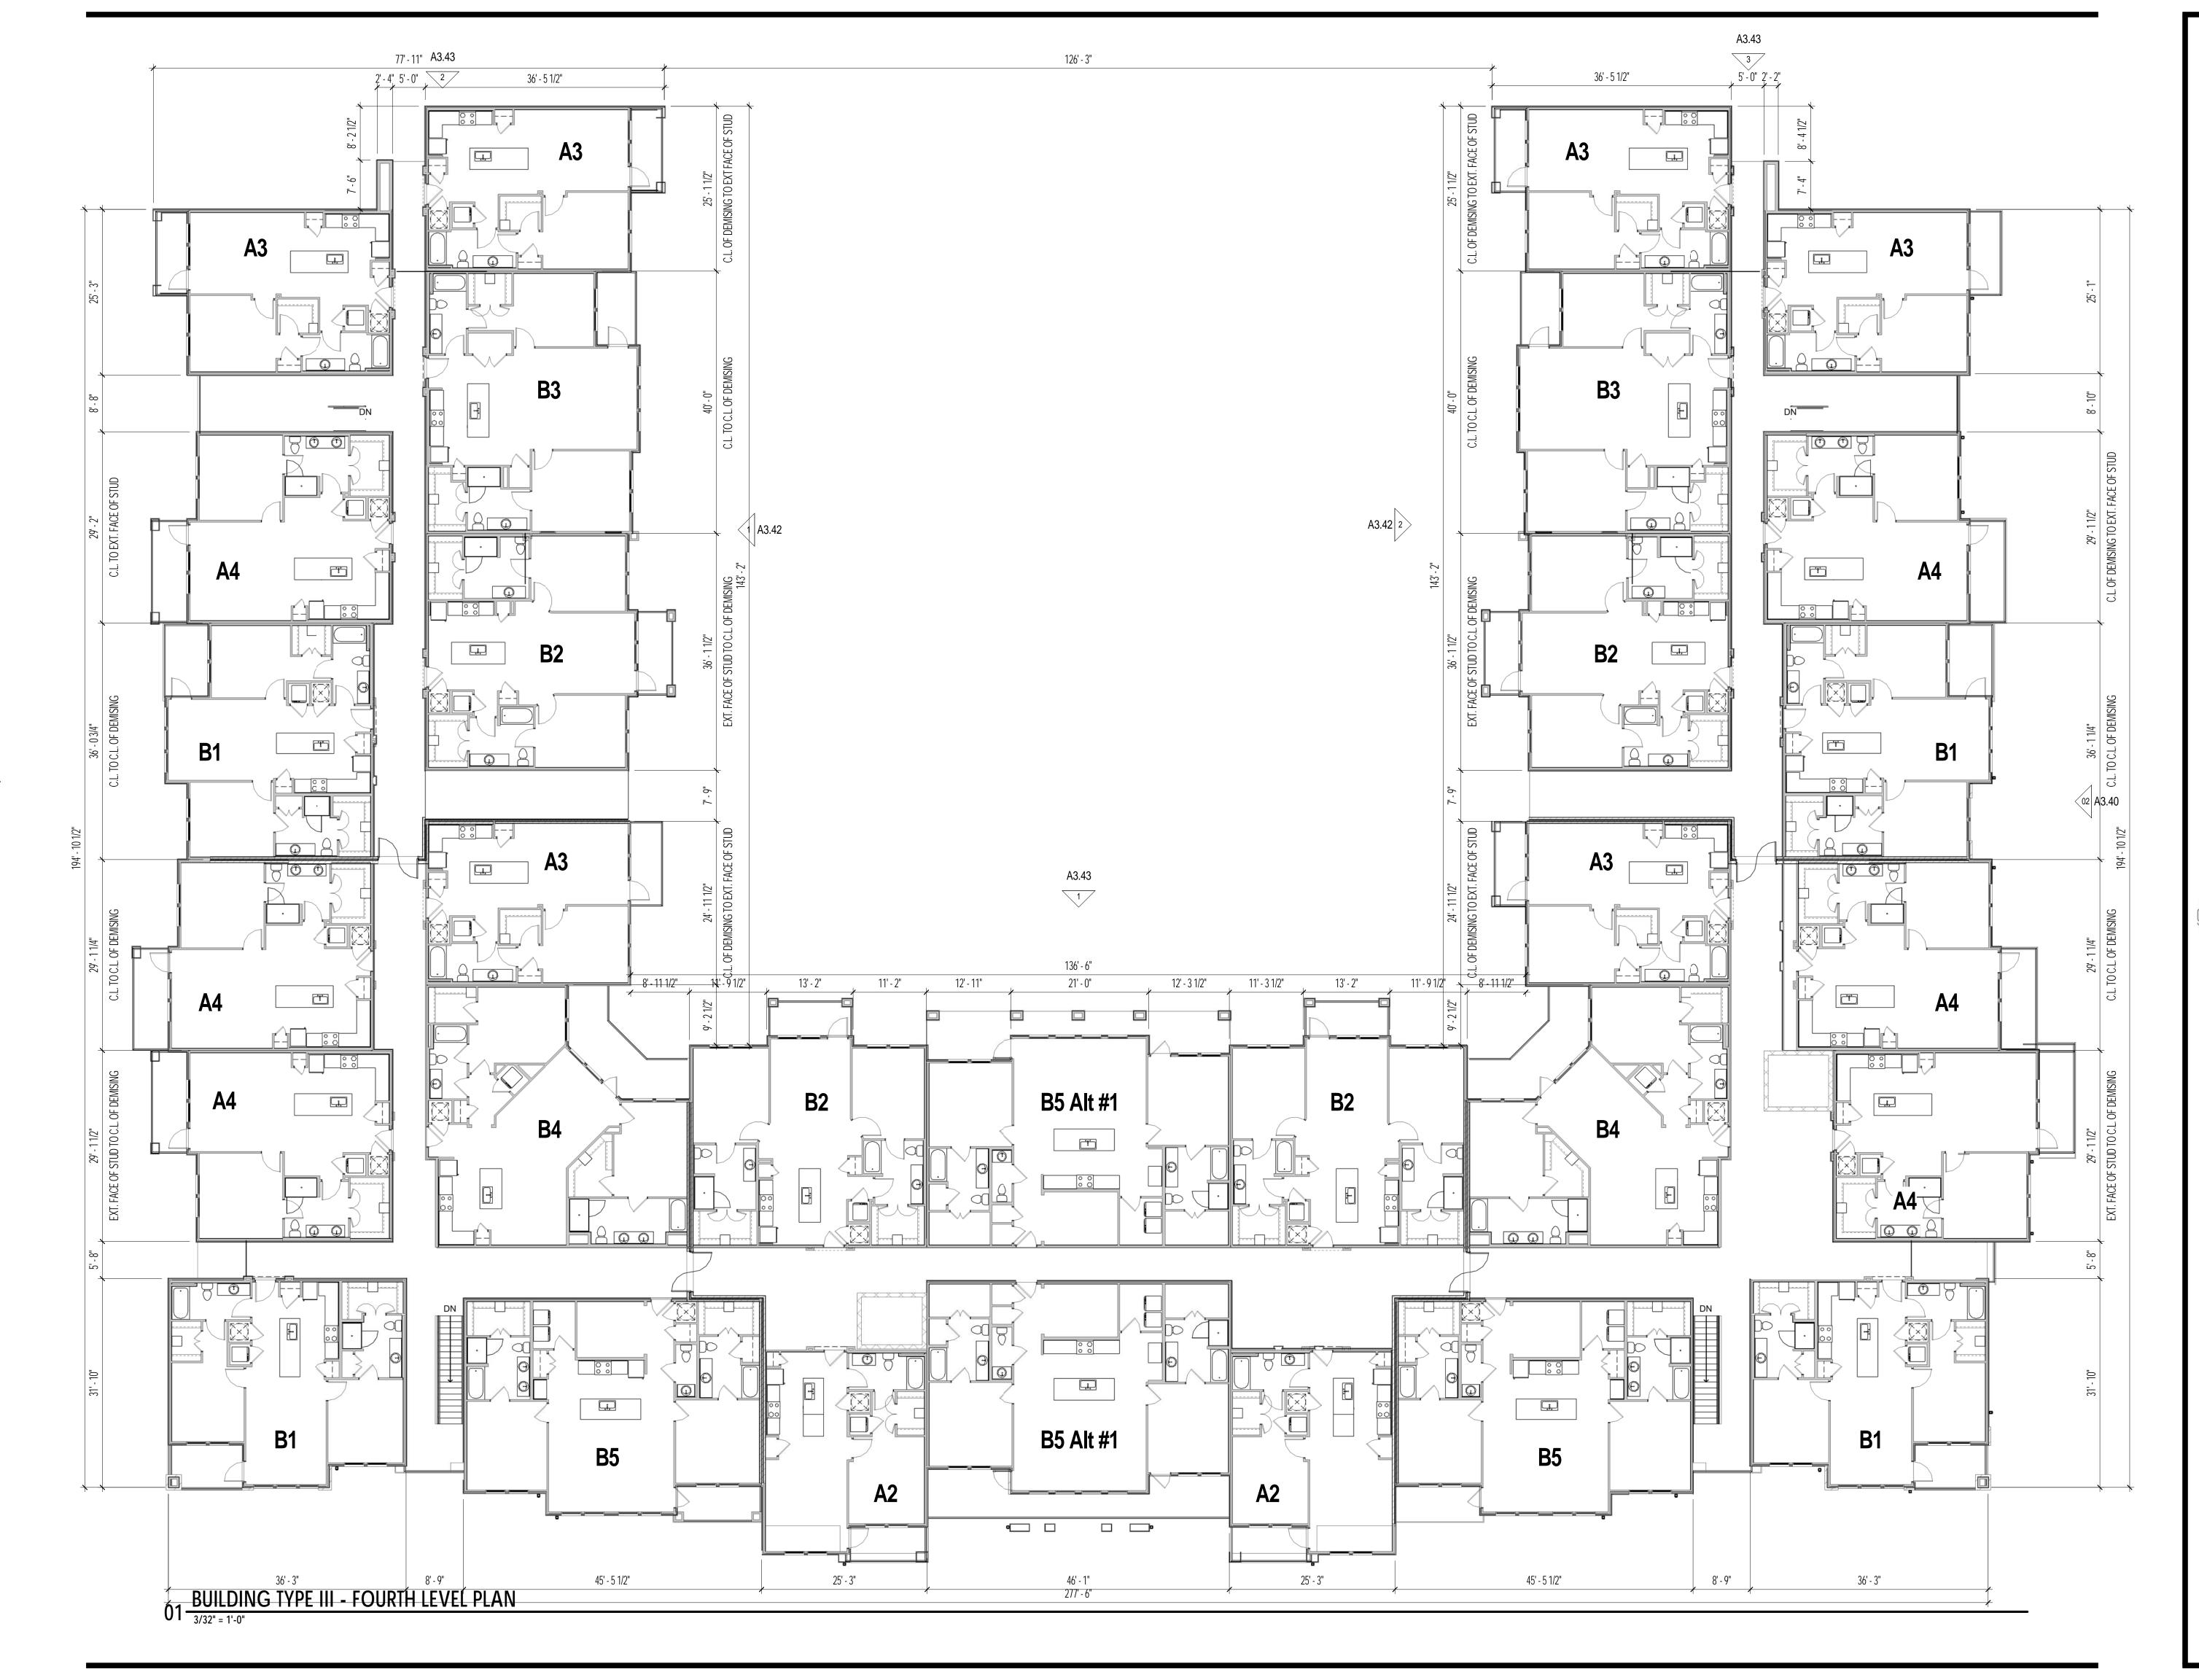


A3.41

**ARTMENTS** TEXAS SAN ANTONIO, AP BROOKS <u>OWNER</u> NRP Group LLC 200 Concord Plaza Drive, Suite 900 San Antonio, TX 78216 Mark Johnson P: 972.899.6140 CIVIL ENGINEER STRUCTURAL ENGINEER Lalonde Engineering Inc. 6617 Red Bud Road Fort Worth, Tx 76135 Phillippe Lalonde 817.307.8266 MEP ENGINEER Lwanda & Company, LLC 6136 Frisco Square Blvd. Suite 400 Frisco, TX 75034 Joe Nyanjom 469.287.5488 gsr andrade ARCHITECT 4121 Commerce St. Ste. Dallas, Texas 75226 P 214.824.7040 F 214.887.0559 copyright 2010 © gsr | andrade architects, inc. INTERIM REVIEW DOCUMENTS This document is preliminary and is not intended for Regulatory Approval, Permit, or Construction Purposes. This document is issued under the authority of Fernando J. Andrade, 17868 on 05-15-15. Revisions: Date: HDRC Submittal 05-15-15 Project No. 2310 Drawn By: Author Checked By: Checker Sheet Title: BLDG. TYPE III - OVERALL 4TH LEVEL PLAN



# 02 BUILDING TYPE III - GARAGE ELEVATION RIGHT



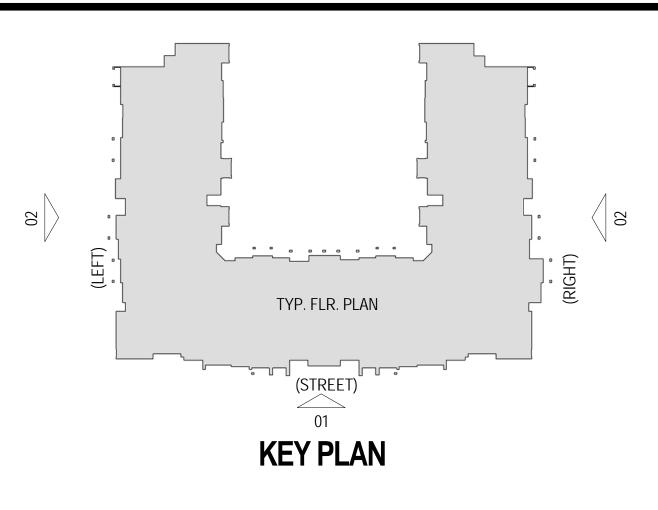

[		
KEYNOTE LEGEND		
#	# EXTERIOR MATERIAL	
03	STUCCO FINISH 'A'	
04	STUCCO FINISH 'B'	
05	SMOOTH STUCCO FINISH 'C'	
08	ALUM. WINDOW PER PLAN W/CLEAR ANODIZED FINISH	
09	ASPHALT COMPOSITION ROOFING (REF. ROOF PLAN FOR SLOPE)	
11	METAL GUARDRAIL (PTD.) - MIN. 42" A.F.F.	
12	MODULAR BRICK	
16	GARAGE DOOR PER PLAN (PTD. FINISH 'A')	
27	CANOPY W/STUCCO FINISH @ FASCIA	
L	·	

			SAN ANTONIO, TEXAS
	Grou	up LLC	
900 San J Mark	Antoi Johi	nio, TX	iza Drive, Suite 78216
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alor 617 ort <sup>v</sup> Philli	nde E Red Wort	Enginee Bud R h, Tx 70 ₋alonde	6135
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		4121	l Commerce St. Ste
			Dallas, Texas 7522 P 214.824.70
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Checked By: Checker Sheet Title: BUILDING TYPE III -EXTERIOR ELEVATIONS Drawing No.

Drawn By: Author

SLAB FORMING PLAN LEGEND

	TOP OF SLAB PER CIVIL DWGS.
	1/2" SUPPRESSED PORTION OF SLAB
	(4" TO 4-1/2") SUPPRESSED PORTION OF SLAB IN GARAGE
	SLOPED PORTION OF SLAB (2%)
1/2"	STEP IN SLAB; HT. INDICATED ON LOW SIDE OF STEP


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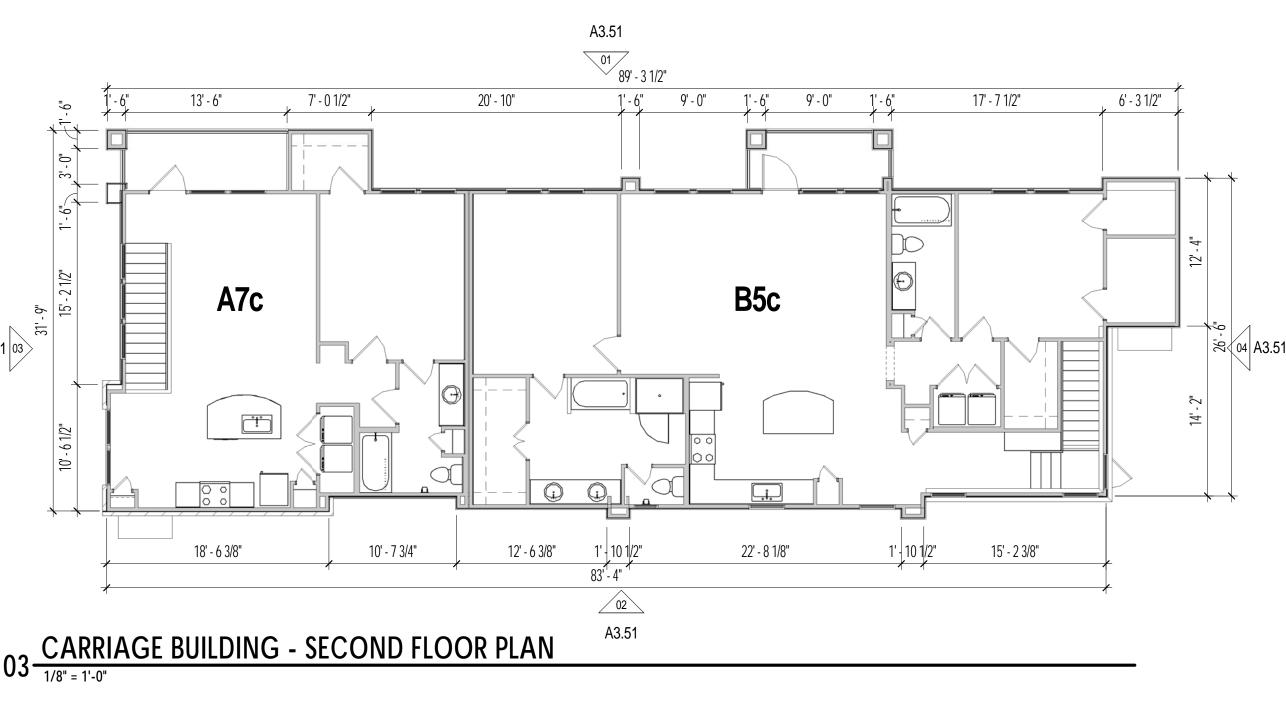
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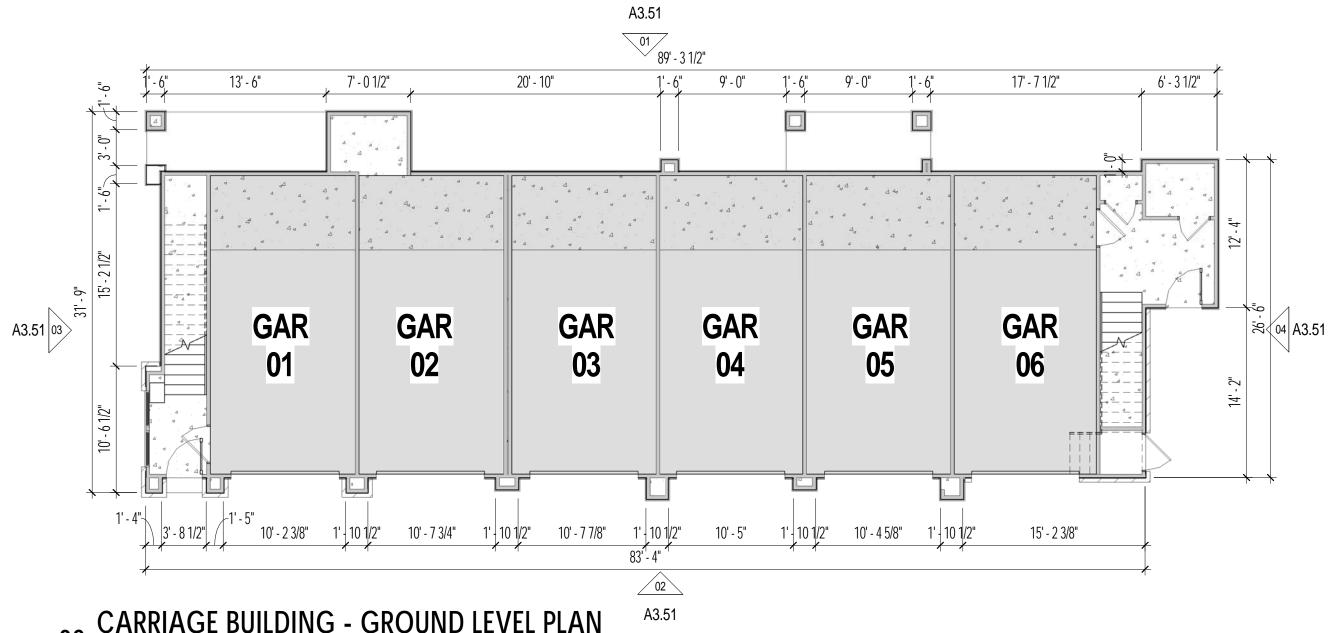
04 CARRIAGE BUILDING - ROOF PLAN





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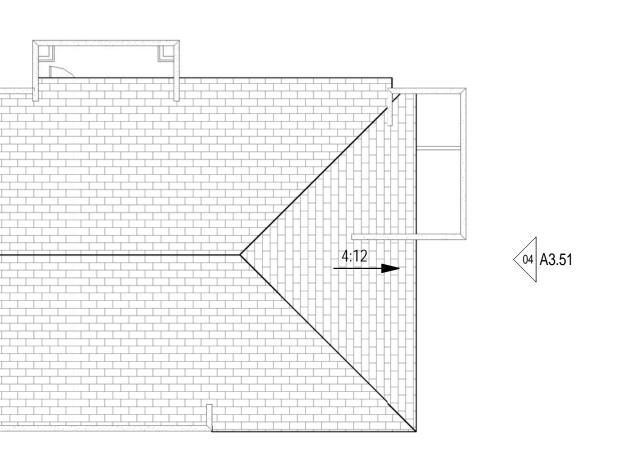






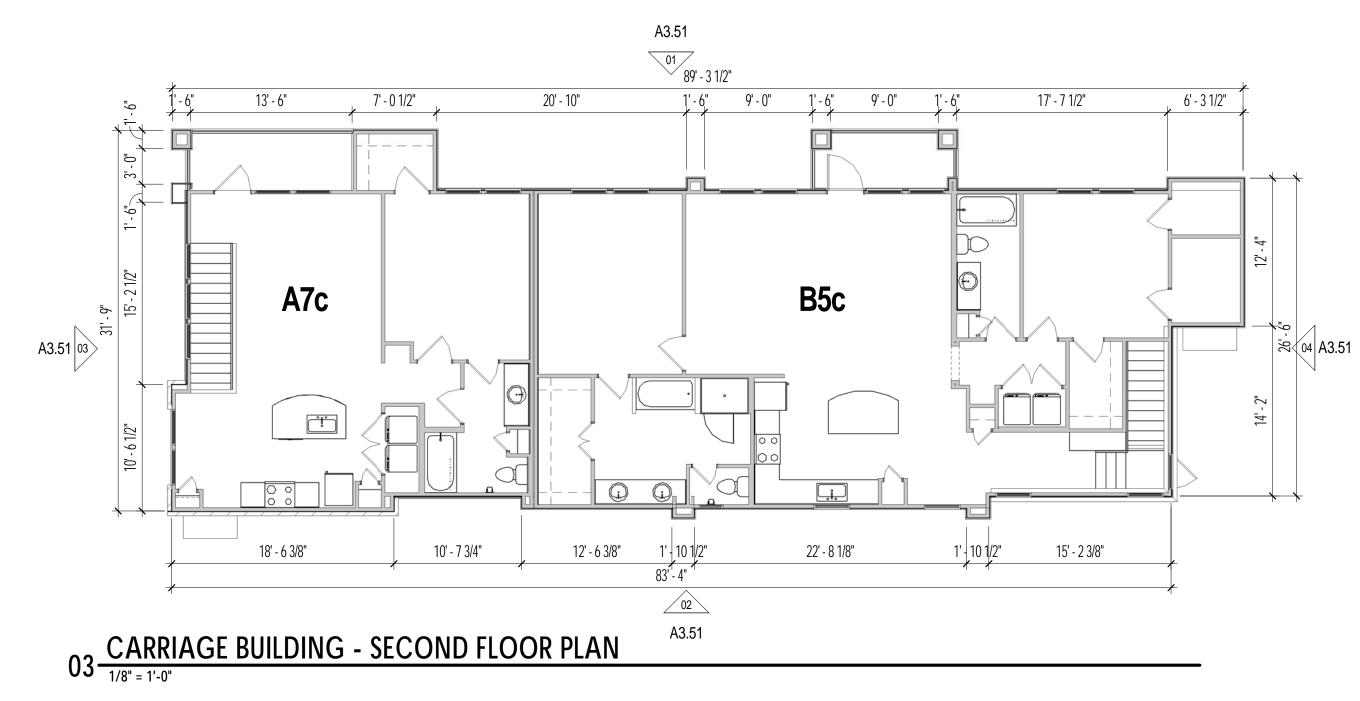

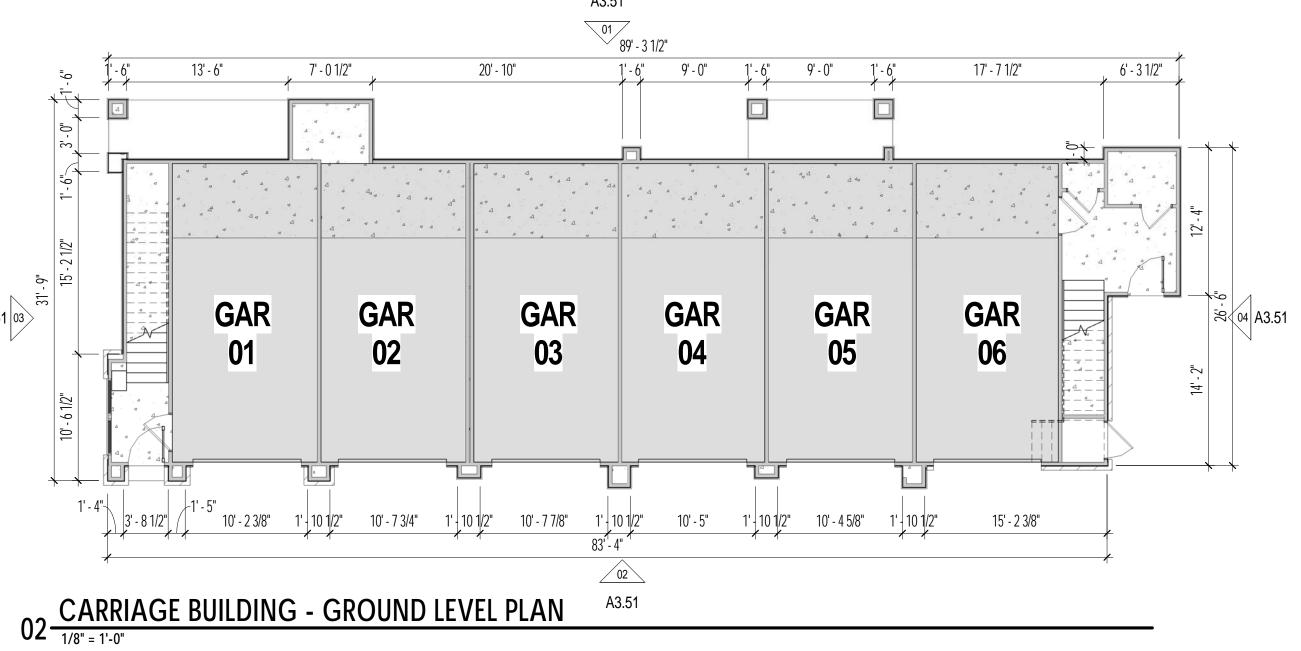

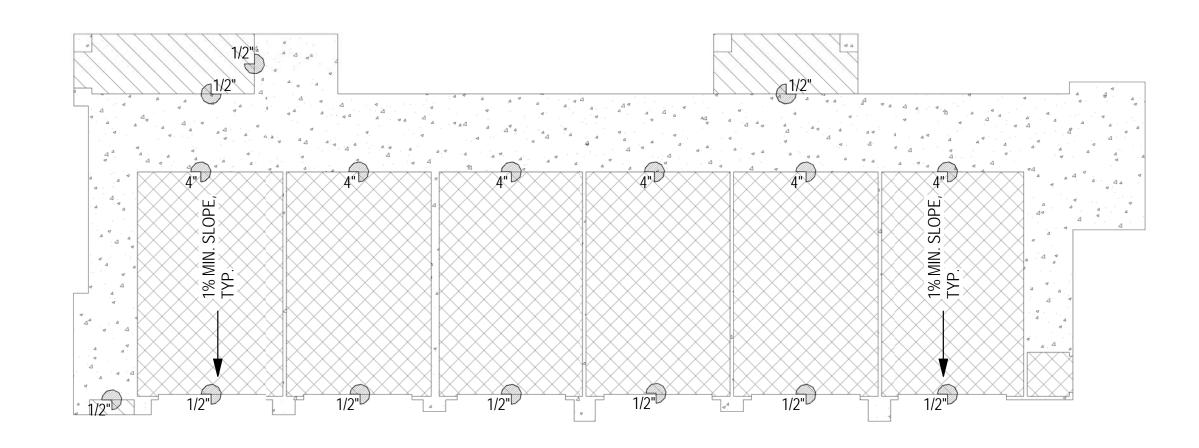

01 CARRIAGE BUILDING - SLAB FORMING PLAN




**APARTMENTS** SAN ANTONIO, TEXAS BROOKS <u>OWNER</u> NRP Group LLC 200 Concord Plaza Drive, Suite 900 San Antonio, TX 78216

Mark Johnson P: 972.899.6140

CIVIL ENGINEER

## STRUCTURAL ENGINEER Lalonde Engineering Inc. 6617 Red Bud Road Fort Worth, Tx 76135 Phillippe Lalonde 817.307.8266 <u>MEP ENGINEER</u> Lwanda & Company, LLC 6136 Frisco Square Blvd. Suite 400 Frisco, TX 75034 Joe Nyanjom 469.287.5488 gsr andrade ARCHITECT 4121 Commerce St. Ste. Dallas, Texas 75226 P 214.824.7040 F 214.887.0559 copyright 2010 © gsr | andrade architects, inc. INTERIM REVIEW DOCUMENTS This document is preliminary and is not intended for Regulatory Approval, Permit, or Construction Purposes. This document is issued under the authority of Fernando J. Andrade, 17868 on 05-15-15. Revisions: Date: HDRC Submittal 05-15-15 Project No. 2310 Drawn By: Author Checked By: Checker Sheet Title: CARRIAGE BUILDING Drawing No.




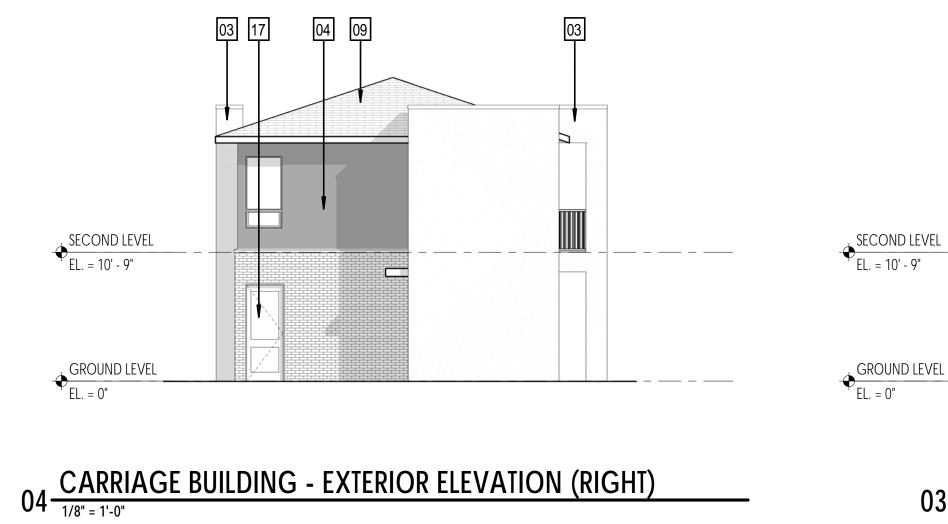




02 CARRIAGE BUILDING - EXTERIOR ELEVATION (GARAGE)



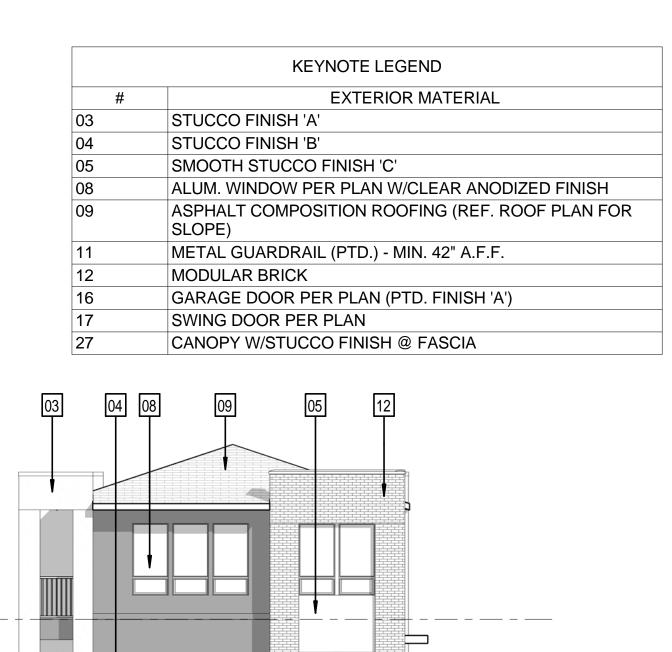

# 03 CARRIAGE BUILDING - EXTERIOR ELEVATION (LEFT)



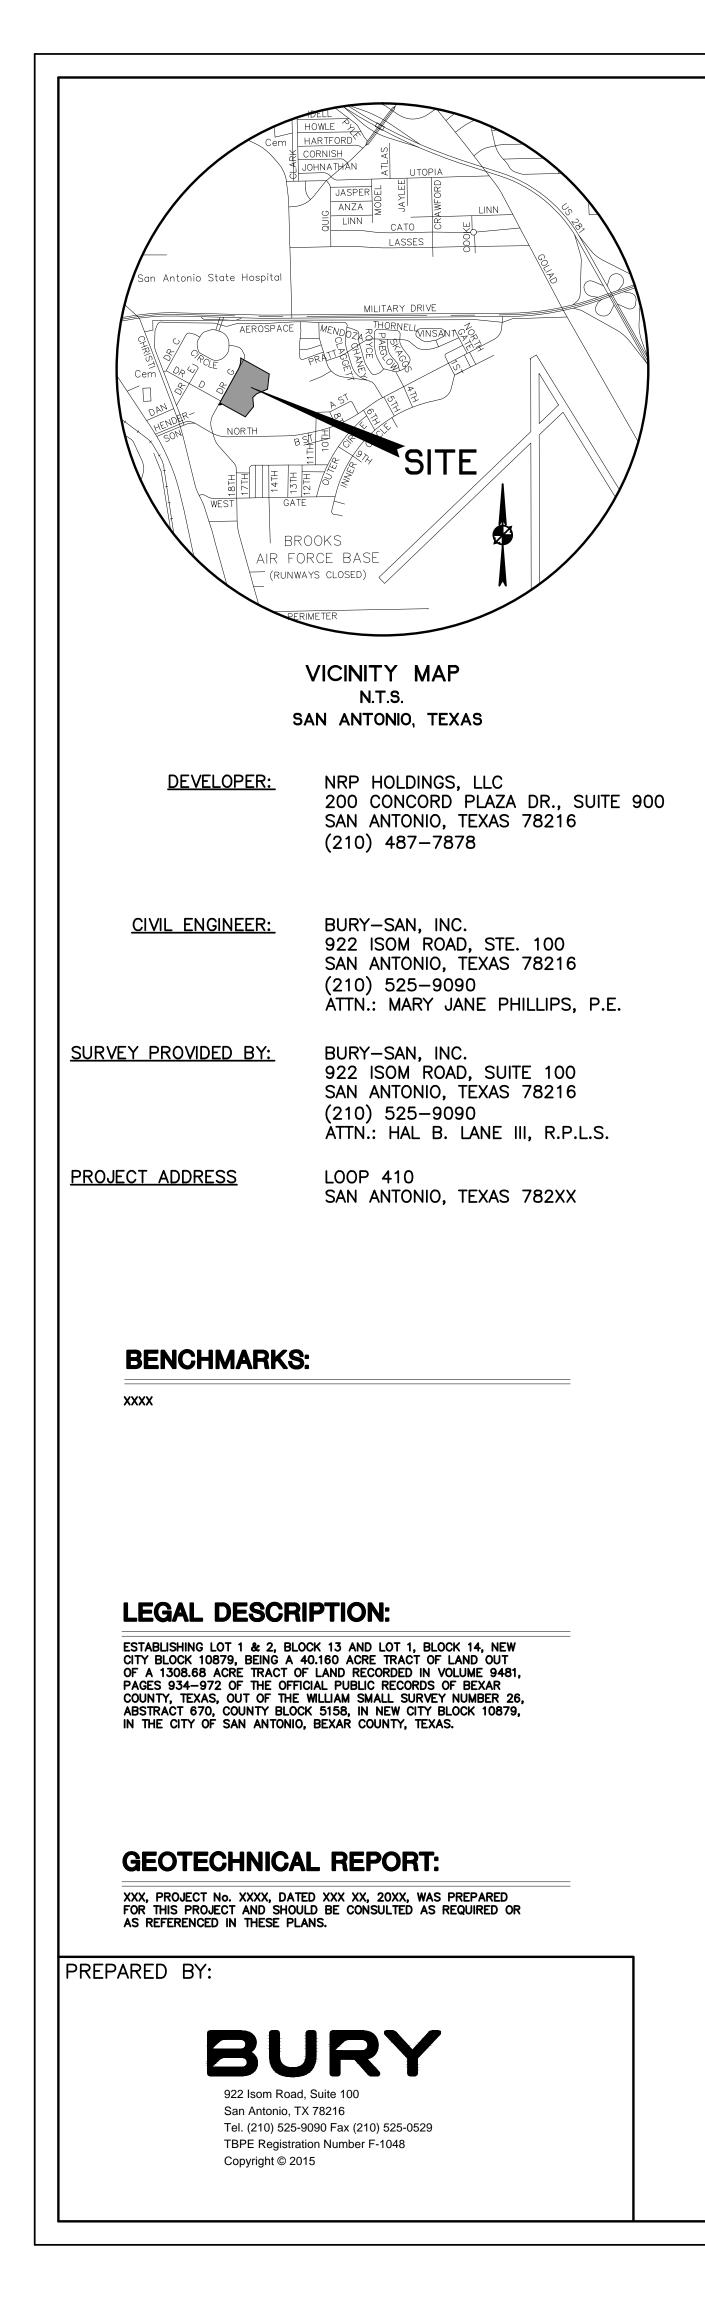

## **GENERAL NOTES:**

1. ALL IMPROVEMENTS SHALL BE MADE IN ACCORDANCE WITH THESE APPROVED PLANS. ANY ADDITIONAL IMPROVEMENTS WILL REQUIRE PLAN REVISIONS AND APPROVAL FROM THE CITY OF SAN ANTONIO AND TXDOT.

PRIOR TO ANY WORK IN EASEMENT OR STREET RIGHT-OF-WAY.

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ADMINISTRATION.

5. ALL CLEARING, GRUBBING, STRIPPING, EXCAVATION, FILL COMPACTION, SUBGRADE PREPARATION AND PAVEMENT CONSTRUCTION SHALL BE IN ACCORDANCE WITH THE GEOTECHNICAL REPORT PREPARED FOR THIS PROJECT.

6. TRENCH EXCAVATION PROTECTION: CONTRACTOR AND/OR CONTRACTOR'S INDEPENDENTLY RETAINED EMPLOYEE OR STRUCTURAL DESIGN/GEOTECHNICAL/SAFETY/EQUIPMENT CONSULTANT. IF ANY. SHALL REVIEW THESE PLANS AND ANY AVAILABLE GEOTECHNICAL INFORMATION AND THE ANTICIPATED INSTALLATION SITE(S) WITHIN THE PROJECT WORK AREA IN ORDER T DEVELOP THE CONTRACTOR'S PLANS TO IMPLEMENT THE PROJECT DESCRIBED IN THE CONTRACT DOCUMENTS. THE CONTRACTOR'S PLANS SHALL PROVIDE FOR ADEQUATE TRENCH SAFETY EXCAVATIONS. SPECIFICALLY, CONTRACTOR AND/OR CONTRACTOR'S INDEPENDENTLY RETAINED EMPLOYEE OR SAFETY CONSULTANT SHALL DEVELOP AND IMPLEMENT A TRENCH SAFETY PROGRAM IN ACCORDANCE WITH OSHA STANDARDS GOVERNING THE PRESENCE AND ACTIVITIES OF INDIVIDUALS WORKING IN AND AROUND TRENCH EXCAVATION. THE CONTRACTOR PLANS AND OUTLINE FOR TRENCH SAFETY PROGRAM SHALL BE FURNISHED BY THE CONTRACTOR TO THE OWNER, PRIOR TO EXECUTION OF THE CONTRACT, FOR INCLUSION AS PART OF THE CONTRACT DOCUMENTS. THE DOCUMENTS FURNISHED TO THE OWNER ARE NOT FOR THE OWNER'S REVIEW, APPROVAL OR ENDORSEMENT OF THE CONTRACTOR'S PLAN AND TRENCH SAFETY PROGRAM, BUT SOLELY FOR THE PURPOSE OF INCLUDING DETAILED TRENCH SAFETY PLANS FOR THE PROJECT IN THE CONTRACT DOCUMENTS.

7. PERMANENT EROSION CONTROL/VEGETATION WILL BE COMPLETED BY CONTRACTOR.

8. BARRICADES AND WARNING SIGNS:

BARRICADES AND WARNING SIGNS SHALL CONFORM TO THE TEXAS MANUAL ON UNIFORM TRAFFIC CONTROL DEVICES AND ARE GENERALLY LOCATED TO AFFORD MAXIMUM PROTECTION TO THE PUBLIC AS WELL AS CONSTRUCTION PERSONNEL AND EQUIPMENT TO ASSURE EXPEDITIOUS TRAFFIC FLOW AT ALL TIMES. DURING THE PROGRESS OF WORK, THE CONTRACTOR SHALL PROVIDE ACCESS FOR LOCAL TRAFFIC.

9. RESERVED

10. CONTRACTOR IS RESPONSIBLE FOR DEMOLITION OF ANY AND ALL EXISTING BUILDINGS/STRUCTURES ON SITE AND UTILITY RELOCATION WORK.

11. RESERVED

16. THE INFORMATION CONTAINED ON THESE DRAWINGS IN REGARDS TO EXISTING UTILITIES, TOPOGRAPHY, CONTOURS, OR SUBSURFACE CONDITIONS IS FURNISHED SOLELY AS THE BEST INFORMATION AVAILABLE AT THIS TIME. ITS ACCURACY IS NOT GUARANTEED AND ITS USE IN NO WAY RELIEVES THE CONTRACTOR OF ANY RESPONSIBILITY FOR LOSSES DUE TO ANY INACCURACIES.

17. ALL REQUIRED RELOCATIONS OR ALTERATIONS OF TELEPHONE POLES, UNDERGROUND CONDUIT, POWER POLES, AND ANY OTHER FACILITIES SHALL BE DONE BY THIS CONTRACTOR, UNLESS NOTED AS "BY OTHERS". THIS CONTRACTOR SHALL SCHEDULE AND COORDINATE HIS WORK WITH THAT OF OTHER CONTRACTORS AND UTILITY COMPANIES SO AS NOT TO DELAY THE PROJECT.

18. THE CONTRACTOR SHALL NOTIFY BEXAR COUNTY BEFORE BEGINNING ANY UTILITY CONSTRUCTION IN PUBLIC R.O.W. OR PUBLIC EASEMENT. NO PIPE SHALL BE LAID UNTIL THE ASSIGNED INSPECTOR HAS MET WITH THE CONTRACTOR OR HIS REPRESENTATIVE AT THE PROJECT SITE.

19. THE CONTRACTOR SHALL CONTACT ALL UTILITY COMPANIES FOR EXISTING UTILITY LOCATIONS PRIOR TO CONSTRUCTION. UTILITY LOCATIONS TO BE MARKED ON-SITE AND IN PUBLIC R.O.W., WHERE APPLICABLE.

20. RESERVED

PER MANUFACTURERS RECOMMENDATIONS.

LANDSCAPE PLAN.

# CIVIL CONSTRUCTION DOCUMENTS **BROOKS CITY BASE II**

# DAVE ERWIN DRIVE SAN ANTONIO, TEXAS

BPI JOB NO .: SUBMITTAL DATE: R0110695-50005 APRIL, 2015

SUBMITTED BY :

MARY JANE PHILLIPS. P.E. BURY-SAN, INC. 922 ISOM ROAD, STE. 100 SAN ANTONIO, TEXAS 78216 (210) 525-9090

2. CONTRACTOR SHALL CALL THE UTILITY AGENCIES LISTED BELOW, FOR UTILITY LOCATIONS

CITY OF SAN ANTONIO SAN ANTONIO WATER SYSTEM SAN ANTONIO WATER SYSTEM CPS ENERGY CPS ENERGY AT&T	(210) (210) (210) (210) (210) (210) (210)
AT&T	(210)
TIME WARNER	(210)

3. THE CONTRACTOR SHALL NOTIFY THE CITY OF SAN ANTONIO, TXDOT OR BEXAR COUNTY AT LEAST TWENTY-FOUR (24) HOURS PRIOR TO THE INSTALLATION OF ANY DRAINAGE FACILITY WITHIN A DRAINAGE EASEMENT OR STREET RIGHT-OF-WAY.

4. ALL CONSTRUCTION OPERATIONS SHALL BE ACCOMPLISHED IN ACCORDANCE WITH APPLICABLE REGULATIONS OF THE U.S. OCCUPATIONAL HEALTH AND SAFETY

12. ALL AREAS DISTURBED BY CONSTRUCTION SHALL BE RESTORED AND GRADED TO

13. ALL DEBRIS AND EXCESS MATERIAL SHALL BE REMOVED FROM THE SITE IN A MANNER NOT TO DAMAGE THE OWNER PRIOR TO ACCEPTANCE OF THE PROJECT.

14. ALL CONCRETE WORK SHALL CONFORM TO ALL APPLICABLE REQUIREMENTS OF ACI

15. ALL EXPOSED CORNERS FOR CONCRETE WORK SHALL BE CHAMFERED 1".

21. ALL SLOPES STEEPER THAN 3:1 SHALL BE OVERLAID WITH TRM 450 AND ANCHORED

22. NOTE 23 SHALL APPLY TO ALL AREAS WITHIN PROPERTY NOT COVERED BY

23. PERMANENT EROSION CONTROL:

- ALL DISTURBED AREAS SHALL BE RESTORED AS NOTED BELOW:

- A MINIMUM OF 4" OF TOPSOIL SHALL BE PLACED IN ALL DRAINAGE CHANNELS (EXCEPT ROCK) AND BETWEEN THE CURB AND R.O.W. PROPERTY LINES. - BROADCAST SEEDING:

DATE

i. FROM SEPTEMBER 15 TO MARCH 1, SEEDING SHALL BE WITH A COMBINATION OF 2 POUNDS PER 1000 SF OF UNHULLED BERMUDA AND 7 POUNDS PER 1000 SF OF WINTER RYE WITH A PURITY OF 95% WITH 90% GERMINATION.

ii. FROM MARCH 2 TO SEPTEMBER 14, SEEDING SHALL BE WITH HULLED BERMUDA AT A RATE OF 2 POUNDS PER 1000 SF WITH A PURITY OF 95% WITH 85% GERMINATION.

- FERTILIZER SHALL BE A PELLETED OR GRANULAR SLOW RELEASE WITH AN ANALYSIS OF 15-15-15 TO BE APPLIED ONCE AT PLANTING AND ONCE DURING THE PERIOD OF ESTABLISHMENT AT A RATE OF 1 POUND PER 1000 SF. – HYDRAULIC SEEDING:

i. FROM SEPTEMBER 15 TO MARCH 1, SEEDING SHALL BE WITH A COMBINATION OF 1 POUND PER 1000 SF OF UNHULLED BERMUDA AND 7 POUNDS PER 1000 SF OF WINTER RYE WITH A PURITY OF 95% WITH 90% GERMINATION.

ii. FROM MARCH 2 TO SEPTEMBER 14. SEEDING SHALL BE WITH HULLED BERMUDA AT A RATE OF 7 POUNDS PER 1000 SF WITH A PURITY OF 95% WITH 85% GERMINATION.

FERTILIZER SHALL BE A WATER SOLUBLE FERTILIZER WITH AN ANALYSIS OF 15-15-15 AT A RATE OF 1 TO 1.5 POUNDS PER 1000 SF. (45-65 POUNDS PER ACRE)

MULCH TYPE USED SHALL BE HAY. STRAW. OR MULCH APPLIED AT A RATE OF 45 POUNDS PER 1000 SF, WITH A SOIL TACKIFIER AT A RATE OF 1.4 POUNDS PER 1000 SF.

- THE PLANTED AREA SHALL BE IRRIGATED OR SPRINKLED IN A MANNER THAT WILL NOT ERODE THE TOPSOIL BUT WILL SUFFICIENTLY SOAK THE SOIL TO A DEPTH OF 6". THE IRRIGATION SHALL OCCUR AT TEN-DAY INTERVALS DURING THE FIRST TWO MONTHS. RAINFALL OCCURRENCES OF  $\frac{1}{2}$ " OR MORE SHALL POSTPONE THE WATERING SCHEDULE FOR ONE WEEK.

RESTORATION SHALL BE ACCEPTABLE WHEN THE GRASS HAS GROWN AT LEAST  $12^{*}$ HIGH WITH 95% COVERAGE, PROVIDED NO BARE SPOTS LARGER THAN 16 SQUARE

24. CONTRACTOR TO COMPLY WITH TXDOT OR BEXAR COUNTY INSPECTION REQUIREMENTS PRIOR TO POURING CONCRETE.

25. CONTRACTOR SHALL BE RESPONSIBLE FOR SUBMITTING NOTICE OF INTENT (NOI) TO E.P.A. AND THE TCEQ FOR THE TEXAS POLLUTANT DISCHARGE ELIMINATION SYSTEM (TPDES) 48 HOURS PRIOR TO THE COMMENCEMENT OF CONSTRUCTION ACTIVITIES.

26. CONTRACTOR SHALL PROVIDE A LANDSCAPE MAINTENANCE CONTRACT AND WARRANTY PERIOD FOR ONE YEAR STARTING ON THE COMPLETION DATE AS ESTABLISHED BY THE OWNER.

27. NO BLASTING ON SITE.

28. CONTRACTOR IS REQUIRED TO PROVIDE "AS BUILT" ON ALL UTILITY AND DRAINAGE IMPROVEMENTS, PUBLIC OR PRIVATE.

29. CONTRACTOR SHALL APPLY FOR RIGHT-OF-WAY CONSTRUCTION PERMIT AND UTILITY PERMIT FROM COUNTY AND/OR TXDOT FOR ALL CONSTRUCTION IN COUNTY AND/OR TXDOT R.O.W.

30. CONTRACTOR IS RESPONSIBLE FOR TAKING (AND INCLUDING IN BID) ALL OF THE APPROPRIATE SECURITY MEASURES AT THE SITE, FOR THE DURATION OF THE CONSTRUCTION PERIOD.

31. PRIOR TO CONSTRUCTION, THE CONTRACTOR SHALL MAKE CERTAIN THAT ALL REQUIRED PERMITS AND APPROVALS HAVE BEEN OBTAINED. NO CONSTRUCTION OR FABRICATION SHALL BEGIN UNTIL THE CONTRACTOR HAS RECEIVED AND THOROUGHLY REVIEWED ALL PLANS AND OTHER DOCUMENTS APPROVED BY ALL OF THE PERMITTING AUTHORITIES.

32. ALL CONSTRUCTION WITHIN THE PUBLIC RIGHT-OF-WAY SHALL CONFORM TO THE STANDARD SPECIFICATIONS AND DRAWINGS OF THE CITY, COUNTY AND/OR TXDOT (AS WELL AS THE REQUIREMENTS OF THE T.C.E.Q. AND THE OCCUPATIONAL SAFETY AND HEALTH ADMINISTRATION (OSHA)).

33. PRIOR TO CONSTRUCTION, THE CONTRACTOR SHALL CONDUCT A SITE WORK PRE-CONSTRUCTION CONFERENCE BETWEEN THE CITY OF SAN ANTONIO, CONSULTING ENGINEER, CONTRACTOR(S), UTILITY COMPANIES AND ANY OTHER AFFECTED PARTIES.

34. NECESSARY BARRICADES, SUFFICIENT LIGHTS, SIGNS, AND OTHER TRAFFIC CONTROL METHODS AS MAYBE NECESSARY FOR THE PROTECTION AND SAFETY OF THE PUBLIC, SHALL BE PROVIDED BY THE CONTRACTOR IN ACCORDANCE WITH THE LATEST EDITION OF THE MANUAL ON UNIFORM TRAFFIC CONTROL DEVICES AND MAINTAINED AT ALL TIMES (24 HRS. PER DAY) DURING THE CONSTRUCTION PROCESS.

35. THE LOCATION AND ELEVATION OF IMPROVEMENTS TO BE DONE SHALL BE CONFIRMED BY FIELD MEASUREMENTS PRIOR TO THE CONSTRUCTION OF THE WORK THE CONTRACTOR IS TO MAKE EXPLORATORY EXCAVATIONS AND LOCATE EXISTING JNDERGROUND UTILITIES. THE CONTRACTOR SHALL BE RESPONSIBLE FOR MAKING ALI THE NECESSARY ARRANGEMENTS WITH THE RESPECTIVE UTILITY COMPANIES. GRAVITY LINE CONSTRUCTION IS REQUIRED TO BE VERIFIED AT CONNECTION POINT THEN BUILD UPSTREAM.

36. THE CONTRACTOR IS RESPONSIBLE FOR PROTECTING EXISTING FACILITIES FROM DAMAGE AND COST OF REPAIR TO EXISTING FACILITIES AND IMPROVEMENTS AS A RESULT OF CONTRACTOR'S WORK. THE CONTRACTOR SHALL NOTIFY ALL UTILITY OFFICES PRIOR TO STARTING WORK AND SHALL COORDINATE THEIR WORK WITH THE UTILITY OFFICES.

37. DURING CONSTRUCTION, THE CONTRACTOR SHALL PROVIDE A GEOTECHNICAL LAB TO PERFORM MATERIALS TESTING DURING THE CONSTRUCTION.

### SHEET INDEX C0.0 COVER SHEET C0.1 GENERAL NOTES C1.0 EXISTING CONDITIONS, DEMOLITION, & S.W.P.P.P. C1.1 EXISTING CONDITIONS, DEMOLITION, & S.W.P.P.P. C1.2 STORM WATER POLLUTION PREVENTION PLAN DETAILS C2.0 OVERALL SITE PLAN C2.1 SITE AND PAVING PLAN C2.2 SITE AND PAVING PLAN C2.3 FIRE PROTECTION PLAN C2.4 FIRE PROTECTION PLAN n C3.0 OVERALL GRADING PLAN C3.1 GRADING PLAN C3.2 GRADING PLAN C3.3 DRAINAGE PLAN C3.4 DRAINAGE PLAN C4.0 OVERALL UTILITY PLAN C4.1 WATER PLAN FOR INTERIM REVIEW C4.2 WATER PLAN AND NOT INTENDED C4.3 WASTEWATER PLAN FOR BIDDING. C4.4 WASTEWATER PLAN PERMITTING C5.0 SITE PLAN DETAILS OR CONSTRUCTION C5.1 PURPOSES. SITE PLAN DETAILS MARY JANE PHILLIE C6.0 UTILITY PLAN DETAILS TX. REG. 102318 ш **H**S OVER Ŏ SPECIAL CONSTRUCTION NOTES 1. THE CONTRACTOR SHALL CONTACT THE APPLICABLE UTILITY LOCATOR AT 1-800-DIG-TESS, 48 HOURS BEFORE BEGINNING ANY EXCAVATION. 2. DUE TO FEDERAL REGULATIONS TITLE 49, PART 192.181, CPS ENERGY MUST MAINTAIN ACCESS TO GAS VALVES AT ALL TIMES. THE CONTRACTOR MUST PROTECT AND WORK AROUND ANY GAS VALVES THAT ARE IN THE PROJECT AREA. 3. THE EXISTENCE AND LOCATION OF UNDERGROUND CABLE INDICATED ON THE PLANS ARE TAKEN FROM THE BEST RECORDS AVAILABLE AND ARE NOT GUARANTEED TO BE ACCURATE. CONTRACTOR TO CONTACT THE TELEPHONE COMPANY CABLE LOCATOR 48 HOURS PRIOR TO EXCAVATION AT 1-800-DIG-TESS. CONTRACTOR HAS THE RESPONSIBILITY TO PROTECT AND SUPPORT TELEPHONE COMPANY PLANT DURING CONSTRUCTION. 4. NOT USED 5. DAMAGE TO ANY UNDERGROUND DRAINAGE SYSTEM SHALL BE REPORTED TO THE CITY'S DRAINAGE SUPERINTENDENT. THE SUPERINTENDENT WILL INSTRUCT THE DAMAGING PARTY (CONTRACTOR) ON HOW TO REPAIR THE LINE AT THE CONTRACTORS COST. 6. CONTRACTOR IS RESPONSIBLE FOR MAINTAINING AND PROTECTING THE INTEGRITY OF THE POWER POLES DURING CONSTRUCTION. THE CONTRACTOR SHALL BE REQUIRED AT THEIR EXPENSE TO PROVIDE ACCEPTABLE BRACING OF SPECIFIC CITY PUBLIC SERVICE POLES DURING THE CONSTRUCTION OF THIS PROJECT AND/OR PROVIDE AT THEIR EXPENSE FOR CITY PUBLIC SERVICE TO PROVIDE BRACING. IN ADDITION IT IS CRITICAL THE CONTRACTOR WORK CLOSELY WITH CITY OF SAN ANTONIO CONSTRUCTION FOREMAN Ш Х Т FOR THE SAKE OF SAFETY TO ISOLATE AND/OR PROTECT CONTRACTOR FROM ENERGIZED ELECTRIC CONDUCTORS ABOVE AREAS OF PROPOSED EXCAVATION. МО **GENERAL UTILITY NOTES:** <S CITY ANTONI</pre> 1. ALL WATER IMPROVEMENTS SHALL BE MADE IN ACCORDANCE WITH SAN ANTONIO WATER SYSTEM (SAWS), AND THESE APPROVED PLANS. ALL WASTEWATER IMPROVEMENTS SHALL BE MADE IN ACCORDANCE WITH SAWS AND THESE APPROVED PLANS. ANY ADDITIONAL IMPROVEMENT WILL REQUIRE PLAN REVISIONS AND APPROVAL BY SAWS. 2. AT LEAST FORTY-EIGHT (48) HOURS BEFORE BEGINNING ANY WATER AND WASTEWATER CONSTRUCTION IN PUBLIC R.O.W. OR PUBLIC EASEMENT, THE CONTRACTOR SHALL NOTIFY AND SAWS **N N** FOR MAIN LINE CONSTRUCTION, OR WATER AND WASTEWATER UTILITY TAPS. 3. IN ADVANCE OF CONSTRUCTION, THE CONTRACTOR SHALL VERIFY THE LOCATIONS OF ALL BR( S UTILITIES TO BE EXTENDED, TIED TO, OR ALTERED, OR SUBJECT TO DAMAGE/INCONVENIENCE BY THE CONSTRUCTION OPERATIONS. THE CITY OF SAN ANTONIO MAINTENANCE RESPONSIBILITY ENDS AT R.O.W./EASEMENT LINES. 200 EV 4. NO OTHER UTILITY SERVICE/APPURTENANCES SHALL BE PLACED NEAR THE PROPERTY LINE, OR OTHER ASSIGNED LOCATION DESIGNATED FOR WATER AND WASTEWATER UTILITY SERVICE THAT WOULD INTERFERE WITH THE WATER AND WASTEWATER SERVICES. 5. FOR PRESSURE TAPS, FURNISH, INSTALL AND AIR TEST THE SLEEVE AND VALVE. CONCRETE BLOCKING SHALL BE PLACED BEHIND AND UNDER ALL TAP SLEEVES TWENTY-FOUR (24) HOURS PRIOR TO MAKING THE WET TAP. 6. JOINT RESTRAINTS SHALL BE IN ACCORDANCE WITH SAWS REQUIREMENTS. 7. ALL PRIVATE WATER AND WASTEWATER LINES WILL COMPLY WITH THE INTERNATIONAL PLUMBING CODE. 8. CONCRETE ENCASE ALL WATER LINES THAT CROSS WITHIN 2.0 FEET OF WASTEWATER LINE. 9. EXTEND ALL EXISTING UTILITY MANHOLES, BOXES, COVERS, ETC. TO PROPOSED FINISH GRADE, UNLESS APPROVED OTHERWISE. 10. ALL PROPOSED ELECTRIC, PHONE AND CABLE CONDUITS SHALL BE PROVIDED WITH PULL STRINGS. $\mathcal{S}$ 11. IF REQUIRED, ALL WORK ASSOCIATED WITH PROVIDING NATURAL GAS INCLUDING TRENCHING, CONDUIT INSTALLATION, PAVEMENT REPLACEMENT/BACKFILL AND METER INSTALLATION AS DESCRIBED ON THESE PLANS SHALL BE COORDINATED WITH NATURAL GAS PROVIDER. Δ Δ 12. THE TOP OF PROPOSED MANHOLES SHALL MATCH THE FINISHED GRADE ELEVATIONS UNLESS OTHERWISE NOTED. 13. ALL PROPOSED ELECTRIC, GAS, PHONE, AND CABLE UTILITIES SHOWN FOR REFERENCE ONLY, CONTRACTOR TO VERIFY AND COORDINATE LOCATIONS WITH UTILITY COMPANIES. SHEET

### SITE CLEARING

CONDUCT SITE CLEARING OPERATIONS TO THE EXTENT SHOWN ON THE DRAWINGS, INCLUDING BUT NOT LIMITED TO: REMOVAL OF TREES AND OTHER VEGETATION, TOPSOIL STRIPPING, CLEARING AND GRUBBING. AND REMOVAL ALL IMPROVEMENTS ABOVE OR BELOW GRADE. REFER TO THE GEOTECHNICAL REPORT FOR THIS PROJECT FOR ADDITIONAL SITE PREPARATION REQUIREMENTS. EXECUTION:

- 1. SITE CLEARING OPERATIONS SHALL NOT DAMAGE OR INTERFERE WITH THE PUBLIC USE OF ROADS, WALKS, ADJACENT LAND OR FACILITIES AND EXISTING IMPROVEMENTS INTENDED TO REMAIN.
- 2. EXISTING TREES TO REMAIN SHALL BE PROTECTED IN COMPLIANCE WITH LANDSCAPE PROTECTION.
- 3. CONTRACTOR SHALL REMOVE TREES, SHRUBS, GRASS AND OTHER VEGETATION, IMPROVEMENTS OR OBSTRUCTIONS INTERFERING WITH THE INSTALLATION OF NEW CONSTRUCTION OR AS SHOWN ON PLANS. CLEARING OPERATIONS SHALL INCLUDE REMOVAL OF STUMPS AND ROOTS. 4. CONTRACTOR SHALL STRIP TOPSOIL IN A MANNER APPROPRIATE TO SEGREGATE FROM
- UNDERLYING SUBSOL. TOPSOIL STRIPPING NEAR TREES INTENDED TO REMAIN SHALL BE COMPLETED IN COMPLIANCE WITH LANDSCAPE PROTECTION.
- 5. SPOIL SHALL BE STORED ONLY IN AREAS SHOWN ON THE PLANS AND SHALL BE MAINTAINED IN ACCORDANCE WITH APPLICABLE POLLUTION PREVENTION PLANS OR PERMITS.
- 6. WASTE MATERIAL OR EXCESS TOPSOIL GENERATED AS A RESULT OF CLEARING AND GRADING OPERATIONS SHALL BECOME THE PROPERTY OF THE CONTRACTOR. APPROPRIATE DISPOSAL OF ALL SPOIL MATERIAL SHALL BE AT THE CONTRACTOR'S EXPENSE. BURNING ON THE OWNER'S PROPERTY IS NOT PERMITTED.

### DEMOLITION NOTES:

FOLLOWING APPROPRIATE SAFETY PROCEDURES, DEMOLISH EXISTING FACILITIES AS SHOWN ON THE PLANS. PROTECTION OF PUBLIC AND PRIVATE PROPERTY AND SAFE DISPOSITION OF SPOIL MATERIAL IS INCLUDED IN THIS ITEM. EXECUTION:

- 1. CONTRACTOR SHALL SUBMIT FOR APPROVAL TO GOVERNMENTAL AGENCIES AND THE OWNER A DEMOLITION PLAN INCLUDING BUT NOT LIMITED TO THE FOLLOWING: A. METHODS, EQUIPMENT AND SEQUENCE OF OPERATION.
- B. CREDENTIALS OF INDIVIDUALS PERFORMING DEMOLITION OPERATIONS, INCLUDING SUBCONTRACTORS.
- SAFETY MEASURES TO PROTECT WORKERS, PERSONNEL AND THE PUBLIC.
- D. SAFETY MEASURES TO PROTECT ADJACENT PROPERTIES, LANDSCAPING, IMPROVEMENTS TO REMAIN OR PUBLIC RIGHTS OF WAY.
- ASBESTOS OR OTHER HAZARDOUS MATERIAL ABATEMENT PLAN. F. STORAGE, REMOVAL AND DISPOSITION OF SPOIL MATERIAL.
- G. EROSION CONTROL MEASURES, INCLUDING NPDES PROCEDURES AND REGULATIONS. H. POLLUTION AND AIR QUALITY CONTROL MEASURES (DUST CONTROL, ETC.). I. HEALTH DEPARTMENT NOTICE.
- J. UTILITY COORDINATION WITH ALL AFFECTED UTILITIES, INCLUDING LOCATION OF SERVICE.
- 2. THE USE OF EXPLOSIVES WILL NOT BE PERMITTED.
- 3. THE PROJECT SITE SHALL BE CLEANED DAILY. DEBRIS, RUBBISH AND CONTRACTORS SALVAGED MATERIAL SHALL BE REMOVED PROMPTLY.
- 4. ALL SPOIL MATERIAL REMAINING AFTER OWNER SALVAGE IS COMPLETE AND RESULTING FROM DEMOLITION OPERATIONS BECOMES THE PROPERTY OF THE CONTRACTOR. APPROPRIATE DISPOSAL OF SPOIL MATERIAL SHALL BE THE RESPONSIBILITY OF THE CONTRACTOR AT HIS OWN EXPENSE. OWNER WILL PROVIDE LIST OF ITEMS TO BE SALVAGED.

### EARTHWORK

PREPARE SUBGRADE BY EXCAVATION OR EMBANKMENT FOR BUILDING SLABS, WALKS AND PAVEMENTS. EXCAVATION AND BACKFILL FOR UNDERGROUND UTILITIES AND DRAINAGE FILL COURSE FOR SUPPORT OF BUILDING SLABS ARE INCLUDED IN THIS ITEM. EXECUTION:

- 1. ALL EXCAVATION, BACKFILL AND COMPACTION SHALL BE PERFORMED AS SHOWN IN THE
- PLANS AND GEOTECHNICAL REPORT FOR THE SITE. 2. EXCESS MATERIAL RESULTING FROM EXCAVATION OPERATIONS IS THE PROPERTY OF THE
- CONTRACTOR. APPROPRIATE DISPOSAL SHALL BE AT THE CONTRACTOR'S EXPENSE. 3. ALL EXCAVATION SHALL BE PERFORMED AS DIRECTED IN THE PLANS AND IN COMPLIANCE WITH OSHA STANDARDS
- 4. OWNER WILL ENGAGE AT THE OWNER'S COST SOIL TESTING AND INSPECTION SERVICE IN ACCORDANCE WITH MATERIAL TESTING SPECIFICATION TO VERIFY COMPLIANCE WITH THE PLANS & SPECIFICATIONS. REPLACEMENT AND RETESTING OF DEFICIENT WORK SHALL BE
- DONE BY CONTRACTOR AT NO ADDITIONAL COMPENSATION. 5. DATA ON SUBSURFACE CONDITIONS IS AVAILABLE TO THE CONTRACTOR. THE OWNER MAKES NO WARRANTY AS TO THE CORRECTNESS OF THESE REPORTS. THE CONTRACTOR MAY, AT HIS
- OWN EXPENSE, PERFORM ADDITIONAL TEST BORINGS. 6. CONTRACTOR IS RESPONSIBLE FOR COORDINATION WITH ALL AFFECTED UTILITY COMPANIES. THIS SHALL INCLUDE LOCATION OF FACILITIES, PROTECTION DURING CONSTRUCTION, DAMAGE
- REPAIRS AND DISRUPTION OF SERVICE. 7. THE EXCAVATION IS UNCLASSIFIED, AND CONTRACTOR SHALL PERFORM EXCAVATION TO THE ELEVATIONS INDICATED IN THE PLANS, REGARDLESS OF CHARACTER OF MATERIAL, WITH NO ADDITIONAL COMPENSATION FROM THE OWNER. USE OF EXPLOSIVE IS PROHIBITED.
- 8. CONTRACTOR IS RESPONSIBLE FOR PROVIDING BARRICADES REQUIRED TO WARN AND/OR PREVENT ACCESS TO CONSTRUCTION AREA.
- 10. EARTHWORK SHALL BE PERFORMED IN COMPLIANCE WITH LANDSCAPE PROTECTION.
- DIRECTED BY THE ENGINEER AT NO ADDITIONAL COST TO THE OWNER. 12. CONTRACTOR SHALL PROVIDE ALL LABOR AND EQUIPMENT NECESSARY TO PROPERLY
- DEWATER EXCAVATION AREAS AS REQUIRED. 13. EXCAVATED MATERIAL SHALL BE STOCKPILED WHERE DIRECTED IN THE PLANS. STOCKPILE
- 14. EARTHWORK SHALL BE PERFORMED TO THE TOLERANCES SHOWN IN THE PLANS AND/OR SPECIFIED IN THE GEOTECHNICAL REPORT FOR THE PROJECT.
- 15. TRENCHES SHALL BE BACKFILLED ONLY AFTER INSPECTION AND APPROVAL OF THE ENGINEER. BACKFILL MATERIAL AND PROCEDURES FOR TRENCHES SHALL BE IN COMPLIANCE WITH THE TEXAS DEPARTMENT OF TRANSPORTATION 2004 STANDARD SPECIFICATION FOR CONSTRUCTION OF HIGHWAYS, STREETS AND BRIDGES, ITEM 400 - EXCAVATION AND BACKFILL FOR STRUCTURES.

## **GRADING NOTES:**

- 1. VERIFY THE SUITABILITY OF ALL EXISTING AND PROPOSED SITE CONDITIONS INCLUDING GRADES AND DIMENSIONS BEFORE COMMENCEMENT OF CONSTRUCTION. THE ENGINEER SHALL BE NOTIFIED IMMEDIATELY OF ANY DISCREPANCIES. MINOR ADJUSTMENT TO FINISH GRADE TO ACCOMPLISH SPOT DRAINAGE IS ACCEPTABLE, IF NECESSARY, UPON PRIOR APPROVAL OF THE ENGINEER.
- 2. REFER TO SITE PLAN FOR HORIZONTAL DIMENSIONS. 3. UNLESS NOTED OTHERWISE, ALL PARKING LOT GRADES ARE TO INVERT OF GUTTER. ADD 0.5' TO GUTTER GRADE FOR TOP OF CURB GRADE EXCEPT WHERE CURB IS FLUSH WITH PAVFMFNT
- 4. SITE PREPARATION AND GRADING, FOUNDATION EXCAVATION AND FILL SHALL BE PERFORMED IN ACCORDANCE WITH THE GEOTECHNICAL INVESTIGATION REPORT.
- 5. PAVING INSTALLED SHALL "FLUSH OUT" AT ANY JUNCTURE WITH EXISTING PAVING. 6. ALL FILL MATERIAL PROVIDED SHALL BE APPROVED BY THE GEOTECHNICAL ENGINEER
- PRIOR TO PLACING AND COMPACTING. 7. ALL STORM SEWER INLETS AND STRUCTURES SHALL BE PRECAST UNLESS OTHERWISE NOTED.
- 8. REFER TO CIVIL AND/OR LANDSCAPE PLANS FOR RETAINING WALL LOCATIONS AND ELEVATIONS. REFER TO STRUCTURAL RETAINING WALL PLANS FOR CONSTRUCTION DETAILS.

## SITE PLAN NOTES:

- 1. ALL ON-SITE CONSTRUCTION SHALL BE IN ACCORDANCE WITH CURRENT BEXAR COUNTY SPECIFICATIONS
- 2. ALL CONSTRUCTION IN RIGHT-OF-WAYS AND/OR EASEMENTS SHALL BE IN ACCORDANCE WITH APPLICABLE STANDARD SPECIFICATIONS.
- 3. PRIOR TO STARTING CONSTRUCTION, THE CONTRACTOR SHALL MAKE CERTAIN THAT ALL REQUIRED PERMITS AND APPROVALS HAVE BEEN OBTAINED. NO CONSTRUCTION OR FABRICATION SHALL BEGIN UNTIL THE CONTRACTOR HAS RECEIVED AND THOROUGHLY REVIEWED ALL PLANS AND OTHER DOCUMENTS AS
- APPROVED BY ALL OF THE PERMITTING AUTHORITIES.
- BEFORE BEGINNING EACH PHASE OF CONSTRUCTION.
- 5. THE CONTRACTOR IS RESPONSIBLE FOR THE PROTECTION OF ALL EXISTING UTILITIES DURING THE CONSTRUCTION OF THIS PROJECT.
- 6. IF CONTRACTOR FINDS A DISCREPANCY WITH THE TOPOGRAPHIC INFORMATION ON THESE PLANS, HE/SHE SHALL CONTACT THE CONSTRUCTION MANAGER/SUPERVISOR AND CIVIL ENGINEER IMMEDIATELY.
- 7. CONTRACTOR SHALL PROTECT ALL BENCHMARKS AND PROPERTY MONUMENTATION AND SHALL REPLACE OR REPAIR, AT HIS OWN EXPENSE, BENCHMARKS AND MONUMENTATION DISTURBED DURING CONSTRUCTION.
- 8. IF CONTRACTOR RELOCATES OR SETS NEW BENCHMARKS, THE VERTICAL ELEVATIONS OF THE BENCHMARKS SHALL BE SET TO A TOLERANCE OF 0.010
- 9. ALL DIMENSIONS SHOWN ARE TO FACE OF CURB, BUILDING FACE OF BRICK, STONE AND FACE OF WALLS, UNLESS OTHERWISE NOTED.
- 10. REFER TO ARCHITECTURAL/STRUCTURAL PLANS FOR DETAILED BUILDING DIMENSIONS.
- 11. ALL CURB RADII SHALL BE 3.0' UNLESS OTHERWISE NOTED.
- 12. THE AMERICANS WITH DISABILITIES ACT (ADA) GUIDELINES, BOTH FEDERAL AND STATE ARE TO BE INCORPORATED IN ALL CONSTRUCTION DOCUMENTS. IF ANY CRITERIA CANNOT BE MET THEN OWNER IS TO BE ALERTED OF THE CONDITION AND INFORMED OF THE MEASURES THAT WOULD BE NECESSARY TO BE IN CONFORMANCE.
- 13. ALL PEDESTRIAN RAMPS TO BE TEXTURED AND PAINTED/STAINED PER BEXAR COUNTY AND A.D.A. REQUIREMENTS, AS REQUIRED.
- 14. CONTRACTOR IS RESPONSIBLE FOR VERIFYING EXISTING UTILITIES, PAVEMENT AND STRUCTURES WITHIN OR AROUND THE PROPOSED BUILDING PAD LIMITS OF CONSTRUCTION. THE CONTRACTOR IS RESPONSIBLE FOR REMOVAL, RELOCATION AND COORDINATION OF THESE EXISTING UTILITIES, PAVEMENT AND STRUCTURES. CONTRACTOR SHALL CONTACT ENGINEER IF A CONFLICT EXISTS.
- 15. PROVIDE PAD CERTIFICATION FROM A LICENSED SURVEYOR AND SOIL COMPACTION DOCUMENTATION FROM A GEOTECHNICAL ENGINEER.
- 16. PUMPING RUNOFF OR RAINWATER FROM A BUILDING EXCAVATION IS NOT AN EXTRA PAY ITEM.
- 17. STANDARD PARKING SPACES ARE 9'x18' AND COMPACT ARE 8'x16' UNLESS OTHERWISE NOTED
- 18. REFER TO LANDSCAPE PLANS FOR SIDEWALK DETAILS.

9. CONTRACTOR IS RESPONSIBLE FOR PROTECTING ADJACENT FACILITIES FROM DAMAGE. 11. OVER-EXCAVATION IS NONCOMPENSABLE, AND SHALL BE BACKFILLED AND COMPACTED AS

SHALL BE MAINTAINED IN COMPLIANCE WITH ALL RELEVANT POLLUTION PREVENTION PLANS.

4. THE CONTRACTOR SHALL GIVE THE CITY A MINIMUM OF 48 HOURS NOTICE

### **PAVEMENT NOTES:**

1. DESIGN MIX SUBMITTALS SHALL BE PROVIDED FOR REVIEW AT LEAST 7 DAYS PRIOR TO PLACEMENT. 2. DO NOT UNLOAD OR USE ANY HEAVY CONSTRUCTION EQUIPMENT ON NEW CONCRETE FOR AT LEAST 72 HOURS AFTER CONCRETE IS POURED.

- 3. LOCATE AND PLACE LINES OR SLEEVES FOR UNDERGROUND UTILITIES PRIOR TO PLACEMENT OF PAVEMENT BASE.
- 4. JOINTS SHALL BE PLACED IN ANY PROPOSED CONCRETE PAVEMENT AND CURBING AS RECOMMENDED IN THE GEOTECHNICAL STUDY FOR THIS SITE OR JOINT LAYOUT AND DESIGN SHALL CONFORM TO THE AMERICAN CONCRETE PAVEMENT ASSOCIATION (ACPA) TECHNICAL PUBLICATION 150 61.01P.
- 5. CONTRACTOR IS RESPONSIBLE FOR COORDINATING WORK SUCH THAT UTILITIES ARE INSTALLED PRIOR TO PAVEMENT BASE IS INSTALLED OR ELSE PROVIDE ADEQUATE SLEEVING.
- 6. ALL CONCRETE WORK SHALL CONFORM TO ALL APPLICABLE REQUIREMENTS OF ACI 330. FLY ASH
- CAN BE USED IN MIX DESIGNS WHERE SUITABLE. 7. ALL CONCRETE PAVING AND FLATWORK SHALL BE CURED IN CONFORMANCE WITH AMERICAN CONCRETE PAVEMENT ASSOCIATION GUIDELINES.

## **PAVEMENT MARKINGS**

FURNISH AND INSTALL PAVEMENT MARKINGS OF THE TYPE AND SIZE SHOWN ON THE PLANS AND AS REQUIRED FOR COMPLIANCE WITH GOVERNING CODES. IF NO GOVERNING CODES APPLY, THEN USE TXDOT STANDARDS. EXECUTION:

- 1. CONTRACTOR SHALL CLEAN PAVEMENT OF GREASE, DIRT, OIL, SAND, GRAVEL OR OTHER FOREIGN MATERIALS PRIOR TO APPLYING MARKINGS AS RECOMMENDED BY PAINT MANUFACTURER.
- 2. PAVEMENT MARKINGS SHALL BE APPLIED BY MACHINE AT A RATE OF ONE (1) GALLON/100 SQUARE
- 3. PAVEMENT MARKINGS SHALL NOT BE APPLIED DURING PERIODS OF EXCESS HUMIDITY OR PAVEMENT TEMPERATURES BELOW 50 DEGREES F. 4. MINIMUM LINE WIDTH IS 4 INCHES. PAVEMENT MARKINGS MUST COMPLY WITH LOCAL FIRE
- STANDARDS AND CURRENT ACCESSIBILITY CODE. 5. A MINIMUM OF TWO COATS SHALL BE REQUIRED.
- 6. CLOSE AREAS TO TRAFFIC FOR DURATION OF DRYING TIME, WHICH SHALL BE NO LESS THAN THE
- MINIMUM RECOMMENDED BY THE PAINT MANUFACTURER. 7. TRAFFIC PAINT SHALL BE SHERWIN WILLIAMS PRO-MAR TRAFFIC PAINT OR APPROVED EQUAL -

### STORM SEWER NOTES:

COLOR AS SPECIFIED ON PLANS.


- 1. THE LOCATION OF UNDERGROUND UTILITIES SHOWN ON THIS PLAN ARE BASED ON FIELD SURVEYS AND LOCAL UTILITY COMPANY RECORDS. IT SHALL BE THE CONTRACTOR'S FULL RESPONSIBILITY TO CONTACT THE VARIOUS UTILITY COMPANIES TO LOCATE THEIR UTILITIES PRIOR TO STARTING CONSTRUCTION. (SEE SITE INFORMATION SHEET FOR UTILITY CONTACTS)
- 2. VERIFY ALL EXISTING INVERTS AND RIM ELEVATIONS PRIOR TO CONSTRUCTION. CONTACT ENGINEER WITH ANY DISCREPANCIES.
- 3. COMPLETE OR COORDINATE ADJUSTMENT OF OTHER UTILITIES IN ORDER TO CONSTRUCT STORM SEWER TO ELEVATIONS PROVIDED.
- 4. THE FOLLOWING STORM SEWER PIPES ARE ALLOWABLE (WITH MANUFACTURER'S SPECS FOR BACKFILL FOLLOWED):
- A. 12" THRU 48" RCP, D-LOAD DESIGN B. 6" THRU 12" PVC, SDR 35 OR SCH. 40
- C. 12" THRU 18" GALVANIZED CORRUGATED METAL (2-2/3"x 1/2" CORRUGATED) D. 12" THRU 48" "ULTRAFLO" SPIRAL RIB PIPE (AASHTO M-36 TYPE I.R. WITH GALVANIZED STEEL AS
- PER AASHTO M-218) E. 6" THRU 36", HDPE


NOTE

- A. OPTIONS C & D SHALL NOT BE USED ALONG COASTAL REGIONS OR AREAS WHERE THE EXISTING SOILS ARE CORROSIVE. B. THE ABOVE SHALL BE FOLLOWED UNLESS PIPES ARE TO BE INSTALLED IN PUBLIC ROW OR EASEMENT. IF PIPE IS PART OF PUBLIC SYSTEM, PIPE MATERIAL SHALL FOLLOW REQUIREMENTS OF AUTHORITY HAVING JURISDICTION. C. MANNING'S "N" VALVE SHALL BE 0.013 OR LESS.
- 5. ALL STORM SEWER INLETS/STRUCTURES SHALL BE PRE-CAST.
- 6. GRATE INLETS LOCATED IN THE PEDESTRIAN ACCESS ROUTE OR HIGH TRAFFIC AREAS SHALL BE ADA COMPLIANT
- 7. GROUT/FORM MANHOLE OR INLET TO PROVIDE FOR SMOOTH FLOW OF WATER.


## WATER AND WASTEWATER UTILITY NOTES


- 1. ALL WORK SHALL CONFORM WITH BEXAR COUNTY SPECIFICATIONS.
- 2. NOTIFY THE COUNTY OR TXDOT AT LEAST 48 HOURS PRIOR TO STARTING CONSTRUCTION. DISRUPTION OF SERVICES SHALL BE COORDINATED WITH THE OWNER AND UTILITY COMPANY. 3. COMPLETE ALL REQUIRED RELOCATIONS OR ALTERATIONS OF TELEPHONE POLES,
- UNDERGROUND CONDUIT, POWER POLES, AND ANY OTHER FACILITIES UNLESS NOTED AS "BY OTHERS". SCHEDULE AND COORDINATE HIS WORK WITH THAT OF OTHER CONTRACTORS AND UTILITY COMPANIES SO AS NOT TO DELAY THE PROJECT.
- 4. ALL PRIVATE WATER AND WASTEWATER LINES WILL COMPLY WITH THE INTERNATIONAL PLUMBING CODE. 5. ALL WATER PIPE 4"-12" SHALL BE CLASS 200 PVC C900 DR14 OR DUCTILE IRON (D.I.)
- CLASS 350 (IRRIGATION LINES AND DOMESTIC SERVICE LINES SHOULD BE SDR-21 RATED PIPE). ALL WATER PIPE 14"-36" SHALL BE CLASS 235 PVC 905 DR 18 OR DUCTILE IRON (D.I.) CLASS 250. ALL WATER PIPE LESS THEN 4" SHALL BE COPPER OR SCHEDULE 40
- 6. ALL PUBLIC MAIN WASTEWATER PIPE SHALL BE SDR 26 PVC., OR PRESSURE RATED PIPE WHERE REQUIRED. SERVICE LATERALS SHALL BE SCHEDULE 40 PVC.
- 7. INSTALL MECHANICAL JOINT (M.J.) FITTINGS ON DUCTILE IRON (D.I.) PIPE OR PVC C900 DR14 PIPE OR C905 DR 18 PIPE.
- 8. RESTRAINED JOINTS SHALL BE INSTALLED ON ALL WATER PIPE 6" AND LARGER.
- 9. ALL WATER MAINS SHALL BE BURIED MIN. 3'.
- 10. WHERE PUBLIC WATER AND SANITARY SEWER LINES ARE INSTALLED WITH A SEPARATION DISTANCE CLOSER THAN NINE FEET THE INSTALLATION MUST MEET THE REQUIREMENTS OF 30 TAC 217.53 (DESIGN CRITERIA FOR DOMESTIC WASTEWATER SYSTEMS) OR 30 TAC 290.44(E) (WATER HYGIENE). CONCRETE ENCASE ALL WATER LINES THAT CROSS WITHIN 1.5 FEET OF WASTEWATER LINE.
- 11. FOR PRESSURE TAPS, FURNISH, INSTALL AND AIR TEST THE SLEEVE AND VALVE. CONCRETE BLOCKING SHALL BE PLACED BEHIND AND UNDER ALL TAP SLEEVES TWENTY-FOUR (24) HOURS PRIOR TO MAKING THE WET TAP.
- 12. SEE MECHANICAL PLANS FOR EXACT LOCATION OF WATER AND WASTEWATER CONNECTIONS TO BUILDINGS.
- 13. ALL ON-SITE WATER AND WASTEWATER LINES WILL BE EXTENDED TO A MINIMUM OF 5 FEET FROM THE BUILDING.
- 14. ALL BACKFLOW DEVICES WILL CARRY A MANUFACTURER RATING NOT TO EXCEED A 7 P.S.I. PRESSURE DROP THROUGH BACKFLOW DEVICE.
- 15. PROTECT EXISTING STRUCTURES FROM DAMAGE DURING CONSTRUCTION. PRIOR TO THE FINAL ACCEPTANCE OF THE PUBLIC MAINS EXISTING STRUCTURES WILL BE INSPECTED FOR DAMAGE AND THE CONTRACTOR WILL BE RESPONSIBLE FOR REPAIRING ANY DAMAGE. 16. EXTEND ALL EXISTING AND PROPOSED UTILITY MANHOLES, BOXES, COVERS, ETC.
- TO PROPOSED FINISH GRADE, UNLESS APPROVED OTHERWISE. 17. ALL MAINS SHALL BE TESTED BY THE CONTRACTOR AS REQUIRED BY AUTHORITIES.
- THE ENGINEER OR INSPECTOR SHALL BE PRESENT DURING THE TEST. 18. ALL WATER MAINS SHALL BE CHLORINATED AS REQUIRED BY AUTHORITIES.

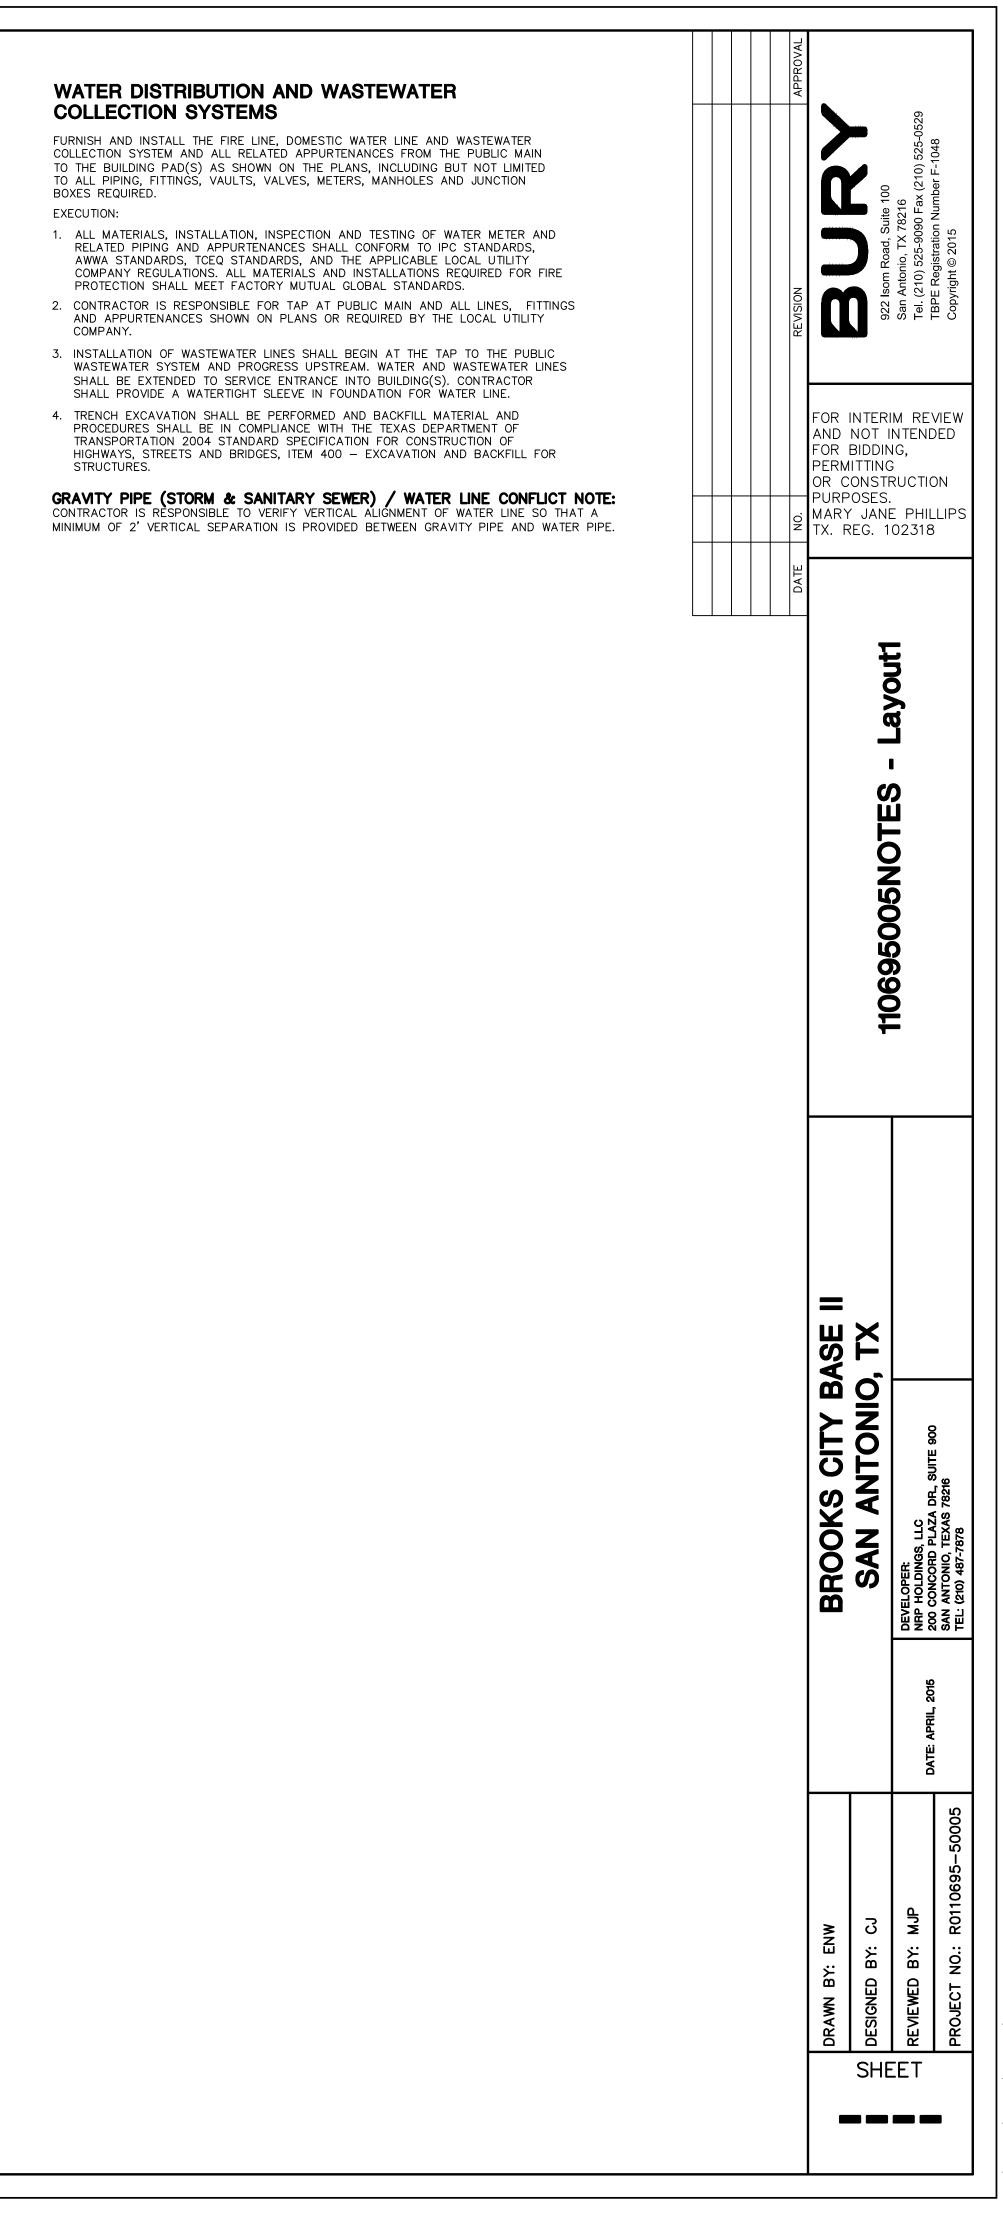


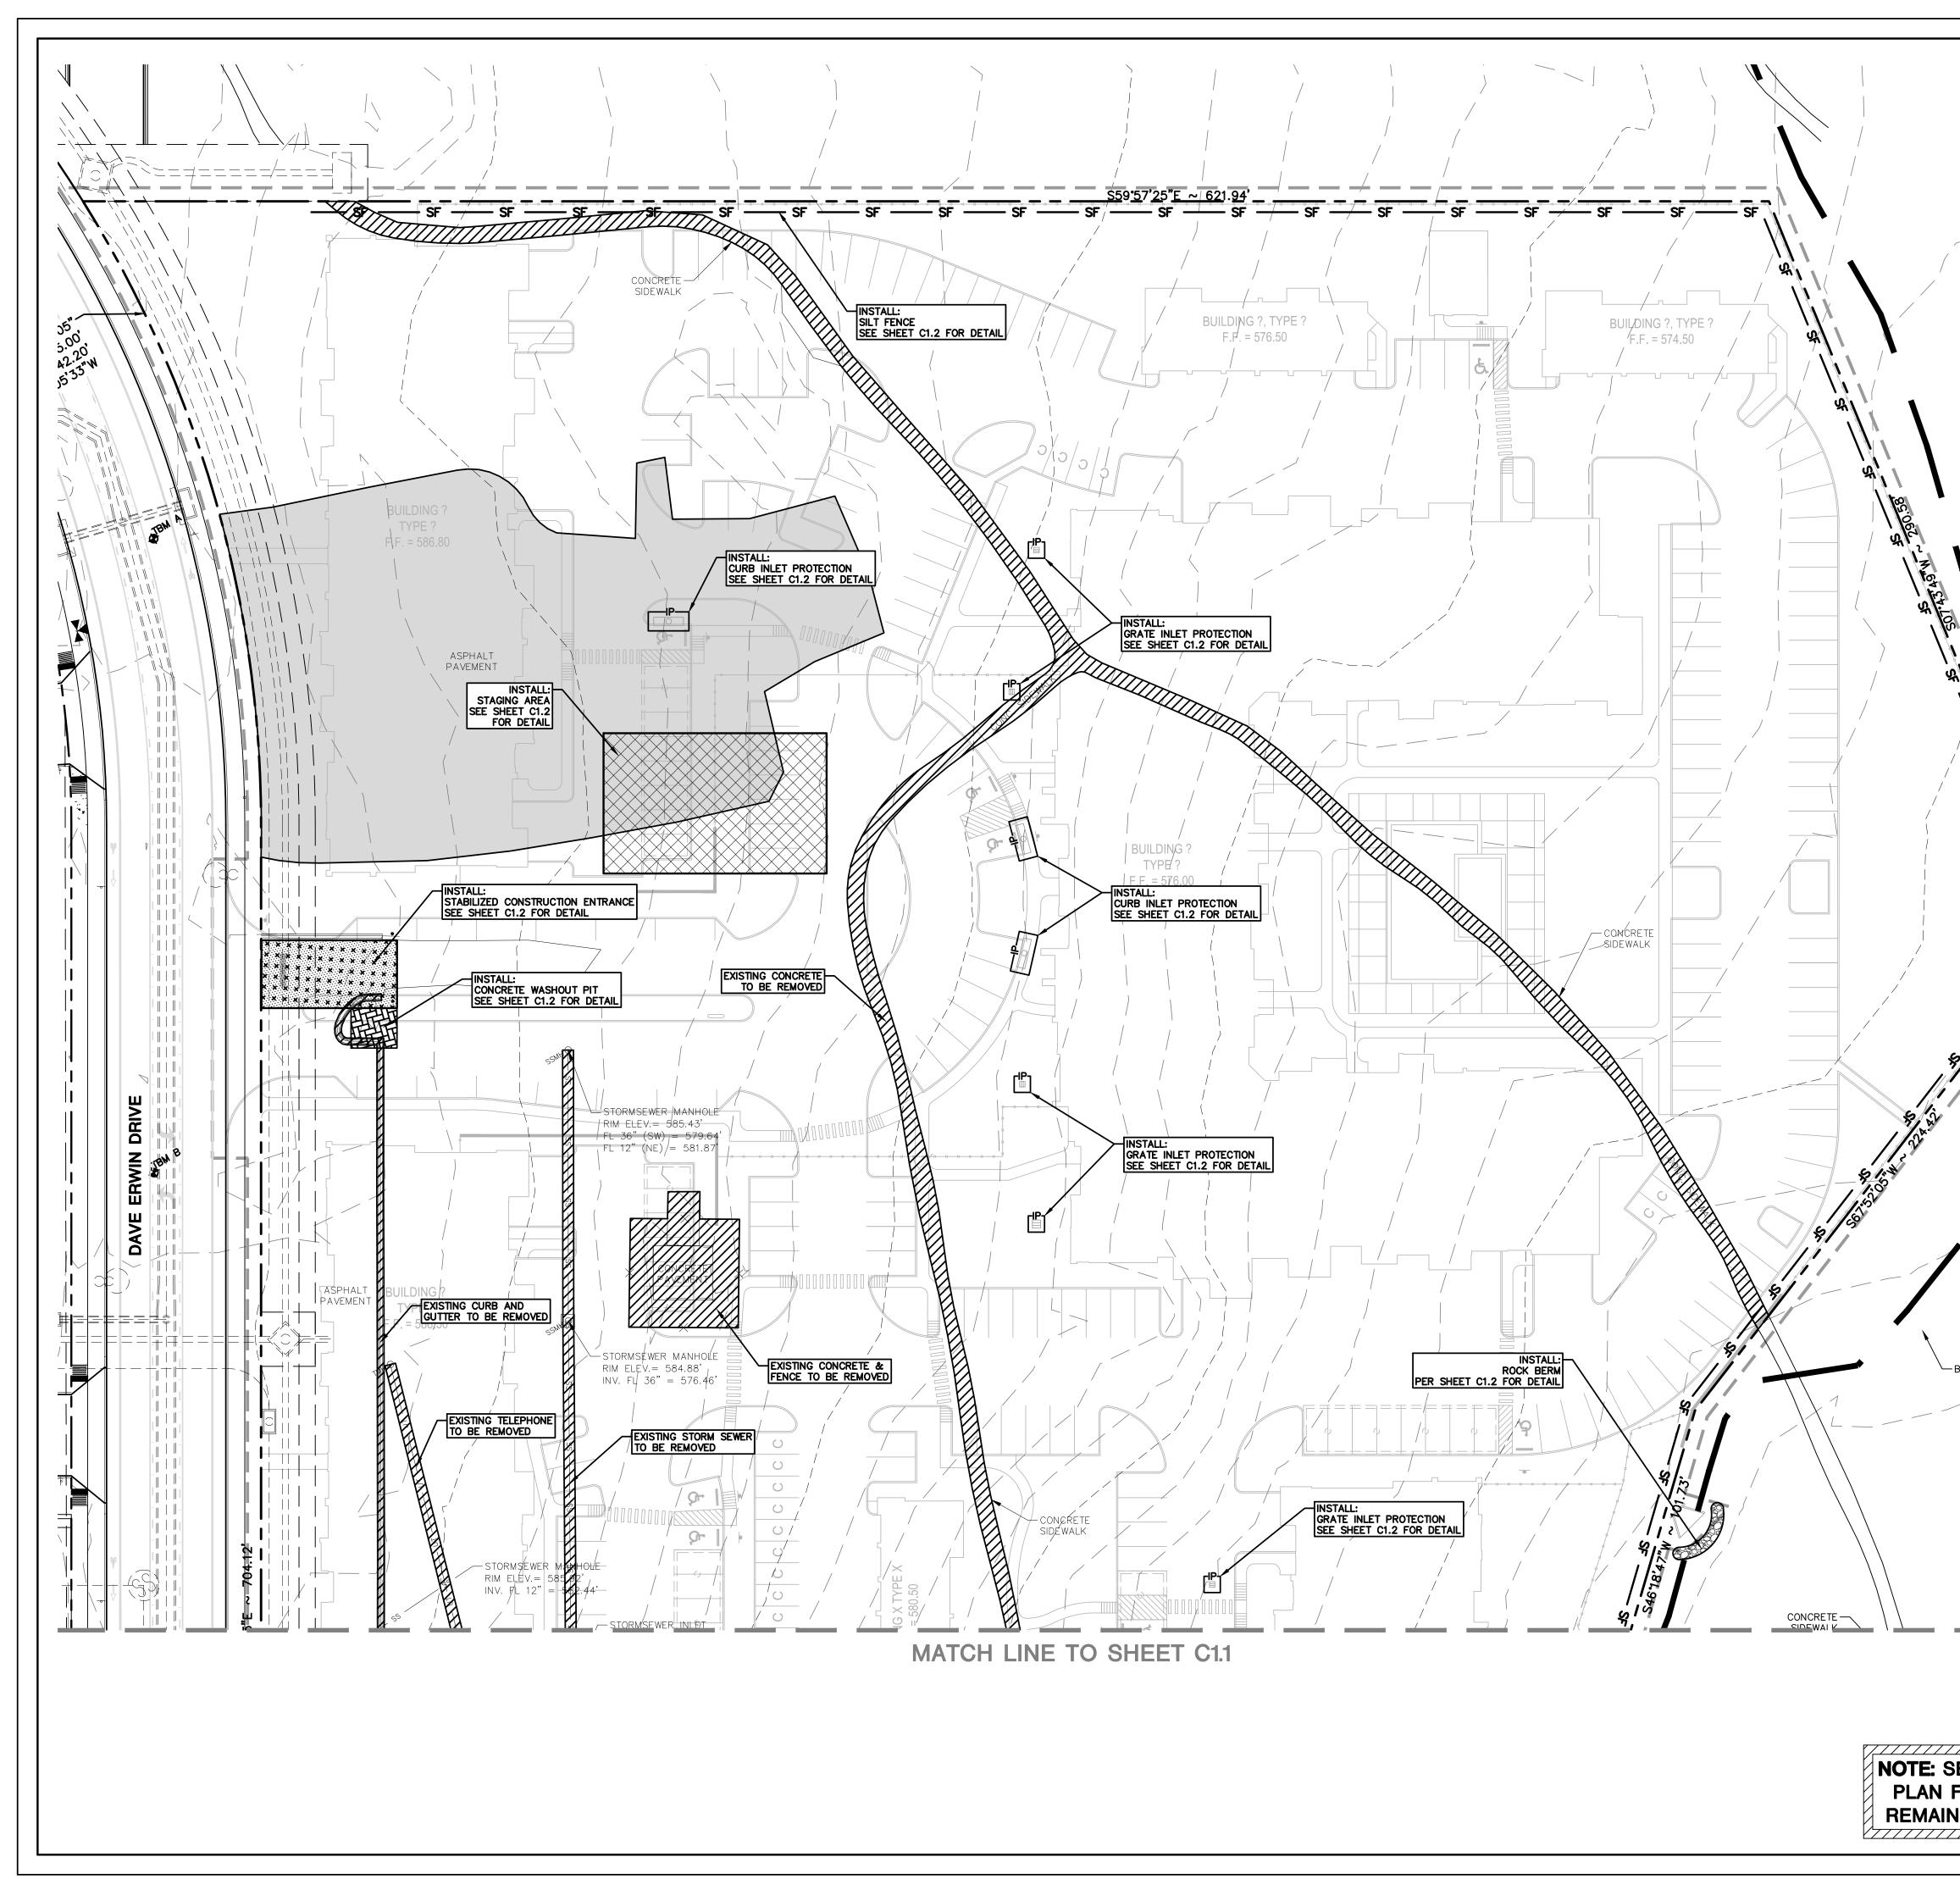

	LEGEND	ED	APROVAL		
	$\begin{array}{c} \bullet \\ \bullet $	1/2" IRON ROD FOUND 1/2" IRON ROD SET IRON PIPE FOUND BENCHMARK FIRE DEPARTMENT CONNECTION LIGHT POLE POWER POLE DOWN GUY FIRE HYDRANT WATER VALVE WATER METER GAS METER GAS VALVE WASTEWATER MANHOLE STORMSEWER MANHOLE DRAINAGE INLET STAND UP CURB HANDICAPPED PARKING SPACE SIGN TRANSFORMER PAD ELECTRIC METER OVER HEAD ELEC. LINE STORM SEWER LINE WATER LINE FIRE WATER LINE	NO. NO.	FOR INTERIAND NOT I FOR BIDDIN PERMITTING OR CONSTE PURPOSES.	M REVIEW NTENDED IG, RUCTION E PHILLIPS
		FIRE WATER LINE DOMESTIC WATER LINE LANDSCAPE WATER LINE WASTEWATER LINE UNDERGROUND ELECTRIC UNDERGROUND TELEPHONE GAS LINE PROPERTY LINE CONTOUR SPOT ELEVATION FLOW DIRECTION CONCRETE SURFACE RETAINING WALL LIMITS OF CONSTRUCTION TO BE REMOVED SILT FENCE (SEE DETAIL C1.2.1) TREE PROTECTION (SEE DETAIL C1.2.8) INLET PROTECTION (SEE DETAIL C1.2.4 & C1.2.5) STABILIZED CONSTRUCTION ENTRANCE (SEE DETAIL C1.2.3) STAGING AREA (SEE DETAIL C1.2.7) CONCRETE TRUCK WASHOUT PIT (SEE DETAIL C1.2.6) ROCK BERM (SEE DETAIL C1.2.2) TREE TO BE REMOVED		EXISTING CONDITIONS,	<b>4</b>
BIRD HOUSE	SHOWN IN AN A SHALL DETERMIN UTILITIES BEFOR FULLY RESPONSI MIGHT BE OCCAS	0 15 30 60 1" = 30' 0 15 $30$ 60 1" = 30' 0 $15$ $1000000000000000000000000000000000000$	ARE ACTOR TING O BE ICH LOCATE	BROOKS CITY BASE II SAN ANTONIO, TX	DATE: APRIL, 2015 DATE: APRIL, 2015 SAN ANTONIO, TEXAS 78216 TEL: (210) 487-7878
SEE TREE PRESERVATION FOR LIST OF TREES TO N AND/OR BE REMOVED.	CITY BLOCK 1087 OF A 1308.68 AC PAGES 934-972 COUNTY, TEXAS, ABSTRACT 670, C		LAND OUT ILUME 9481, F BEXAR NUMBER 26, OCK 10879,	DRAWN BY: ENW HE DESIGNED BY: CJ	H REVIEWED BY: MJP PROJECT NO.: R0110695-50005

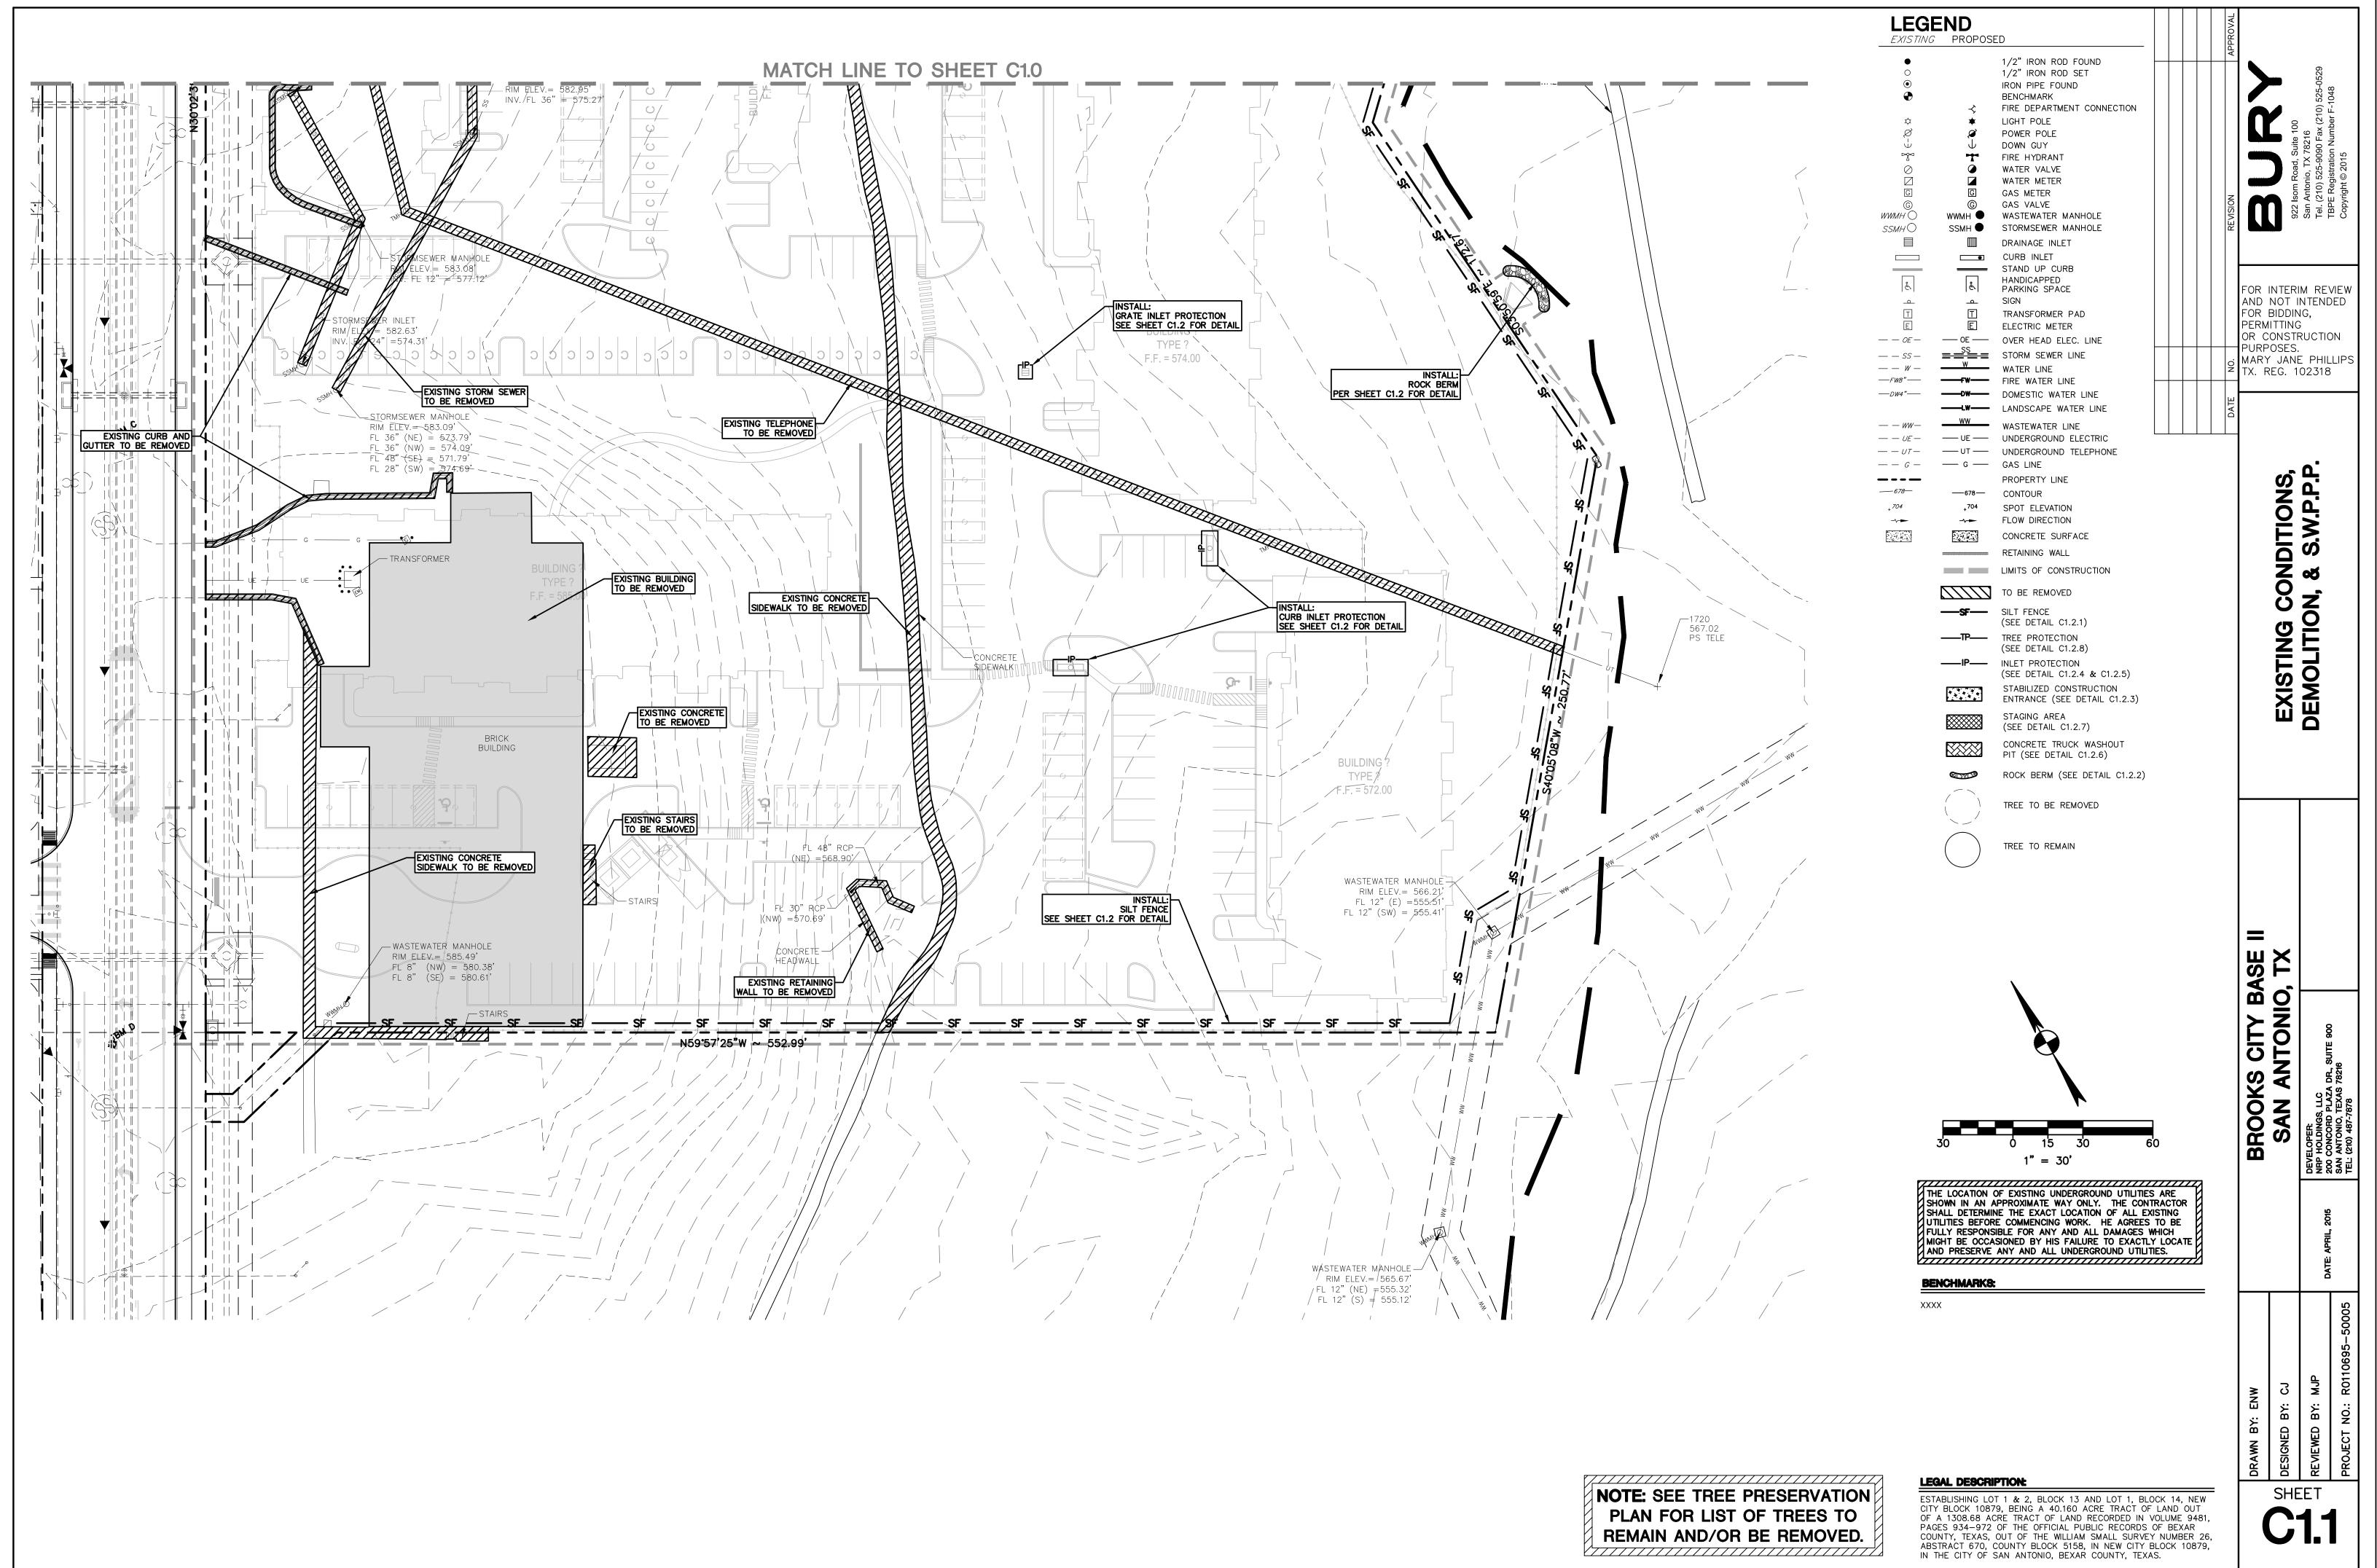

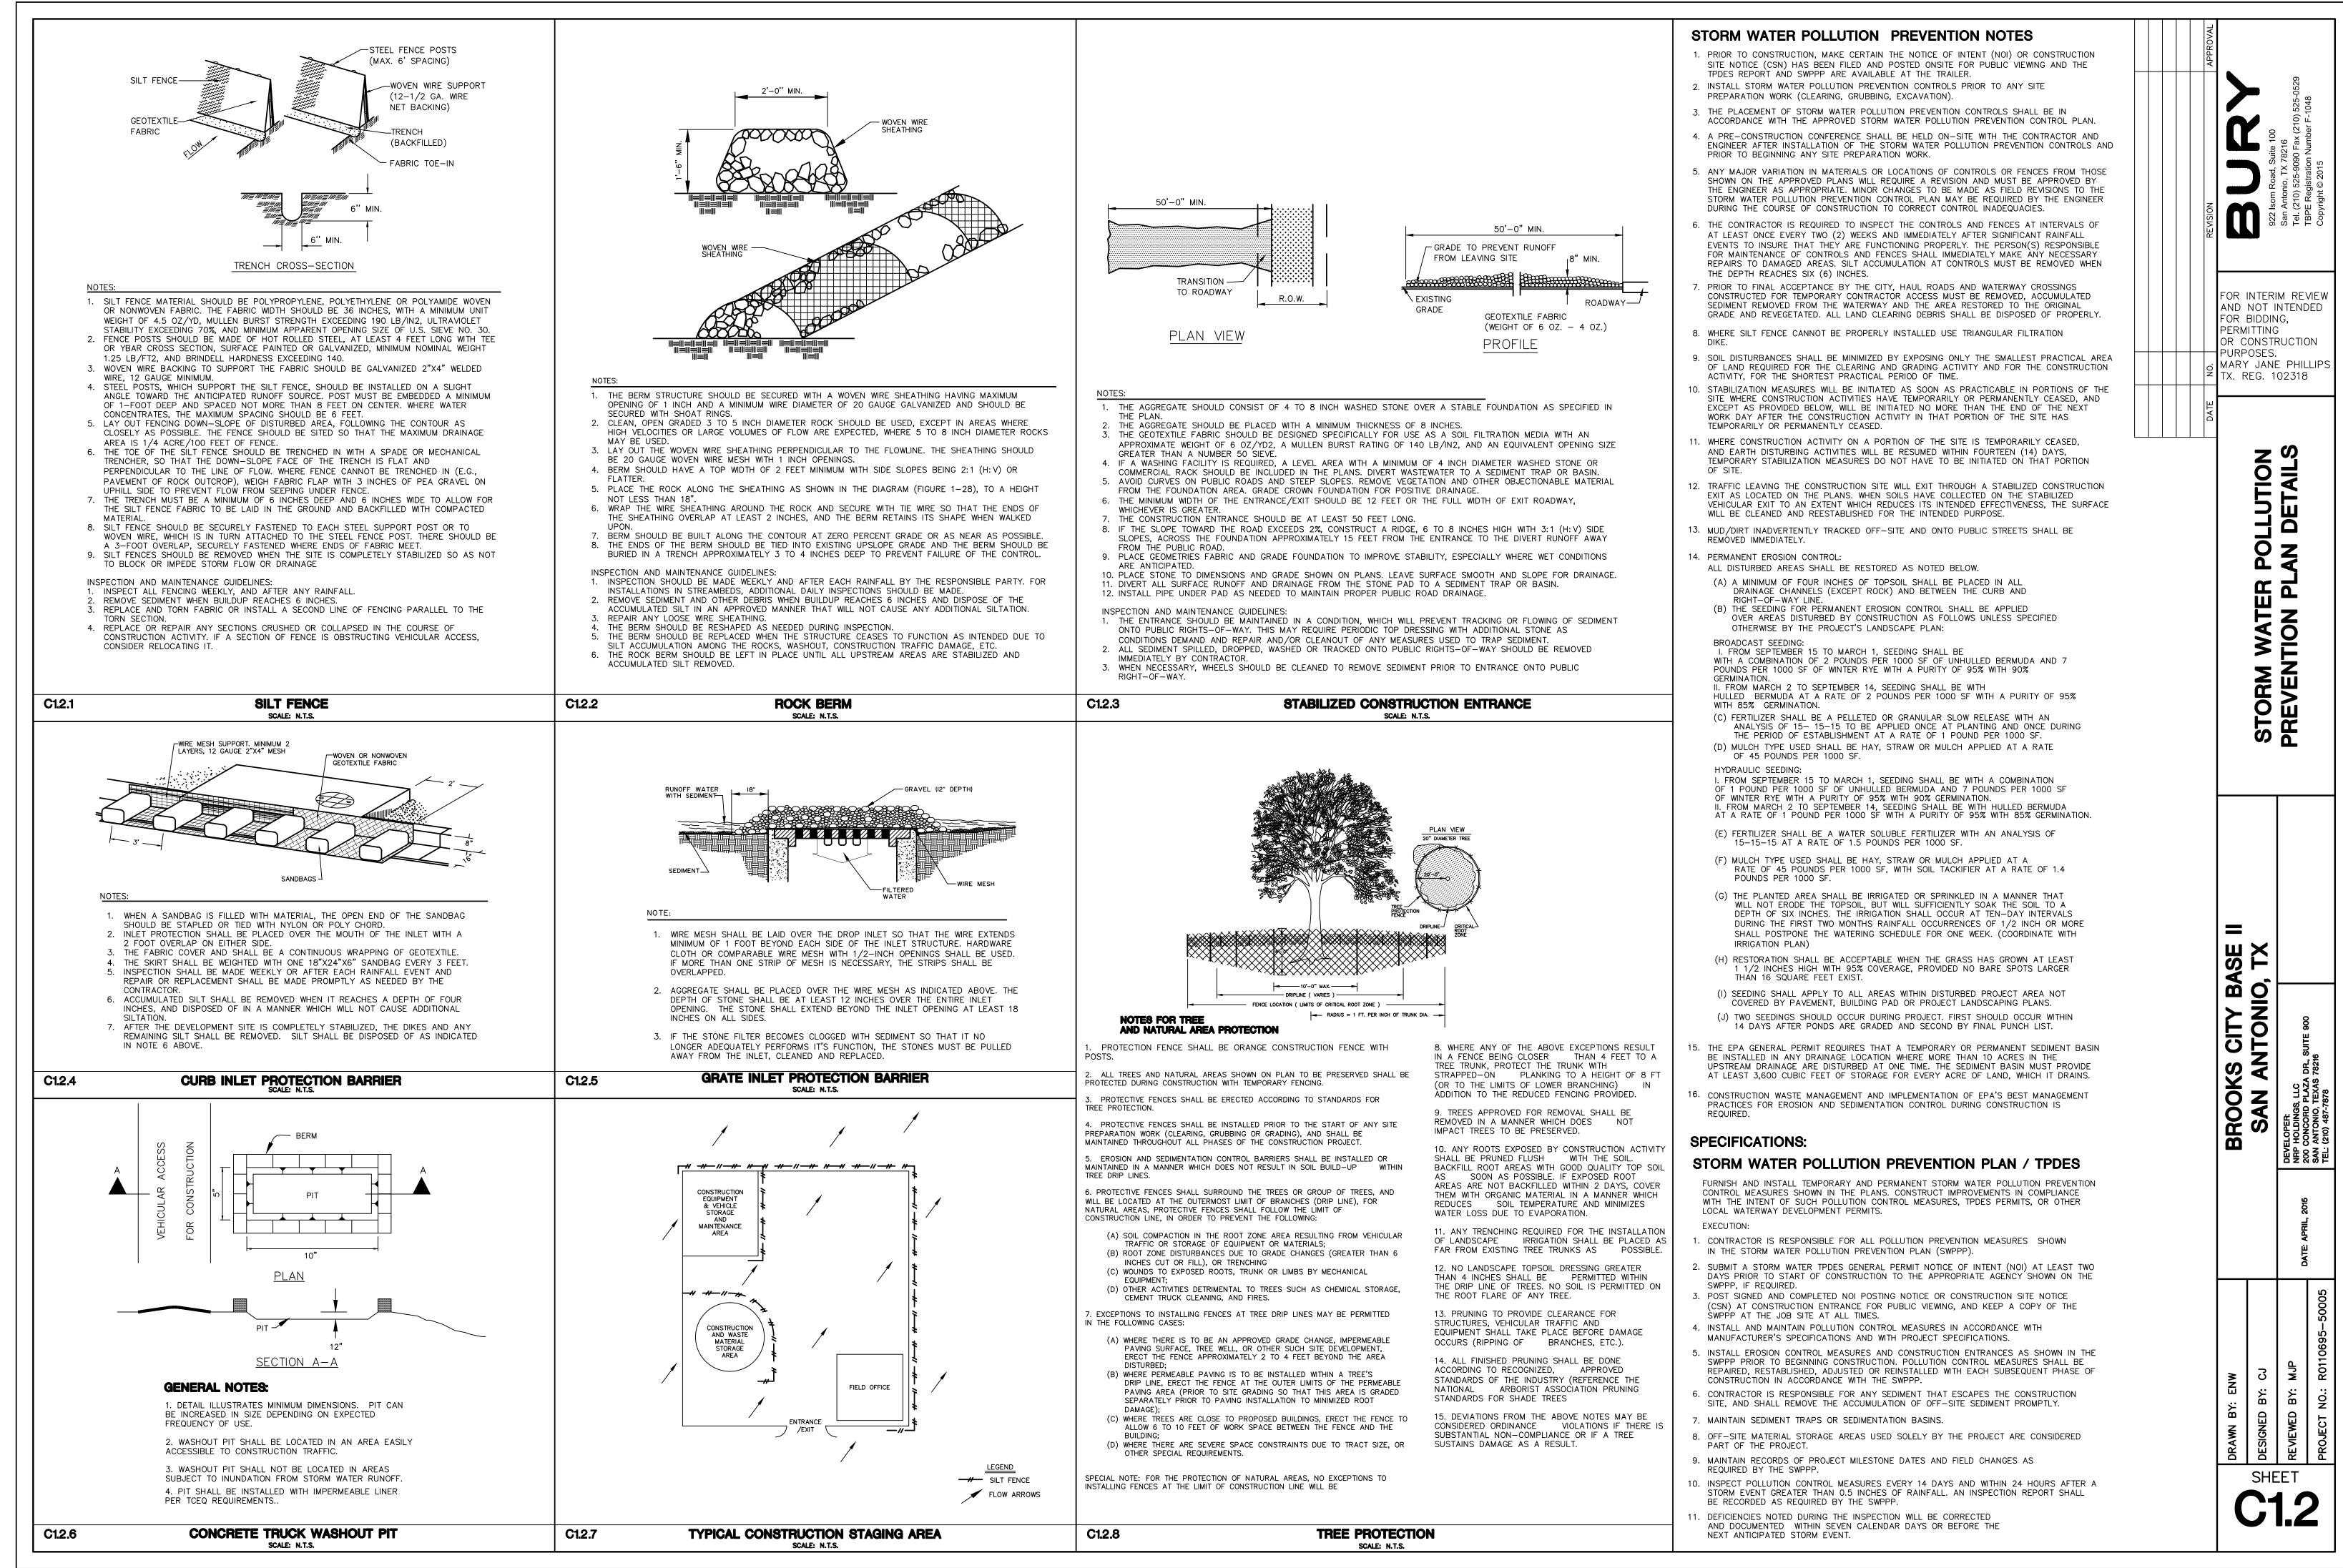


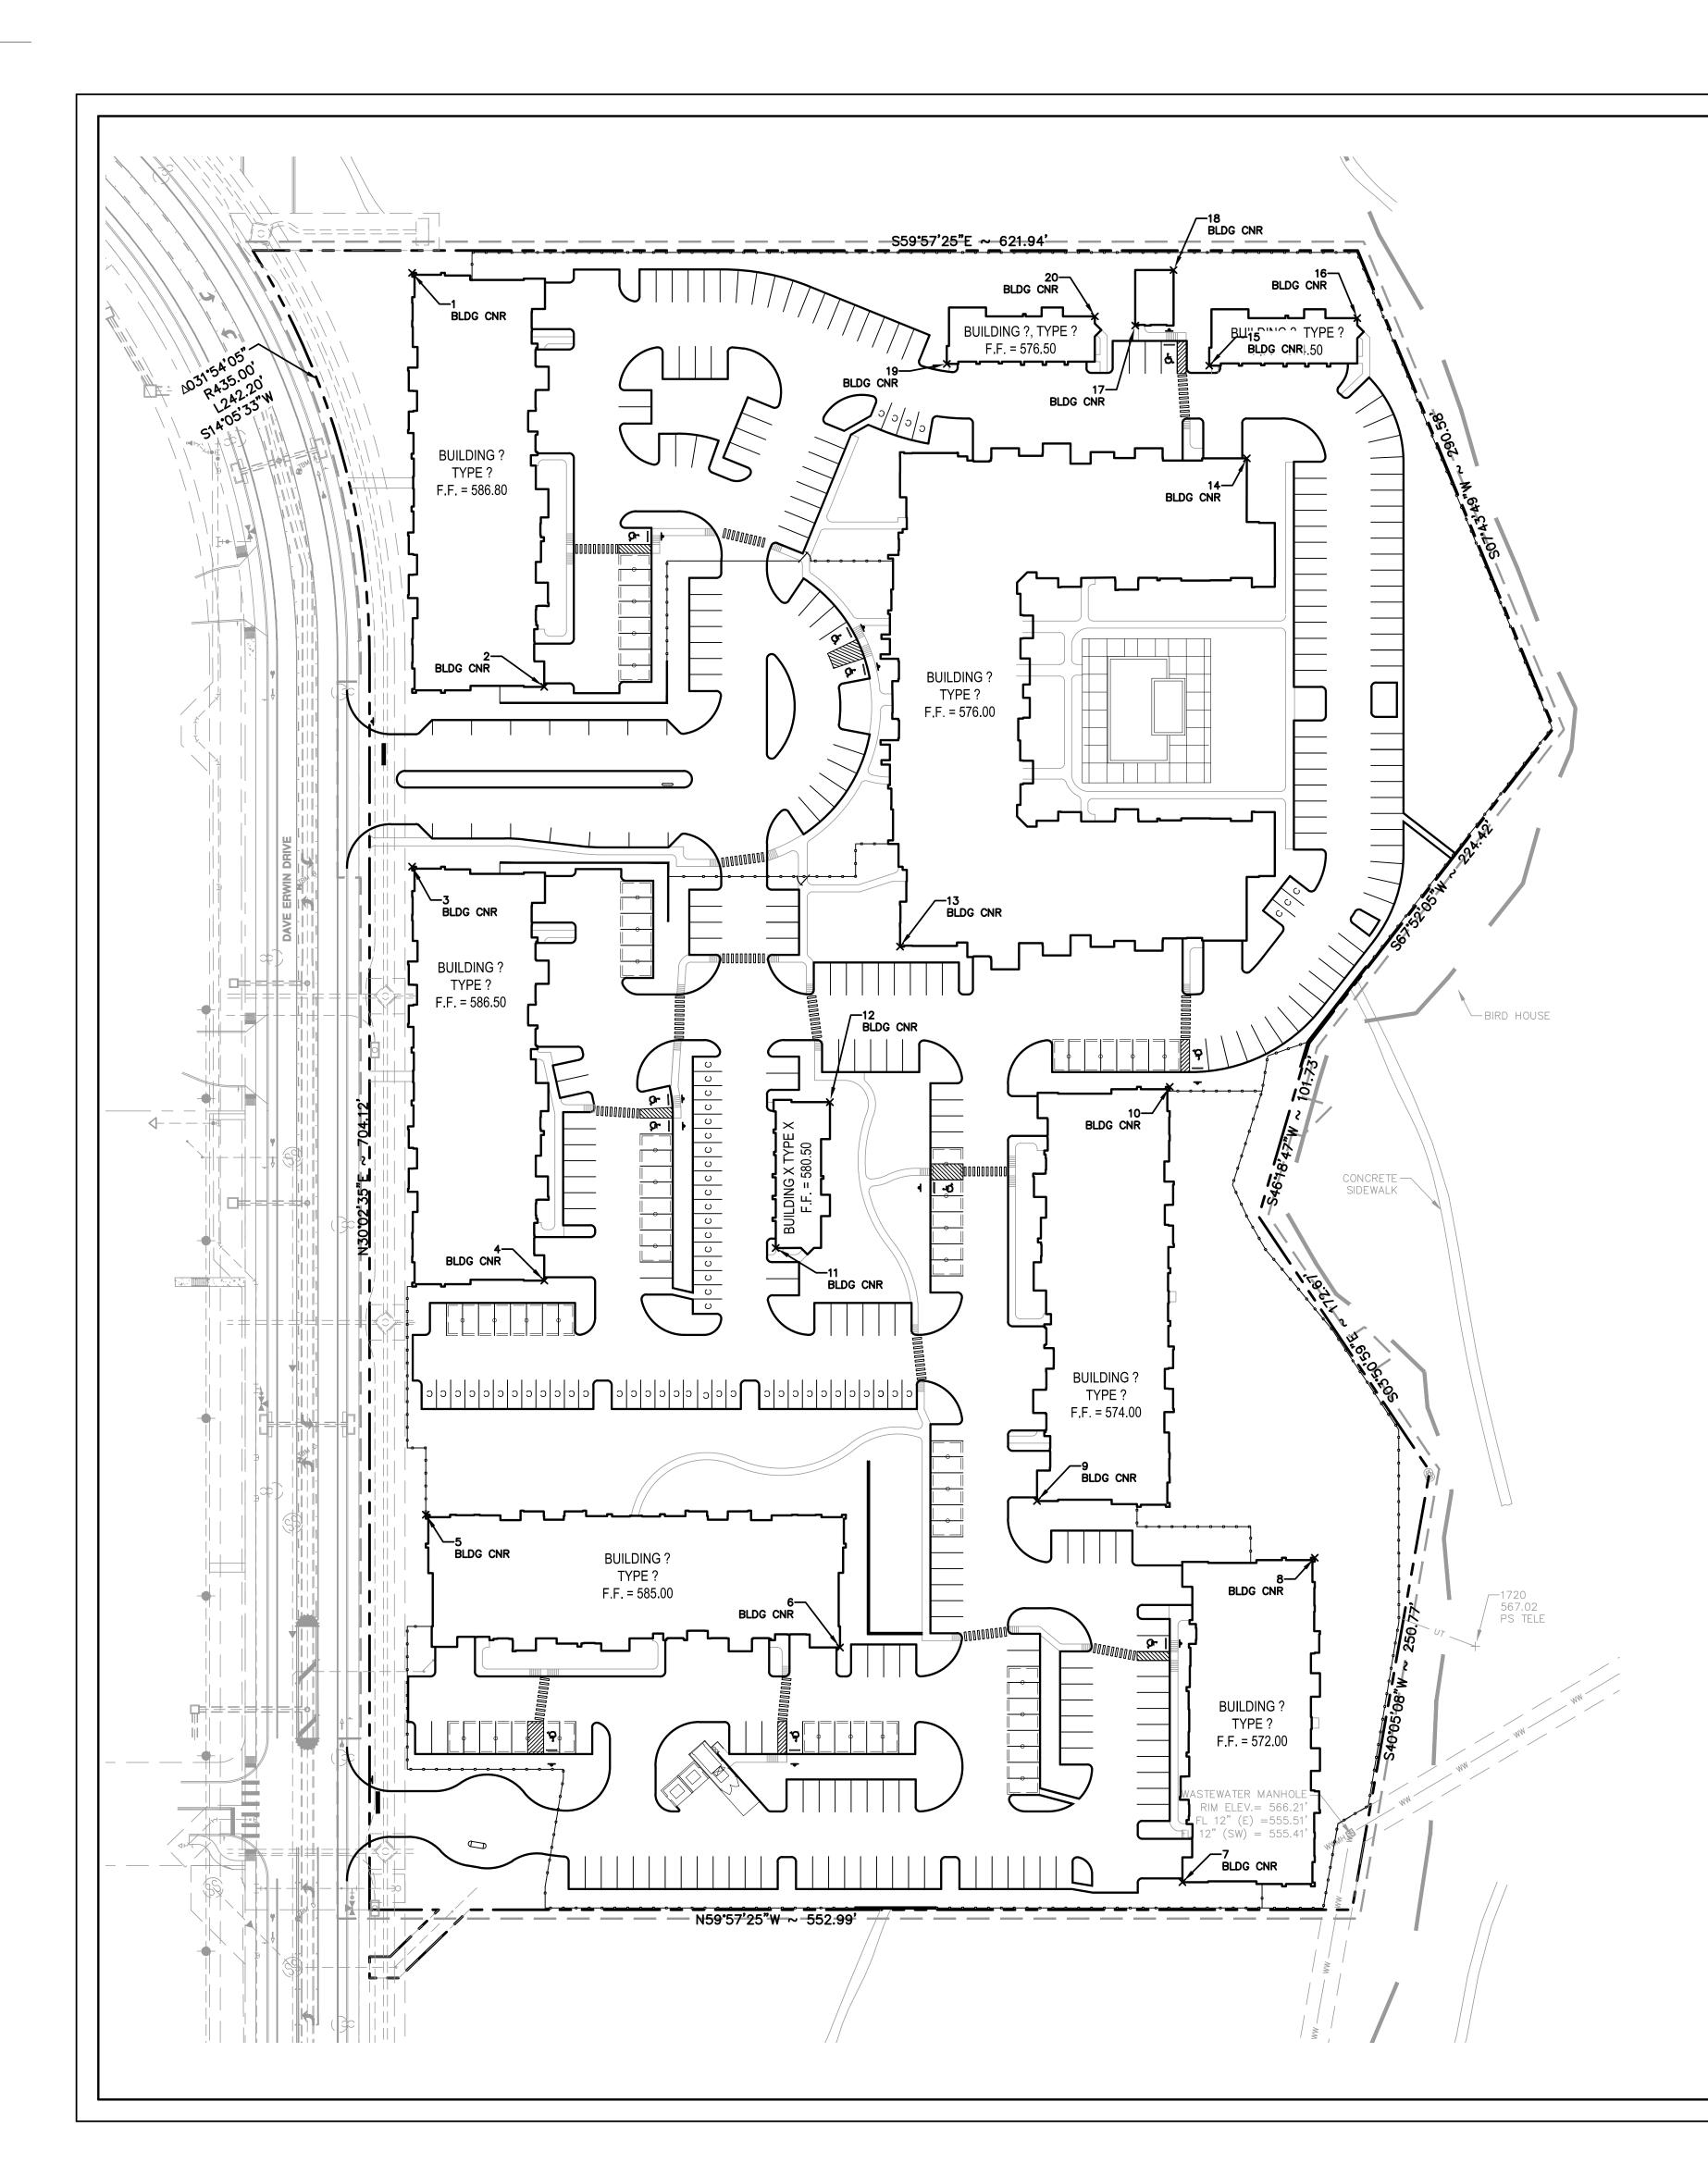


	CONTROL POINTS						
POINT #	DESCRIPTION	NORTHING	EAS				
1	BLDG CNR	677174.9084	14359				
2	BLDG CNR	676935.9399	14353				
3	BLDG CNR	676885.5381	14342				
4	BLDG CNR	676646.5696	14337				
5	BLDG CNR	676565.8785	14324				
6	BLDG CNR	676384.4756	14341				
7	BLDG CNR	676173.6153	14351				
8	BLDG CNR	676294.4478	14366				
9	BLDG CNR	676400.3672	14354				
10	BLDG CNR	676564.7590	14373				
11	BLDG CNR	676597.2713	14349				
12	BLDG CNR	676653.0683	14356				
13	BLDG CNR	676709.0930	14363				
14	BLDG CNR	676849.3196	14394				
15	BLDG CNR	676905.0752	14395				
16	BLDG CNR	676886.5250	14403				
17	BLDG CNR	676945.4472	14392				
18	BLDG CNR	676961.7046	14396				
19	BLDG CNR	676979.8683	14382				
20	BLDG CNR	676961.3181	14391				

40

BUILDING USE	MUL'
NUMBER OF UNITS	XX
	TOTAL
REGULAR	
ACTUAL/PROPOSED PARKING	
MAXIMUM COMPACT SPACES (10%)	
COMPACT SPACES PROPOSED	
HANDI-CAPPED SPACE(ADA)	
REQUIRED H.C. PARKING	
REQUIRED V.A. PARKING	
PROPOSED H.C. PARKING	
PROPOSED V.A. PARKING	

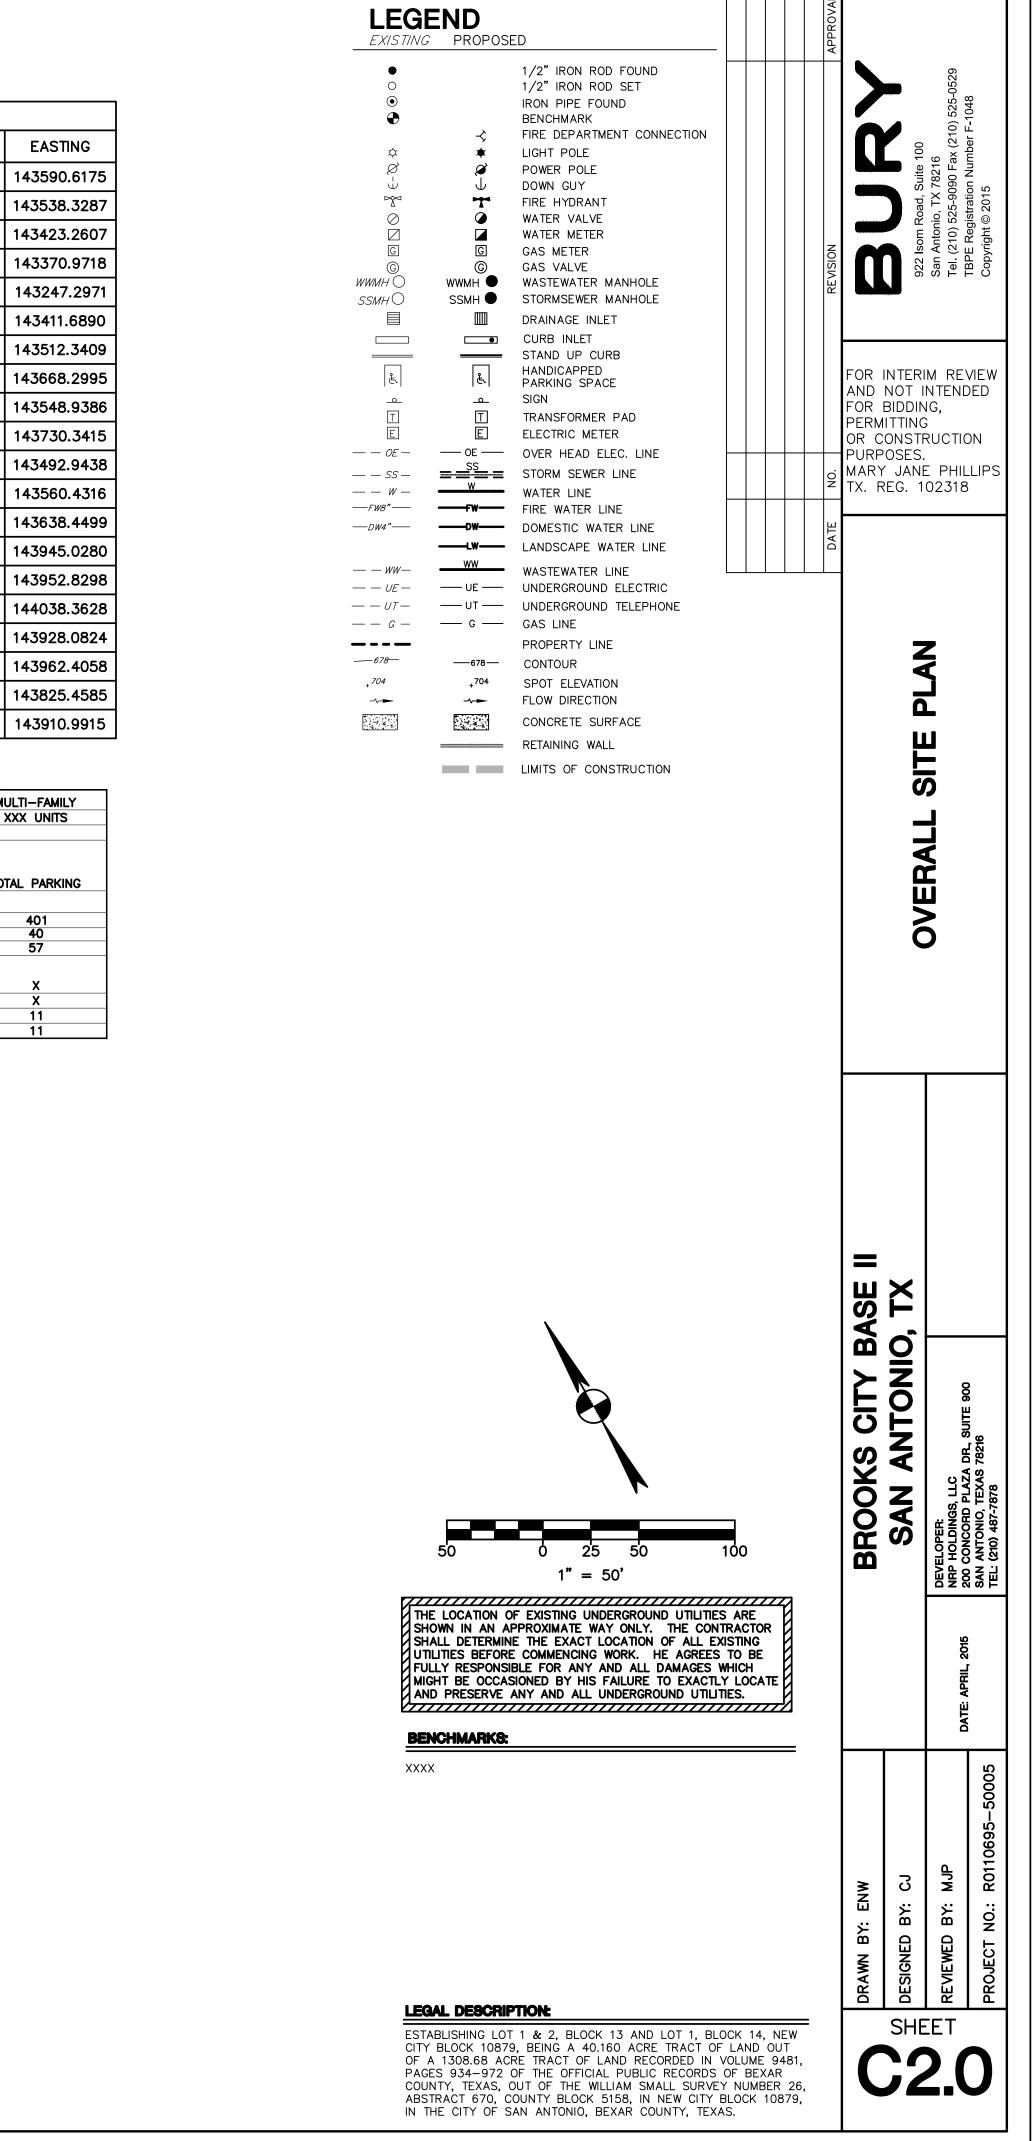

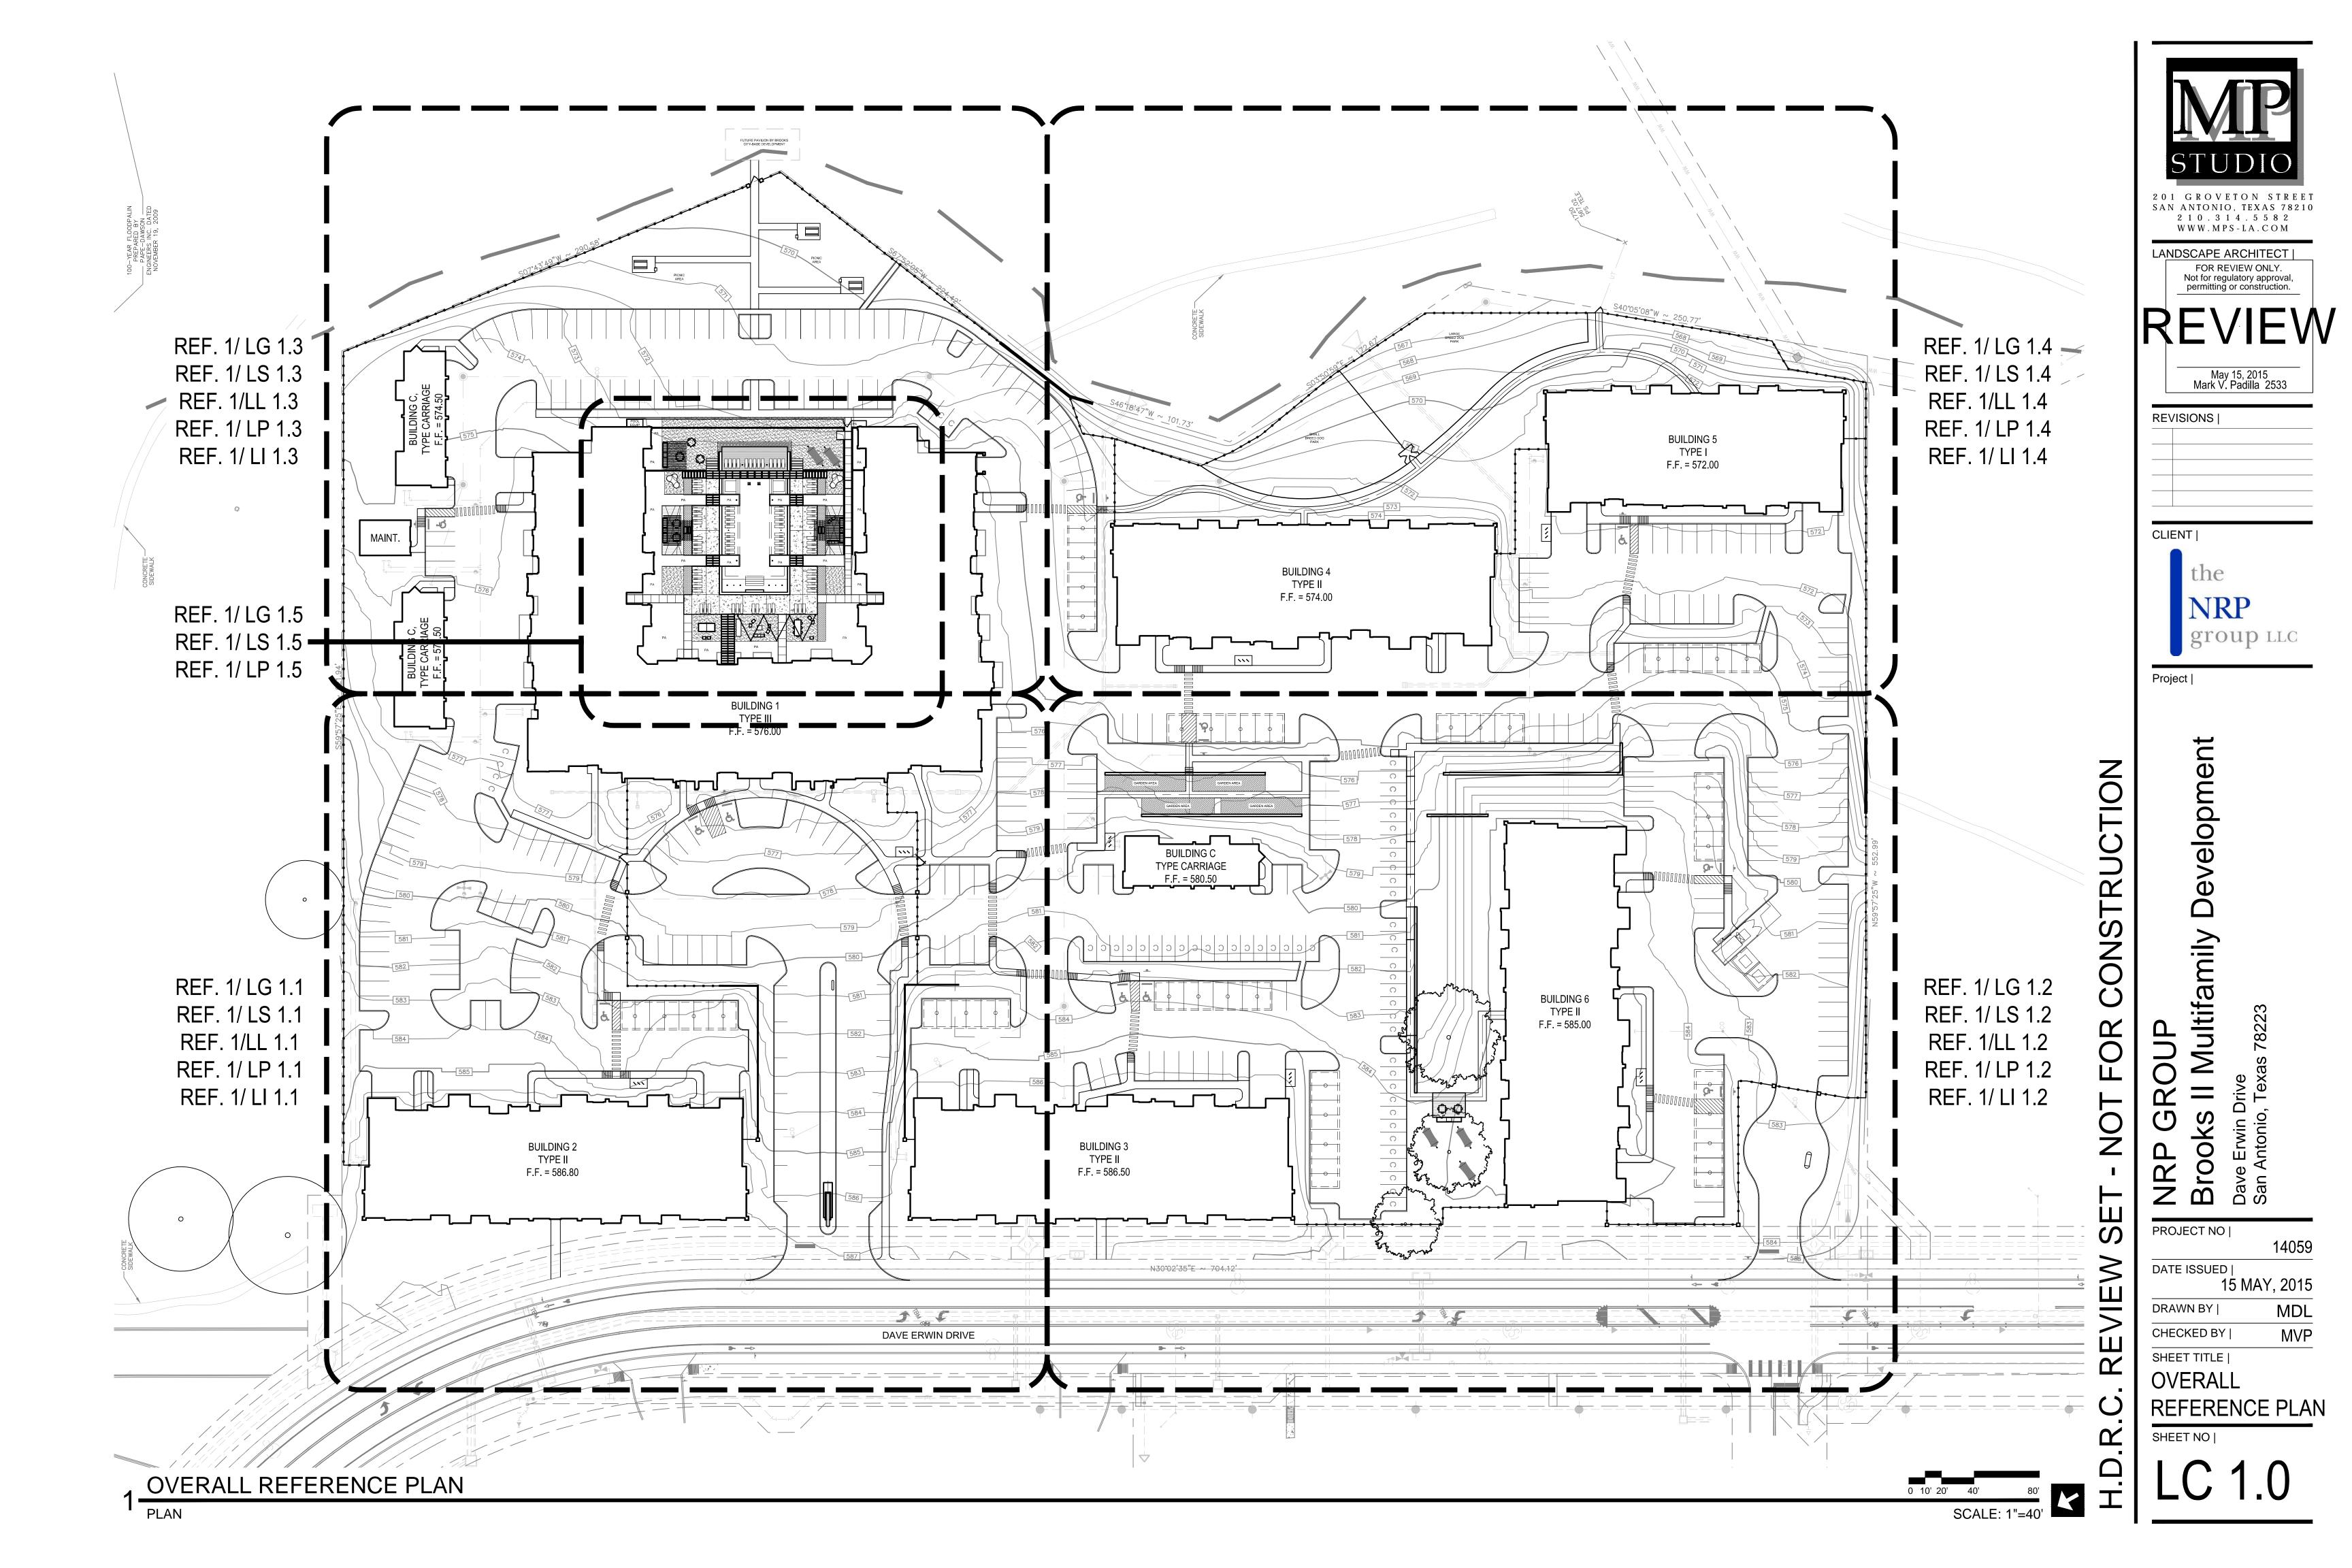

## **GENERAL NOTES:**

1.) LOCATE AND VERIFY THE CONDITION OF EXISTING UTILITIES PRIOR TO EXCAVATION. TAKE RESPONSIBILITY OF CONTACTING LINE LOCATION SERVICES AND ANY COST INCURRED FOR BODILY INJURY AND / OR DAMAGE OF OWNER'S PROPERTY OR SAID UTILITIES.

2.) THE LANDSCAPE ARCHITECT SHALL BE NOTIFIED BY THE CONTRACTOR OF ANY DISCREPANCIES DISCOVERED BETWEEN THE PLANS AND ACTUAL SITE CONDITIONS BEFORE PROCEEDING WITH THE WORK. THE CONTRACTOR SHALL BE LIABLE FOR ALL MODIFICATIONS AND DAMAGES IF WORK PROCEEDS WITHOUT THIS NOTIFICATION.

3.) THE CONTRACTOR IS RESPONSIBLE FOR ALL ASPECTS OF MAINTAINING A SAFE WORK SITE INCLUDING, BUT NOT LIMITED TO PROVIDING FOR TRAFFIC CONTROL, INSTALLATION AND PLACEMENT OF FENCING AND BARRICADES, EXCAVATION AND TRENCH PROTECTION, AND COMPLIANCE WITH ALL FEDERAL AND LOCAL REGULATIONS AND CODES. ALL SAFETY EXPOSURES OR VIOLATIONS SHALL BE RECTIFIED IMMEDIATELY.

4.) THE CONTRACTOR IS RESPONSIBLE FOR PROTECTION OF ALL EXISTING IMPROVEMENTS BOTH ON SITE AND ADJACENT TO THE WORK SITE AND SHALL REPAIR ANY DAMAGE TO THESE IMPROVEMENTS TO THE SATISFACTION OF THE OWNER.

5.) THE CONTRACTOR SHALL NOTIFY OWNER AND LANDSCAPE ARCHITECT 48 HOURS PRIOR TO COMMENCEMENT OF WORK TO COORDINATE PROJECT INSPECTION SCHEDULES.

6.) ANY ALTERNATES AND OR SUBSTITUTIONS PROPOSED BY THE CONTRACTOR SHALL BE SUBMITTED TO THE LANDSCAPE ARCHITECT FOR APPROVAL. CHANGES TO THE SCOPE OF WORK AND / OR CONTRACT DOCUMENTS RESULTING FROM THE ACCEPTANCE OF THE CONTRACTOR'S ALTERNATES AND / OR SUBSTITUTIONS SHALL BE THE RESPONSIBILITY OF THE CONTRACTOR.

7.) THE CONTRACTOR IS RESPONSIBLE FOR REMOVAL OF TRASH ON A DAILY BASIS.

8.) THE CONTRACTOR SHALL COMPLY WITH ALL APPLICABLE CODES, REGULATIONS AND ORDINANCES. PRIOR TO CONSTRUCTION, ALL PERMITS AND APPROVALS REQUIRED FOR CONSTRUCTION OF THE PROJECT SHALL BE PAID FOR AND OBTAINED BY THE CONTRACTOR (PLAN REVIEW FEES ARE PAID BY OWNER) COSTS FOR PERMITS SHALL BE INCLUDED IN THE BID. IT IS THE CONTRACTOR'S RESPONSIBILITY TO BECOME AWARE OF REQUIRED INSPECTIONS THAT ARE ASSOCIATED WITH PERMITS ISSUED FOR THE WORK AND TO SCHEDULE THESE INSPECTIONS AT THE APPROPRIATE STAGE OF CONSTRUCTION. EXAMPLES INCLUDE BUT ARE NOT LIMITED TO ROUGH-IN ELECTRICAL, ROUGH-IN PLUMBING, IRRIGATION PIPING, FOUNDATION STEEL FOR STRUCTURES (INCLUDING WALLS), FIRE INSPECTIONS RELATED TO ENTRY GATES AND ASSOCIATED STRUCTURES AND OTHERS AS MAY APPLY.

9.) COORDINATE WORK WITH SUBCONTRACTORS TO ACCOMPLISH THE SCOPE OF WORK AS SHOWN AND NOTED IN THE CONTRACT DOCUMENTS AS WELL AS, COORDINATE CONSTRUCTION WITH OTHER CONTRACTORS WORKING ON THE SITE.

10.) THE CONTRACTOR SHALL COORDINATE THE STORING OF MATERIALS, PARKING OF VEHICLES, AND RESTRICTIONS OF WORK AND ACCESS WITH THE OWNER. UNDER NO CIRCUMSTANCES SHALL ANY CONTRACTOR STORE MATERIALS, PARK VEHICLES OR EQUIPMENT UNDER THE CANOPY OF EXISTING TREES.

11.) UNLESS SPECIFIED OTHERWISE, THE CONTRACTOR IS RESPONSIBLE FOR PROVIDING AND PAYING ALL TEMPORARY UTILITIES AND SERVICES NECESSARY TO COMPLETELY INSTALL ALL WORK AS SHOWN AND NOTED IN THE CONTRACT DOCUMENTS.

12.) THE CONTRACTOR IS RESPONSIBLE FOR THE LEGAL OFF-SITE DISPOSAL OF SURPLUS MATERIAL AND DEBRIS.

13.) UPON COMPLETION OF CONSTRUCTION AND PRIOR TO FINAL APPROVAL, THE CONTRACTOR SHALL THOROUGHLY CLEAN THE PROJECT SITE OF ALL TRASH, REPAIR ALL DAMAGE TO FINISH GRADE, INCLUDING TAILINGS FROM EXCAVATIONS, WHEEL RUTS AND ANY SETTLING OR EROSION THAT HAS OCCURRED PRIOR TO COMPLETION. ALL AREAS OF THE PROJECT SITE SHALL BE LEFT IN A NEAT AND PRESENTABLE CONDITION SATISFACTORY TO THE OWNER PRIOR TO SUBMITTAL OF THE FINAL PAYMENT.

14.) THE CONTRACTOR IS RESPONSIBLE FOR PROVIDING AND SERVICING TEMPORARY TOILET FACILITIES.

## **STEEL FENCE FABRICATION NOTES:**

1.) CONTRACTOR SHALL SUBMIT FABRICATION DRAWINGS

2.) ALL WORK WILL BE PERFORMED IN THE SHOP UNLESS OTHERWISE NOTED; NO FABRICATION SHALL BE PERFORMED ON THE PROJECT SITE

3.) GRIND ALL WELDS SMOOTH. STEEL SHALL BE SMOOTH AND FREE OF DIMPLES, CREASES AND BENDS

- 4.) FENCE POST CAPS TO BE 3" X 3" NEWEL POST CAPS
- 5.) STEEL POSTS 3"X 3", PANEL FRAME 2" X 2", PICKETS 3/4" X 3/4"

6.) ALL STEEL SHALL BE HOT DIPPED GALVANIZED AFTER FABRICATION

### **STEEL PAINTING NOTES:**

1.) ALL STEEL SHALL BE PRIMED AND PAINTED AS FOLLOWS WITH DEVOE PAINT 1-888-681-6353 OR SUBMIT EQUAL FOR APPROVAL

2.) REMOVE ALL GREASE, DIRT, OIL AND SIMILAR CONTAMINANTS FROM ALL SURFACES TO RECEIVE SUBSEQUENT INDUSTRIAL COATINGS USING DEVOE PAINT, GARDCOTE HEAVY DUTY CLEANER, DP 120U000; APPLY PER MANUFACTURER'S RECOMMENDATIONS; ENSURE THAT ALL OF THE CLEANING AGENT IS REMOVED, PRIOR TO APPLYING PRIMER, BY PRESSURE WASHING ALL TREATED SURFACES

3.) APPLY GARDCOTE UNIVERSAL EPOXY PRIMER DP 54U735; APPLY PER MANUFACTURERS RECOMMENDATIONS

4.) APPLY DEVOE ALITHANE II, HIGH SOLIDS URETHANE COATING DP47UXXXX/DP47U902; APPLY PER MANUFACTURER'S RECOMMENDATIONS; FINISH: SEMI-GLOSS BLACK, APPLIED IN THE FIELD

NOTE: THE CONTRACTOR SHALL PROTECT FINISHED WORK UNTIL ACCEPTANCE BY THE OWNER

## CONCRETE NOTES:

- A.) ACI #301: SPECIFICATIONS
- C.) ACI #315: MANUAL OF STANDARD PRACTICE
- A.) AGGREGATE C33 B.) READY MIXED CONCRETE - C94
- C.) PORTLAND CEMENT C150
- E.) COMPRESSIVE TESTING C39

3.) ALL CONCRETE SHALL BE NORMAL WEIGHT CONCRETE WEIGHING NOT MORE THAN 145 PCF AND SHALL HAVE A MINIMUM CONCRETE COMPRESSIVE STRENGTH AT 28 DAYS OF 3000 PSI.

6.) PUMPED CONCRETE SHALL MEET THESE ADDITIONAL REQUIREMENTS: A.) MAXIMUM COARSE AGGREGATE SIZE - 1 INCH B.) INCREASE CEMENT FACTOR BY 1/2 SACK PER CUBIC YARD. C.) MAXIMUM SLUMP - 5 INCHES D.) DO NOT PUMP THROUGH AN ALUMINUM TUBE.

7.) CONCRETE SHALL NOT BE PLACED PRIOR TO APPROVAL OF THE CONCRETE MIX DESIGNS BY THE LANDSCAPE ARCHITECT. THE MIX DESIGNS SHALL NOT BE APPROVED PRIOR TO RECEIPT OF COMPRESSIVE TEST RESULTS FROM AN INDEPENDENT TESTING LABORATORY CERTIFYING ADEQUATE STRENGTH OF THE MIX DESIGNS AT 28 DAYS.

8.) HORIZONTAL CONSTRUCTION JOINTS ARE ONLY ALLOWED IN SLABS OF BEAMS WITH WRITTEN APPROVAL OF THE LANDSCAPE ARCHITECT. CONTROL JOINTS SHALL BE PLACED MAXIMUM 25' O.C. AS REQUIRED WITH THE APPROVAL OF THE LANDSCAPE ARCHITECT.

## CONCRETE REINFORCEMENT

1.) ALL REINFORCEMENT SHALL BE DEFORMED BILLET STEEL (GR.60) CONFORMING TO ASTM A615. A.) REINFORCING - A615, GRADE 60, DEFORMED B.) WELDED WIRE MESH - A185, GRADE 60

2.) SPLICES OF HORIZONTAL REINFORCEMENT SHALL LAP AT LEAST 24" AND SHALL BE CONTINUOUS AROUND CORNERS. MAINTAIN AT LEAST 1" BETWEEN REINFORCING BARS AT SPLICES IN BEAMS AND SLABS. REINFORCING BARS SCHEDULED AS CONTINUOUS SHALL BE LAPPED 24".

3.) DETAILING FABRICATION AND ERECTION OF REINFORCING BARS SHALL COMPLY WITH THE ACI "MANUAL OF STANDARD PRACTICE FOR DETAILING REINFORCED CONCRETE STRUCTURES" (ACI 315).

4.) STANDARD PROTECTIVE COVER FOR REINFORCING, UNLESS NOTED OTHERWISE, SHALL BE AS OUTLINED IN ACI

318-83:

- C.) SLABS AND WALLS 1 INCH D.) OTHER - 1 1/2 INCHES

5.) PROVIDE SHOP DRAWINGS OF REINFORCING AND ACCESSORIES FOR REVIEW BY ARCHITECT. SHOP DRAWINGS SHALL CLEARLY INDICATE LOCATION, SIZE, SPACING, SPLICES AND PIECE MARK FOR ALL REINFORCING STEEL. THE SHOP DRAWINGS SHALL PROVIDE SUFFICIENT DETAIL TO PERMIT PLACEMENT OF REINFORCEMENT WITHOUT THE USE OF THE DESIGN DRAWINGS AND SHALL INCLUDE A COMPLETE BILL OF MATERIALS.

6.) FABRICATION OF REINFORCING STEEL SHALL NOT COMMENCE UNTIL SUBMITTALS HAVE BEEN REVIEWED BY LANDSCAPE ARCHITECT.

### SIDEWALK NOTES:

1.) THESE PLANS INDICATE APPROXIMATE LOCATIONS OF THE CONCRETE SIDEWALKS. DIMENSIONS SHOWN ARE FROM BACK OF CURB OR PROPERTY LINE TO SIDEWALK EDGE AND ARE AT RIGHT ANGLES (OR PERPENDICULAR) TO THE CURB OR PROPERTY LINE. SIDEWALK CONTRACTOR SHALL STAKE SIDEWALK LAYOUT FOR APPROVAL BY LANDSCAPE ARCHITECT PRIOR TO BEGINNING CONSTRUCTION. SET ELEVATIONS OF WALKS FOR POSITIVE DRAINAGE FROM PROPERTY LINE TO CURB. OWNER AND LANDSCAPE ARCHITECT SHALL MAKE FINAL APPROVAL OF FINISHED ELEVATION AND LAYOUT OF FORMS IN THE FIELD PRIOR TO CONCRETE PLACEMENT.

2.) CONTRACTOR SHALL USE FIBERGLASS OR THIN WOOD FORMS TO CREATE SMOOTH AND UNIFORM CURVES ON MEANDERING SIDEWALKS UNLESS OTHERWISE APPROVED BY LANDSCAPE ARCHITECT.

3.) CONCRETE SHALL HAVE A MINIMUM COMPRESSIVE STRENGTH AT 28 DAYS OF 3000 PSI. CONCRETE AND REINFORCING SHALL MEET ALL OTHER APPLICABLE CRITERIA IN THE CONCRETE AND REINFORCEMENT NOTES.

4.) CONTRACTOR TO TIE ALL SIDEWALKS INTO EXISTING WALKS WITH A SMOOTH TRANSITION AND TO MATCH EXISTING WALKS IN COLOR AND FINISH.

SIMULTANEOUSLY.

6.) LOCATIONS OF ALL UTILITIES SHOWN ON PLANS ARE APPROXIMATE AND SHALL BE VERIFIED IN FIELD. NOTIFY OWNER OF ANY ELEVATION ADJUSTMENT REQUIRED OF MANHOLES OR UTILITY BOXES. THE APPROPRIATE UTILITY CONTRACTOR WILL MAKE ADJUSTMENT.

7.) STUB OUT WALKS AS SHOWN ON PLANS WITH REDWOOD EXPANSION JOINTS AND 1/2" DOWELS, 12" O.C. TO ALLOW FUTURE CONSTRUCTION. CONTRACTOR SHALL BACKFILL TO TOP OF WALK TO ENSURE NO DOWELS ARE EXPOSED.

8.) CONTROL JOINT LAYOUT AT WALK INTERSECTIONS HAS BEEN SHOWN DIAGRAMMATICALLY ON PLANS AND SHALL BE APPROVED BY LANDSCAPE ARCHITECT PRIOR TO POURING. WALKS SHALL BE POURED IN SECTIONS WITH NO CORNERS LESS THAN 45 DEGREES TO AVOID FUTURE CRACKING.

NOTE: CONTRACTOR IS RESPONSIBLE FOR PROTECTING HIS WORK FROM VANDALISM OR GRAFFITI PRIOR TO CURING. CONTRACTOR SHALL REPLACE AS NECESSARY ANY SECTIONS OF DAMAGED WALK AT NO ADDITIONAL COST TO THE OWNER.

1.) ALL CONCRETE CONSTRUCTION, DETAILING AND ERECTION SHALL CONFORM TO THE FOLLOWING:

B.) ACI #318: BUILDING CODE REQUIREMENTS

2.) CONCRETE MATERIALS SHALL CONFORM TO THE FOLLOWING ASTM REQUIREMENTS:

D.) FIELD CYLINDERS - C31

4.) THE WATER/CEMENT RATIO FOR STRUCTURAL CONCRETE SHALL NOT EXCEED 0.53.

5.) TOTAL AIR CONTENT SHALL BE 3 TO 5 PERCENT.


A.) AGAINST DIRT OF FILL - 3 INCHES B.) EXPOSED TO EARTH OR WEATHER - 2 INCHES

5.) CONTRACTOR SHALL COORDINATE SIDEWALK CONSTRUCTION WITH OTHER CONTRACTORS WORKING

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CLIENT I CLIENT I Project I	
Image: New Group         Brooks II Multifamily Developmen         Dave Erwin Drive         San Antonio, Texas 7823	
DATE ISSUED   15 MAY, 2015 DRAWN BY   MVP CHECKED BY   MVP	
SHEET TITLE   GENERAL NOTES SHEET NO   LC 1.1	



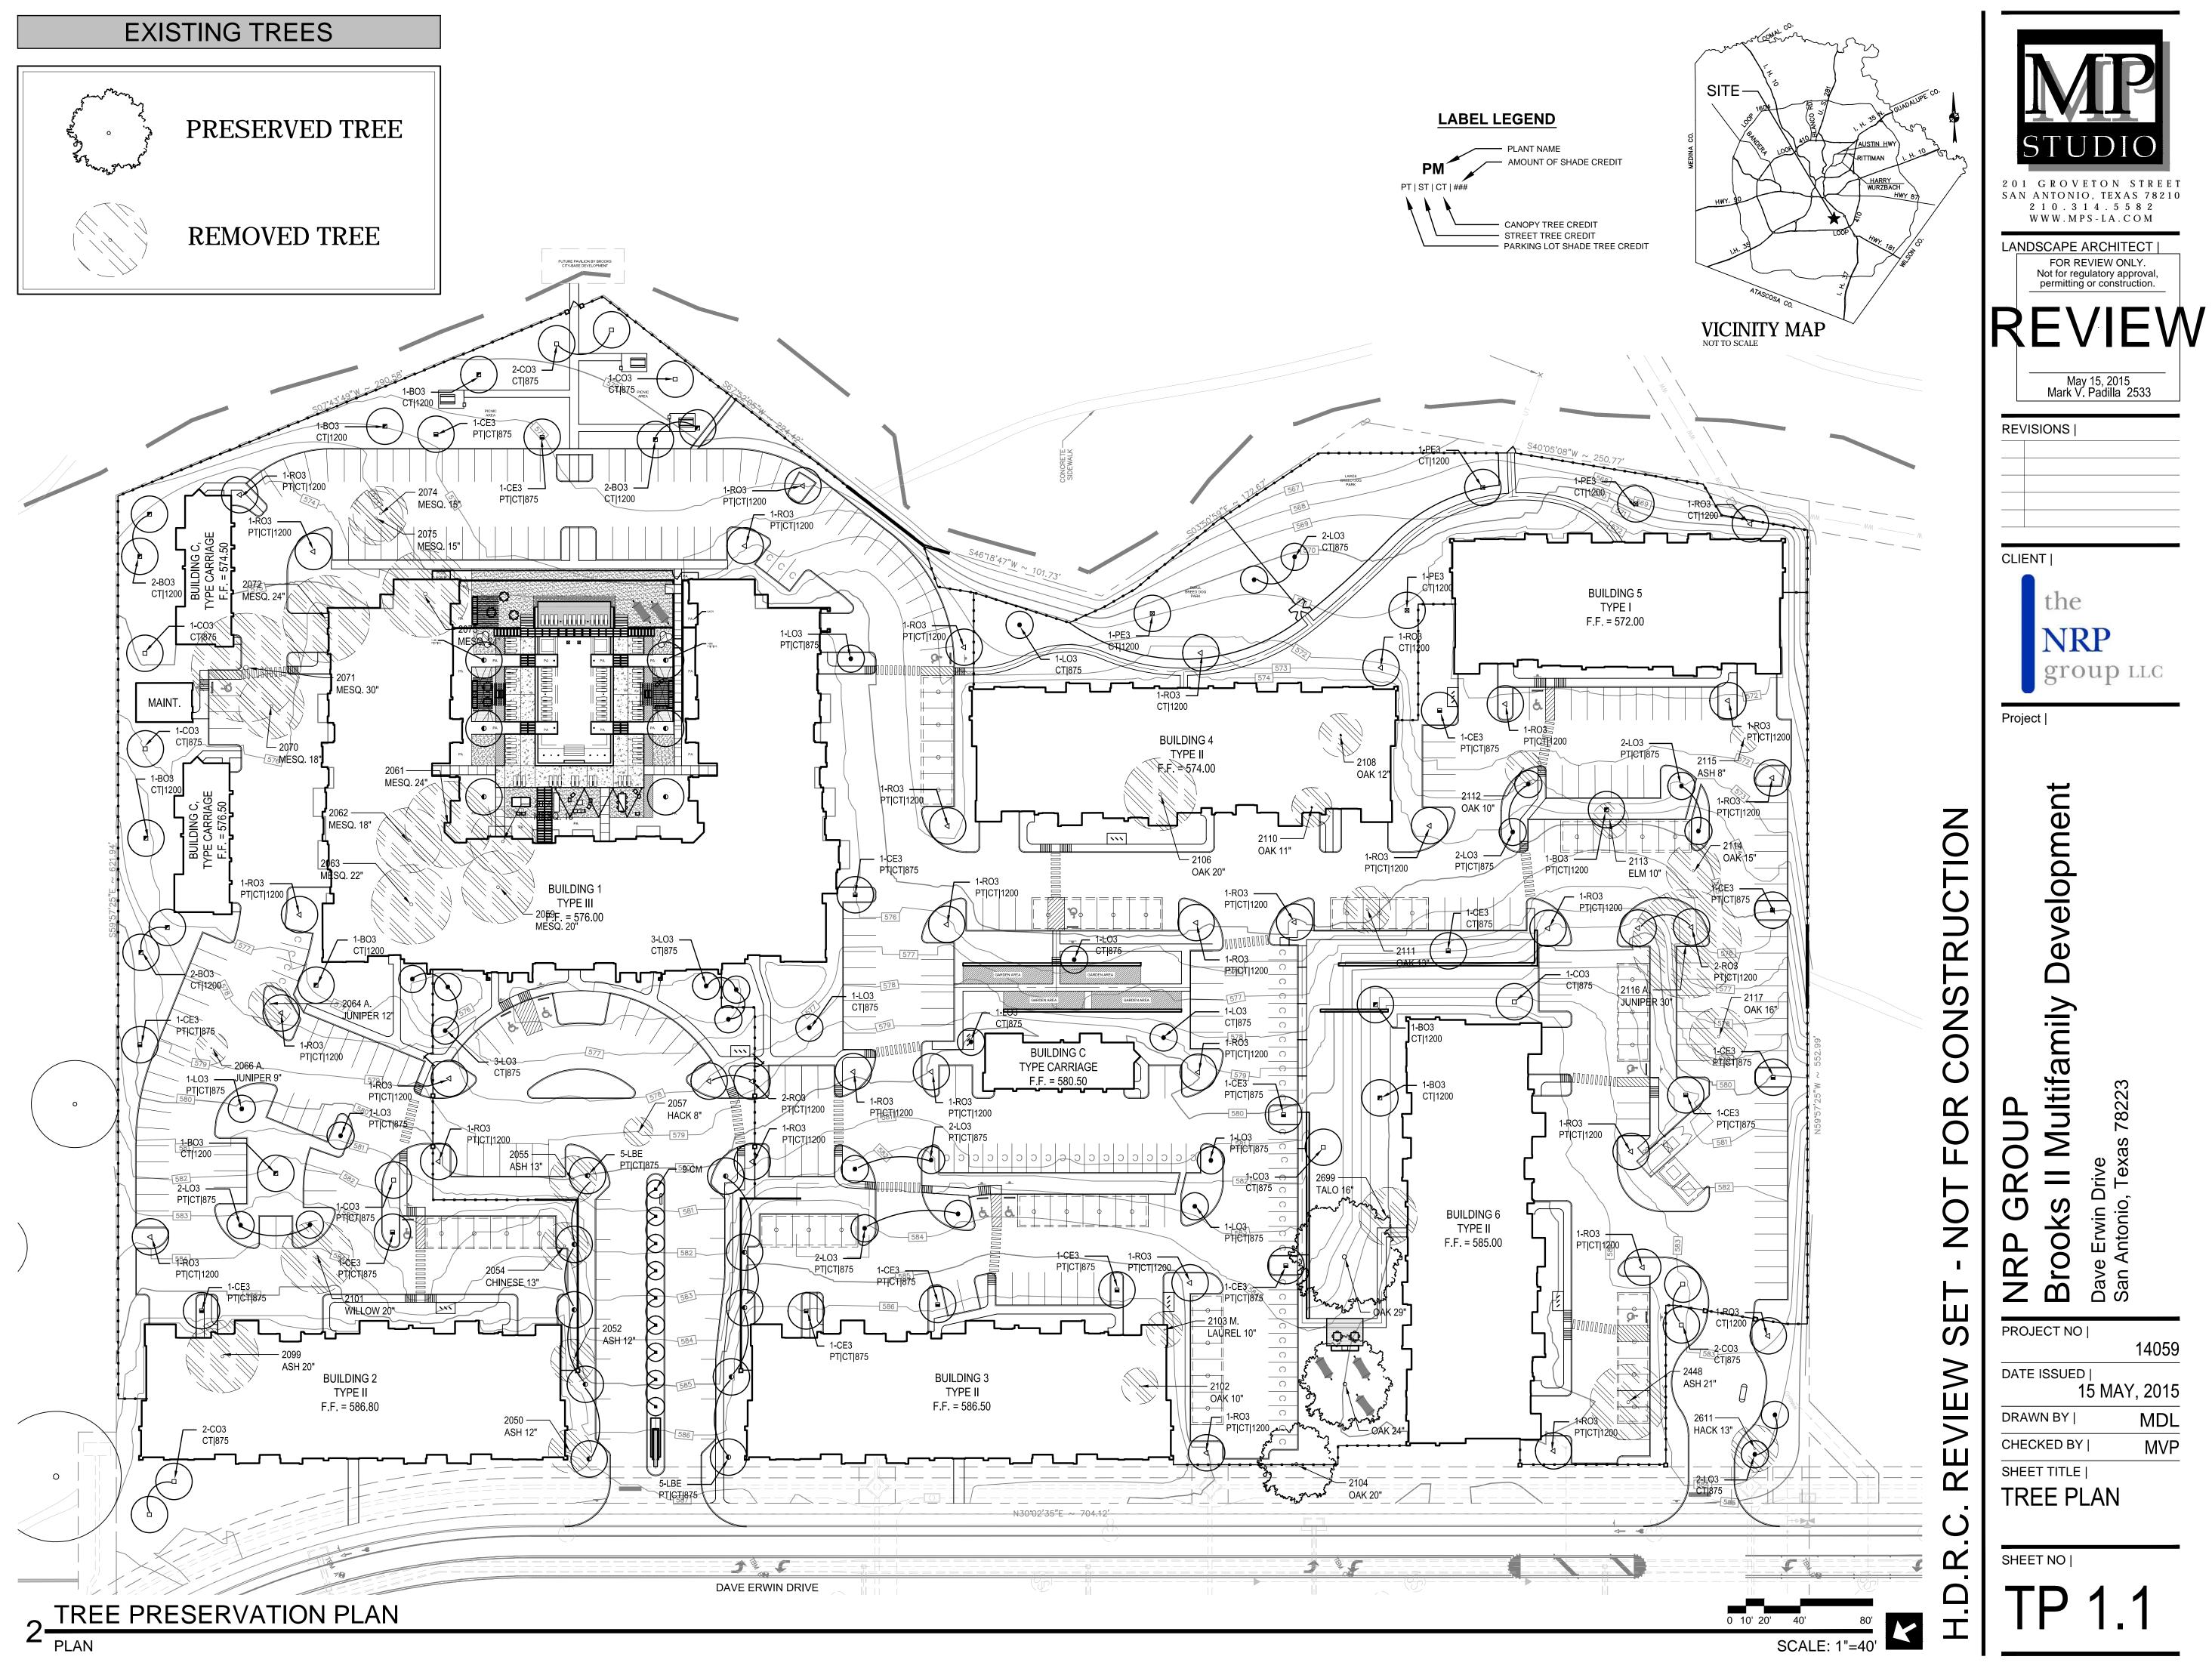

## 1. ALL THE TREES WITH A DIAME PRUNED ACCORDING TO TREE PR

ON TREE PROTECTION DETAIL ON 2. ALL TREES SHALL REMAIN UNLES 3. NO SITE PREPARATION WORK

AND APPROVED BY CITY INSPECTO 4. TREE PROTECTION FENCING S CONTRACTOR DURING SITE CONS

5. THE CONTRACTOR SHALL AVC EXCAVATION IN THE VICINITY OF T

6. THE ROOT PROTECTION ZONE EQUIPMENT, VEHICLES OR MATERI FOR EXAMPLE, A 10-INCH DIAMET THAT ARE IN CONFLICT WITH THE BE PAINTED OVER, WITHIN 20 MINU

7. ACCESS TO FENCED AREAS WILL 8. GRADING, IF REQUIRED, SHALL B 9. TREES, SHRUBS OR BUSHES TO MANAGER OR CITY INSPECTOR.

10. TREES DAMAGED OR LOST SATISFACTION.

11. EXPOSED ROOTS SHALL BE CO 12. ANY TREE REMOVAL SHALL BE



## EXISTING TREE NOTES

## BROOKS II

EXISTING TREE NOTES							
S WITH A DIAMETER GREATER THAN 3 INCHES AFFECTED BY CONSTRUCTION SHALL HAVE THE LIMBS AND ROOTS TRIMMED AND					ry Species* - 11.5"		ant Tree 23.5"
DING TO TREE PRUNING, SOIL AMENDING AND FERTILIZATION, UNLESS SPECIFIED TREES SHALL RECEIVE PROTECTION AS SHOWN	Tag #	Species	Size	Removed	Preserved	Removed	Preser
CTION DETAIL ON THIS SHEET.	2050	ASH	12				
ALL REMAIN UNLESS NOTED ON THE PLANS.	2052 2054	ASH CHINESE	12 13			13	
ARATION WORK SHALL BEGIN IN AREAS WHERE TREE PRESERVATION AND TREATMENT MEASURES HAVE NOT BEEN COMPLETED BY CITY INSPECTOR.	2054	ASH	13			13	
	2057	HACKBERRY	8	8			
TION FENCING SHALL BE REQUIRED. TREE PROTECTION FENCING SHALL BE INSTALLED, MAINTAINED AND REPAIRED BY THE IRING SITE CONSTRUCTION.	2059	MESQUITE	20				
TOR SHALL AVOID CUTTING ROOTS LARGER THAN THREE INCHES IN DIAMETER WHEN EXCAVATING NEAR EXISTING TREES.	2060 2061	MESQUITE MESQUITE	18 24			<b></b>	
HE VICINITY OF TREES SHALL PROCEED WITH CAUTION. THE CONTRACTOR SHALL CONTACT THE CITY INSPECTOR.	2062	MESQUITE	18				
OTECTION ZONE IS THAT AREA SURROUNDING A TREE, AS MEASURED BY A RADIUS FROM THE TREE TRUNK, IN WHICH NO	2063	MESQUITE	22				
ICLES OR MATERIALS MAY OPERATE OR BE STORED. THE REQUIRED RADIUS LENGTH IS 1 FOOT PER DIAMETER INCH OF THE TREE. 10-INCH DIAMETER TREE WOULD HAVE A 5-FOOT RADIUS ROOT PROTECTION ZONE AROUND THE TREE. ROOTS OR BRANCHES	2064	A. JUNIPER	12				
IFLICT WITH THE CONSTRUCTION SHALL BE CUT CLEANLY ACCORDING TO PROPER PRUNING METHODS. LIVE OAK WOUNDS SHALL R, WITHIN 20 MINUTES TO PREVENT OAK WILT.	2066	A. JUNIPER	9	9			
	2068 2070	A. JUNIPER MESQUITE	24 18				
NCED AREAS WILL BE PERMITTED ONLY WITH THE APPROVAL OF THE ENGINEER OR CITY INSPECTOR.	2071	MESQUITE	30				
EQUIRED, SHALL BE LIMITED TO A 3 INCH CUT OR FILL WITHIN THE FENCED ROOT ZONE AREAS.	2072	MESQUITE	24				
S OR BUSHES TO BE CLEARED FROM PROTECTED ROOT ZONE AREAS SHALL BE REMOVED BY HAND AS DIRECTED BY THE PROJECT Y INSPECTOR.	2073	MESQUITE	24				
	2074 2075	MESQUITE MESQUITE	15 15				
AGED OR LOST DUE TO CONTRACTOR'S NEGLIGENCE DURING CONSTRUCTION SHALL BE MITIGATED TO THE ENGINEER'S	2076	HACKBERRY	10				
OTS SHALL BE COVERED AT THE END OF EACH DAY USING TECHNIQUES SUCH AS COVERING WITH SOIL, MULCH OR WET BURLAP.	2078	ASH	16				
	2080	HACKBERRY	8	8			
MOVAL SHALL BE APPROVED BY THE CITY ARBORIST PRIOR TO ITS REMOVAL.	2082 2084	A. JUNIPER A. JUNIPER	15 20				
	2084	HACKBERRY	8	8			
	2088	REDBUD	10			10	
	2090	OAK	40				
	2092	OAK	20				
LIVE BRANCH	2094 2095	ASH ASH	32 36				
	2000	ELM	16			16	
E A B	2098	ASH	20				
BRANCH BARK RIDGE	2099	ASH	20				
BRANCH BARK RIDGE BRANCH COLLAR PROPER PRUNING FOR	2101 2102	WILLOW M.LAUREL	20 10			20 10	
BRANCHES 1 1/2" OR	2102	M.LAUREL	10			10	
GREATER IN DIAMETER.	2104	OAK	20				
NOTE: DO NOT CUT FROM D to E.	2106	OAK	20				
	2108 2110	OAK OAK	12 11				
	2110	OAK	13				
A. FIRST CUT - TO PREVENT THE BARK FROM BEING PEELED WHEN THE BRANCH FALLS.	2112	OAK	10				
B. SECOND CUT - TO REDUCE THE WEIGHT OF BRANCH.	<mark>2113</mark>	ELM	10			<mark>10</mark>	
C. FINAL CUT - ALLOW FOR HEALING COLLAR BUT NO STUBS	2114 2115	OAK ASH	15 8	8			
D. BRANCH RIDGES - INDENT PROPERLY BRANCH RIDGES WHICH ARE SITE FOR DECAY.	2115	A. JUNIPER	30	0			
	2117	OAK	16				
FOR OAKS ONLY: PAINT ALL WOUNDS OR CUTS WITH PRUNING PAINT WITHIN 20 MIN TO PREVENT THE SPREAD OF OAK WILT.	2611	HACKBERRY	13			13	
		OAK	24				
	Sub. Tot. In	OAK	29	41	0	102	
TREE	the second second second second second	by category=			41		
		n percentage=		0	1%	Significa	nt Preserv
		equired (Commercial)			6.4		nercial (ir
	witigation re	equired (Residential) = I		14	1.35	Resi	dential (ir
		•	1	•			•
		MDP AP#1		1			
					-		
		TORY FOR CLA					
TREE CANOPY ZONE		RVATION. SITE			15		
(RPZ)	AND D	OES NOT REQU	JIRE MIT	IGATION			
NOTE:							
3" MULCH INSIDE RPZ/ WHEN BARE DIRT 1. THE FENCING SHOWN ABOVE IS DIAGRAMATIC ONLY							
AND WILL CONFORM TO THE DRIP LINE AND LIMITED							
TO PROJECT BOUNDARY. 2. FOR ACCEPTABLE FENCING MATERIALS SEE							
SPECIFICATIONS.							
A EXISTING TREE PROTECTION							
ELEVATION - PLAN - 3D VIEW NOT TO SCALE							

ant Tree 23.5"			Heritage 3:1		Heritage 1:1		
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				29			
	395	20	264	29 53	0		
0	395	20	204		0		
102		415		317			
nt Preservation	4%		Heritage Pro	eservation	17	%	
iercial (inches) Iential <mark>(</mark> inches)	393.6						
lential (inches)	393.6		Heritag	e Mitigation (in	ches)	792	

STUDIC 201 GROVETON STREET SAN ANTONIO, TEXAS 78210  $2\ 1\ 0\ .\ 3\ 1\ 4\ .\ 5\ 5\ 8\ 2$ WWW.MPS-LA.COM LANDSCAPE ARCHITECT | FOR REVIEW ONLY. Not for regulatory approval, permitting or construction. REVIEW May 15, 2015 Mark V. Padilla 2533 REVISIONS | CLIENT | the NRP group LLC Project | +---Multifamily Developmen CONSTRUCT 8223 C S S Driv NRP GI Brooks Antonio Dave San / PROJECT NO | 14059 DATE ISSUED | 15 MAY, 2015 DRAWN BY | MDL MVP CHECKED BY | SHEET TITLE | TREE PLAN H.D.R. SHEET NO | TP 1 1.2


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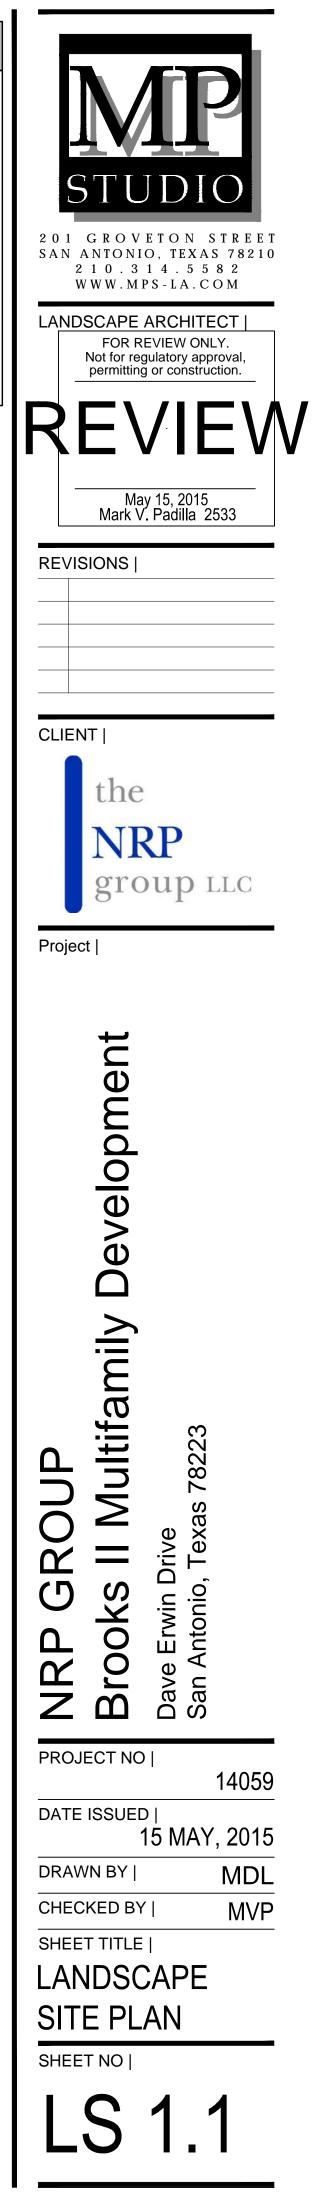
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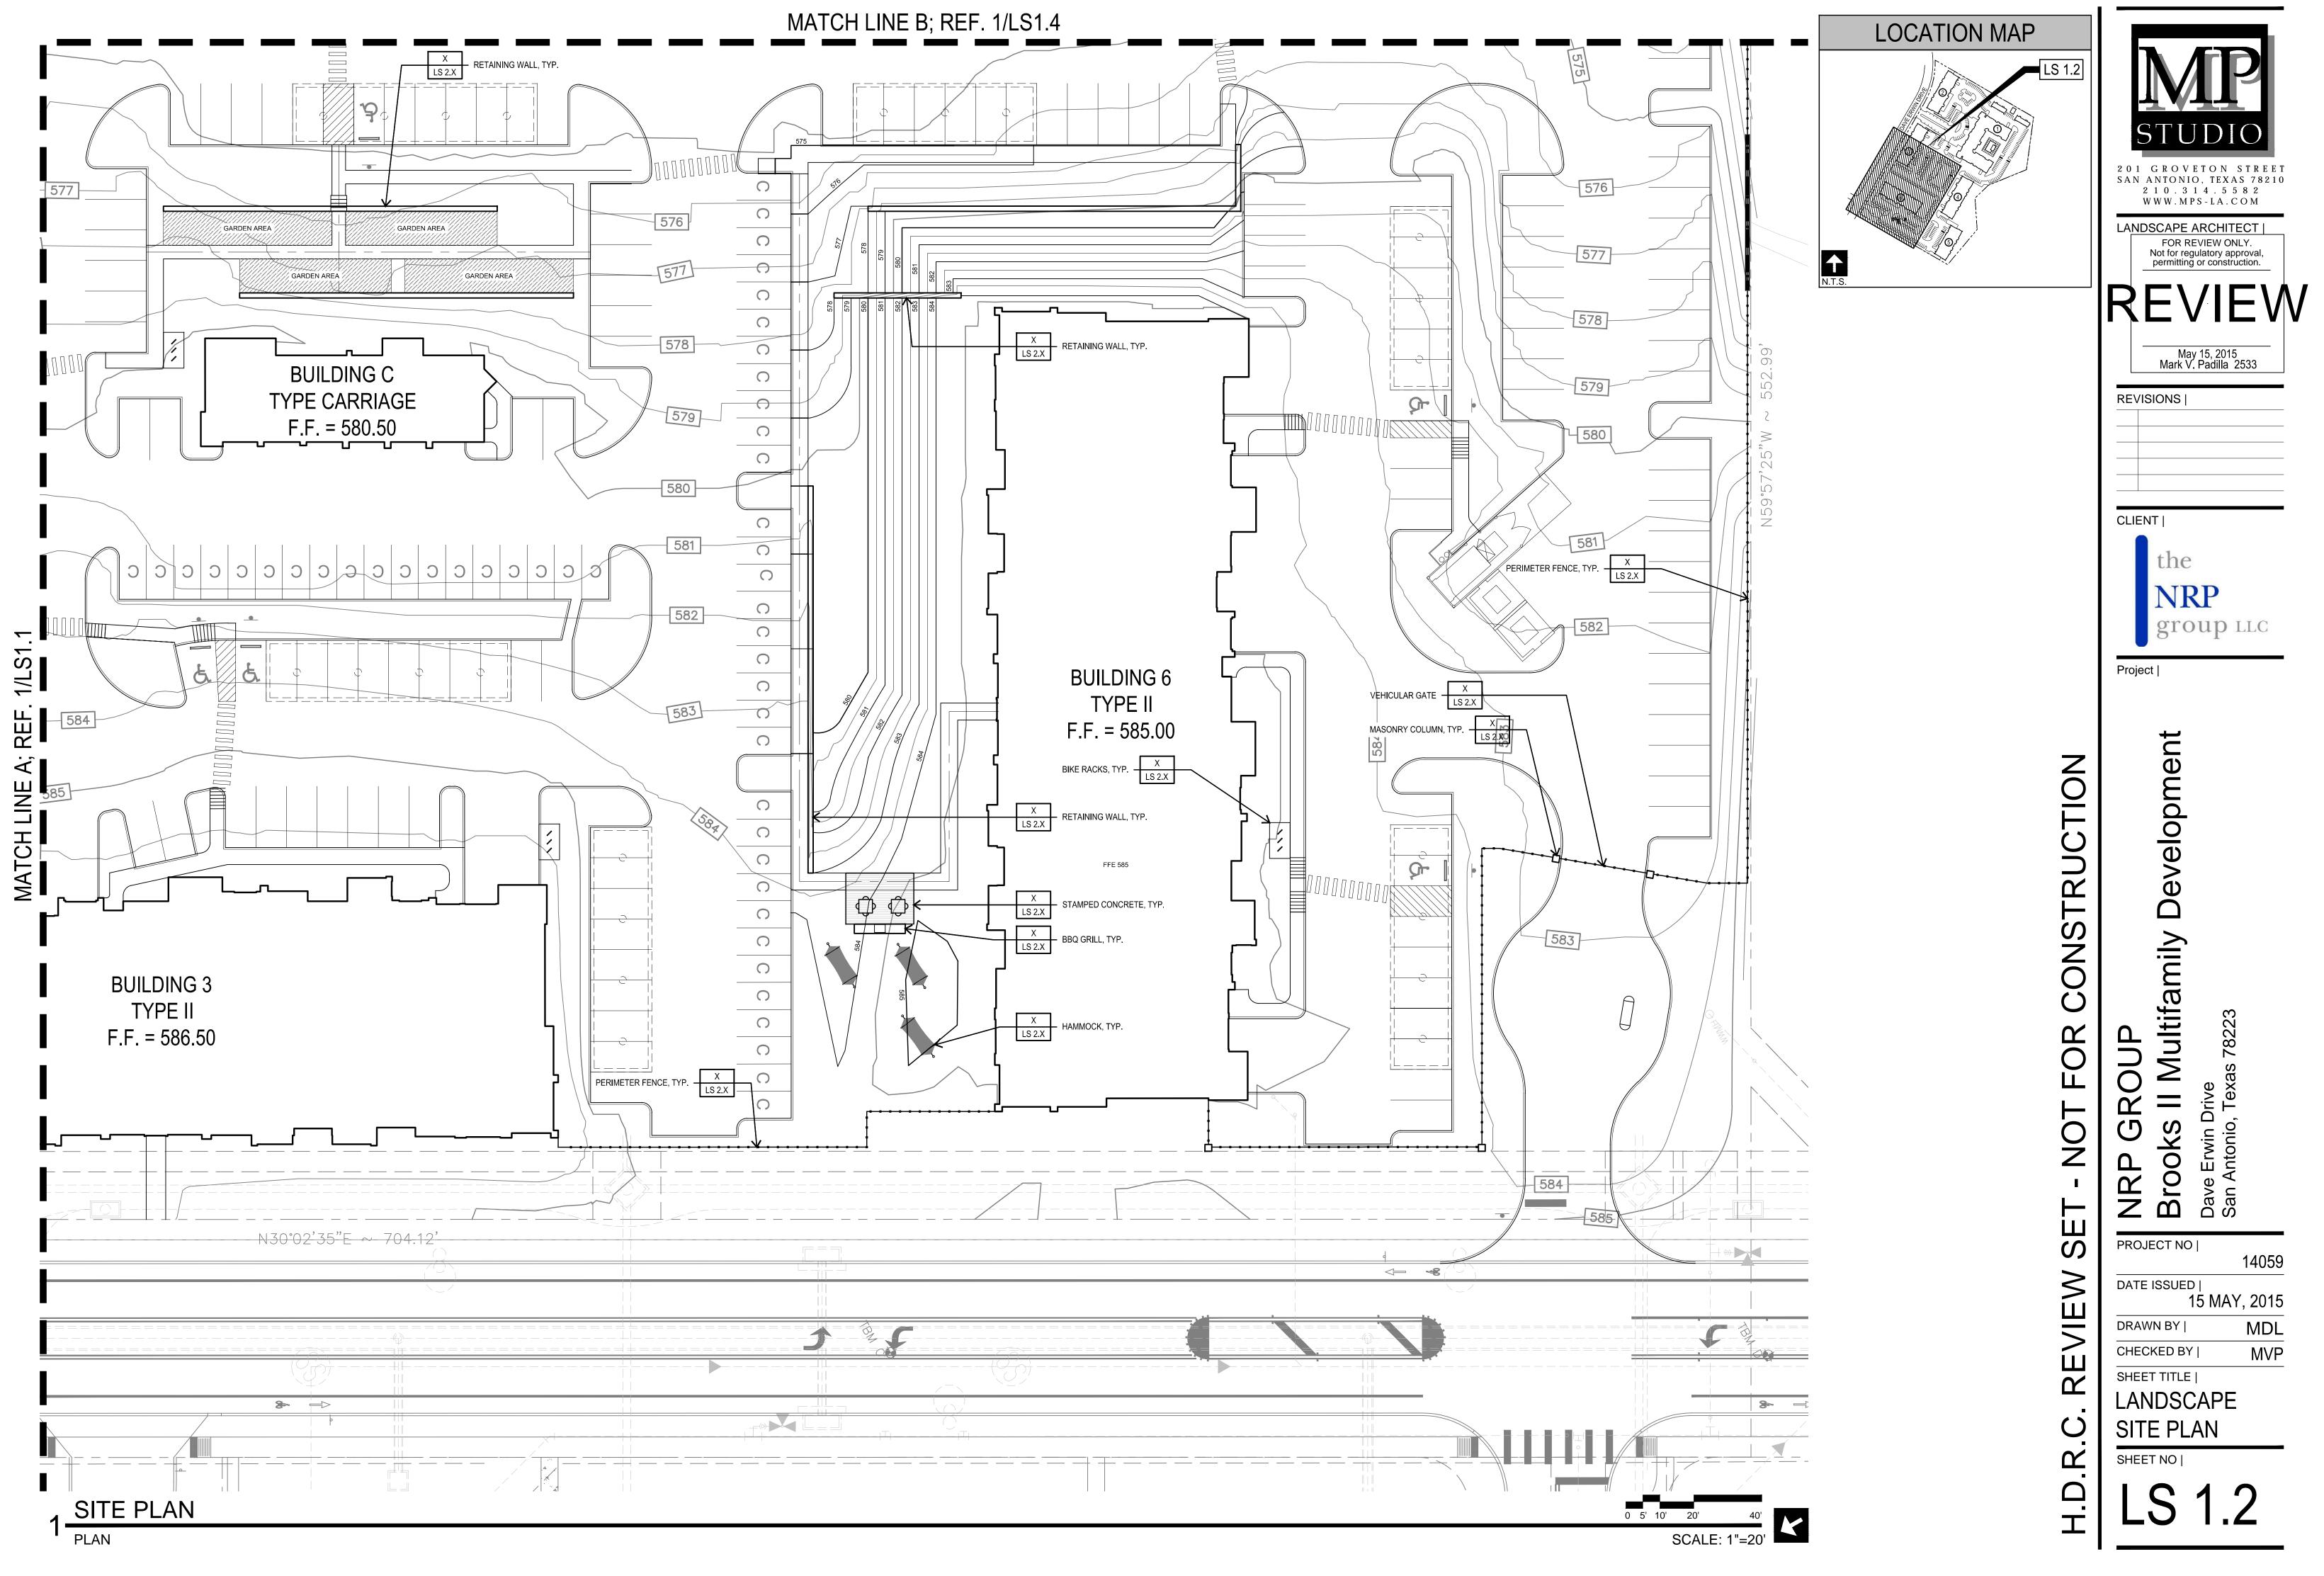






LOCATION MAP


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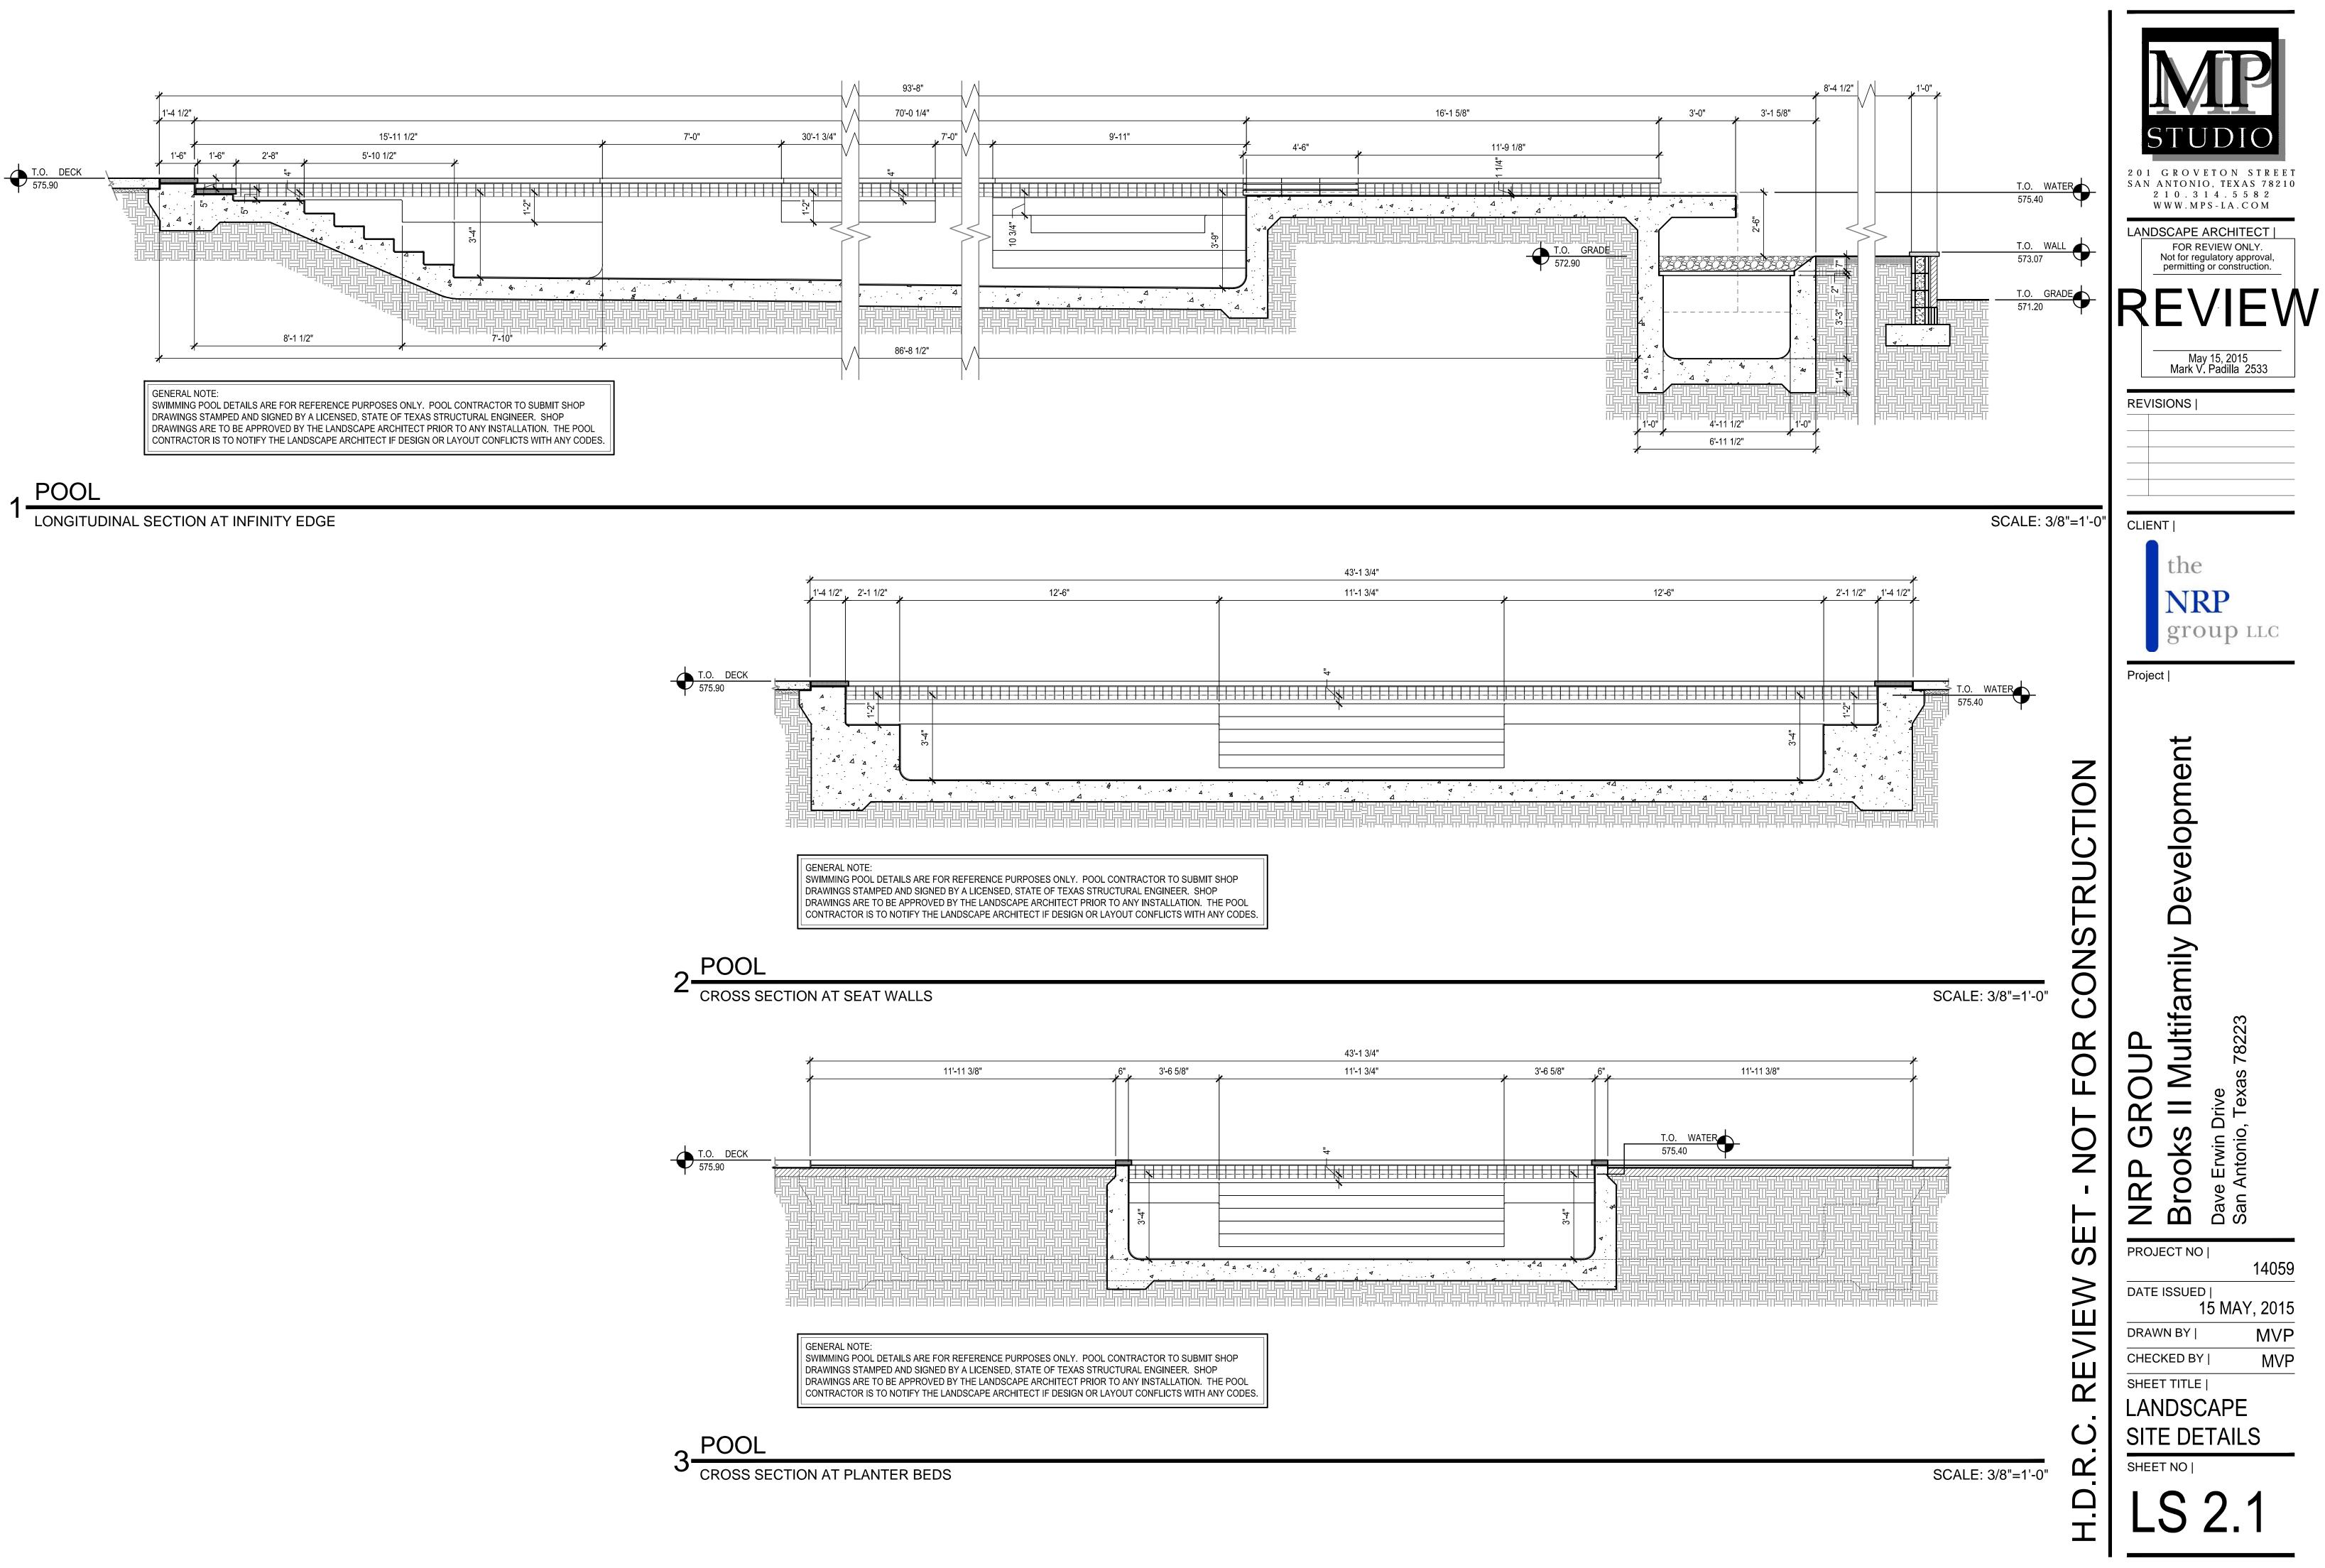




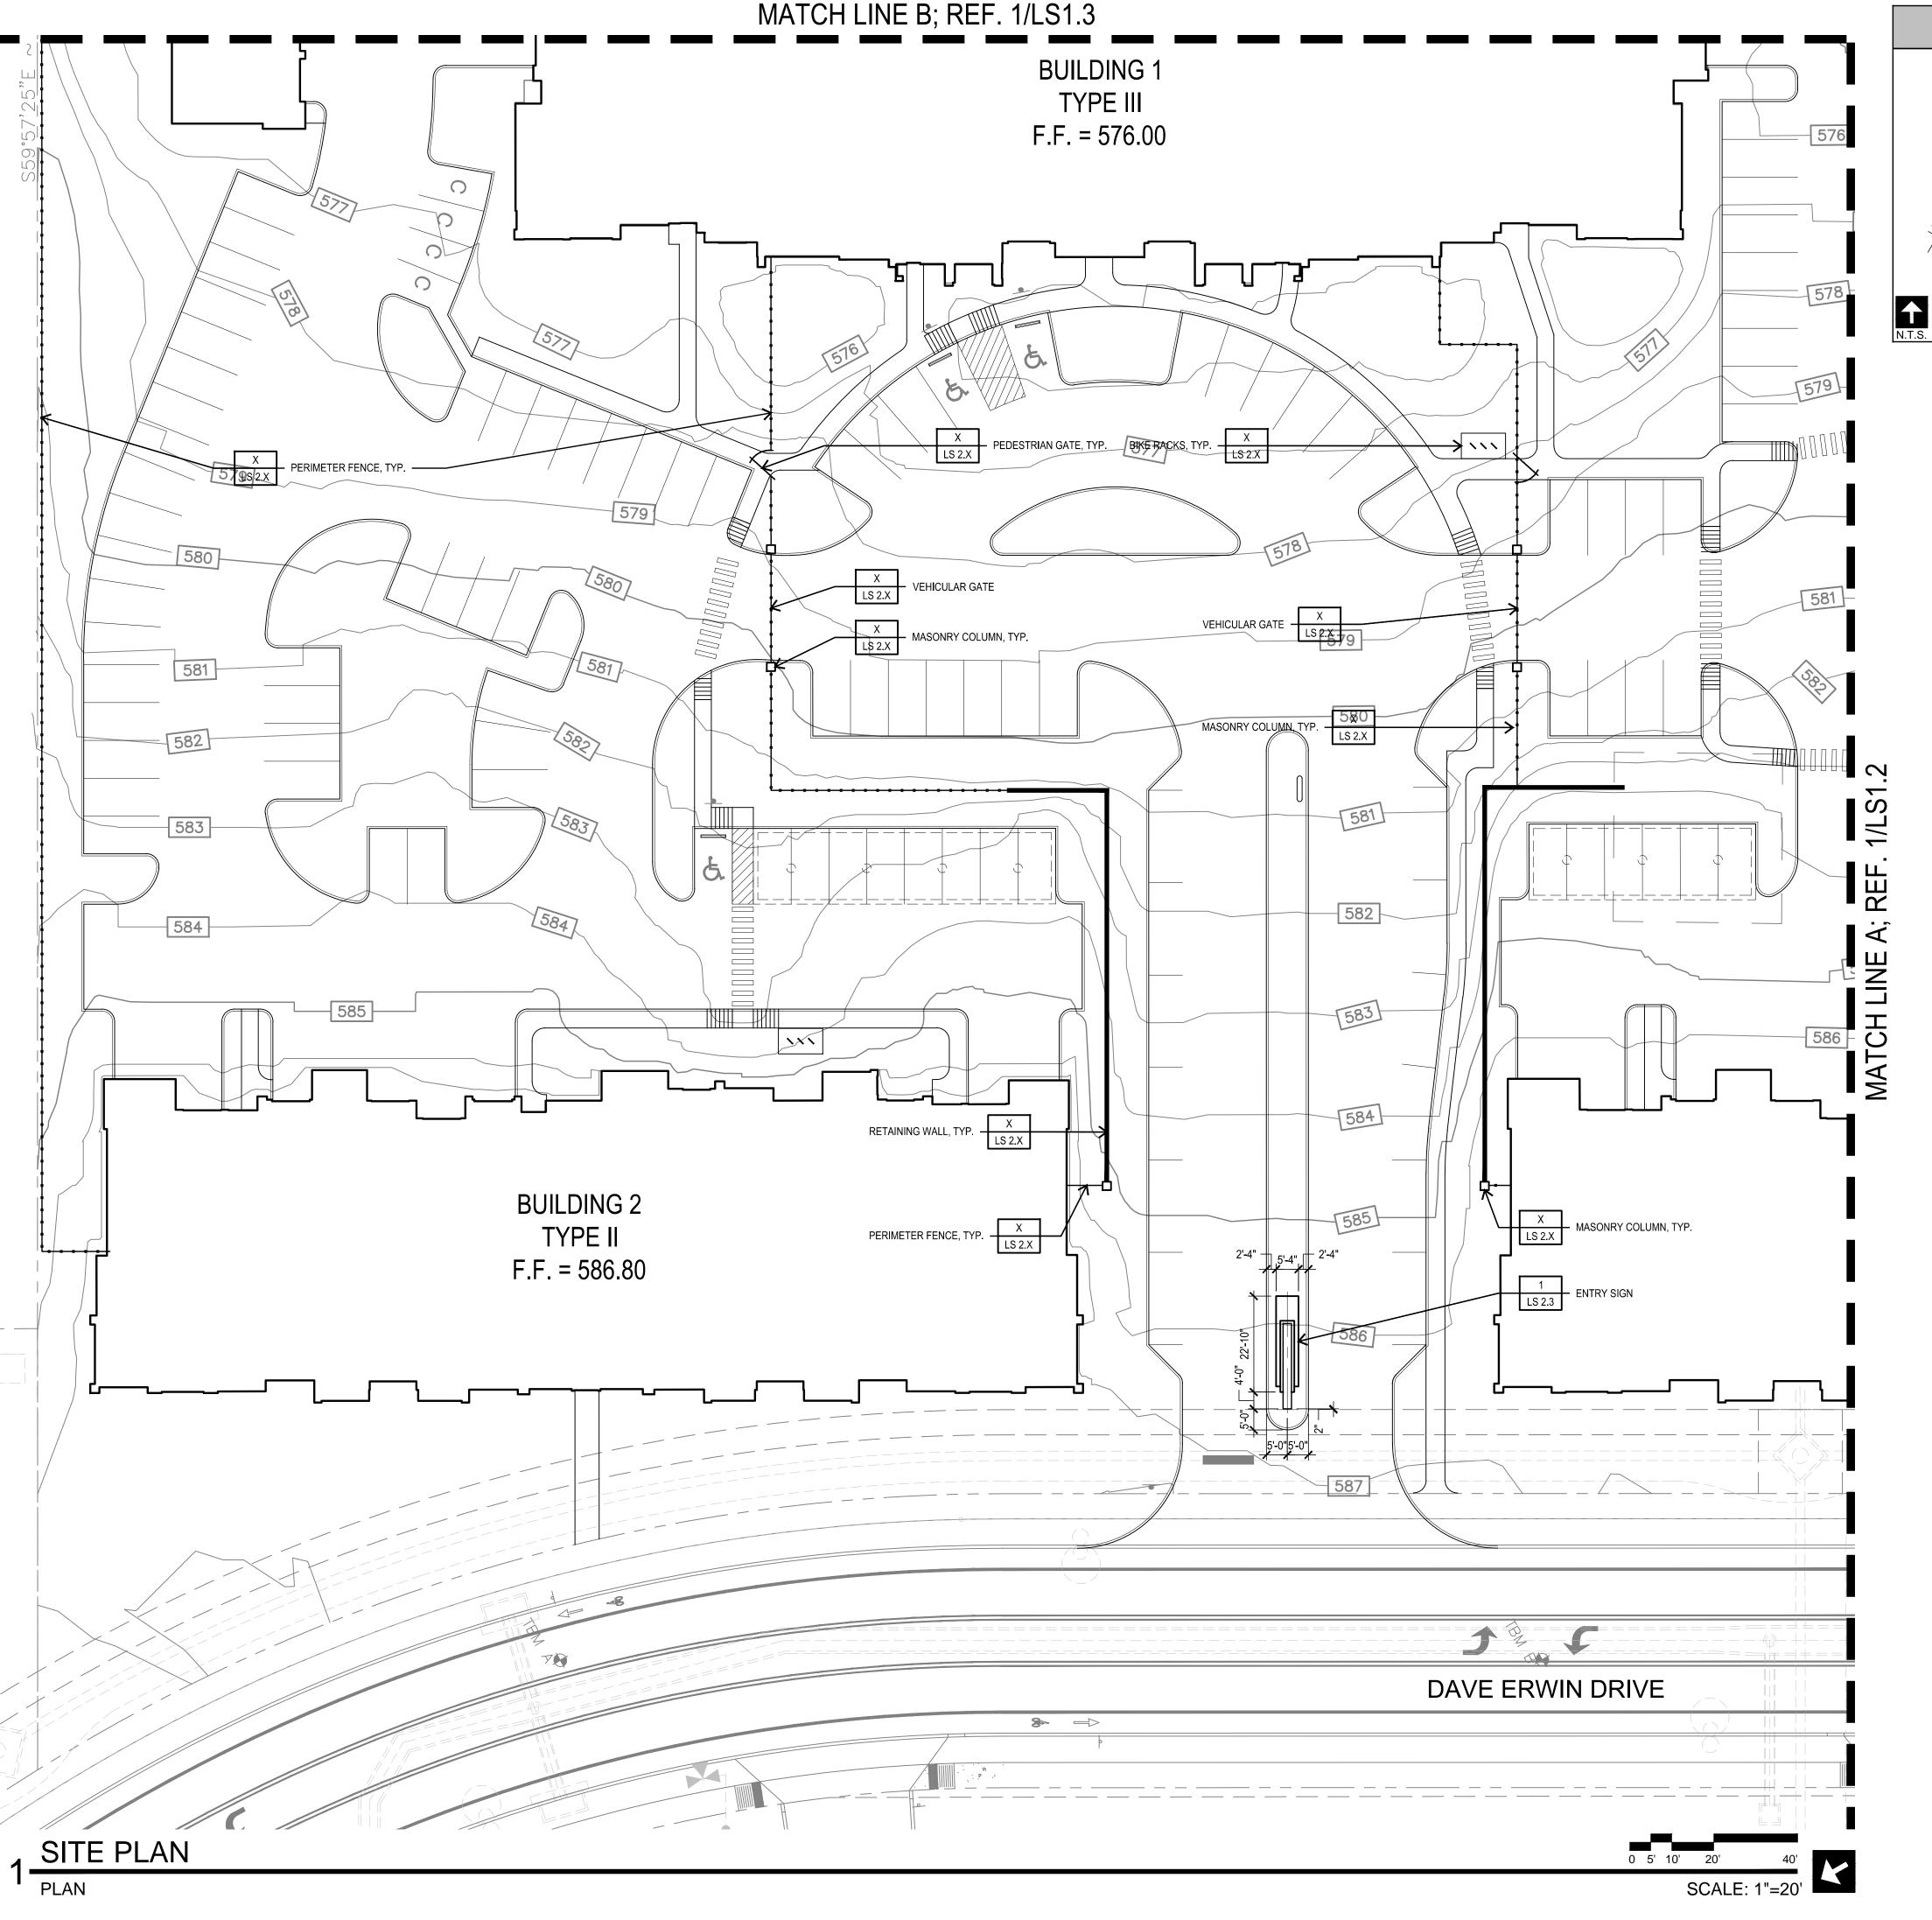

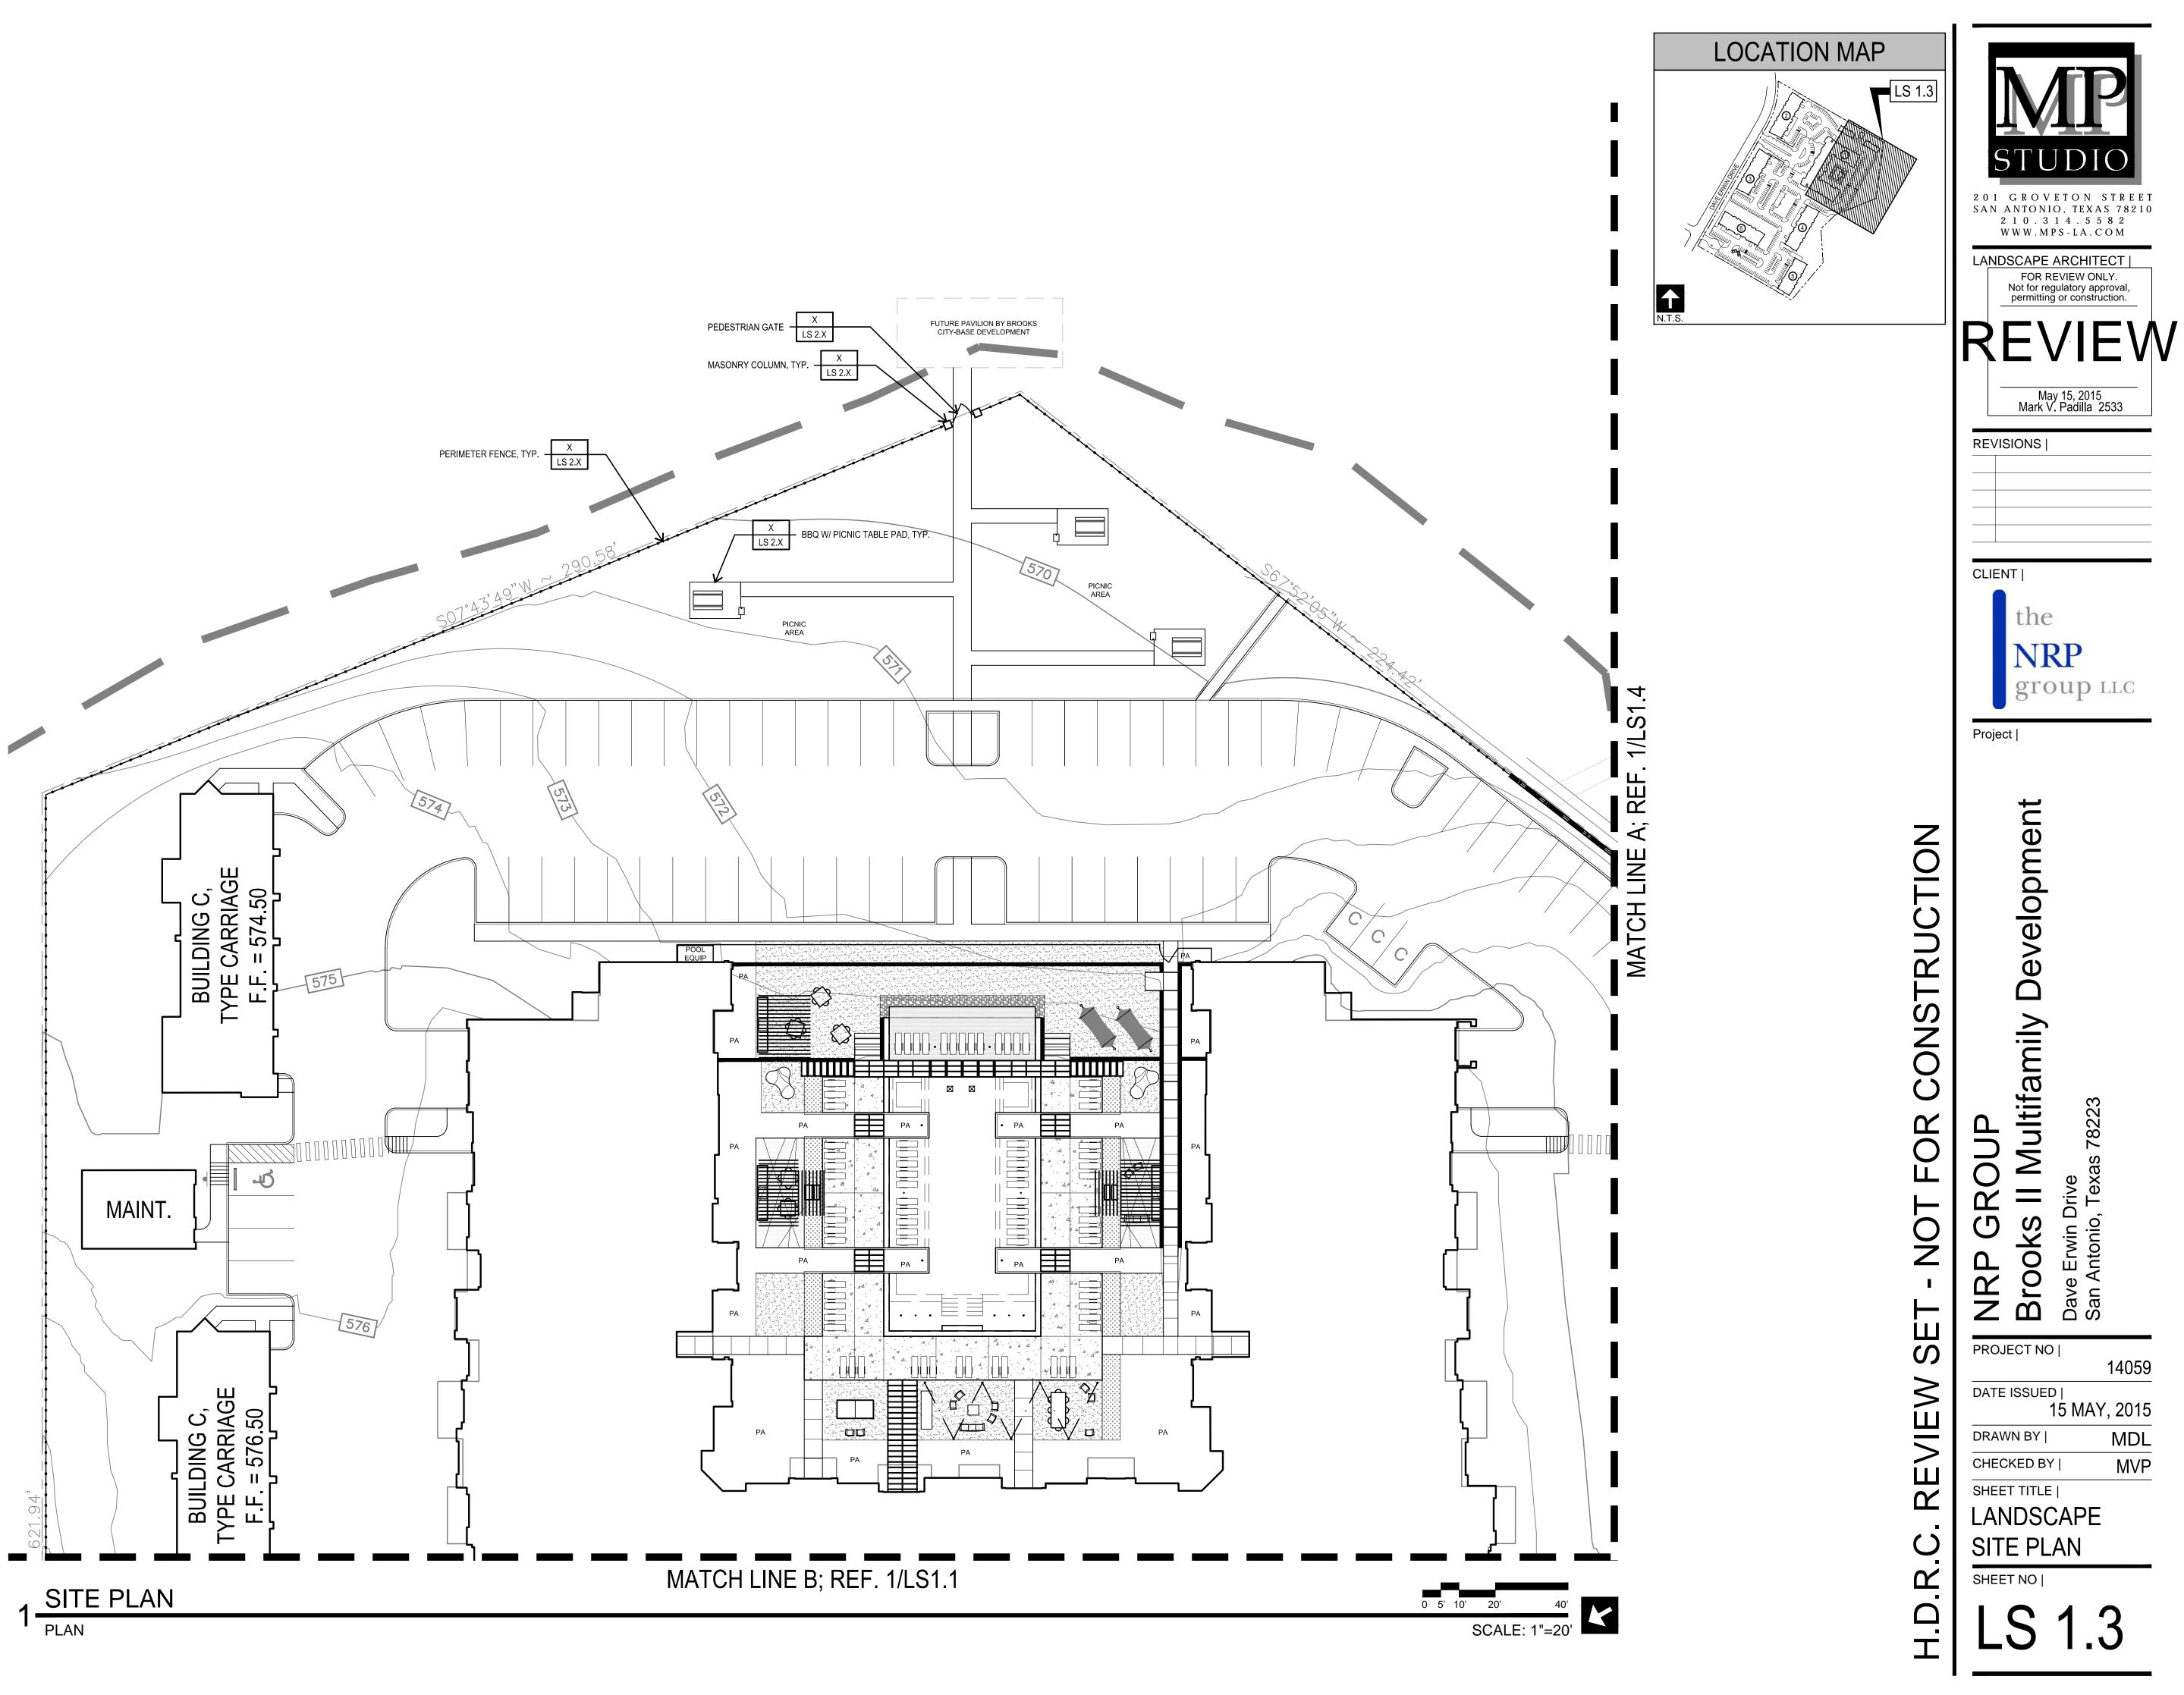

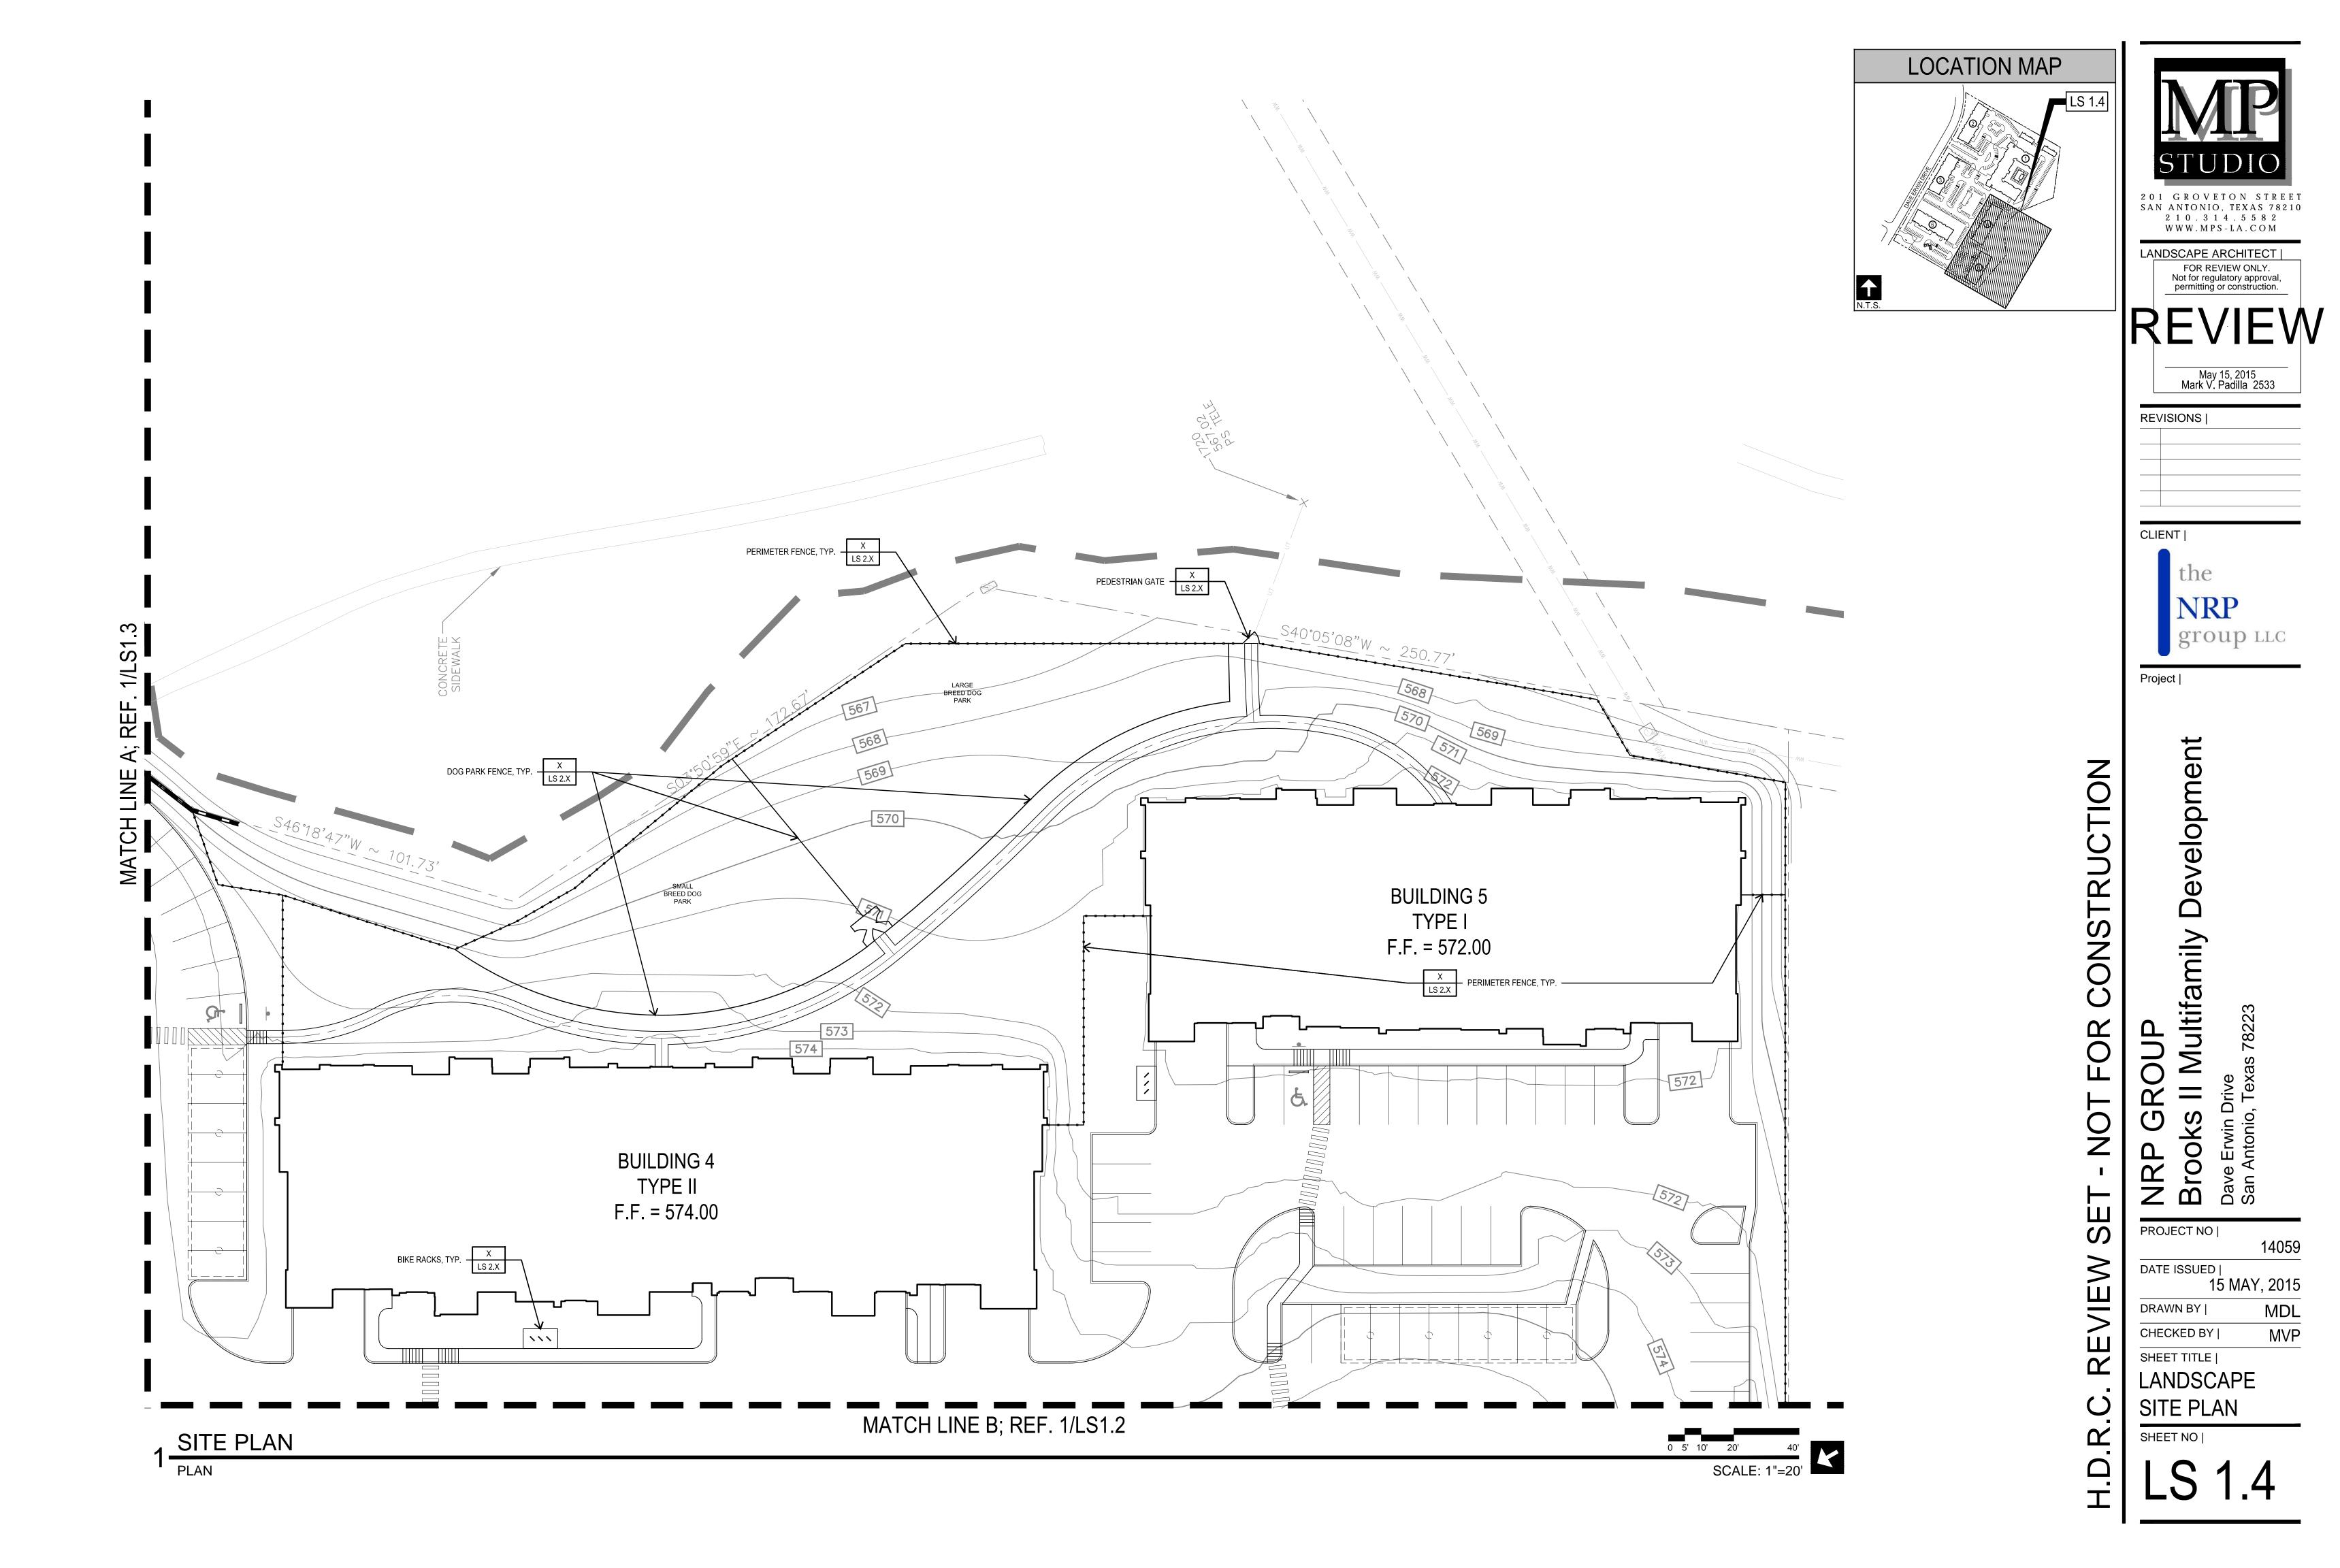


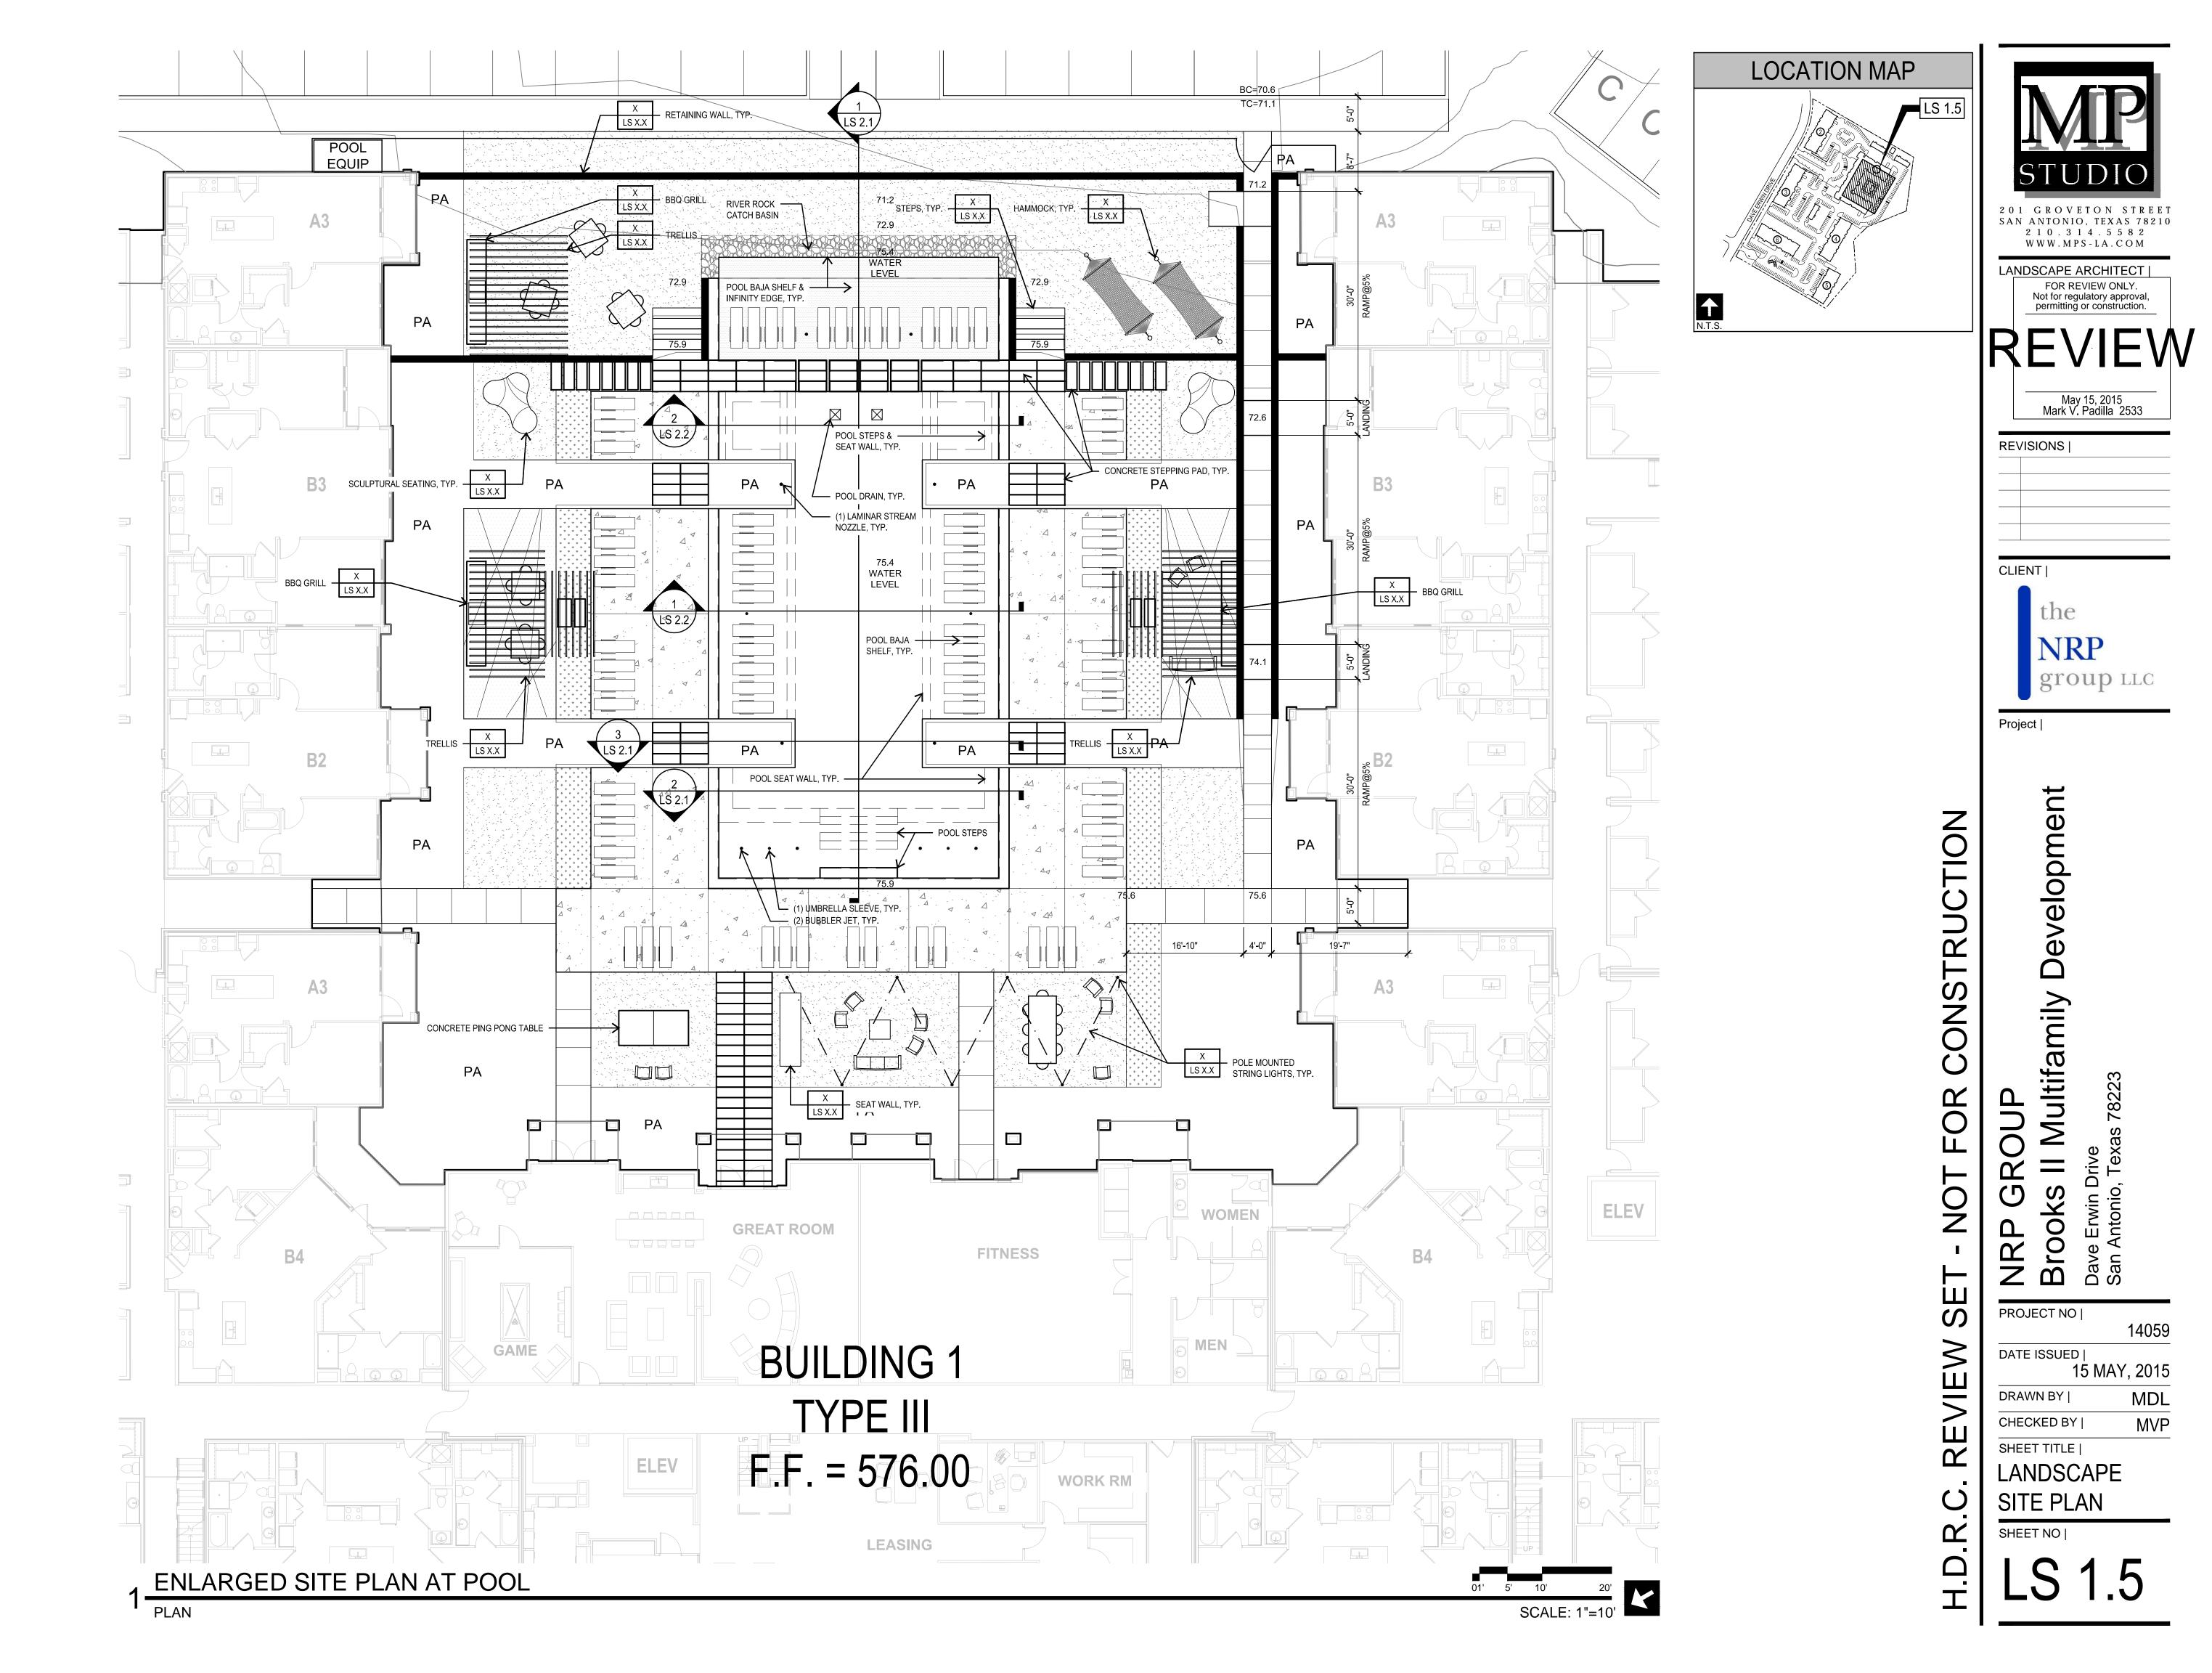










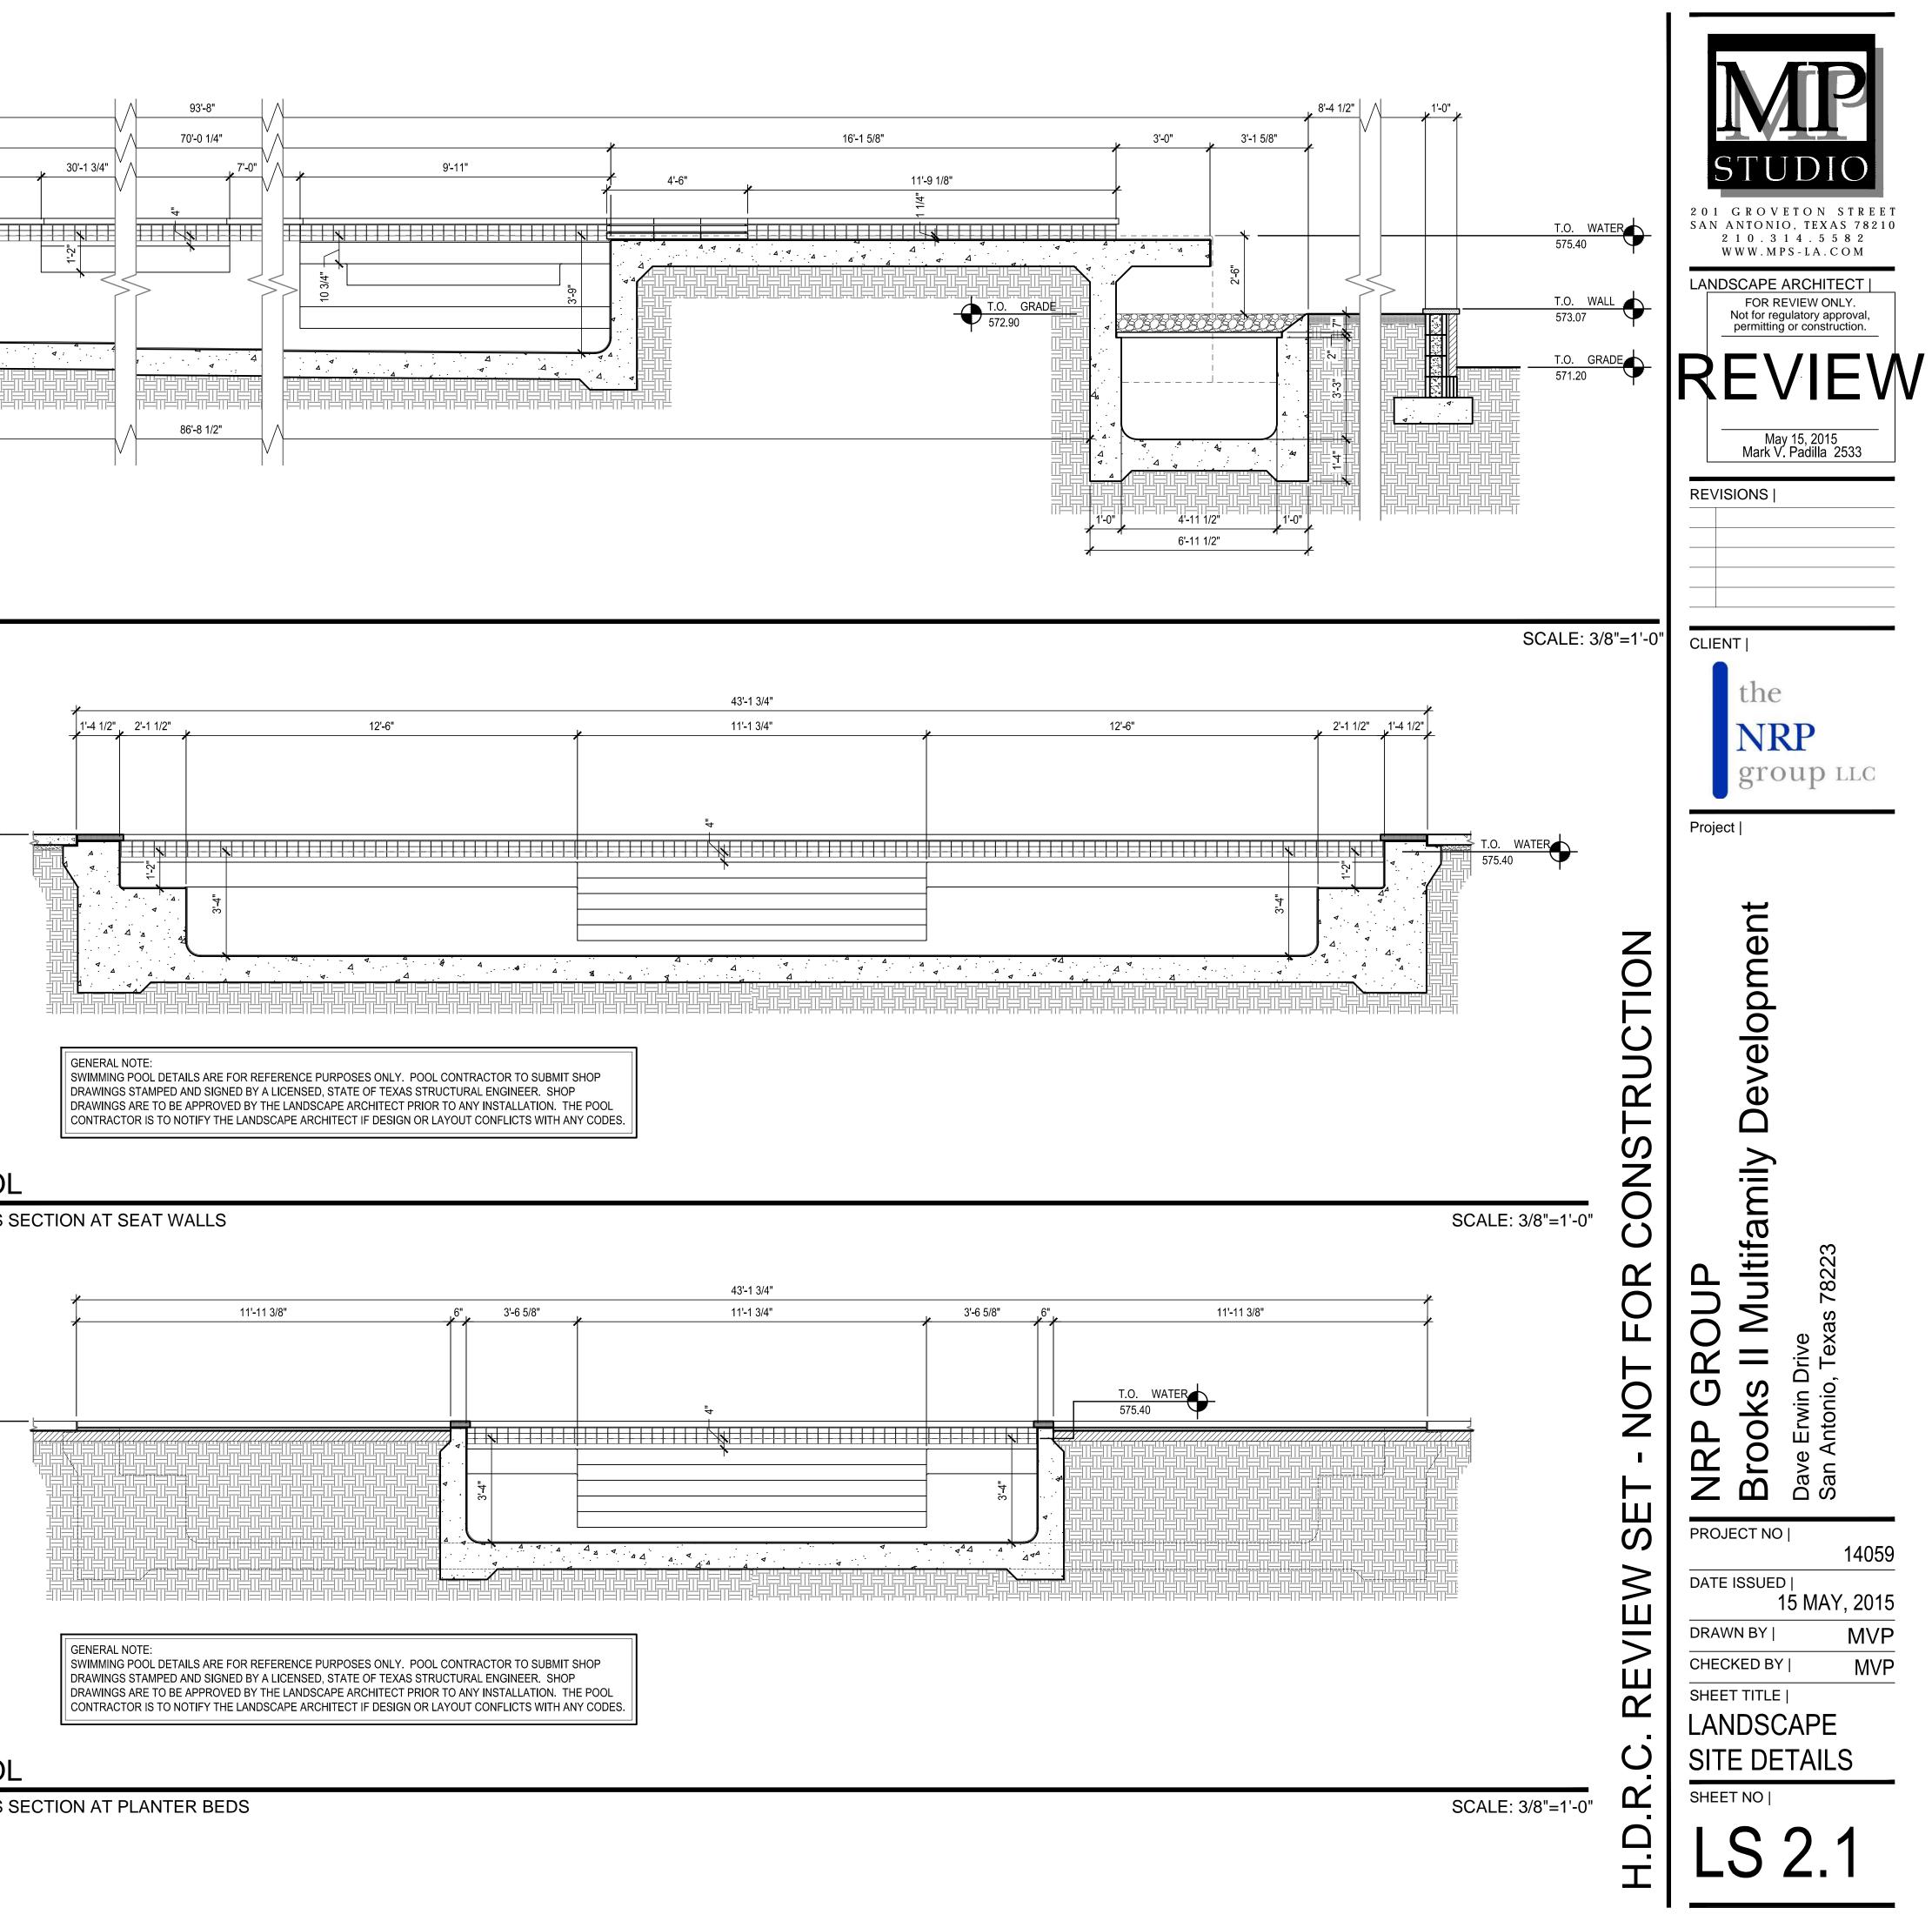

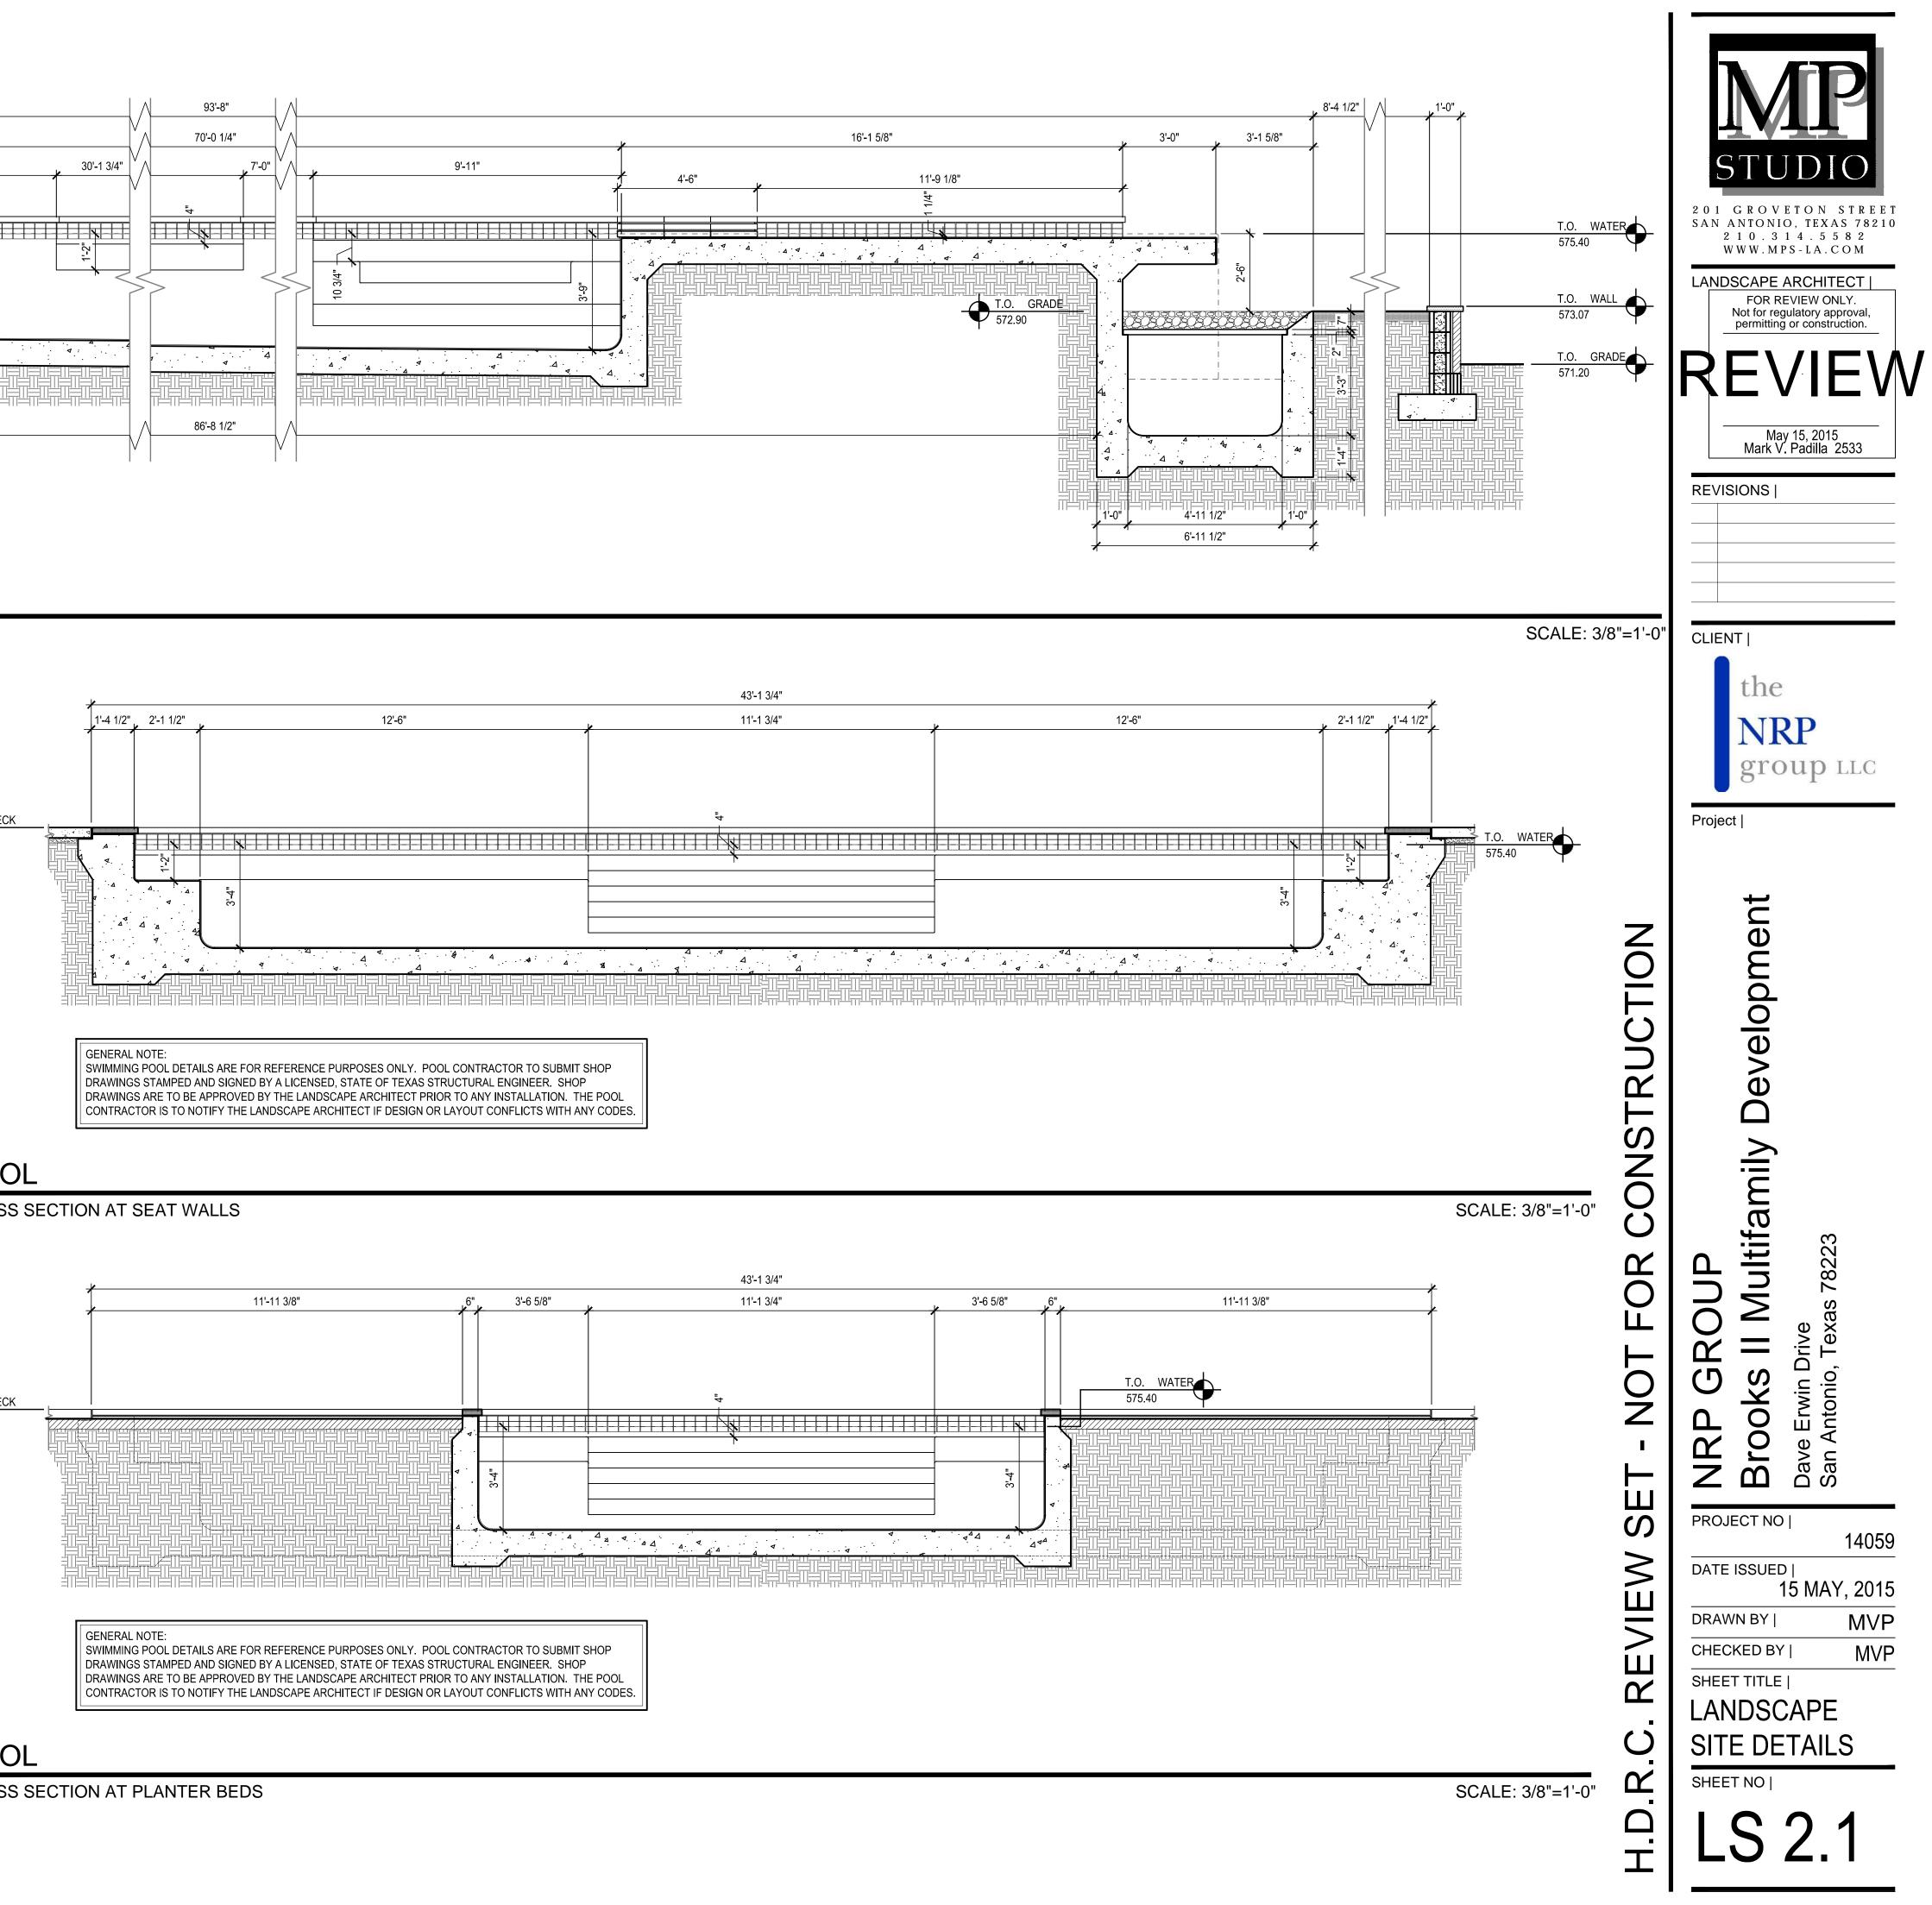

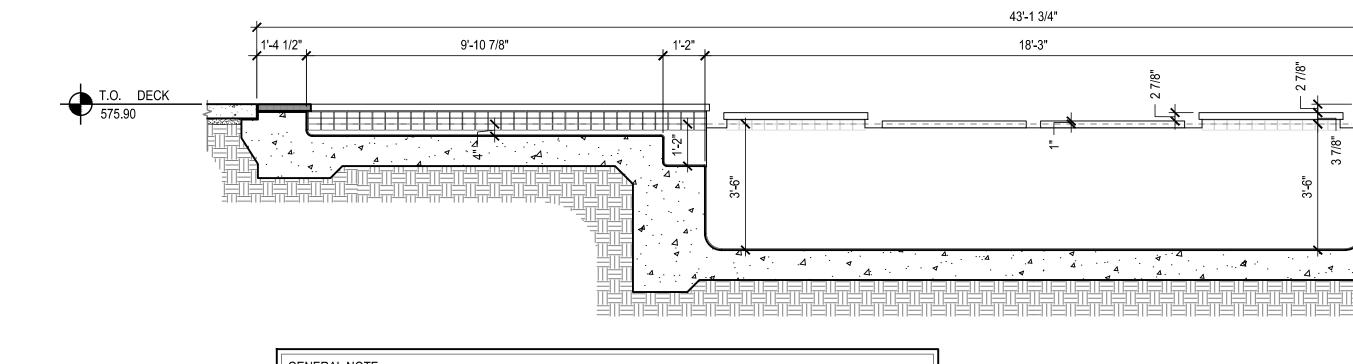



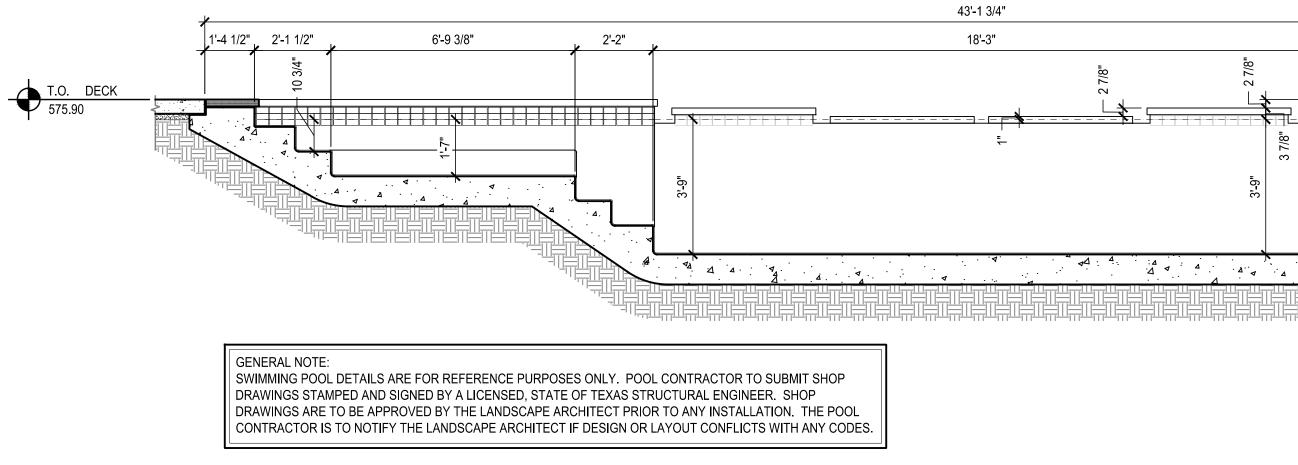





GENERAL NOTE: SWIMMING POOL DETAILS ARE FOR REFERENCE PURPOSES ONLY. POOL CONTRACTOR TO SUBMIT SHOP DRAWINGS STAMPED AND SIGNED BY A LICENSED, STATE OF TEXAS STRUCTURAL ENGINEER. SHOP DRAWINGS ARE TO BE APPROVED BY THE LANDSCAPE ARCHITECT PRIOR TO ANY INSTALLATION. THE POOL CONTRACTOR IS TO NOTIFY THE LANDSCAPE ARCHITECT IF DESIGN OR LAYOUT CONFLICTS WITH ANY CODES.


## **CROSS SECTION AT BAJA SHELFS**


CROSS SECTION AT SEATING WELLS

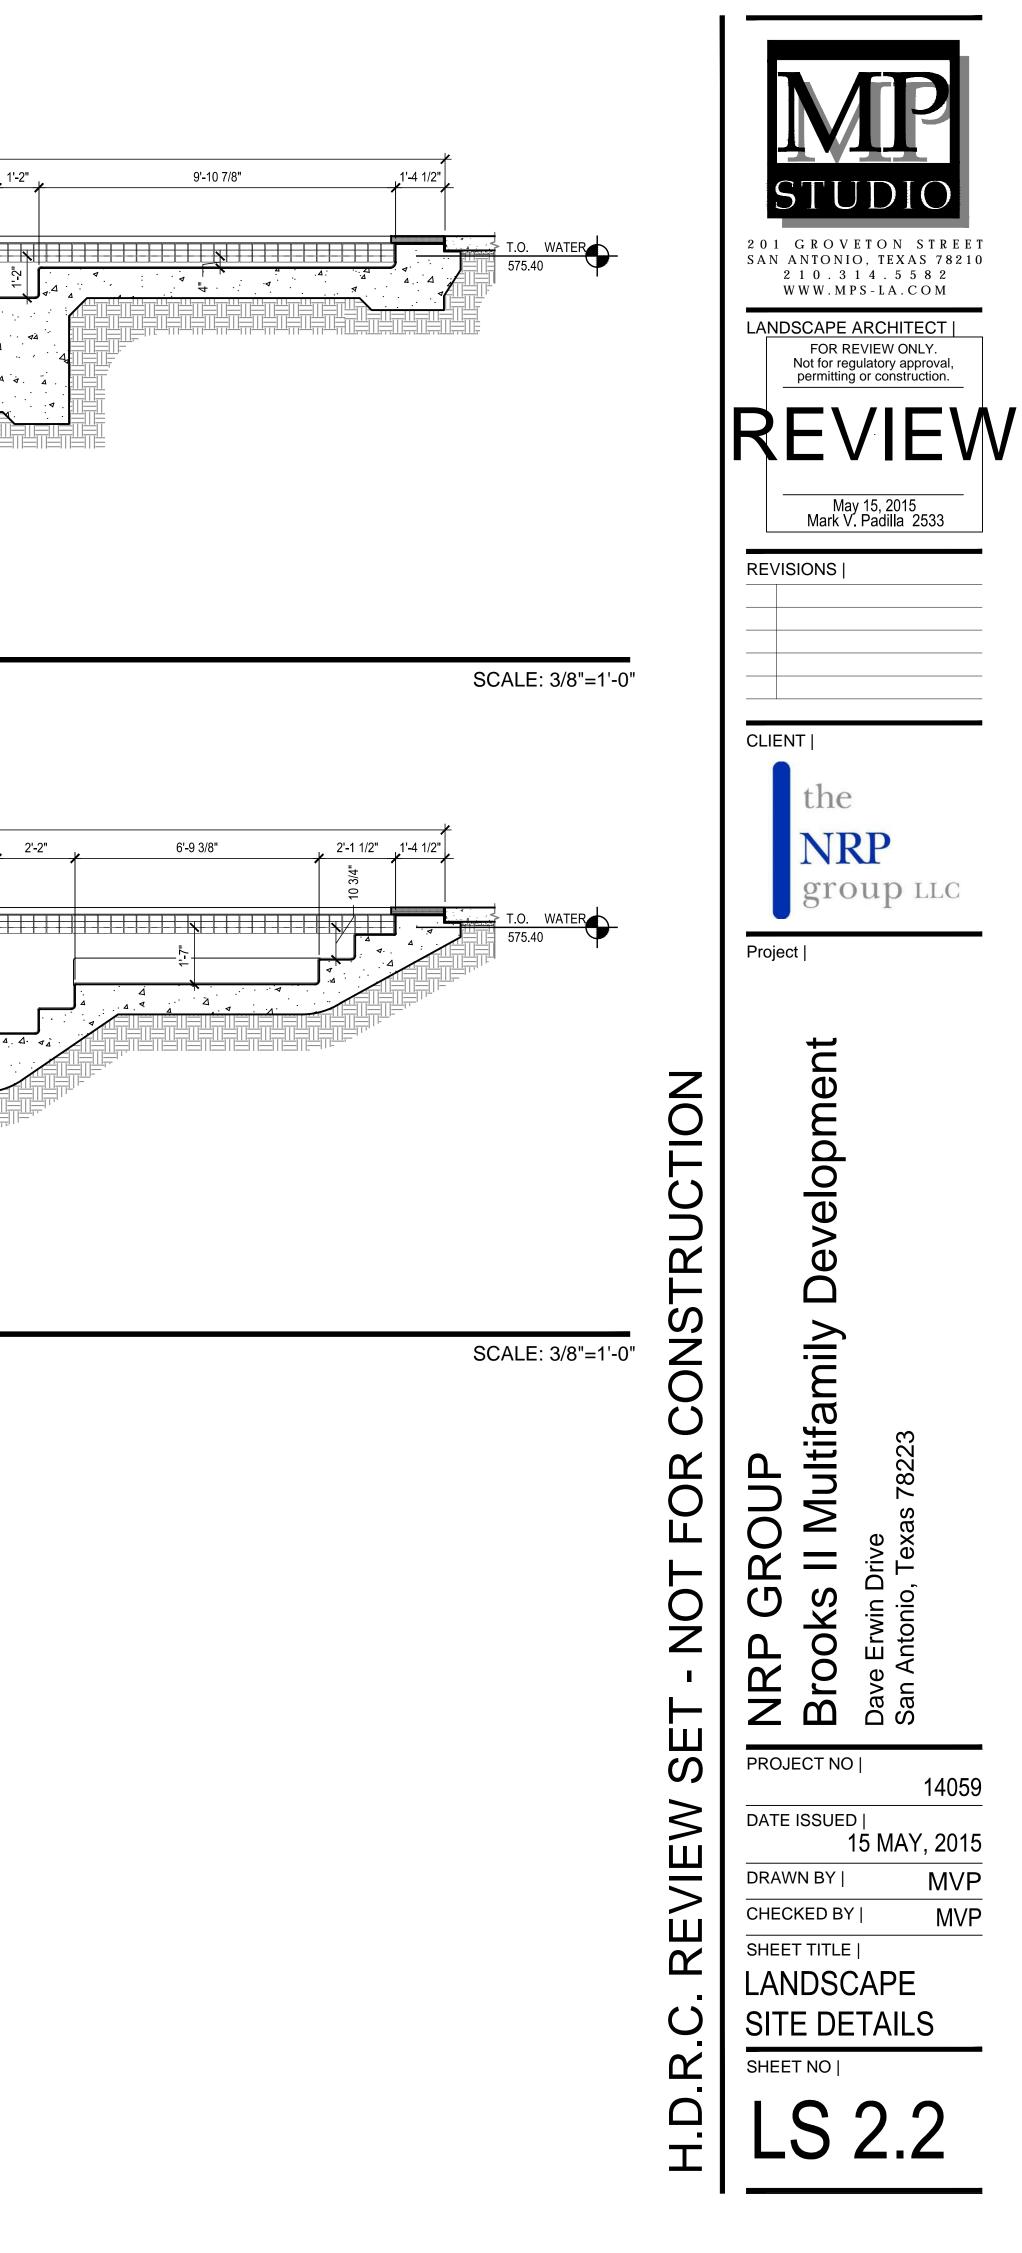

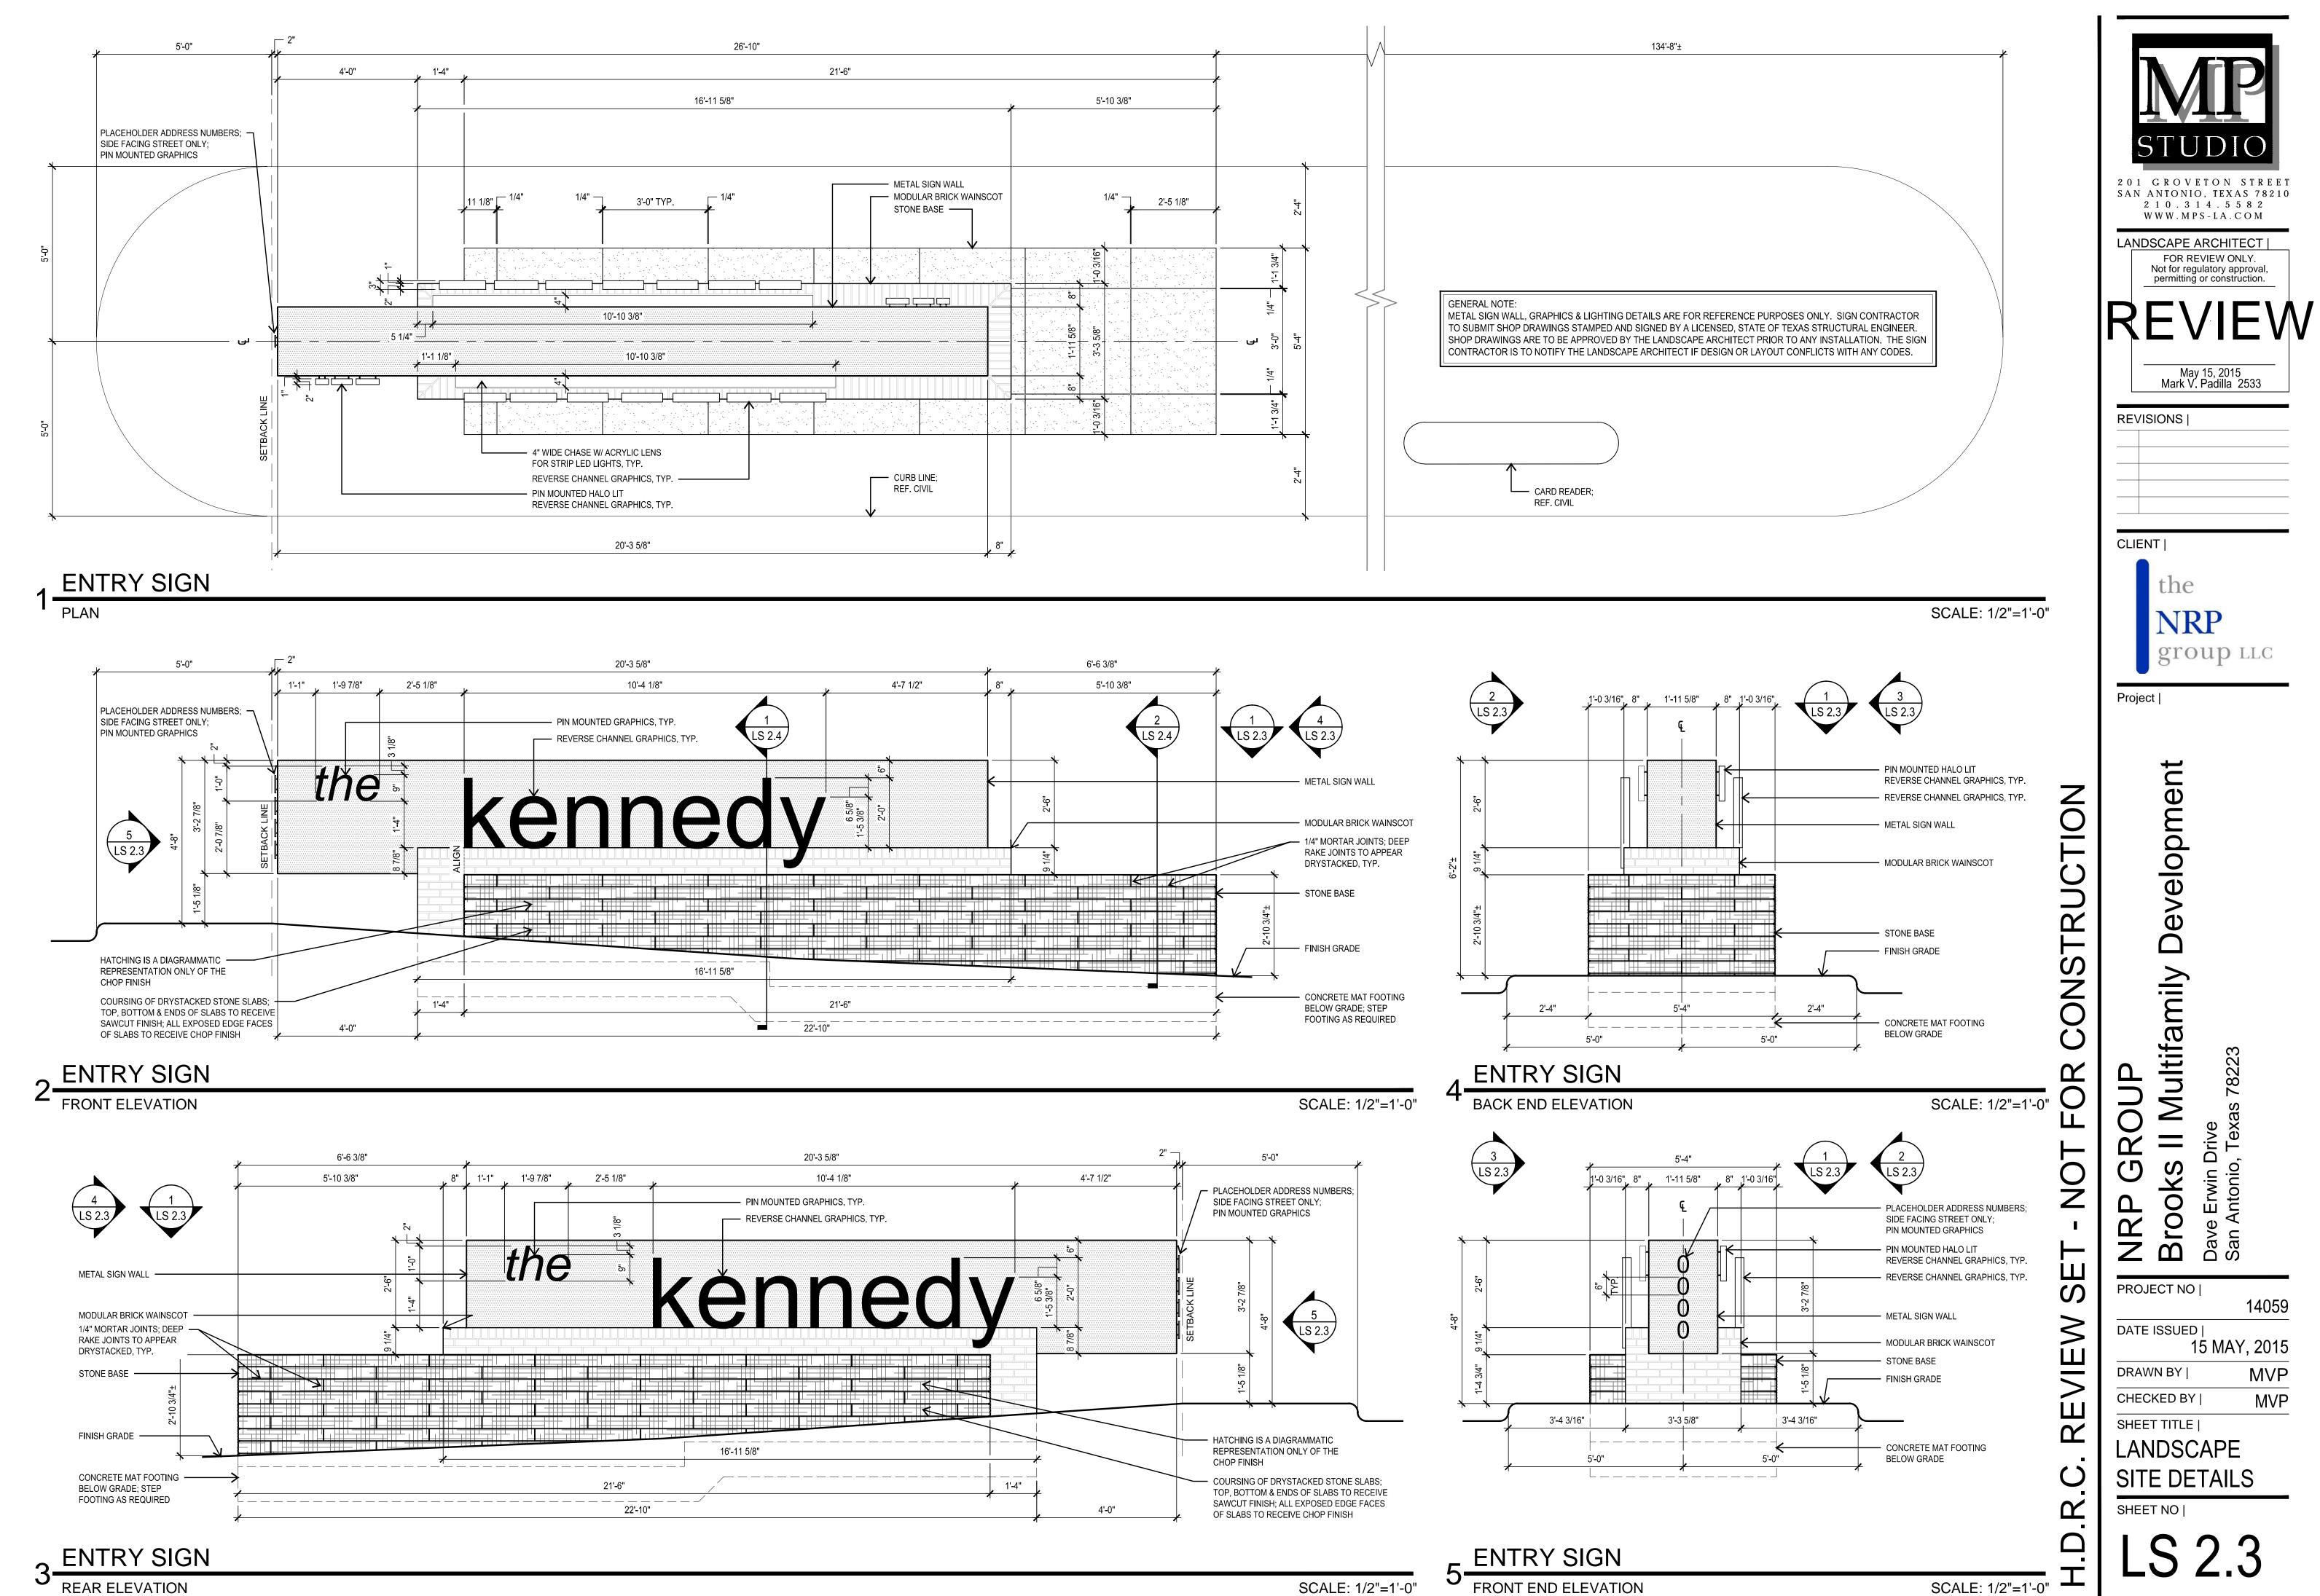


SCALE: 1/2"=1'-0"

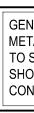

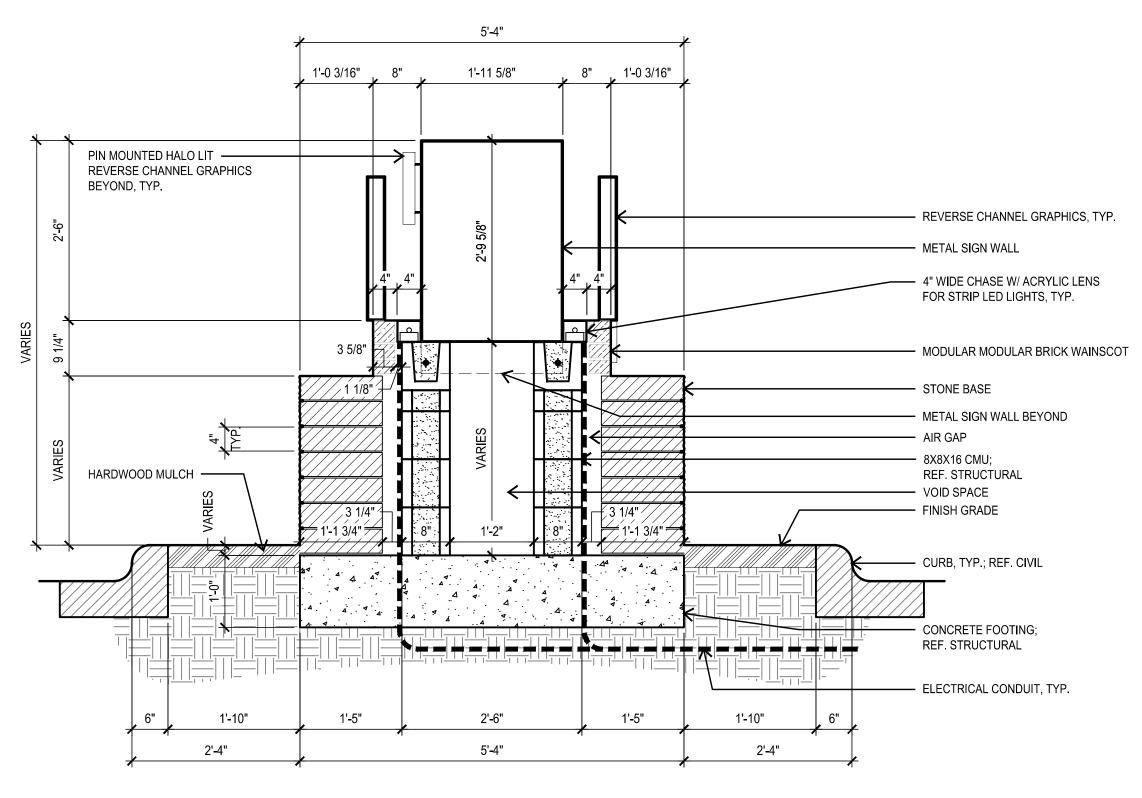

## **ENTRY SIGN**

SECTION AT SIGN WALL

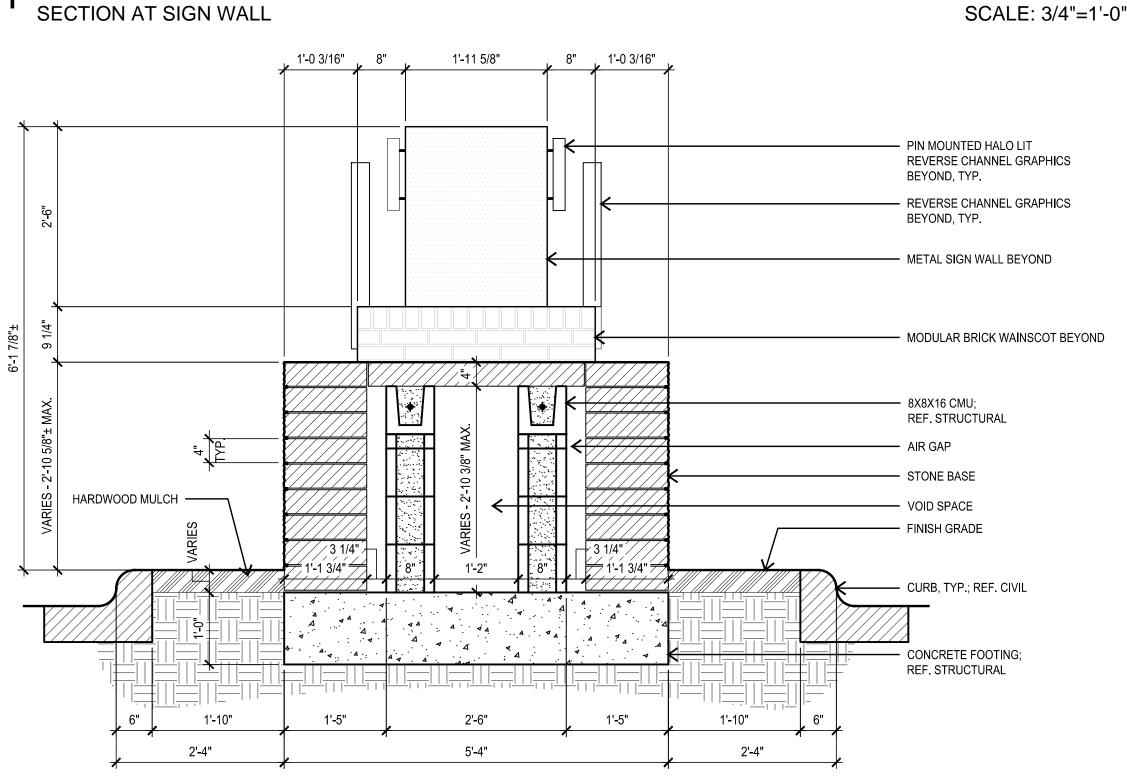



## GENERAL NOTE:

METAL SIGN WALL, GRAPHICS & LIGHTING DETAILS ARE FOR REFERENCE PURPOSES ONLY. SIGN CONTRACTOR TO SUBMIT SHOP DRAWINGS STAMPED AND SIGNED BY A LICENSED, STATE OF TEXAS STRUCTURAL ENGINEER. SHOP DRAWINGS ARE TO BE APPROVED BY THE LANDSCAPE ARCHITECT PRIOR TO ANY INSTALLATION. THE SIGN CONTRACTOR IS TO NOTIFY THE LANDSCAPE ARCHITECT IF DESIGN OR LAYOUT CONFLICTS WITH ANY CODES.

SCALE: 3/4"=1'-0"

STUDIO 201 GROVETON STREET SAN ANTONIO, TEXAS 78210  $2 \ 1 \ 0 \ . \ 3 \ 1 \ 4 \ . \ 5 \ 5 \ 8 \ 2$ WWW.MPS-LA.COM LANDSCAPE ARCHITECT | FOR REVIEW ONLY. Not for regulatory approval, permitting or construction. REVIEW May 15, 2015 Mark V. Padilla 2533 **REVISIONS** | CLIENT | the NRP group LLC Project | Multifamily Development  $\sim$ Ω Ω  $\square$ **()** S Brook ntoi Ω ш  $\mathbf{C}$ Dave San Ζ PROJECT NO | 14059 DATE ISSUED | 15 MAY, 2015 MVP DRAWN BY | CHECKED BY | MVP SHEET TITLE | LANDSCAPE SITE DETAILS SHEET NO |

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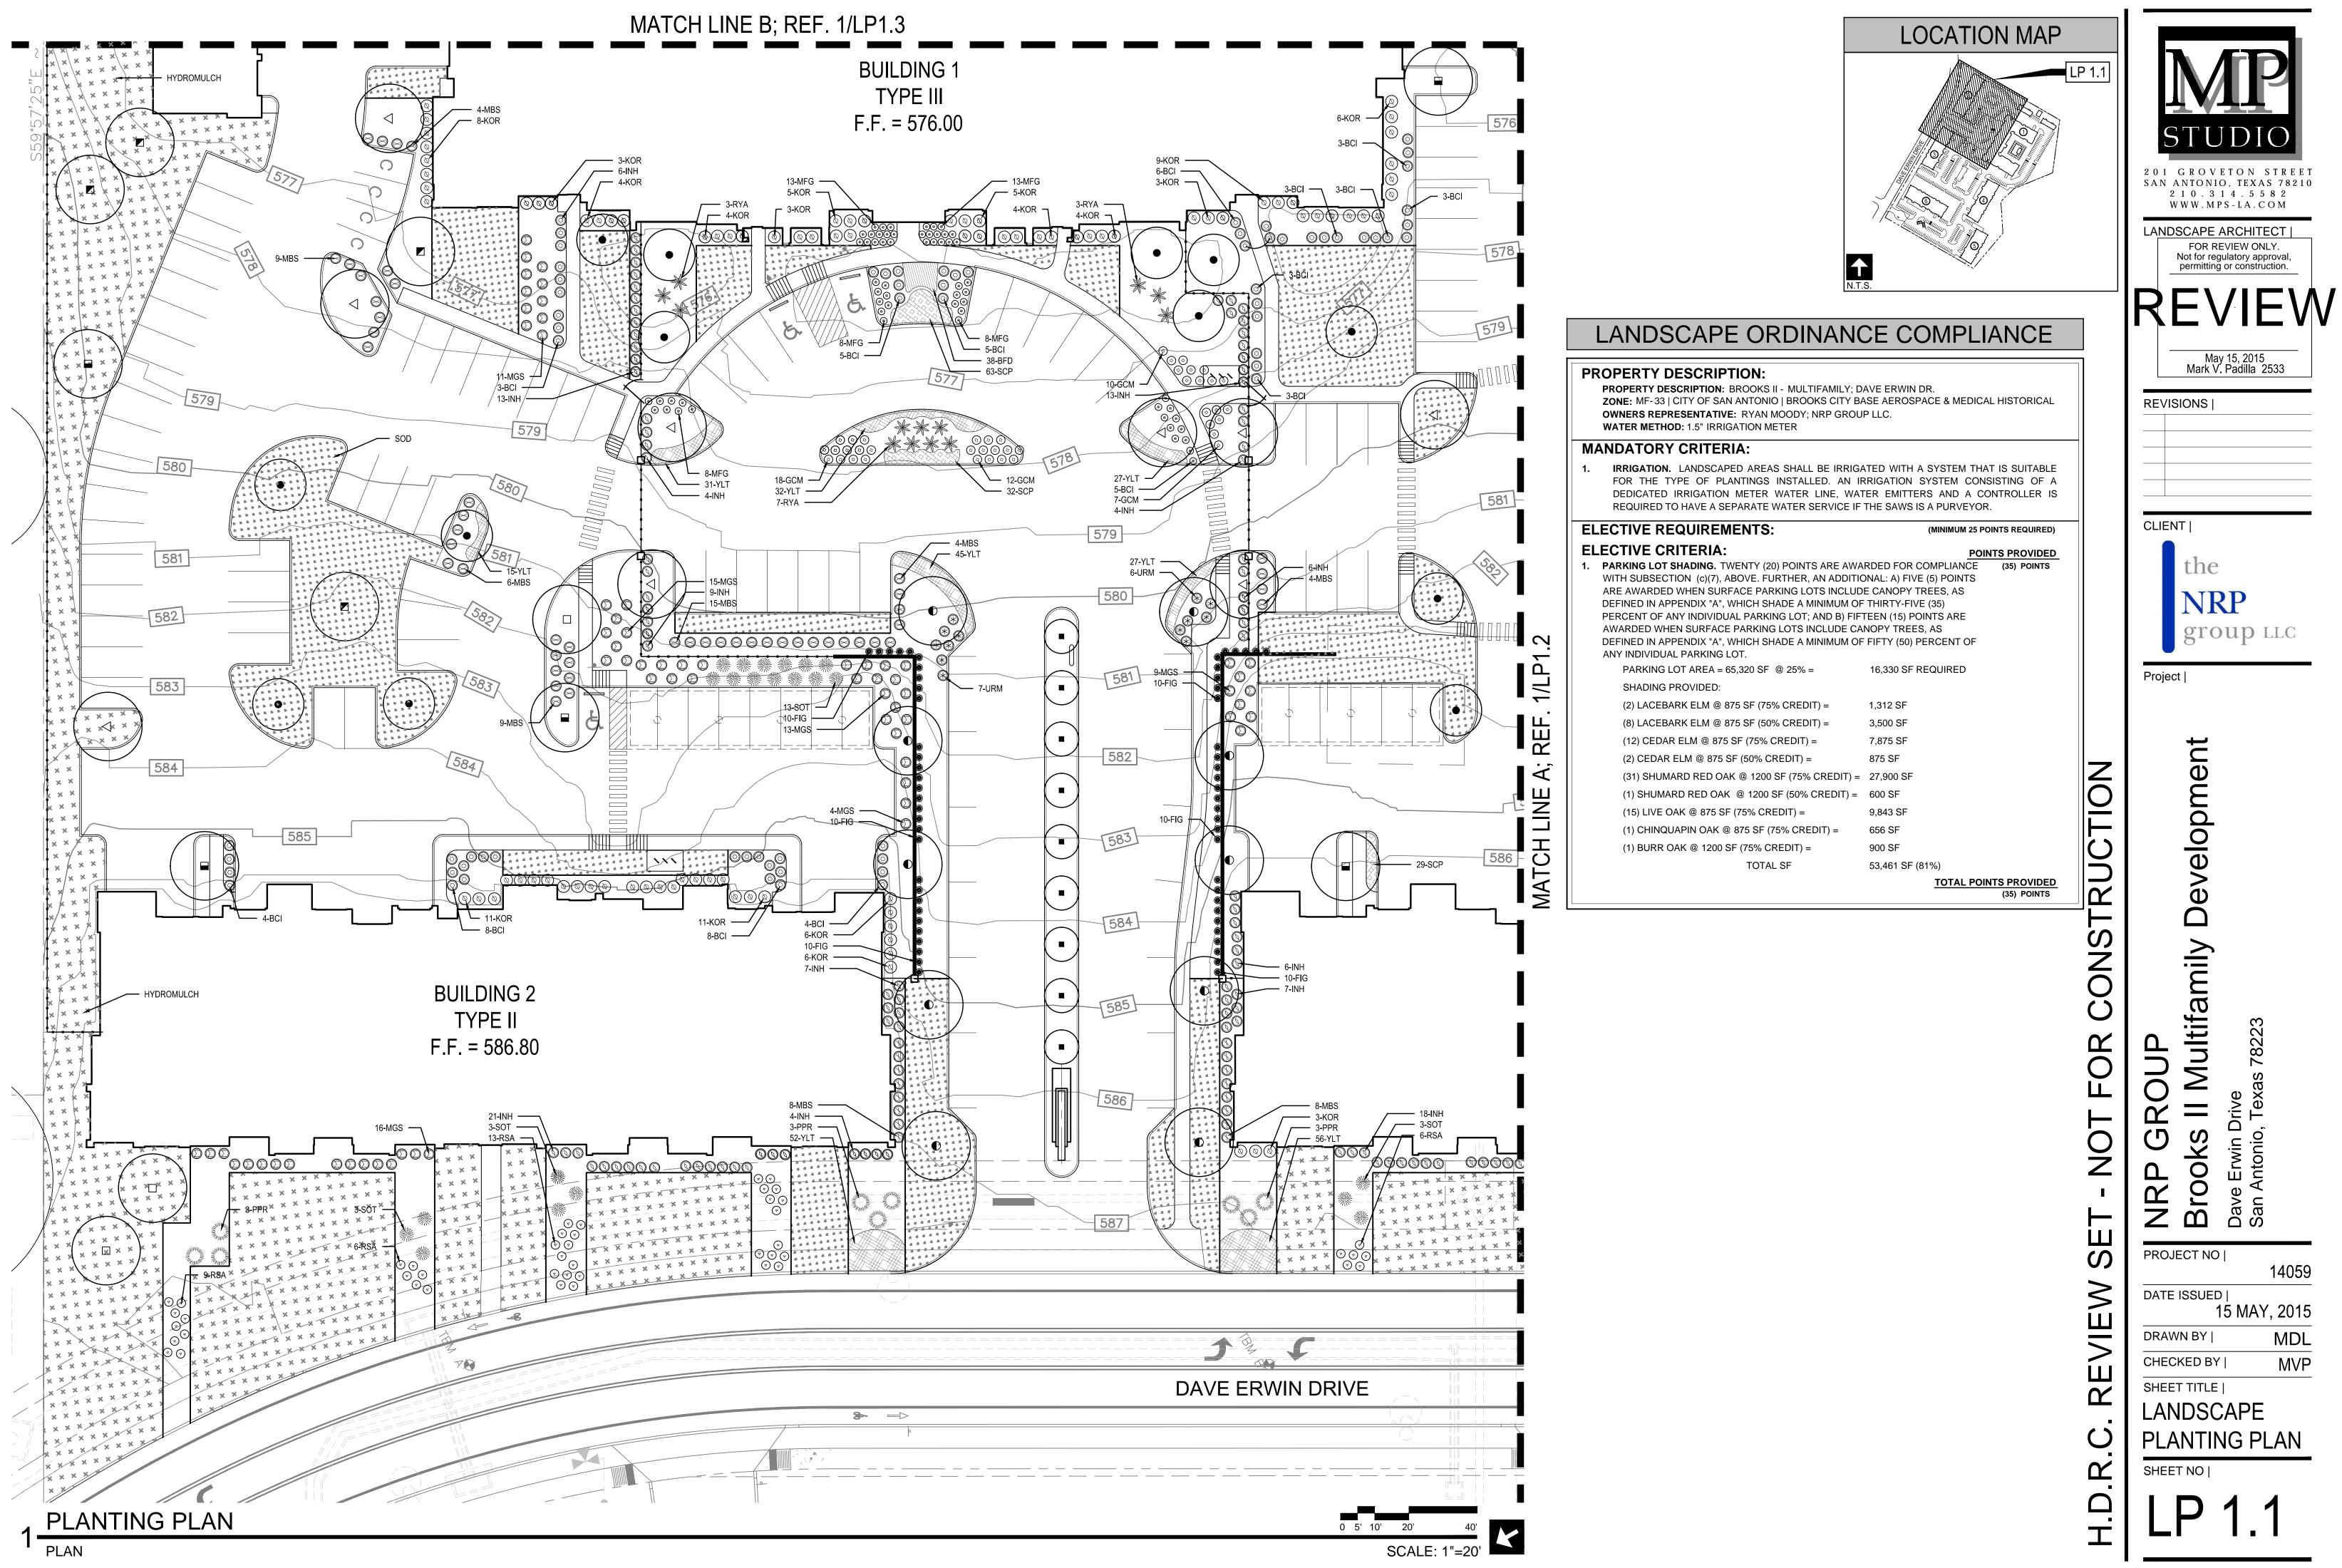
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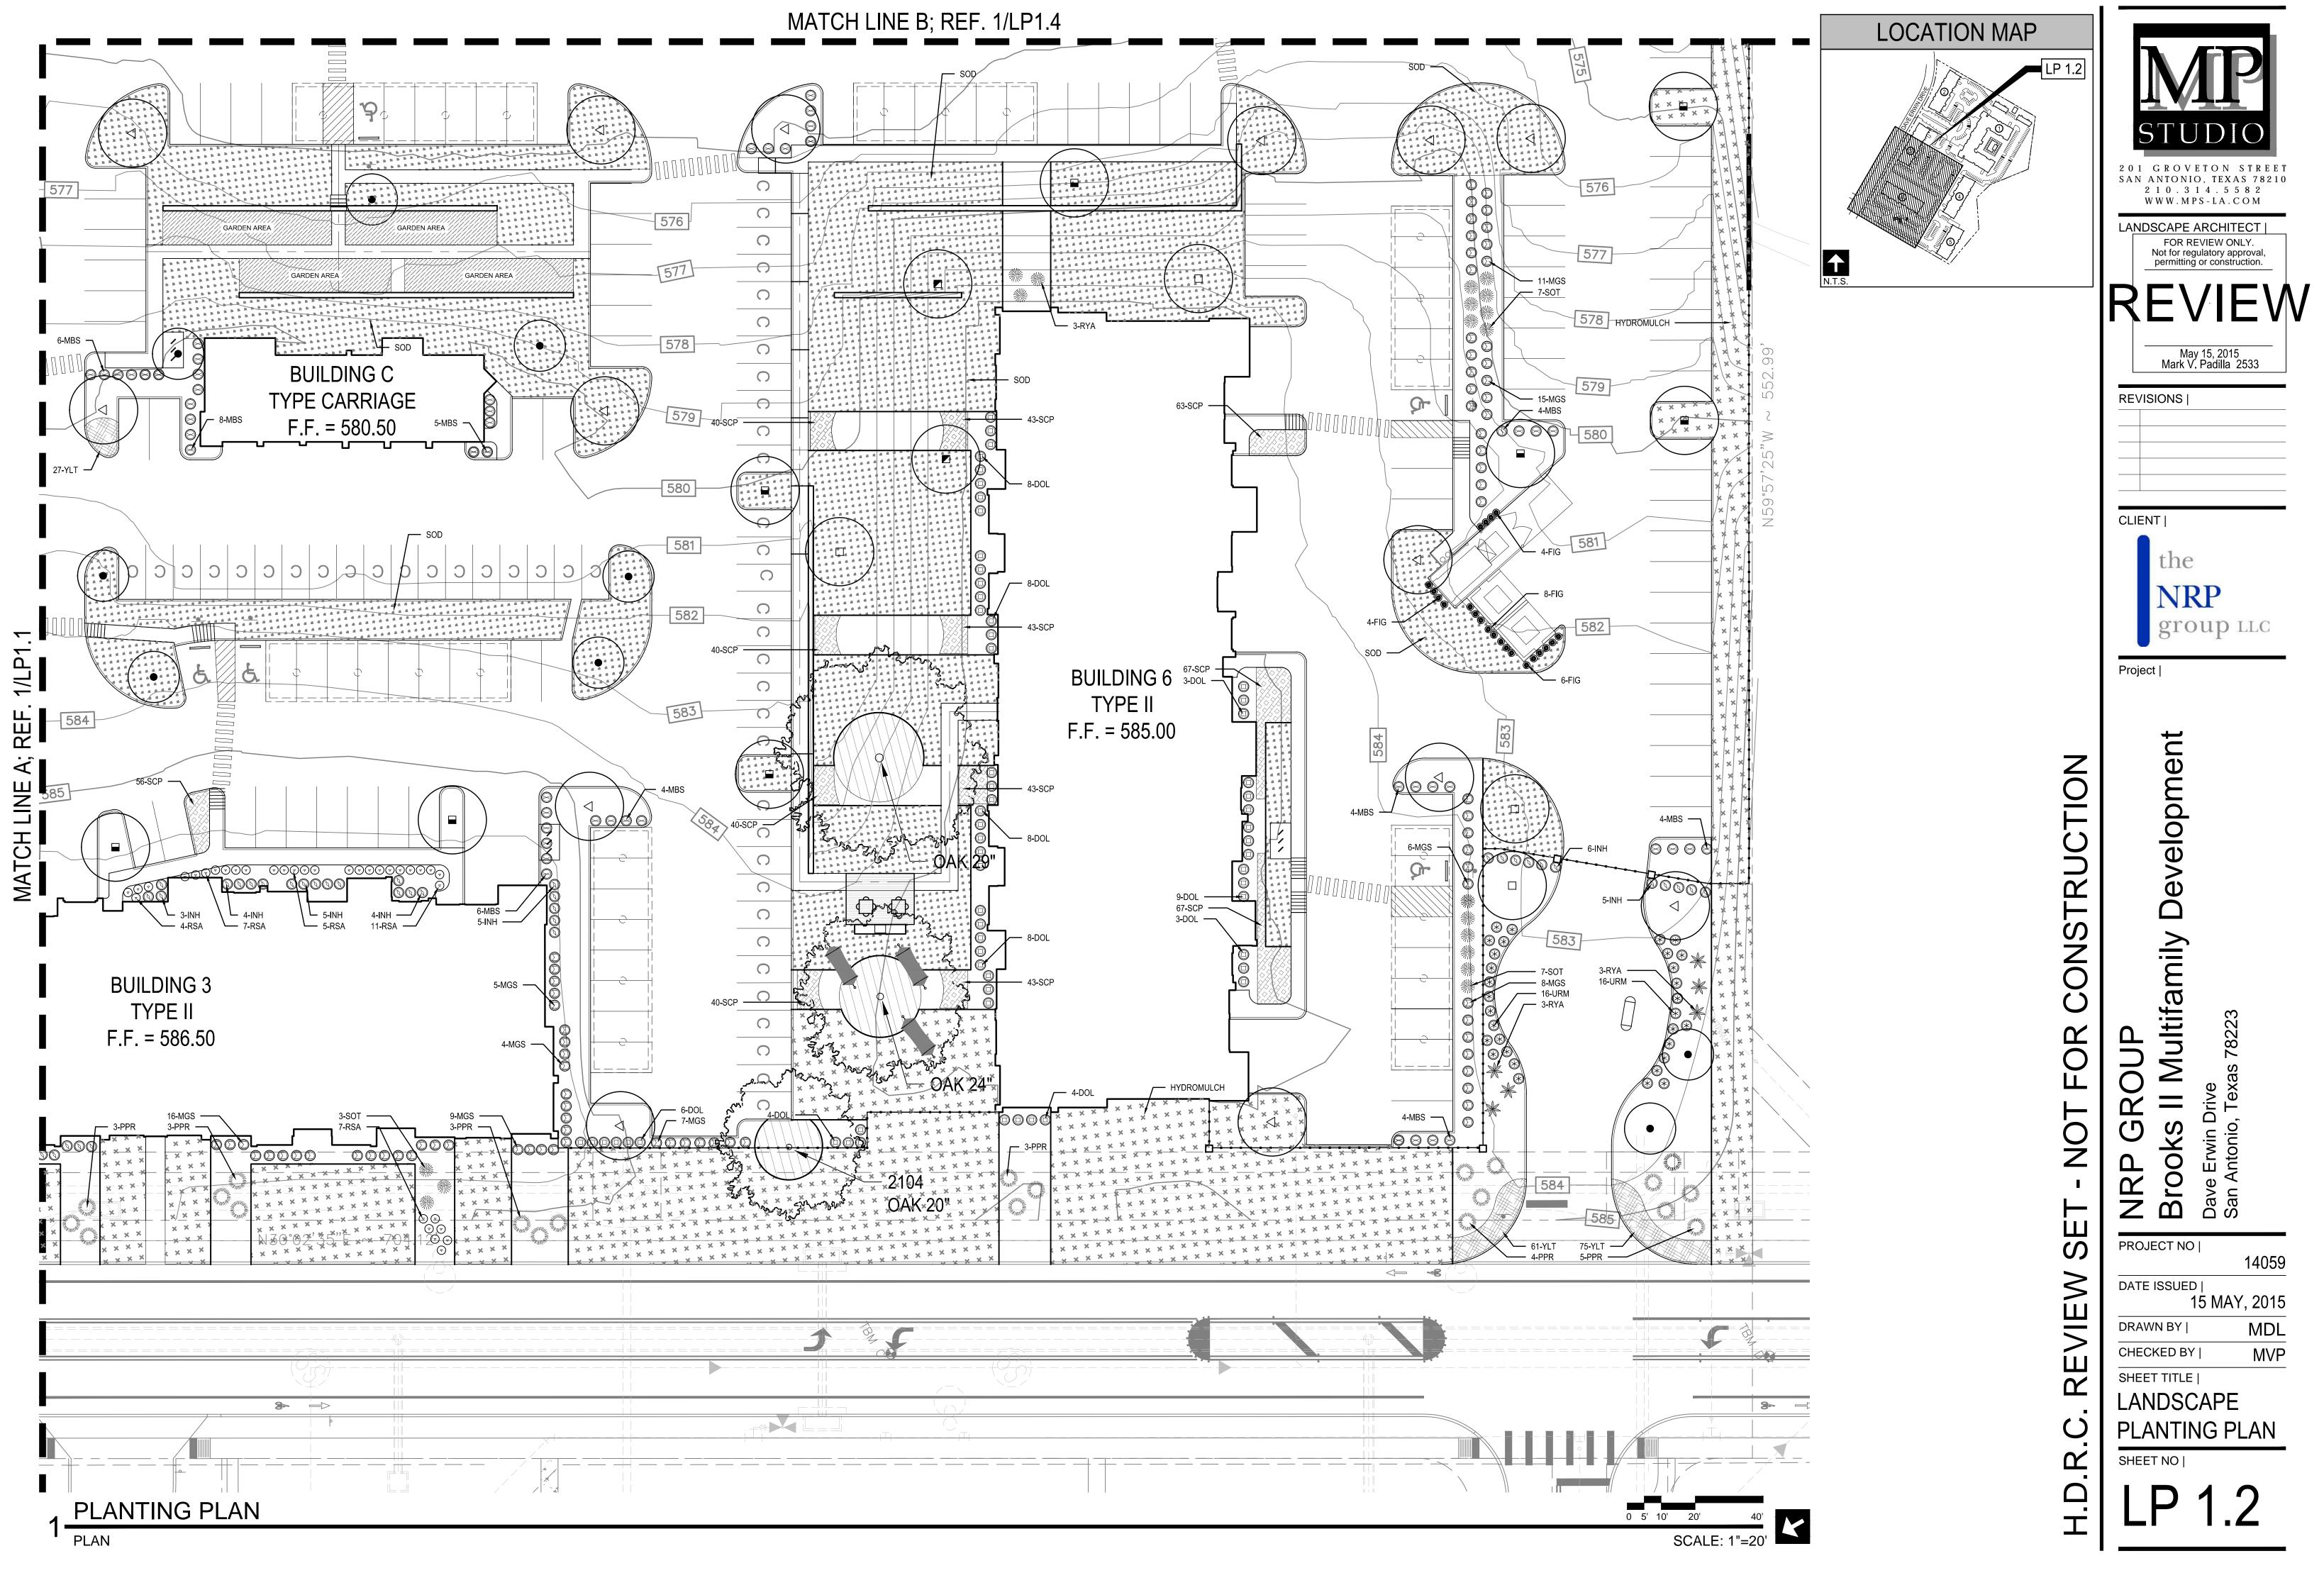
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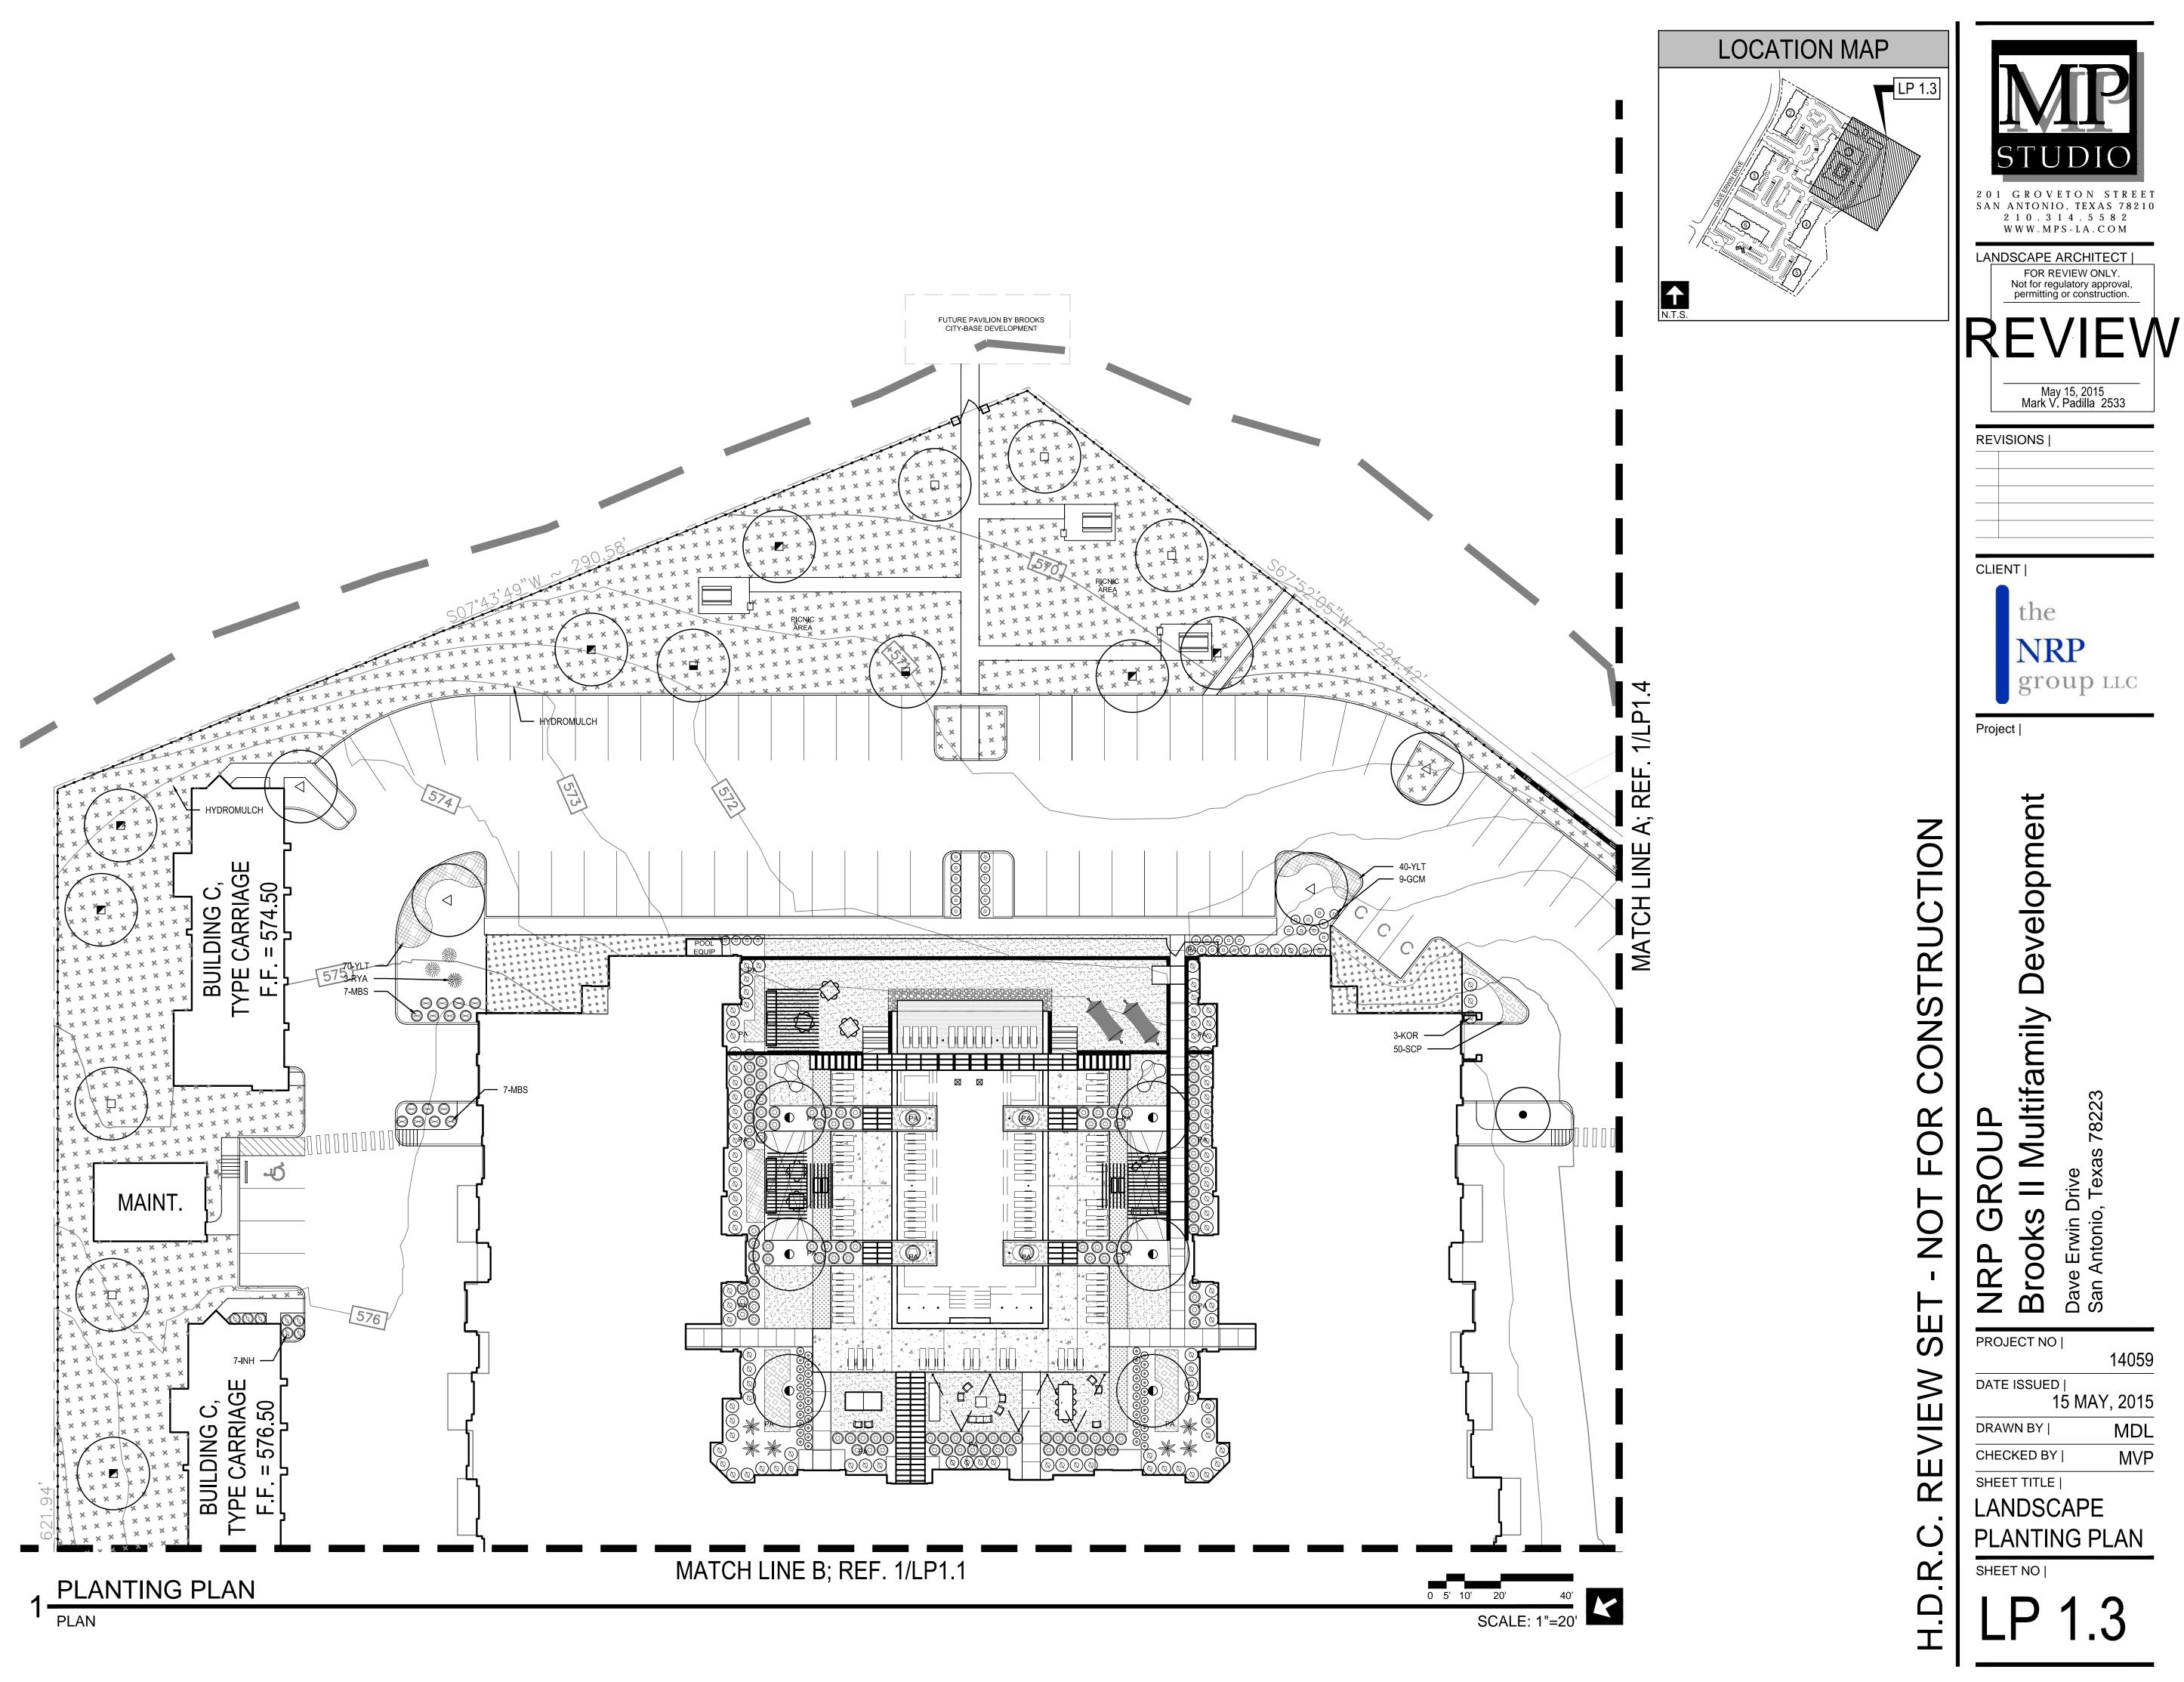
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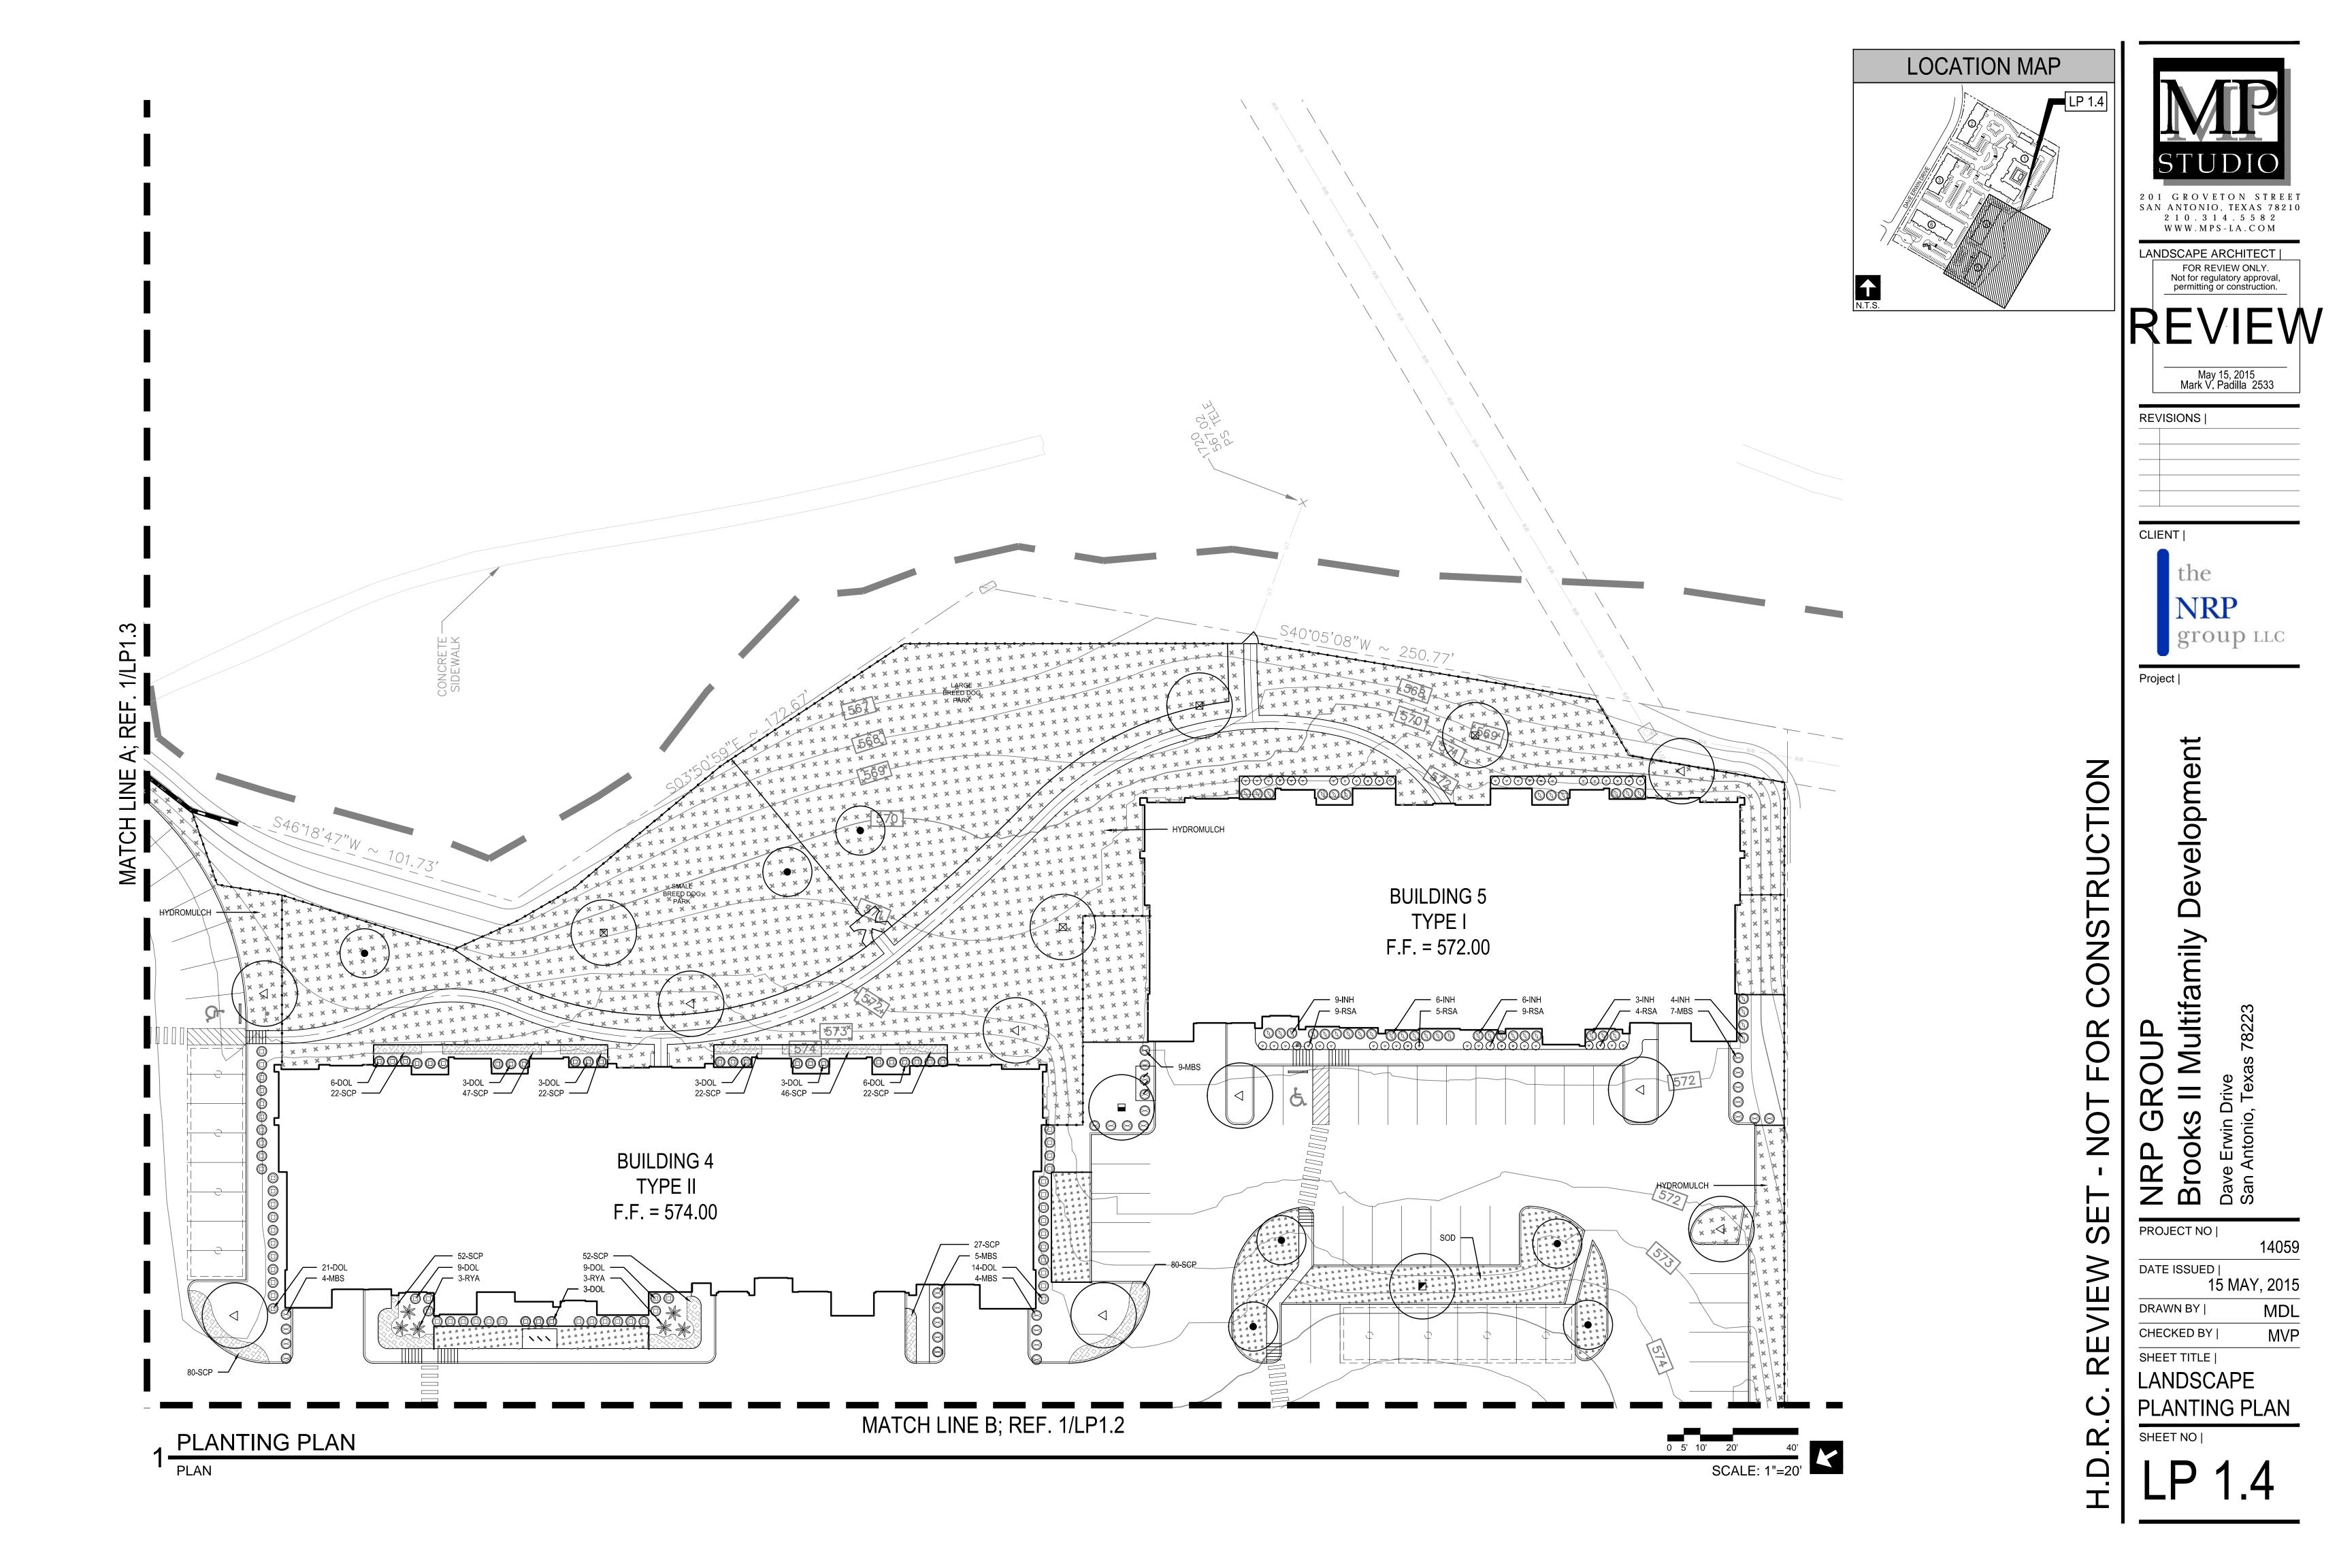
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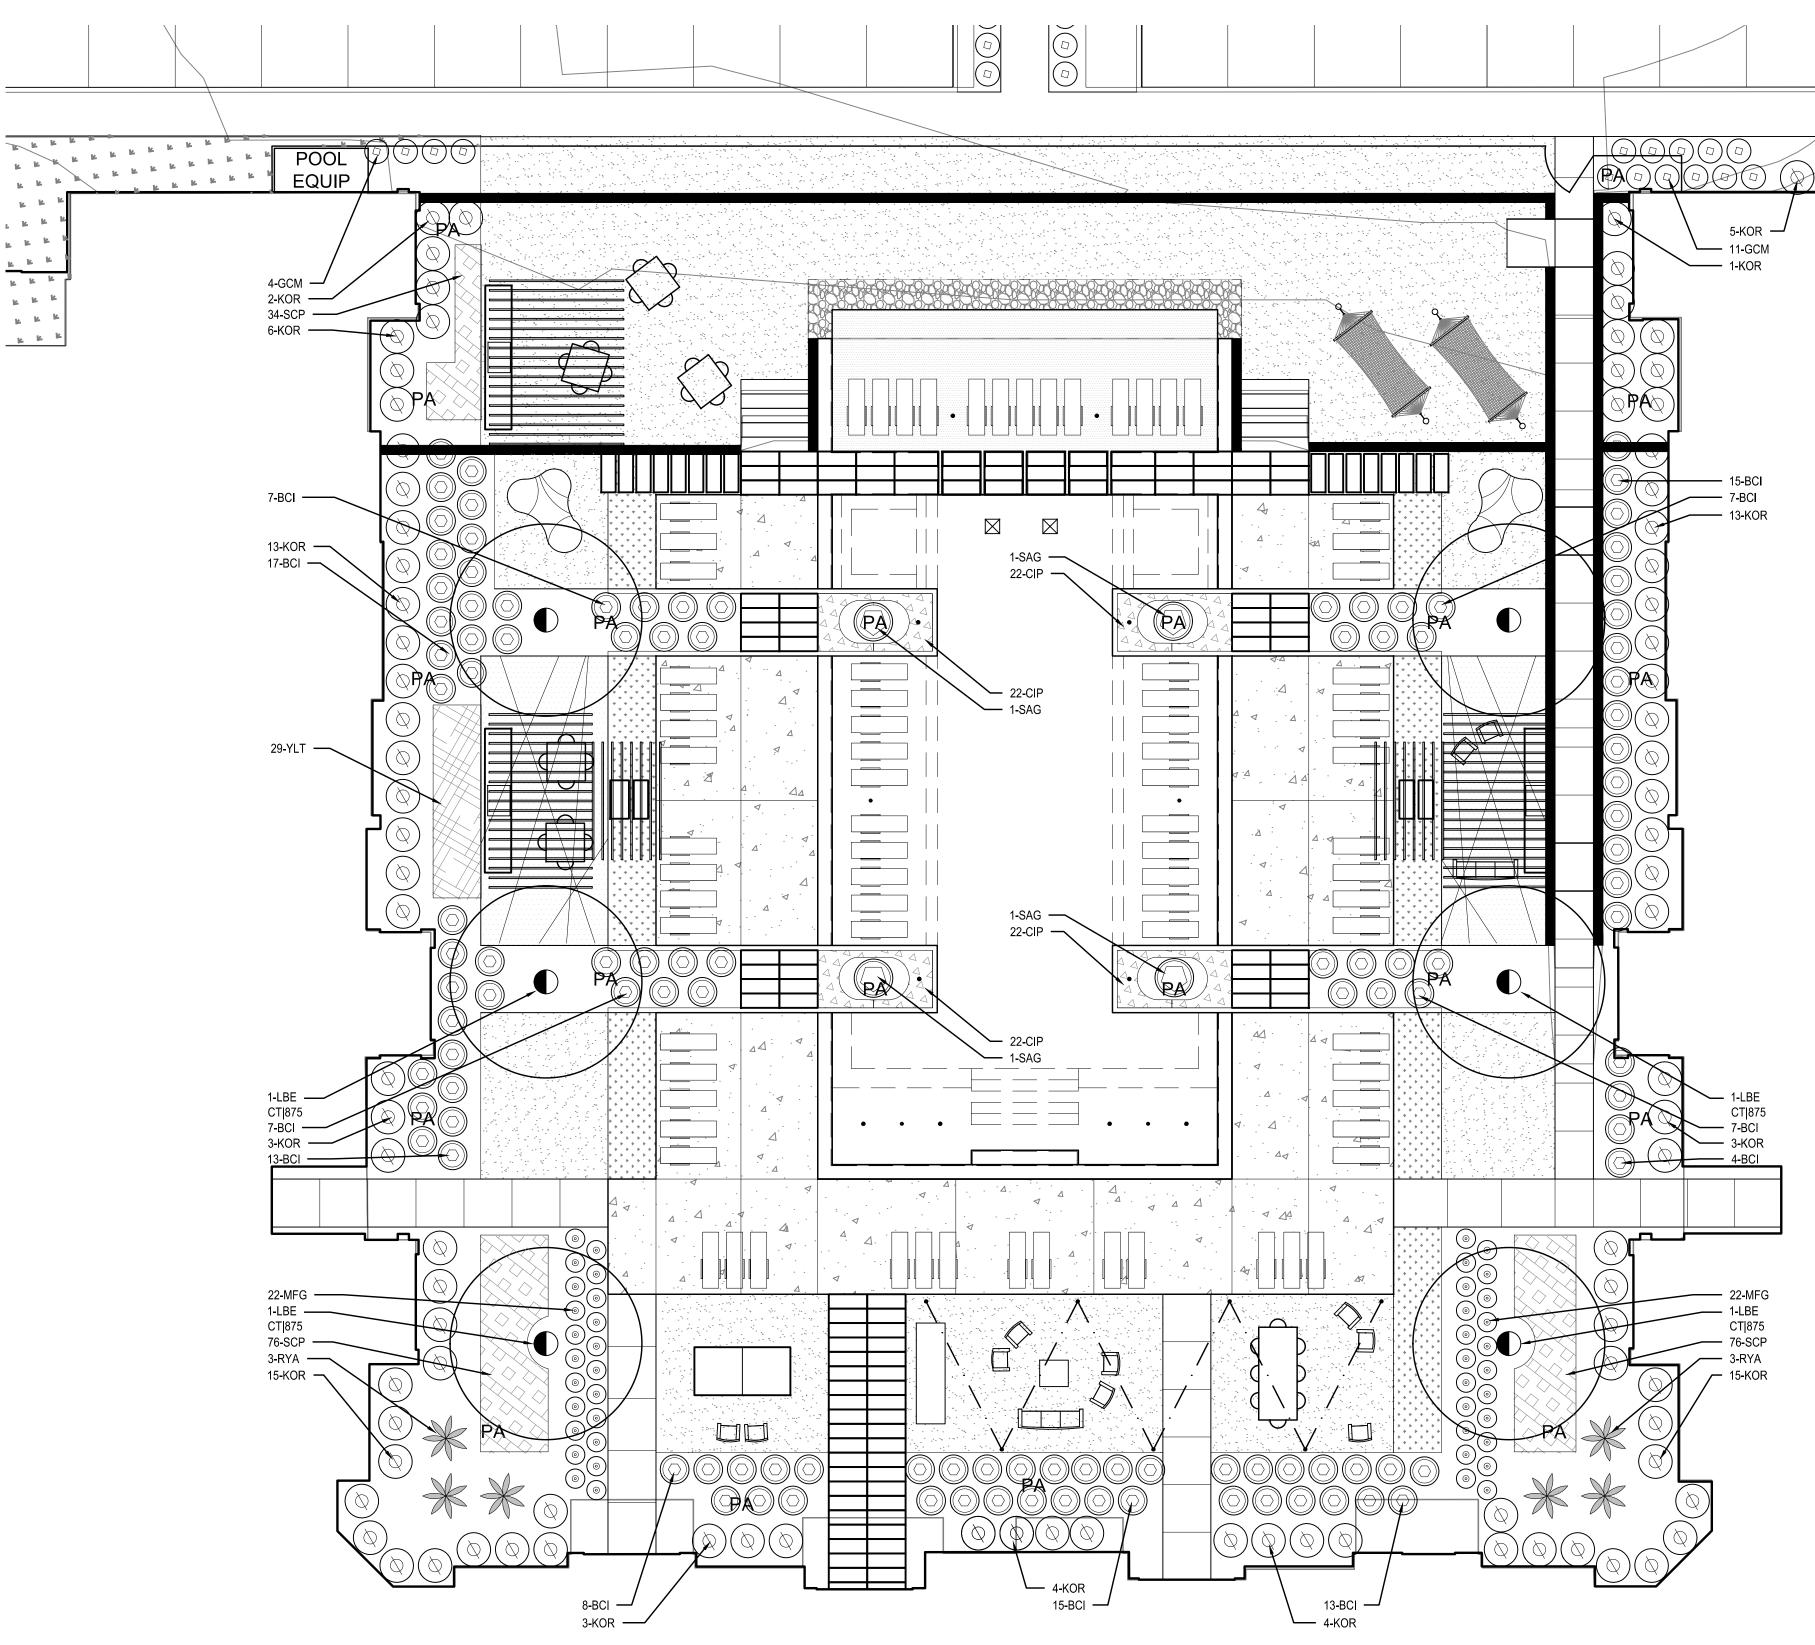
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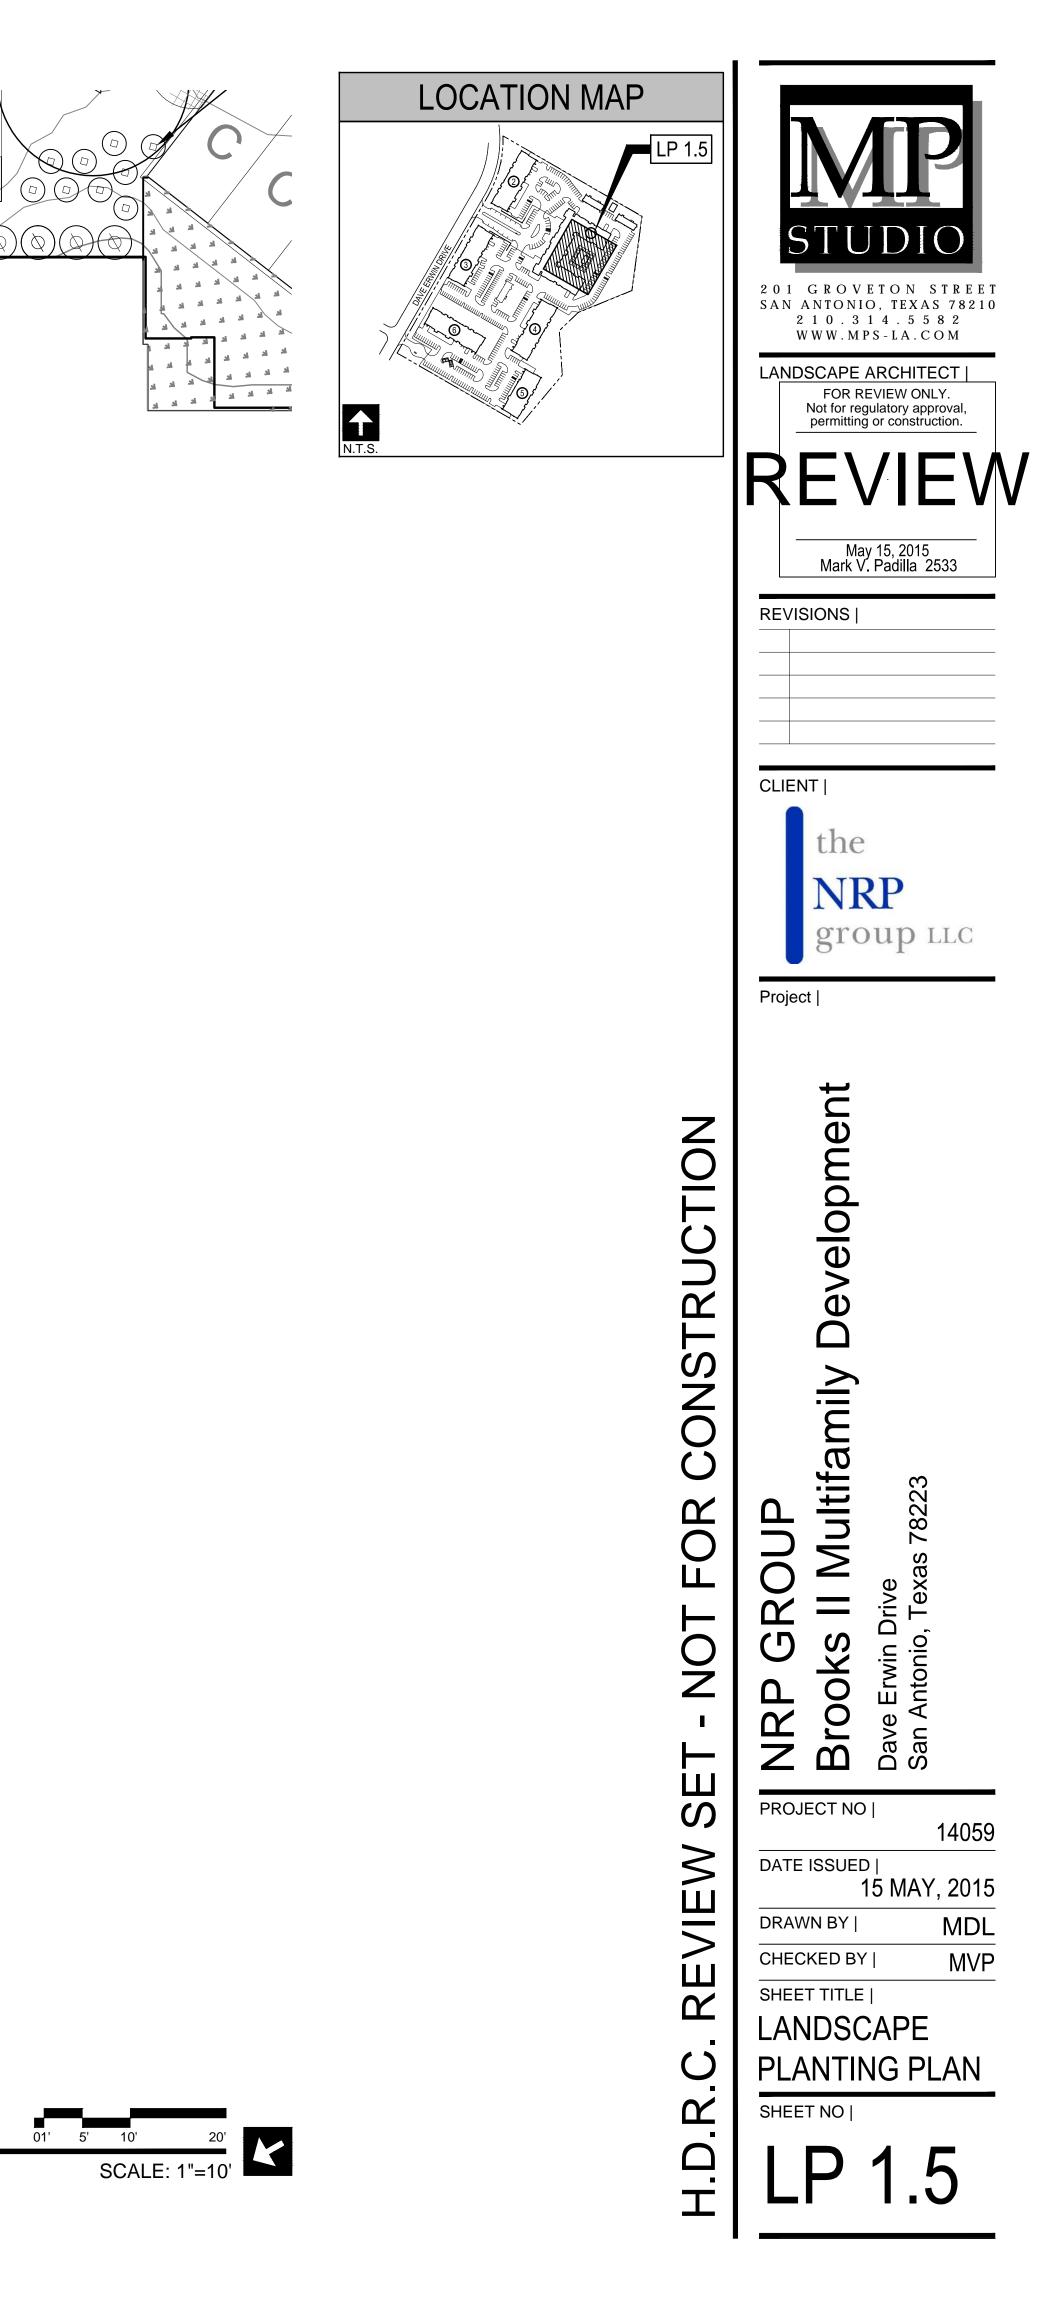



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**BUILDING 1** TYPE III F.F. = 576.00





SPECIES AND SIZE AS INDICATED IN PLANT SCHEDULE. LARGER SIZE MAY BE SUBSTITUTED WITHOUT ADDITIONAL COST TO OWNER,

BROKEN LIMBS, CROTCHES, AND DAMAGED TRUNKS, ROOTS OR LEAVES, SUN SCALD, FRESH BARK ABRASIONS, EXCESSIVE ABRASIONS, AND

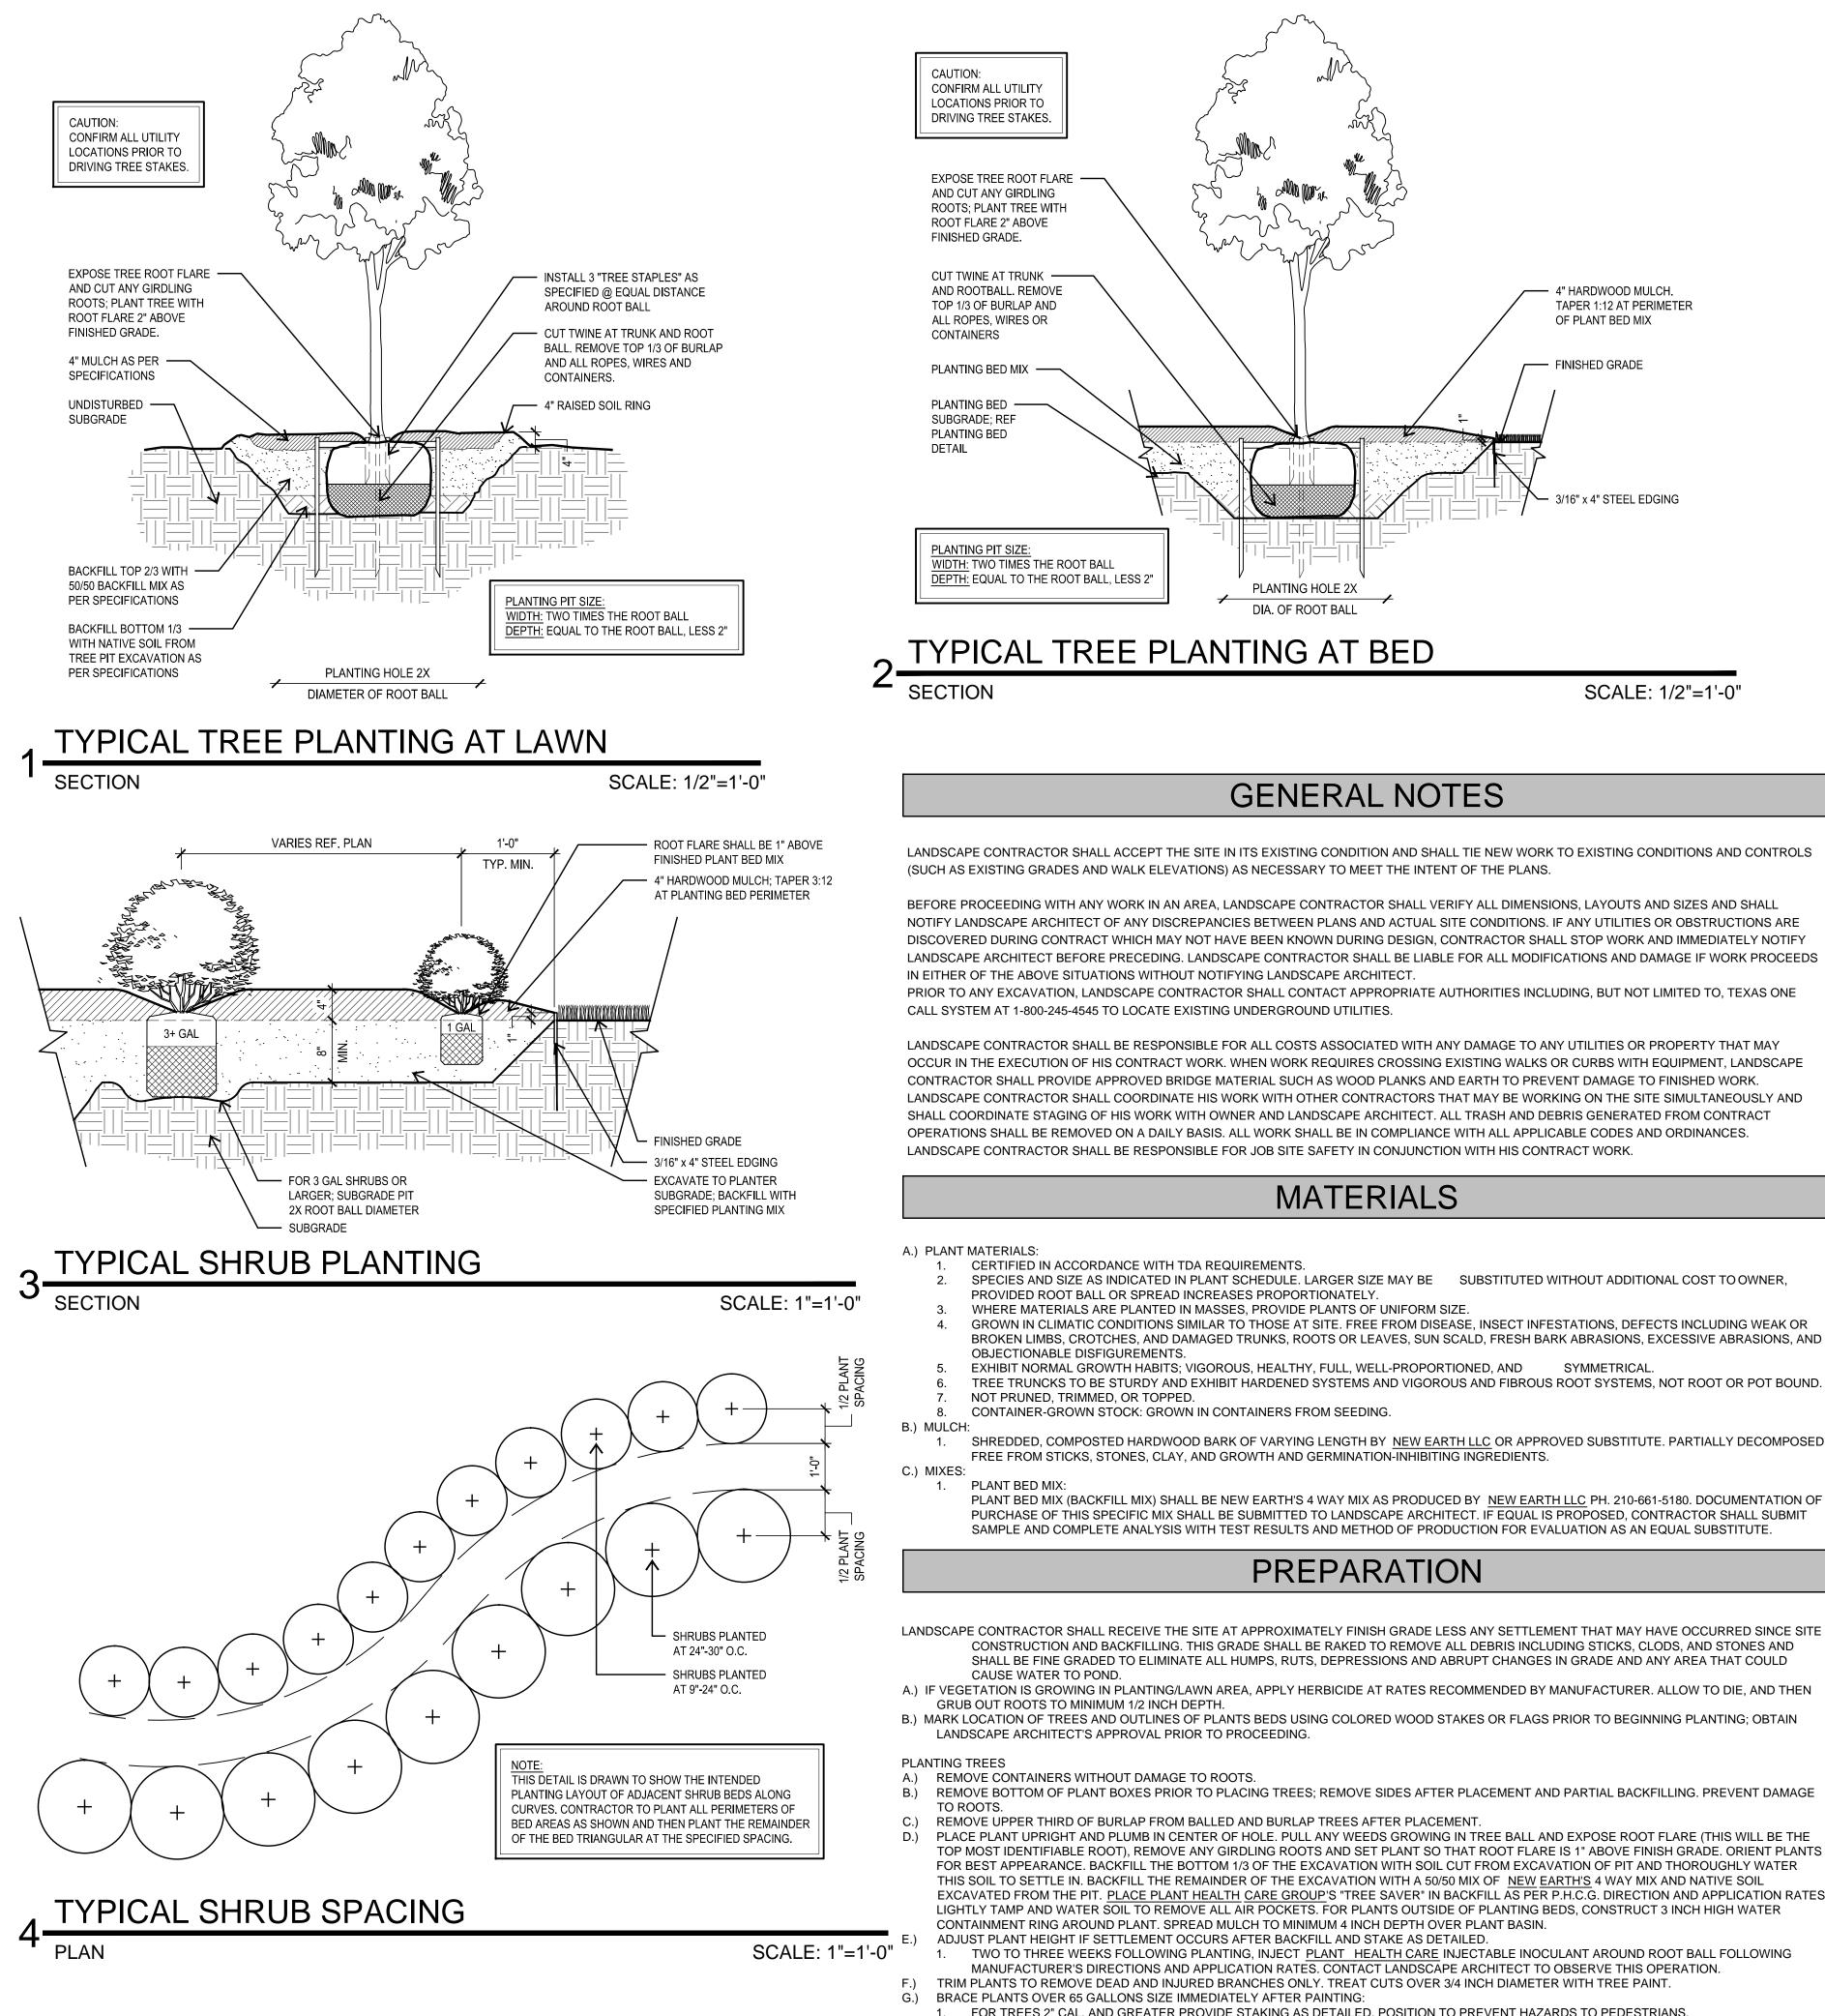TREE TRUNCKS TO BE STURDY AND EXHIBIT HARDENED SYSTEMS AND VIGOROUS AND FIBROUS ROOT SYSTEMS, NOT ROOT OR POT BOUND.

SHREDDED, COMPOSTED HARDWOOD BARK OF VARYING LENGTH BY <u>NEW EARTH LLC</u> OR APPROVED SUBSTITUTE. PARTIALLY DECOMPOSED;

PLANT BED MIX (BACKFILL MIX) SHALL BE NEW EARTH'S 4 WAY MIX AS PRODUCED BY NEW EARTH LLC PH. 210-661-5180. DOCUMENTATION OF PURCHASE OF THIS SPECIFIC MIX SHALL BE SUBMITTED TO LANDSCAPE ARCHITECT. IF EQUAL IS PROPOSED, CONTRACTOR SHALL SUBMIT

CONSTRUCTION AND BACKFILLING. THIS GRADE SHALL BE RAKED TO REMOVE ALL DEBRIS INCLUDING STICKS, CLODS, AND STONES AND SHALL BE FINE GRADED TO ELIMINATE ALL HUMPS, RUTS, DEPRESSIONS AND ABRUPT CHANGES IN GRADE AND ANY AREA THAT COULD

REMOVE BOTTOM OF PLANT BOXES PRIOR TO PLACING TREES; REMOVE SIDES AFTER PLACEMENT AND PARTIAL BACKFILLING. PREVENT DAMAGE

TOP MOST IDENTIFIABLE ROOT), REMOVE ANY GIRDLING ROOTS AND SET PLANT SO THAT ROOT FLARE IS 1" ABOVE FINISH GRADE. ORIENT PLANTS FOR BEST APPEARANCE. BACKFILL THE BOTTOM 1/3 OF THE EXCAVATION WITH SOIL CUT FROM EXCAVATION OF PIT AND THOROUGHLY WATER EXCAVATED FROM THE PIT. PLACE PLANT HEALTH CARE GROUP'S "TREE SAVER" IN BACKFILL AS PER P.H.C.G. DIRECTION AND APPLICATION RATES.

1. TWO TO THREE WEEKS FOLLOWING PLANTING, INJECT PLANT HEALTH CARE INJECTABLE INOCULANT AROUND ROOT BALL FOLLOWING

FOR TREES 2" CAL. AND GREATER PROVIDE STAKING AS DETAILED. POSITION TO PREVENT HAZARDS TO PEDESTRIANS. DO NOT RESTRICT PLANT MOVEMENT UNDER LIGHT WIND LOADS OR DAMAGE BARK.

TREES	TREES							
CALLOUT	QUANTITY	COMMON NAME BOTANICAL NAME	SIZE					
PE3	4	PECAN CARYA ILLINOINENSIS	3" CAL; MIN 12' HT; MIN 5' SPRD.					
LO3	30	LIVE OAK QUERCUS VIRGINIANA	3" CAL; MIN 15' HT; MIN 7' SPRD.					
LBE	16	LACEBARK ELM ULMUS PARVIFOLIA	3" CAL; MIN 12' HT; MIN 5' SPRD.					
RO3	36	SHUMARD OAK QUERCUS SHUMARDII	3" CAL; MIN 12' HT; MIN 5' SPRD.					
BO3	14	BURR OAK QUERCUS MACROCARPA	3" CAL; MIN 10' HT; MIN 4' SPRD.					
CO3	12	CHINQUAPIN OAK QUERCUS MUEHLENBERGII	3 CAL; MIN 12' HT; MIN 5' SPRD.					
CE3	16	CEDAR ELM ULMUS CRASSIFOLIA	3" CAL; MIN 8'-9' HT; MIN 3' SPRD.					

SHRUBS							
CALLOUT	QUANTITY	COMMON NAME BOTANICAL NAME	SIZE	REMARKS			
SAG	4	SAGO PALM CYCAS REVOLUTA	3 GAL.; 24" HT. 24" SPRD.	DARK GREEN; FULL; PLANT 36" O.C.			
MFG	105	MEXICAN FEATHER GRASS NASSELLA TENUISSIMA	3 GAL.; 24" HT. 24" SPRD.	DARK GREEN; FULL; PLANT 36" O.C.			
URM	45	UPRIGHT ROSEMARY ROSMARINUS OFFICINALIS 'UPRIGHT'	3 GAL.; 24" HT. 24" SPRD.	DARK GREEN; FULL; PLANT 60" O.C.			
BCI	180	BI-COLOR IRIS DIETES BICOLOR	3 GAL.; 24" HT. 24" SPRD.	DARK GREEN; FULL; PLANT 60" O.C.			
INH	198	INDIAN HAWTHORN RHAPHIOLEPIS INDICA	3 GAL.; 24" HT. 24" SPRD.	DARK GREEN; FULL; PLANT 48" O.C.			
MBS	170	LINDHEIMER MUHLY GRASS MUHLENBERGIA LINDHEIMERI	1 GAL.; 24" HT. 24" SPRD.	DARK GREEN; FULL; PLANT 60" O.C.			
MGS	149	DWARF MAIDEN GRASS MISCANTHUS SINENSIS	3 GAL.; 24" HT. 24" SPRD.	DARK GREEN; FULL; PLANT 60" O.C.			
KOR	209	'KNOCK OUT' ROSE ROSA 'KNOCK OUT'	3 GAL.; 24" HT. 24" SPRD.	DARK GREEN; FULL; PLANT 60" O.C.			
PPR	31	PRICKLY PEAR 'THORNLESS' OPUNTIA CACANAPA ELLISIANA	3 GAL.; 24" HT. 24" SPRD.	DARK GREEN; FULL; PLANT 60" O.C.			
SOT	47	TEXAS GREEN SOTOL DASYLIRION TEXANUM	1 GAL.; 24" HT. 24" SPRD.	DARK GREEN; FULL; PLANT 60" O.C.			
RYA	31	RED YUCCA HESPERALOE PARVIFOLIA	3 GAL; 20" HT. 20" SPRD.	DARK GREEN; FULL, PLANT 60" O.C.			
DOL	168	DWARF OLEANDER NERIUM OLEANDER 'DWARF PINK'	3 GAL; 20" HT. 20" SPRD.	DARK GREEN; FULL, PLANT 60" O.C.			
GCM	84	GULF COAST MUHLY MUHLENBERGIA CAPILLARIS	3 GAL.; 24" HT. 24" SPRD.	DARK GREEN; FULL; PLANT 60" O.C.			
TCP	25	TURKS CAP MALVAVISCUS ARBOREUS VAR. DRUMMONDII	1 GAL; 18" HT. 12" SPRD.	DARK GREEN; FULL, PLANT 36" O.C.			
FIG	88	FIG IVY FICUS PUMILA	1 GAL; 18" HT. 12" SPRD.	DARK GREEN; FULL, STAKED			
CIP	88	CAST IRON PLANT MELAMPODIUM LEUCANTHUM	1 GAL.; 24" HT. 18" SPRD.	DARK GREEN; FULL; PLANT 18" O.C.			

GROUNDCOVER						
CALLOUT	QUANTITY	COMMON NA BOTANICAL				

CALLOUT	QUANTITY	COMMON NAME BOTANICAL NAME	SIZE	REMARKS
BFD	38	BLACK FOOT DAISY MELAMPODIUM LEUCANTHUM	1 GAL.; 18" HT. 18" SPRD.	DARK GREEN; FULL; PLANT 18" O.C.
SCP	1500	SKULL CAP SCUTELLARIA SUFFRUTESCENS 'TEXAS ROSE'	1 GAL; 12" HT. 10" SPRD.	DARK GREEN; FULL, PLANT 30" O.C.
RSA	144	RED SALVIA SALVIA SPLENDENS	1 GAL.; 18" HT. 12" SPRD.	DARK GREEN; FULL; PLANT 30" O.C.
YLT	587	YELLOW LANTANA LANTANA X HYBRIDA	1 GAL.; 24" HT. 24" SPRD.	DARK GREEN; FULL; PLANT 18" O.C.
LAWN				
CALLOUT	QUANTITY	COMMON NAME BOTANICAL NAME	SIZE	REMARKS
	FIELD VERIFY	COMMON BERMUDA CYNODON DACTYLON	SOLID SOD	CONTINUOUS SOLID SOD STRIP ALONG BACK OF CURB. CONTRACTOR TO FIELD VERIFY QUANTITY OF LAWN REQUIRED.
	FIELD VERIFY	COMMON BERMUDA CYNODON DACTYLON	HYDROMULCH	SEEDS 2 LBS./1,000 SQ.FT. CONTRACTOR TO FIELD VERIFY QUANTITY OF LAWN REQUIRED.

## PLANT LIST

REMARKS SINGLE TRUNK B&B; STRAIGHT TRUNK WITH FULL AND UNIFORM CANOPY; PARK GRADE NOT ACCEPTABLE SINGLE TRUNK B&B; STRAIGHT TRUNK WITH FULL AND UNIFORM CANOPY; PARK GRADE NOT ACCEPTABLE CONTAINER GROWN; STRAIGHT TRUNK W/ FULL AND UNIFORM CANOPY; PARK GRADE NOT ACCEPTABLE SINGLE TRUNK B&B; STRAIGHT TRUNK WITH FULL AND UNIFORM CANOPY; PARK GRADE NOT ACCEPTABLE SINGLE TRUNK B&B; STRAIGHT TRUNK WITH FULL AND UNIFORM CANOPY: PARK GRADE NOT ACCEPTABLE SINGLE TRUNK B&B; STRAIGHT TRUNK WITH FULL AND UNIFORM CANOPY; PARK GRADE NOT ACCEPTABLE SINGLE TRUNK B&B; STRAIGHT TRUNK WITH FULL AND UNIFORM CANOPY; PARK GRADE NOT ACCEPTABLE

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oks II Multifamily Development		IT	SIONS	Ma Mark V	Not for re	ANTONI 10.3 VWW.M			
Erwin Drive ntonio, Texas 78223				ay 15, 2015 /. Padilla 2533	EVIEW ONLY. gulatory approval, g or construction.	ETON STREET O, TEXAS 78210 14.5582 PS-LA.COM	JDIO	P	

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PLANT LIST

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15 MAY, 2015

PROJECT NO |

DATE ISSUED


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PROJECT ARCHITECT D	PROJECT TRACT CAN BE RELOCATED.
ARCHITECTURAL REVIEW THE PROJECT ARCHITECT HAS REVIEWED CONFIRM COMPLIANCE WITH APPLICABLE SEPARATION, OPEN AREA REQUIREMENTS AND OR REQUIREMENTS.	D FLOODPLAIN LINE WAS LOODPLAIN LINE PROVID LINE IS ACCURATE. A THE AERIAL THERE ARE
	S PROJECT IS LOCATED WITHIN THE CITY OF SAN ANTONIO. THE AY. DESIGN CRITERIA WAS TAKEN FROM THE CITY ONLINE ZONING IDEM PARKING WAS NOT USED TO MEET THE CITY PARKING REQUIP IG STANDARDS. THE CITY HAS A MAXIMUM PARKING REQUIREMENT S PROJECT IS SUBJECT TO THE INTERNATIONAL BUILDING CODE AN MENTS. ALL BUILDINGS MUST HAVE A FIRE LANE ON TWO SIDES THE FACE OF THE BUILDING. LDING SEPARATIONS ARE ADEQUATE AS SHOWN. 31' MINIMUMS WEI CT ARCHITECT WILL NEED TO VERIFY.
PROVIDED PARKING Standard attached garage detached garage carport spaces compact accessible spaces parallel PARKING CALCULATIONS (C	E A/C CONDENSERS WILL BE LOCATED ON THE ROOF OF THE BUILDINGS. THE ENGINEER TO CONFIRM LOCATION OF FENCING AGAINST 100 YEAR FLOODPLAIN ALONG THE EASTERN D ENSURE NO ENCROACHMENTS. STORM WATER MANAGEMENT OR WATER QUALITY IS REQUIRED ON SITE.
	<ul> <li>9. THE TOTAL NUMBER OF GARAGES MUST BE ACCESSIBLE GARAGES WILL BE FROVIDED BT THE ARCHITECT AT A LATER DATE. 2000 OF THE TOTAL NUMBER OF GARAGES MUST BE ACCESSIBLE.</li> <li>7. THE BOUNDARY WAS PROVIDED BY THE CLIENT ON 11-7-2013. THE EAST PROPERTY LINE WAS SET BASED ON THE PREVIOUS PLAN AND AN OFFSET OF 200' FROM THOUSAND OAKS DRIVE. THE LIDAR TOPO WAS PROVIDED BY THE CIVIL. AN ACTUAL SURVEY WILL BE REQUIRED TO CONFIRM YIELDS.</li> <li>8. THE TOPOGRAPHIC SURVEY INCLUDED WITHIN THIS SITE PLAN AND ELECTRONIC FILE HAS BEEN MODIFIED. ENGINEER IS RESPONSIBLE TO INCORPORATE THE COMPLETED ALTA BOUNDARY AND TOPOGRAPHIC SURVEY (TO BE SUPPLIED BY THE SURVEYOR) IN PREPARATION OF THE CIVIL PLANS.</li> <li>9. ALL RESIDENT BUILDINGS ARE THREE STORY EXCEPT FOR THE 'U' SHAPE BUILDING WHICH IS FOUR STORIES.</li> </ul>
	- OTHER CURBS AND 4' WALKS ARE USED AROUND POOL AREAS, MAIL KIOSKS, HIGH TRAFFIC AREAS, AND ALL OT - OTHER CURBS AND 4' WALKS ARE USED AROUND POOL AREAS, MAIL KIOSKS, HIGH TRAFFIC AREAS, AND ALL OT UATIONS. FOR THE PURPOSES OF COMPLYING WITH THE FAIR HOUSING ACT, AMERICAN'S WITH DISABILITIES ACT, AND APPLIC SAL CODES, ACCESSIBLE ROUTES ARE SHOWN. THE ROUTES AS SHOWN ARE NOT INTENDED TO HAVE ANY RAMPS 201RING HANDRAILS AND LANDINGS, EXCEPT FOR THE ROUTES AS SHOWN ARE NOT INTENDED TO HAVE ANY RAMPS 201RING HANDRAILS AND LANDINGS, EXCEPT FOR THE AREA AROUND THE POOL. GENERALLY, THE SLOPES OF THE 201RING HANDRAILS AND LANDINGS, EXCEPT FOR THE AREA AROUND THE POOL. GENERALLY, THE SLOPES OF THE 201RING HANDRAILS AND LANDINGS, EXCEPT FOR THE CROSS SLOPE MAY NOT EXCEED 0.5 PERCENT. THE PROJEC 31NEER PREPARING THE GRADING PLANS IS RESPONSIBLE TO ENSURE THAT THE ACCESSIBLE ROUTES ARE DESIGNE CH THAT RAMPS ARE AVOIDED AND THE ROUTES WILL MEET ALL LOCAL, STATE AND FEDERAL ACCESSIBILITY 201REMENTS. THE PROJECT ENGINEER MAY MODIFY THE ROUTES AS REQUIRED BY GRADING. ANY CHANGES TO T UTES MUST BE BROUGHT TO THE ATTENTION OF LEE AND ASSOCIATES.
	TOR BROOKS II ON 4-15-2015. THESE FOOT RM THAT ALL ARCHITECTURAL INFORMATION IS IS INTENTIONAL. AS A GENERAL RULE, 5' WAL
	NOTES: 1. ANY HORIZONTAL DESIGN CHANGES MUST BE APPROVED BY NRP, TELLUS CONSULTING, LLC. AND LEE & ASSOCIATES, INC. 2. THIS PLAN PROVIDES A MIX OF 63%/37%.
LIMITS OF EXISTING UNDFILL LINE BY OTHERS	
2000 2002	



SITE PLAN
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US AIR FORCE SCHOOL OF AEROSPACE MEDICINE HISTORIC DISTRICT




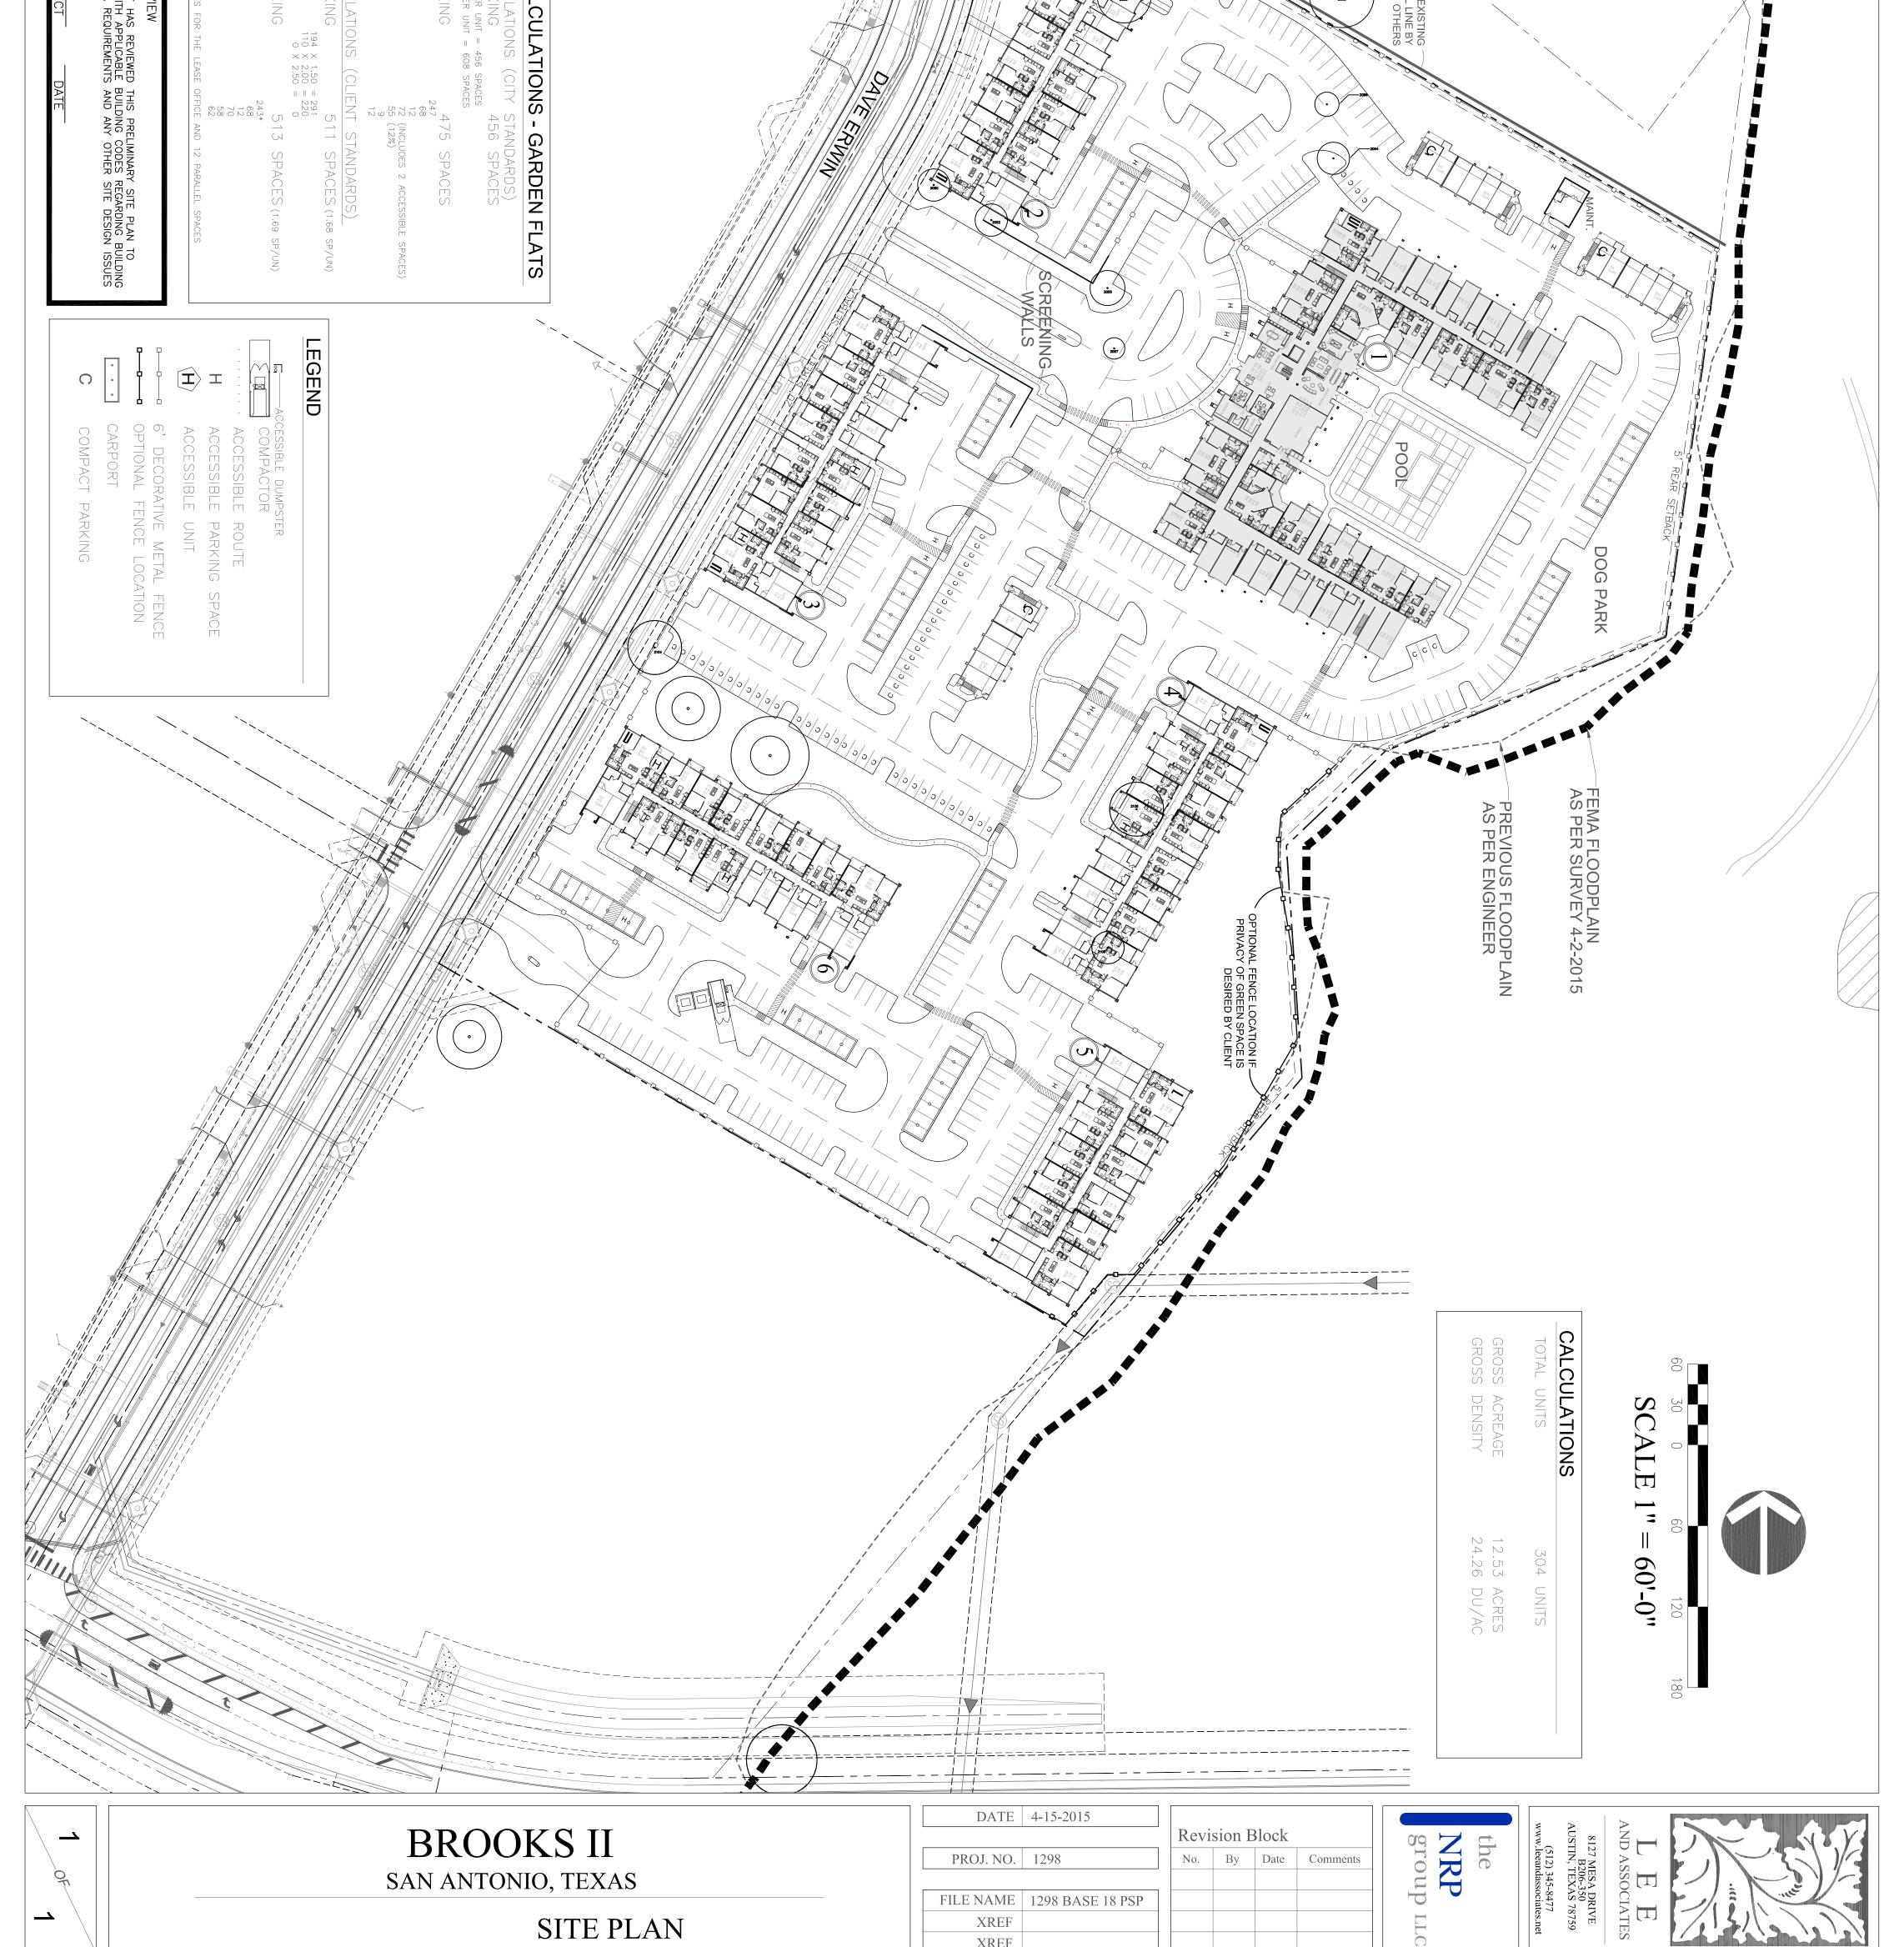

APPROXIMATE HISTORIC DISTRICT BOUNDARY

> NEW BROOKS II STUDENT HOUSING

HISTORIC SITE PLAN OVERLAY - DEMO BLDG 185

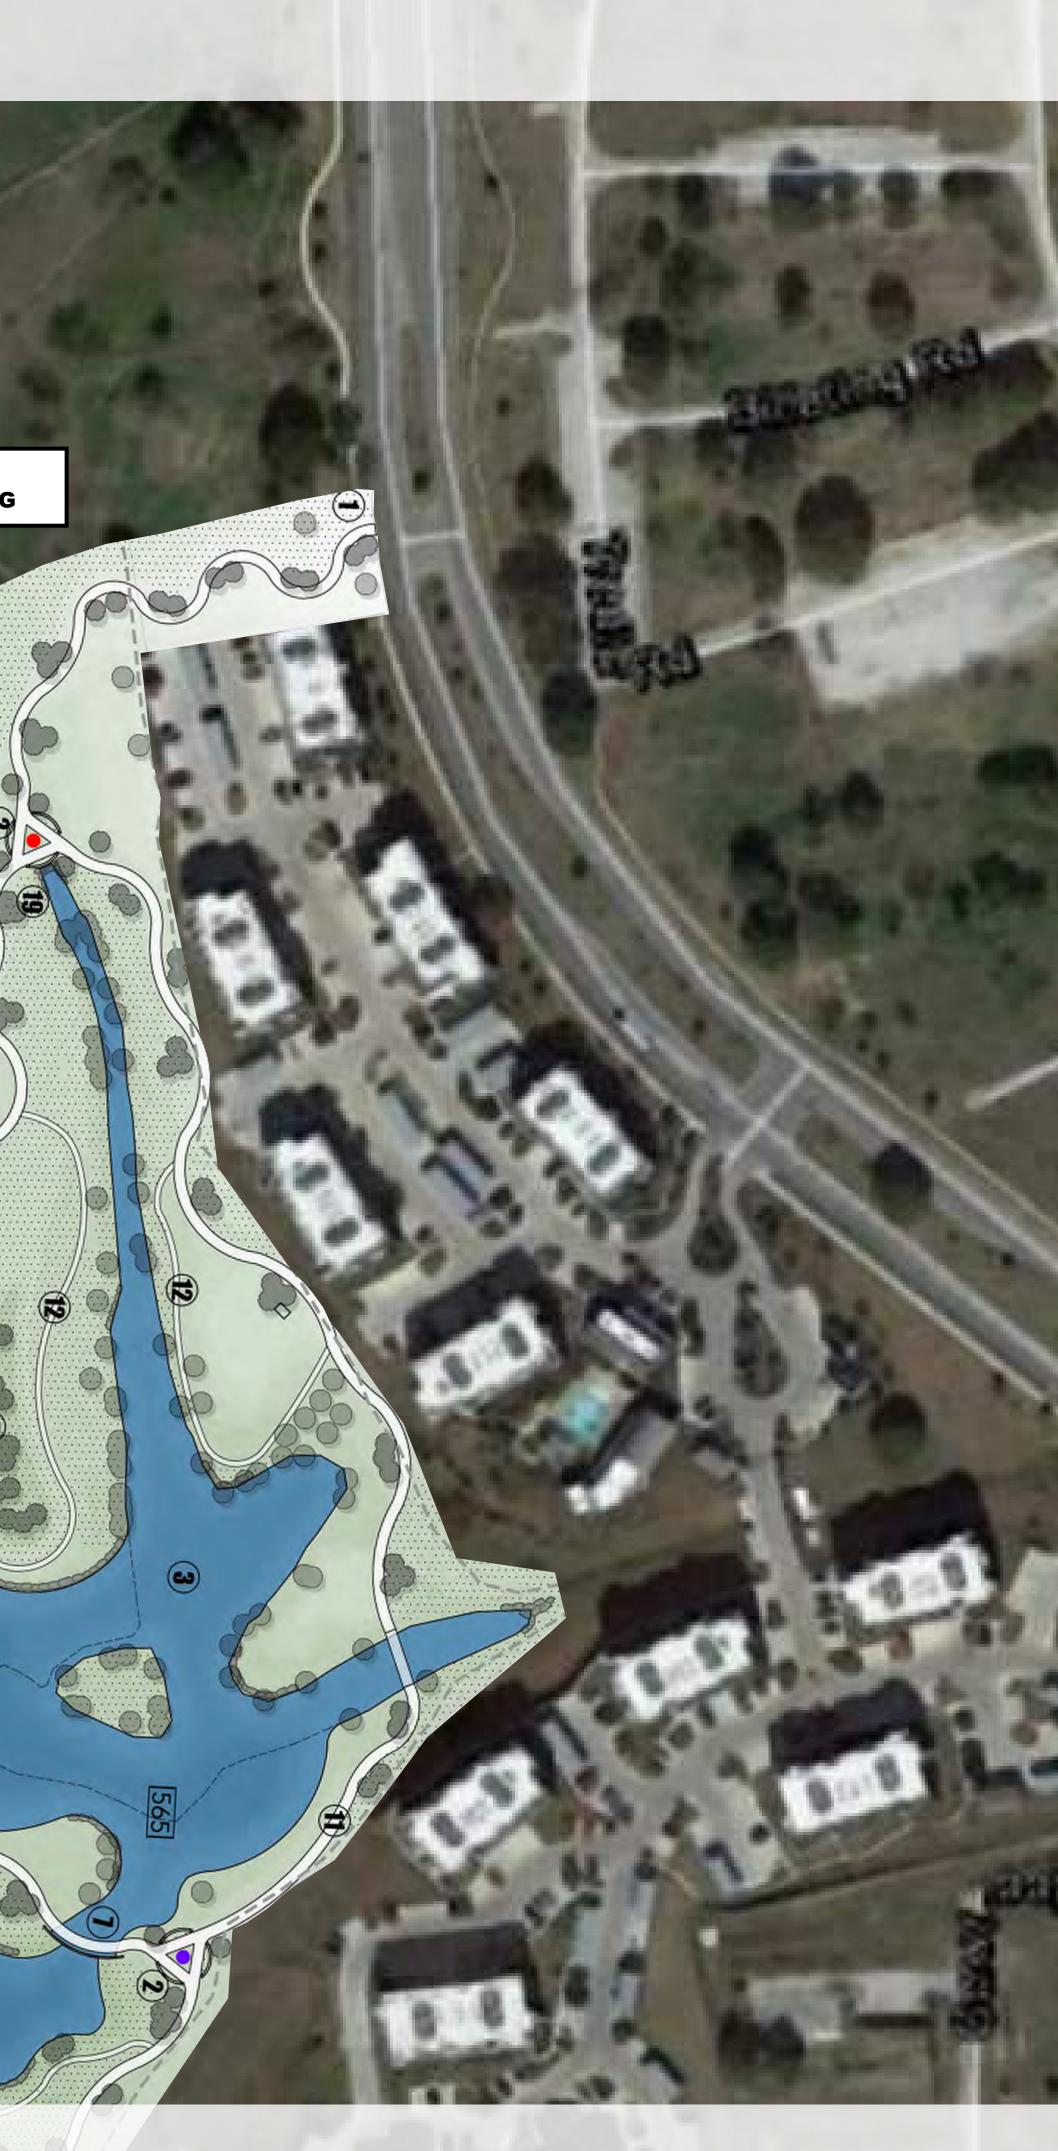

10 00 00 00



## Google earth









LEGEND

1. BRICK FINISH

2. METAL GUARDRAIL (PTD.)

**3. ASHPALT ROOF SHINGLES** 

4. ALUM. WINDOW (CLEAR ANOD.)

5. ENTRY CANOPY W/METAL ROOF 6. PAINTED STUCCO FINISH 'A'



## BROOKS APARTMENTS II - BUILDING TYPE I (FRONT ELEVATION)



## 7. PAINTED STUCCO FINISH 'B' 8. SMOOTH STUCCO FINISH 'C'

## SAN ANTONIO, TX HDRC 05.15.2015





## BROOKS APARTMENTS II - BUILDING TYPE I (GARAGE ELEVATION)





the NRP group LLC



## BROOKS APARTMENTS II - BUILDING TYPE II (FRONT ELEVATION)









## BROOKS APARTMENTS II - BUILDING TYPE III (FRONT ELEVATION)









Decomposed Granite



Horizontal Stacked Seat Walls



Courtyard Beds



Hardwood Mulch







Bury+Partners ENGINEERING SOLUTIONS







# Brooks II Landscape Courtyard Design - San Antonio, Texas



the NRP group LLC

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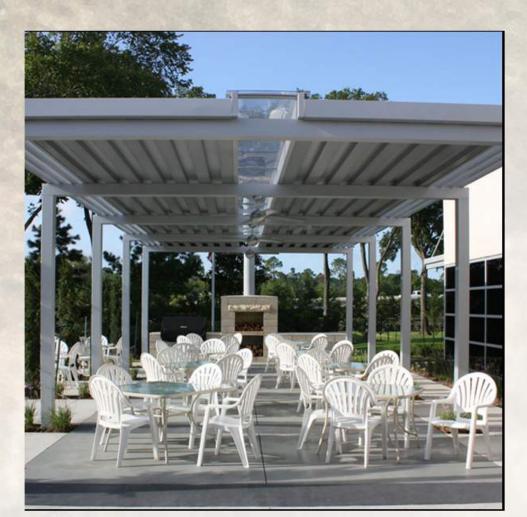
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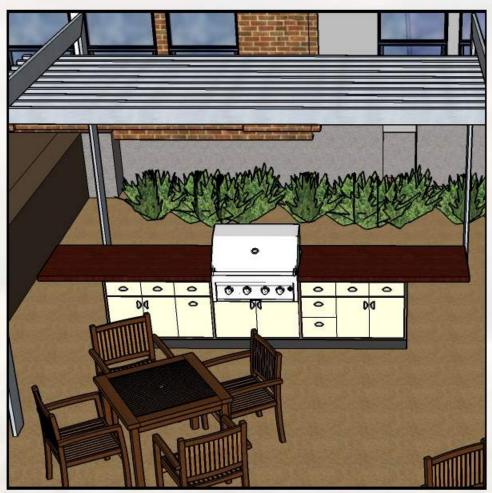
ARCHITECTS



AVAdek Structure



Seating w/ String Lights



Seating and Grill countertops



Covered BBQ area







Pool Sun shelf



Pool Courtyard Perspective

Bury+Partners ENGINEERING SOLUTIONS

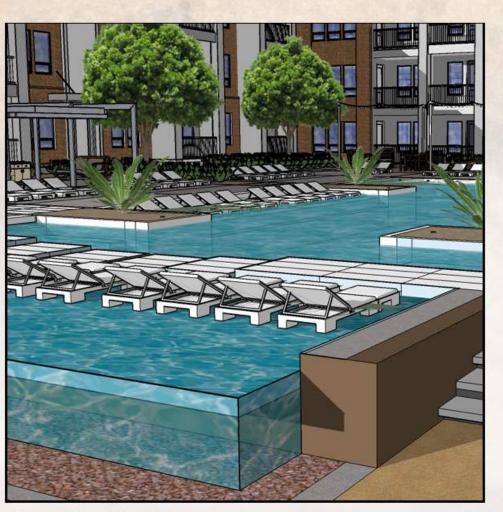

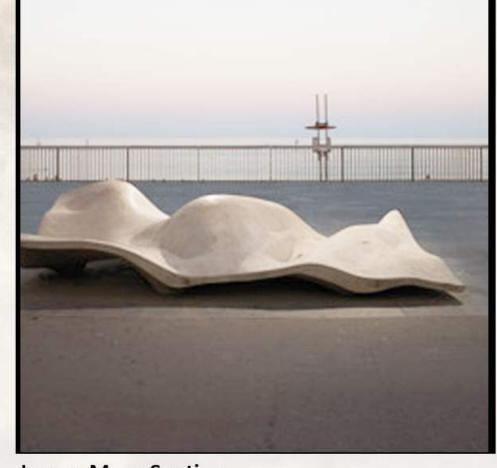



Hammock

Negative Pool Edge

Lungo Mare Seating



**Pool Bubblers** 

the NRP group LLC

gsr

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May 12, 2015

drade

ARCHITECTS





Dog Park

Building 6 Deck Design Perspective




**Retaining Wall** 



Uncut wildflower zone





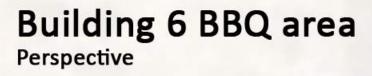





the

NRP

group LLC

**Brooks II** Building 6 Deck & Yard Design - San Antonio, Texas



Horizontal Stacked Seat Wall



**Outdoor Grill** 



May 12, 2015



Sign Entry Design Perspective



Sign Entry Design Perspective



Brooks II Sign Entry Design - San Antonio, Texas

## the NRP group LLC

gsr andrade

May 12, 2015

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CITY OF SAN ANTONIO

OFFICE OF KISTORIC PRESERVATION

Kistoric and Design Review Commission Design Review Committee Report & Recommendation

DATE: 5/12/2015

HDRC Case#\_\_\_\_

ADDRESS: BROOKS LITY BASE Meeting Location: LONE STAR

APPLICANT: GARY AILLARA

DRC Members present: MILAKEL GUARINO, JOHN LAFPOON BETTY FELDMAN

Staff present: ENWARD HALL

Others present:\_\_\_\_\_

REQUEST: NEW CONSTRUCTION OF MULTI-FAMILY RESIDENTIAL

STRUCTURE

COMMENTS/CONCERNS:\_\_

MG: PRESENTATION FORMAT IS MUCH BETTER THIS TIME.

MG: PREVIOUS CONCERNS WERE OVER THE AEVELOPMENT OF THE PAST ELEVATIONS - MATERIALS LORDELT - ARE MUCH MORE APPROPRIATE. NEW ELEVATIONS

BF: QUESTIONS OVER NEW PLAT ROOF-NEW PLACEMENT OF HVAC

UNITS ARE APPROPRIATE.

Committee Chair Signature (or representative)

MG: INCLUSE INFORMATION REGARDING PREVIOUS DEMOLITION INFO.

COMMITTEE RECOMMENDATION: APPROVE DISAPPROVE [ ] APPROVE WITH COMMENTS/STIPULATIONS: SUBMITTEL FOR PRELIMINON

DATE: 41712015 HDRC Case# ADDRESS: BEOOLS LANAWG IL Meeting Location: LONE STAC APPLICANT: LARY W AILLARA -BEOOLS / NEA DRC Members present: BEITY FELAMAN, MICHAEL GUARDINO Staff present: EAWARA HALL Others present: REQUEST: LONDERTVAL (NEW CONSTRUCTION MIXEA VEE)
ADDRESS: BEOOLS LANAING IT Meeting Location: LONE STAR APPLICANT: LARY W AILLARA -BROOKS/NRA DRC Members present: BETTY FELAMAN, MICHAEL GUARDINO Staff present: EAWARA HALL Others present:
APPLICANT: GARY W AILLARA -BROOKS/NEA DRC Members present: BETTY FELAMAN, MICHAEL GUARDINO Staff present: EAWARA HALL Others present:
Staff present: EAWARA HALL Others present:
Staff present: EAWARA HALL Others present:
REQUEST: CONCEPTUAL (NEW CONSTRUCTION MIXED USE)
COMMENTS/CONCERNS:
MG: RESIGN IS HEADED IN THE PICHT ADECTION
MG: CONCERN OVER BUILDING TYPE IT FRONT ELEVATION
MG: WAY TO MAINTAIN A UNIFORM PARAPET AEIGHT ACROSS ALL
BUILDINGS ??
BF! PLAT ROOF WHY SLOPEL? - ELEVATIONS LOOKED MIKED UP,
LONFUSED AND BEOKEN.
MG: BUILDINGS ARE FAR FROM DESIGN GUIDELINES, MG: MODE HORIZONTAL CONTINUITY COMMITTEE RECOMMENDATION: APPROVISE IN PROVIDE
APPROVE WITH COMMENTS/STIPULATIONS:
to Provide mone Honizontality in elavorions
Committee Chair Signature (or representative)