HISTORIC AND DESIGN REVIEW COMMISSION

April 06, 2016 Agenda Item No: 15

HDRC CASE NO: 2016-123

ADDRESS: 208 BUSHNELL

LEGAL DESCRIPTION: NCB 6328 BLK 1 LOT 17, E 11.2 FT OF 16 & W 38.8 FT OF 18

ZONING: R5 H CITY COUNCIL DIST.:

DISTRICT: Monte Vista Historic District **APPLICANT:** Ramon Torres/Turn Key Pros

OWNER: Rodolfo Vaglienty

TYPE OF WORK: Construction of a rear carport

REQUEST:

The applicant is requesting a Certificate of Appropriateness for approval to construct a carport with a footprint of 480 square feet to accommodate parking for three vehicles.

APPLICABLE CITATIONS:

Historic Design Guidelines, Chapter 4, Guidelines for New Construction

5. Garages and Outbuildings

A. DESIGN AND CHARACTER

- *i. Massing and form*—Design new garages and outbuildings to be visually subordinate to the principal historic structure in terms of their height, massing, and form.
- *ii.* Building size New outbuildings should be no larger in plan than 40 percent of the principal historic structure footprint.
- *iii.* Character—Relate new garages and outbuildings to the period of construction of the principal building on the lot through the use of complementary materials and simplified architectural details.
- *iv. Windows and doors*—Design window and door openings to be similar to those found on historic garages or outbuildings in the district or on the principle historic structure in terms of their spacing and proportions.
- v. Garage doors—Incorporate garage doors with similar proportions and materials as those traditionally found in the district.

B. SETBACKS AND ORIENTATION

i. Orientation—Match the predominant garage orientation found along the block. Do not introduce front-loaded garages or garages attached to the primary structure on blocks where rear or alley-loaded garages were historically used. ii. Setbacks—Follow historic setback pattern of similar structures along the streetscape or district for new garages and outbuildings. Historic garages and outbuildings are most typically located at the rear of the lot, behind the principal building. In some instances, historic setbacks are not consistent with UDC requirements and a variance may be required.

FINDINGS:

- a. Work began without a Certificate of Appropriateness for the construction of a 480 square foot carport to accommodate parking for three vehicles. The applicant has paid all associated post work application fees. The rear of the property currently features an existing carport structure that is the subject of a separate request to the HDRC and is not a part of this proposal.
- b. According to the Guidelines for New Construction, new accessory structures should be designed to be visually subordinate to the primary historic structure, feature a footprint that is no more than forty percent of the primary historic façade's footprint and should relate to the period of construction of the primary historic structure. The applicant's proposed footprint and overall height of approximately twelve feet is appropriate.
- c. The applicant has proposed materials to include 4" x 4" steel columns and galvanized steel corrugated utility panels for the roofing material. The primary historic structure at 208 Bushnell is of the Spanish Eclectic


- architectural style. Additionally, there is an existing accessory structure that features a stucco exterior. Staff finds that the applicant's proposed materials are not architecturally appropriate for the style of the primary historic structure nor the Monte Vista Historic District. Staff finds that materials such as cedar posts and tile-like roofing would be more appropriate.
- d. In regards to site location, the applicant has proposed to site the accessory structure at the rear of the property along the side and rear property lines. The location at the rear of the property is appropriate, however, the applicant should ensure that there is a three foot setback between the structure and property line.

RECOMMENDATION:

Staff does not recommend approval based on finding c. Staff finds that materials consisting of cedar posts and a tile-like roof would be appropriate.

CASE MANAGER:

Edward Hall

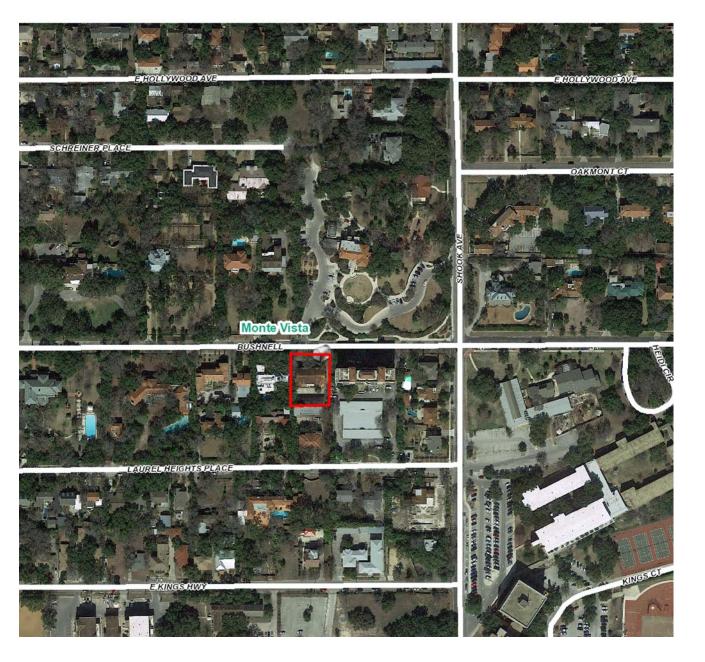





208 Bushnell

Monte Vista

Printed:Mar 11, 2016

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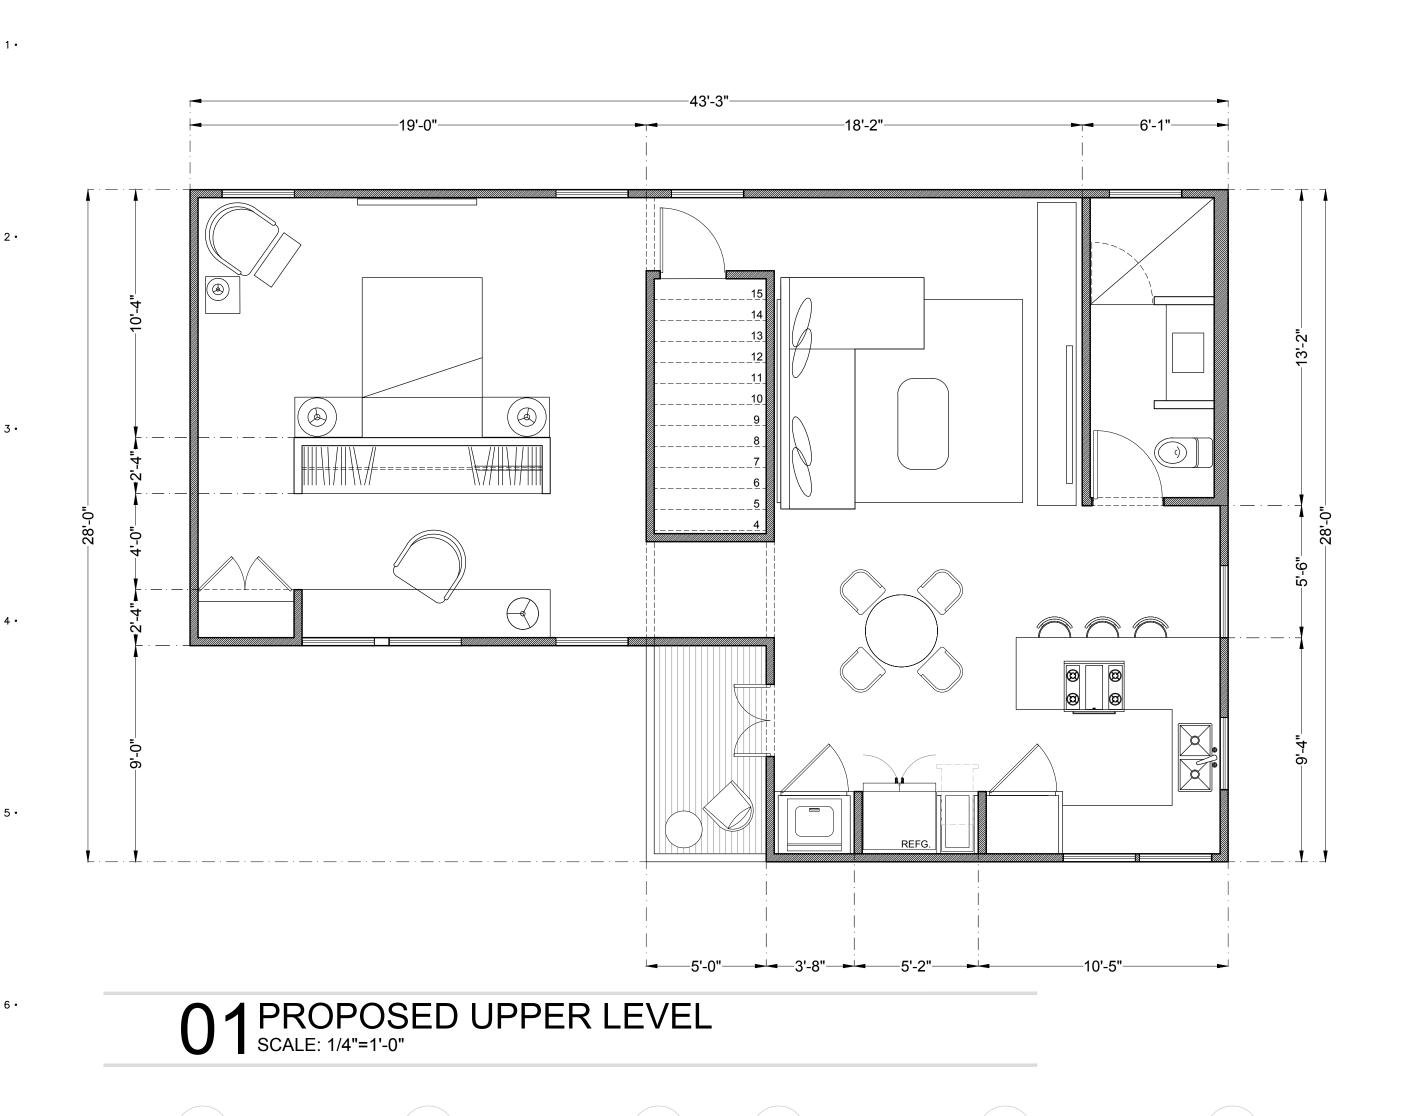


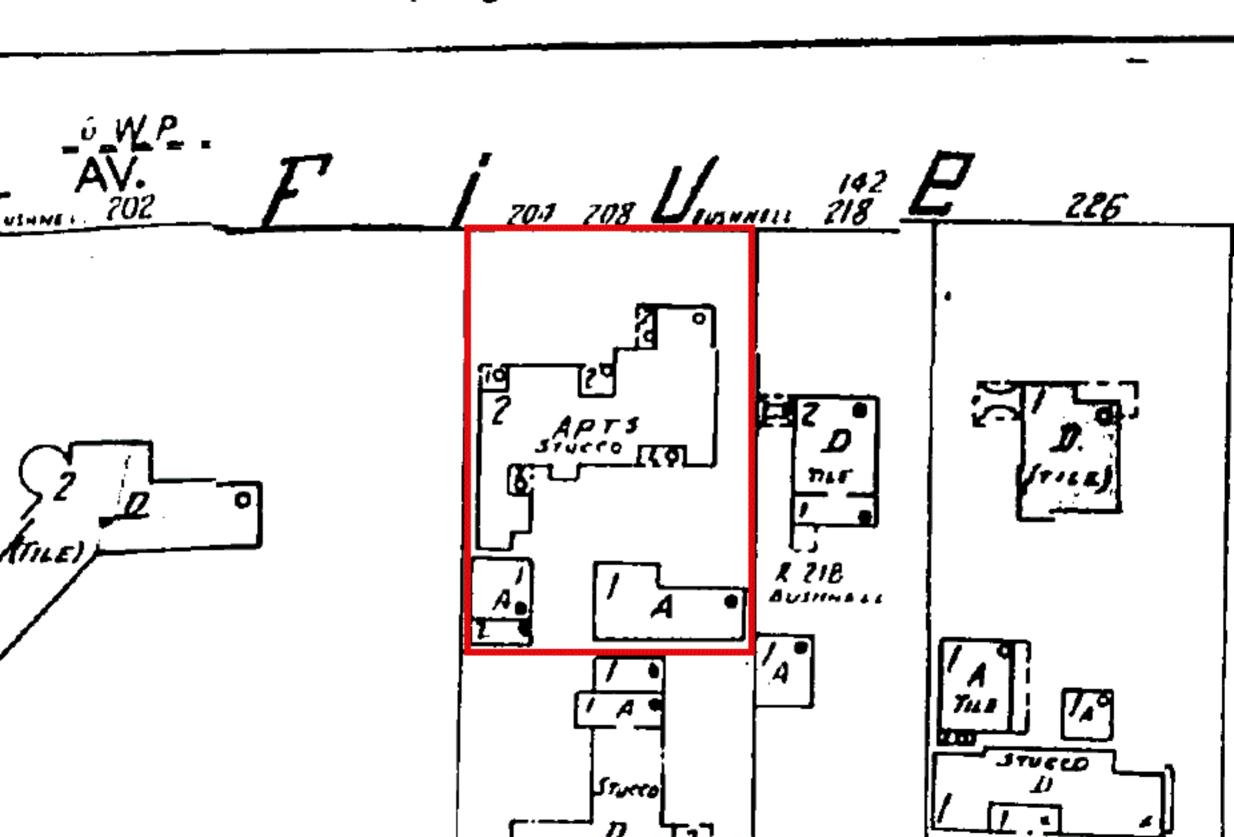

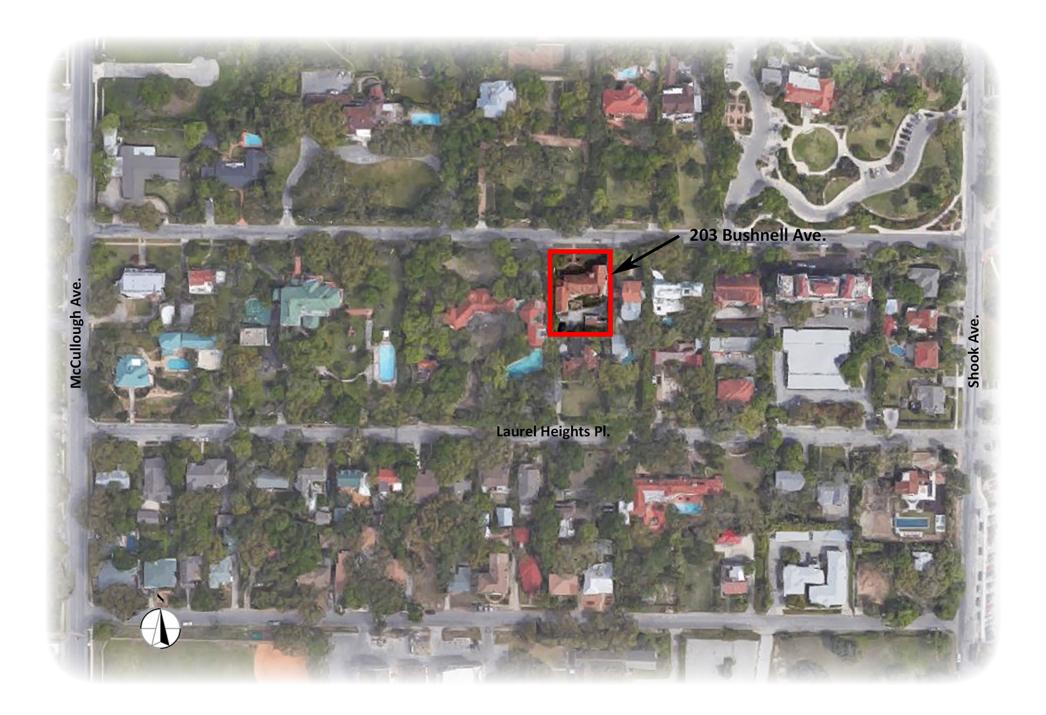








02PROPOSED GROUND LEVEL SCALE: 1/4"=1'-0"

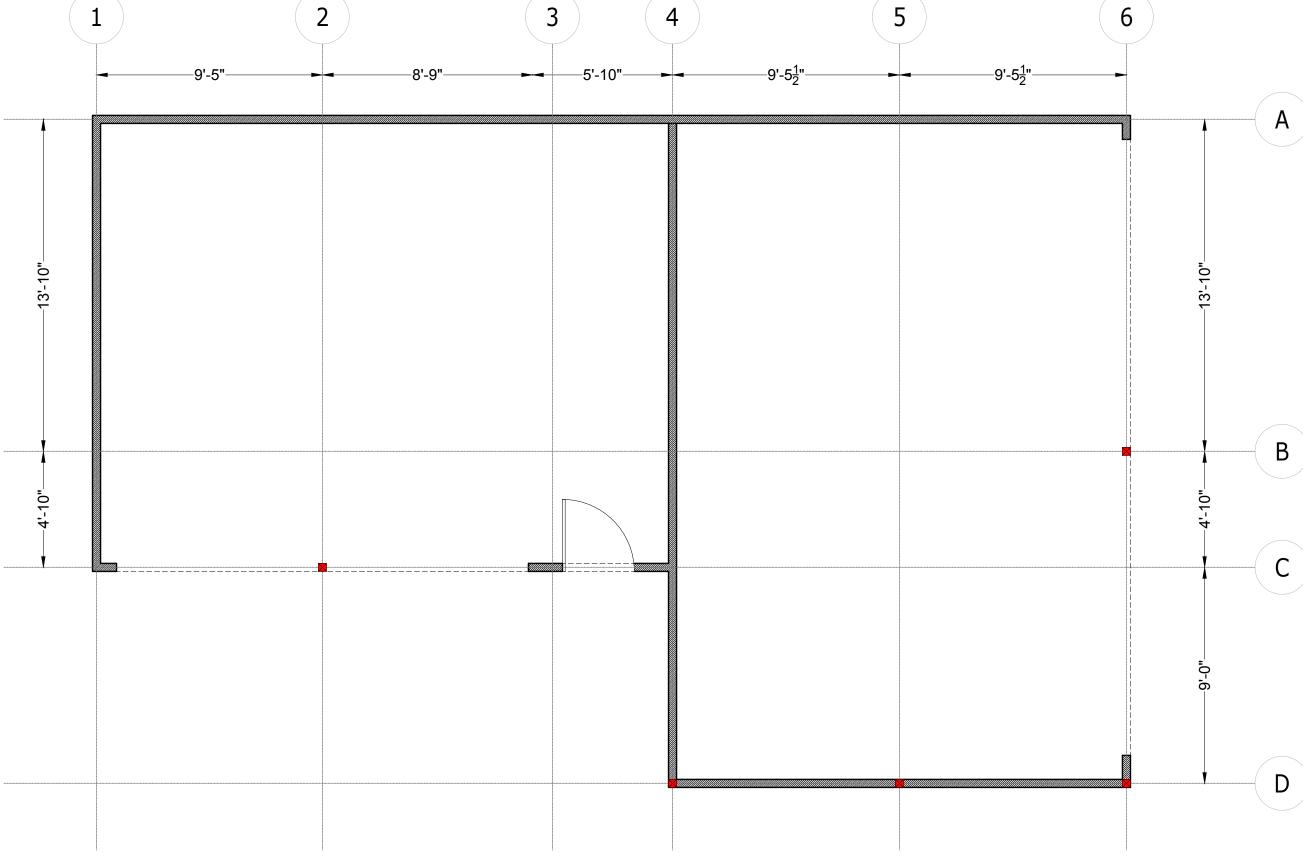

03EXISTING STRUCTURE / CARPORT

FLOOR PLAN

APPROVAL SIGNATURES

APPROVED BY CLIENT

APPROVED BY DIRECTOR

XXX

Project No.

XXX

APPROVED BY DIRECTOR

XXX

Project No.

XXX

File

XXX

Client Approval

Code

Rev.

Revision

MAYU — GROUP

- INNOVATIVE DESIGN -

AMENDMENTS

LOCATION

SIMBOLOGY

ADDRESS BUSHNELL

DIMENSION LINES

CLIENT NAME

SAN ANTONIO, TEXAS

ELEVATION MARKER
ELEVATION MARKER
FINISH FLOOR ELEVATION

ABOVE FINISH FLOOR

DRAWING NO. 0231

INDICATES WALL SUFACE

SLOPE

AREA

LIVING SPACE

STRUCTURAL ENGINEER

• 8 MECHANICAL, ELECTRICAL & PLUMBING

PROFESSIONAL SEAL

CONTENT

TERRACE

TOTAL A/C

CHANGE IN FINISHED FLOOR LEVEL

MARKS FLOOR-LAYING STARTING POINT

BUILDING SECTION A-A CAN BE SEEN ON

FRAME


995 SQ FT


45 SQ FT

995 SQ FT

CHANGE IN FLOOR MATERIAL


No. Date Concept

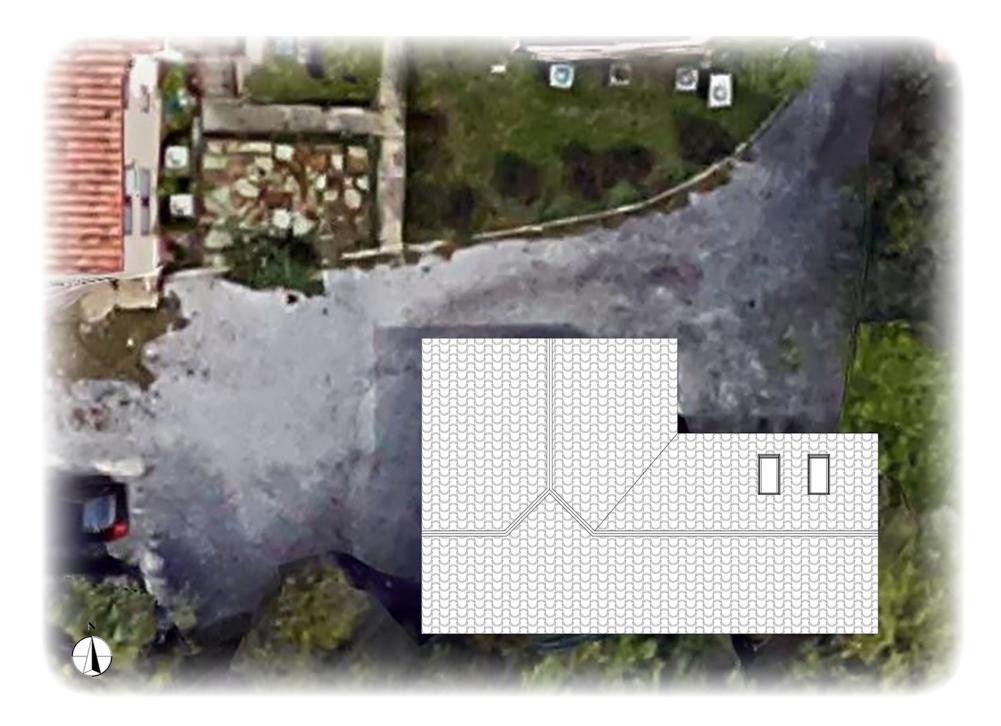

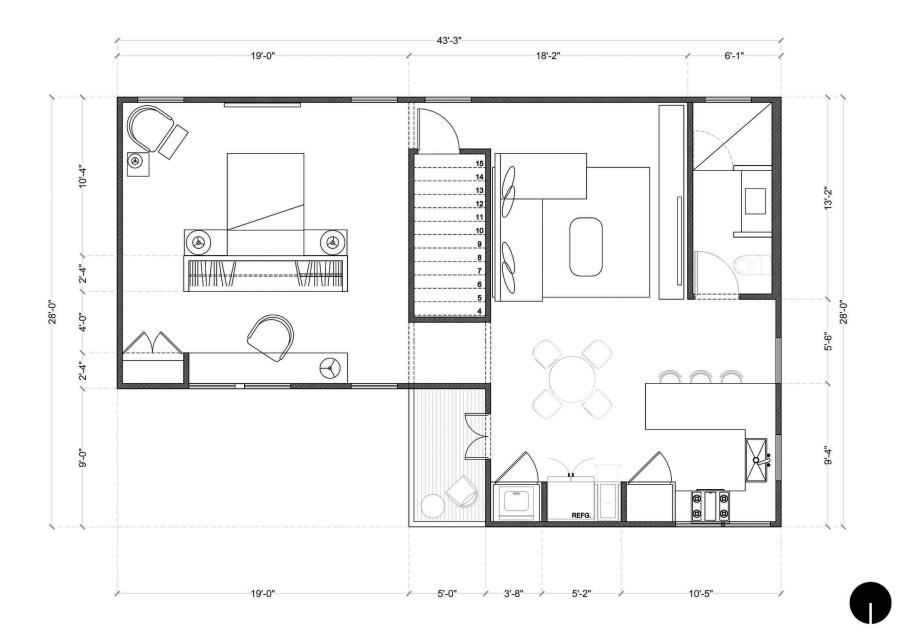






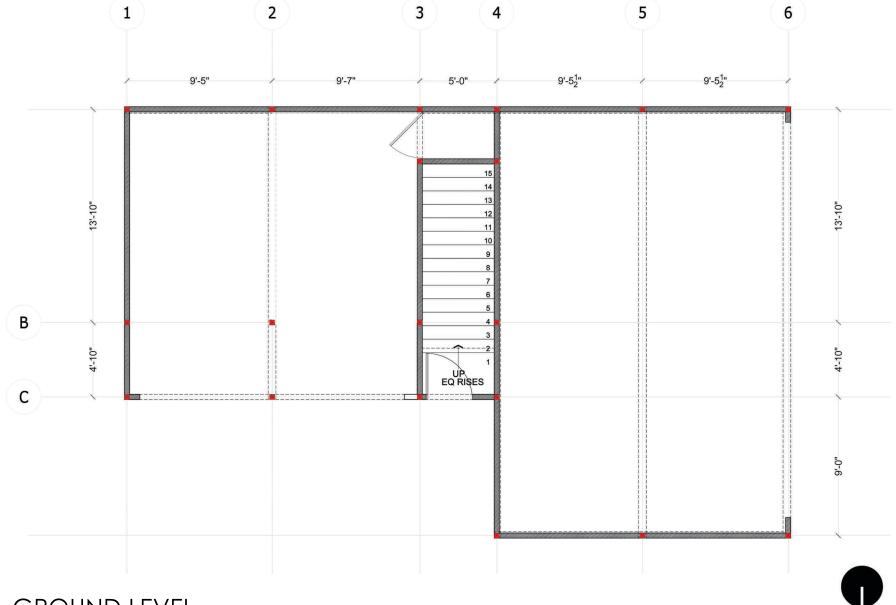

GROUND LEVEL -NEW STEEL FRAME-EXIISTING WOOD FRAMING WILL REMAIN



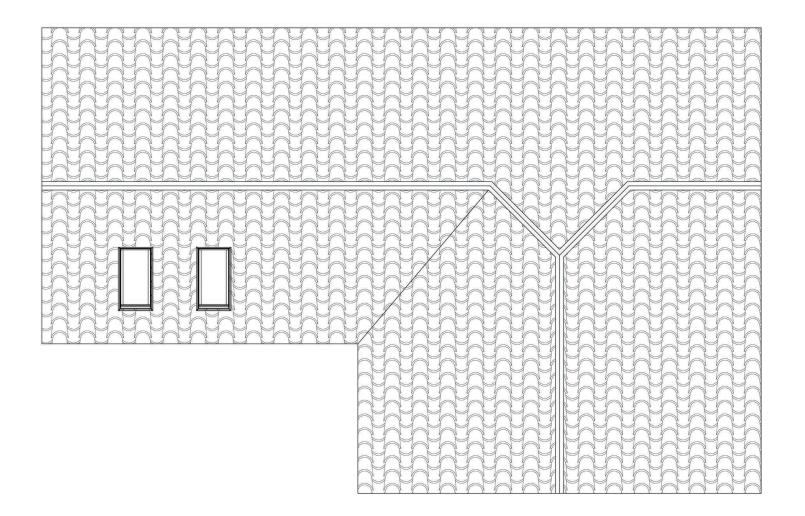












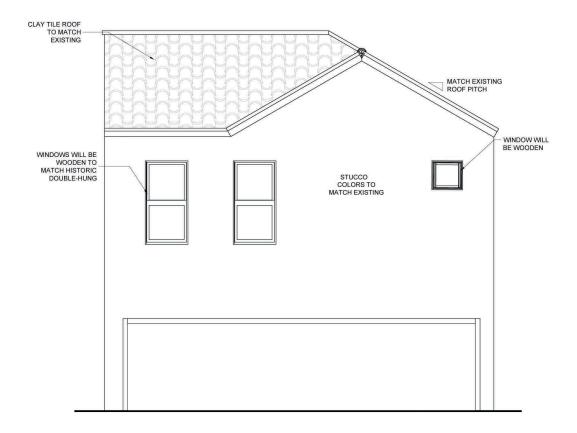




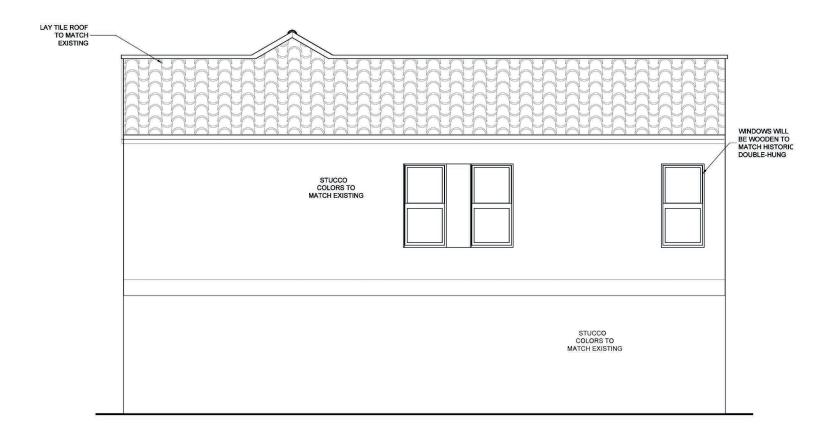



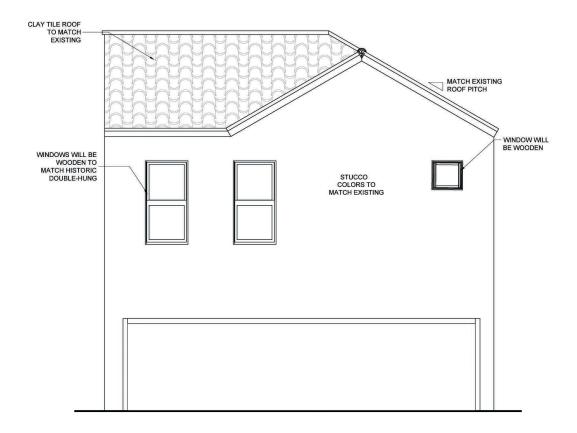



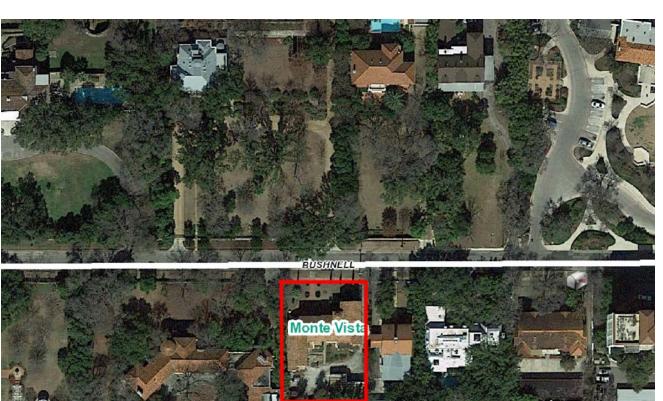







Flex Viewer

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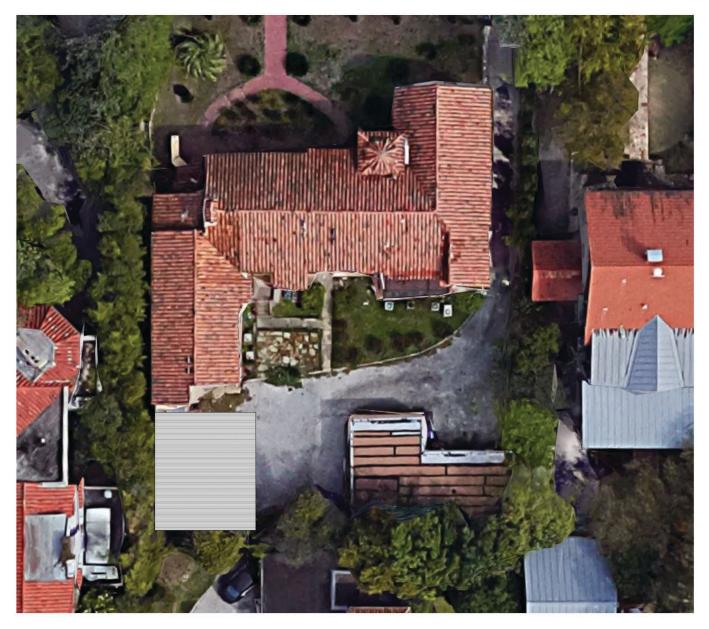















PROPOSED CARPORT-AEREAL VIEW




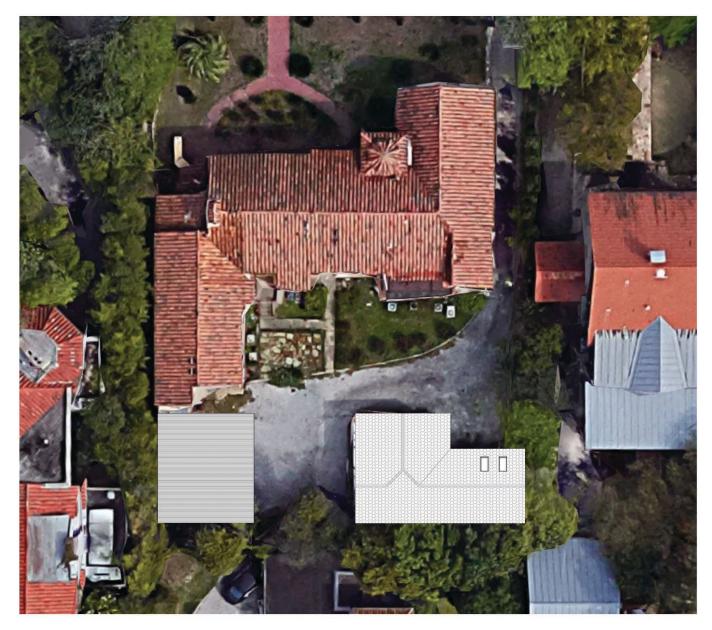



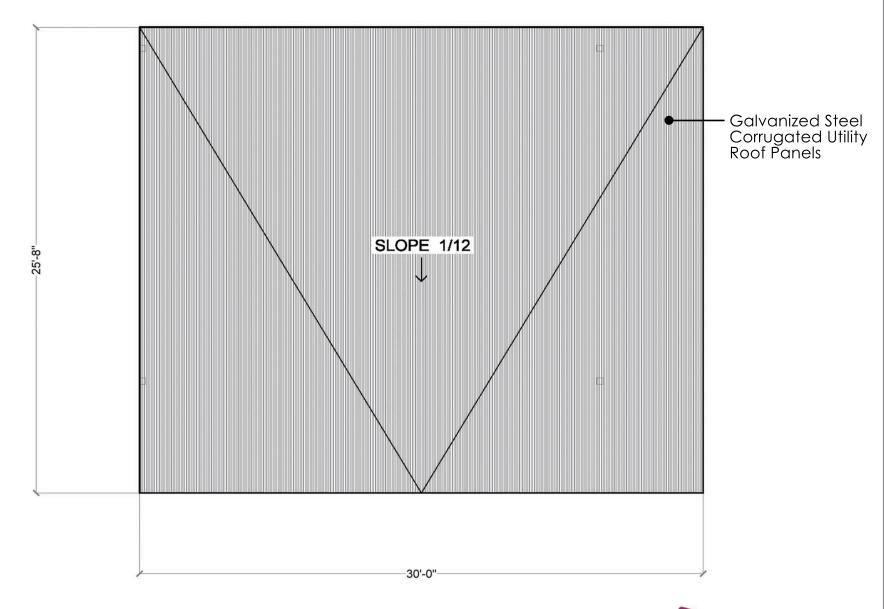

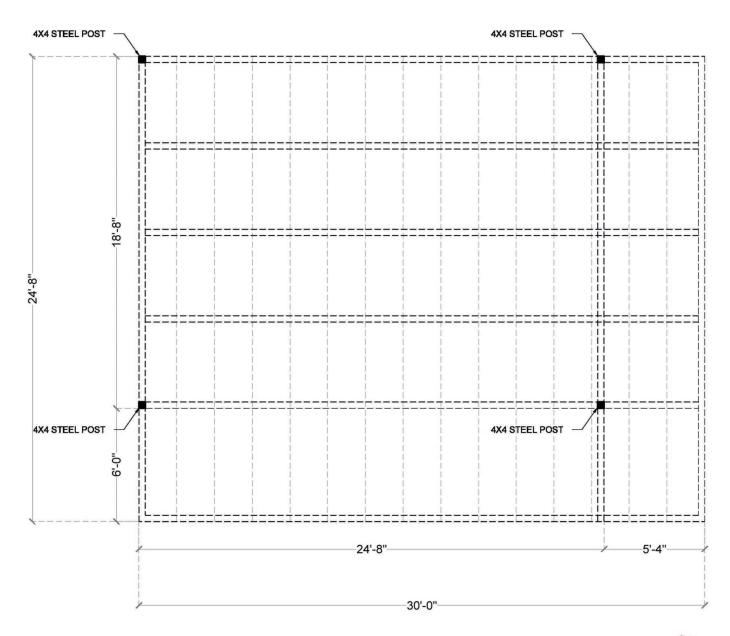

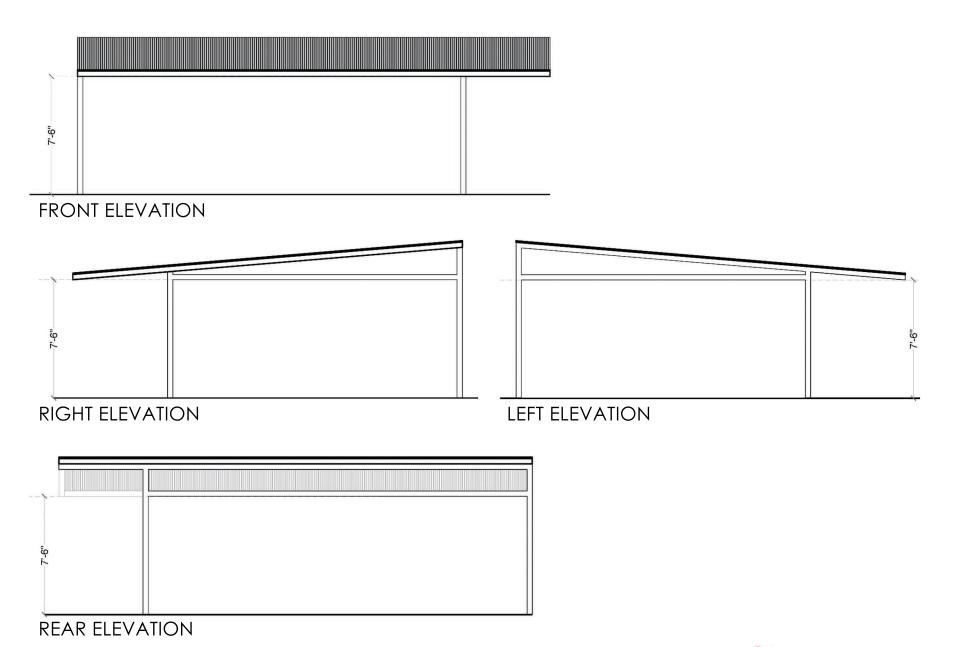

CARPORT ELEVATIONS

