HISTORIC AND DESIGN REVIEW COMMISSION

December 21, 2016 Agenda Item No: 35

HDRC CASE NO: 2016-524
ADDRESS: 300 HASKIN
COMMON NAME: Haskin Park

LEGAL DESCRIPTION:

ZONING: NP-8 **CITY COUNCIL DIST.:** 10

APPLICANT: Google Fiber Texas, LLC

OWNER: City of San Antonio Parks and Recreation Department

TYPE OF WORK: Landscaping and fencing to screen a telecommunications hut and a new parking

area

REQUEST:

The applicant is requesting a Certificate of Appropriateness for approval to construct fencing and landscaping for the purpose of screening a utility structure for telecommunications at 300 Haskin, commonly known as Haskin Park.

APPLICABLE CITATIONS:

UDC Section 35-640. Public Property and Rights-of-Way

- (a) Public Property. Generally, the historic and design review commission will consider applications for actions affecting the exterior of public properties except in the case of building interiors that are the sites of major public assemblies or public lobbies. The historic and design review commission will also consider applications for actions affecting public properties such as city parks, open spaces, plazas, parking lots, signs and appurtenances.
- (b) Public Rights-of-Way. Generally, the historic and design review commission will consider applications for actions affecting public rights-of-way whose construction or reconstruction exceeds in quality of design or materials standards of the design manual of the public works department.

Sec. 35-641. - Design Considerations for Historic and Design Review Commission Recommendations.

In reviewing an application, the historic and design review commission shall be aware of the importance of attempting to find a way to meet the current needs of the City of San Antonio, lessee or licensee of public property. The historic and design review commission shall also recognize the importance of recommending approval of plans that will be reasonable to implement. The best urban design standards possible can and should be employed with public property including buildings and facilities, parks and open spaces, and the public right-of-way. Design and construction on public property should employ such standards because the use of public monies for design and construction is a public trust. Public commitment to quality design should encourage better design by the private sector. Finally, using such design standards for public property improves the identity and the quality of life of the surrounding neighborhoods.

Sec. 35-642. - New Construction of Buildings and Facilities.

In considering whether to recommend approval or disapproval of a certificate, the historic and design review commission shall be guided by the following design considerations. These are not intended to restrict imagination, innovation or variety, but rather to assist in focusing on design principles, which can result in creative solutions that will enhance the city and its neighborhoods. Good and original design solutions that meet the individual requirements of a specific site or neighborhood are encouraged and welcomed.

- (a) Site and Setting.
- (1) Building sites should be planned to take into consideration existing natural climatic and topographical features. The intrusive leveling of the site should be avoided. Climatic factors such as sun, wind, and temperature should become an integral part of the design to encourage design of site-specific facilities which reinforces the individual identity of a neighborhood and promotes energy efficient facilities.
- (2) Special consideration should be given to maintain existing urban design characteristics, such as setbacks, building

heights, streetscapes, pedestrian movement, and traffic flow. Building placement should enhance or create focal points and views. Continuity of scale and orientation shall be emphasized.

- (3) Accessibility from streets should be designed to accommodate safe pedestrian movement as well as vehicular traffic. Where possible, parking areas should be screened from view from the public right-of-way by attractive fences, berms, plantings or other means.
- (4) Historically significant aspects of the site shall be identified and if possible incorporated into the site design. Historic relationships between buildings, such as plazas or open spaces, boulevards or axial relationships should be maintained.

(b) Building Design.

- (1) Buildings for the public should maintain the highest quality standards of design integrity. They should elicit a pride of ownership for all citizens. Public buildings should reflect the unique and diverse character of San Antonio and should be responsive to the time and place in which they were constructed.
- (2) Buildings shall be in scale with their adjoining surroundings and shall be in harmonious conformance to the identifying quality and characteristics of the neighborhood. They shall be compatible in design, style and materials. Reproductions of styles and designs from a different time period are not encouraged, consistent with the secretary of the interior's standards. Major horizontal and vertical elements in adjoining sites should be respected.
- (3) Materials shall be suitable to the type of building and design in which they are used. They shall be durable and easily maintained. Materials and designs at pedestrian level shall be at human scale, that is they shall be designed to be understood and appreciated by someone on foot. Materials should be selected that respect the historic character of the surrounding area in texture, size and color.
- (4) Building components such as doors, windows, overhangs, awnings, roof shapes and decorative elements shall all be designed to contribute to the proportions and scale of their surrounding context. Established mass/void relationships shall be maintained. Patterns and rhythms in the streetscape shall be continued.
- (5) Colors shall be harmonious with the surrounding environment, but should not be dull. Choice of color should reflect the local and regional character. Nearby historic colors shall be respected.
- (6) Mechanical equipment or other utility hardware should be screened from public view with materials compatible with the building design. Where possible, rooftop mechanical equipment should be screened, even from above. Where feasible, overhead utilities should also be underground or attractively screened. Exterior lighting shall be an integral part of the design. Interior lighting shall be controlled so that the spillover lighting onto public walkways is not annoying to pedestrians.
- (7) Signs which are out of keeping with the character of the environment in question should not be used. Excessive size and inappropriate placement on buildings results in visual clutter. Signs should be designed to relate harmoniously to exterior building materials and colors. Signs should express a simple clear message with wording kept to a minimum. (8) Auxiliary design. The site should take into account the compatibility of landscaping, parking facilities, utility and service areas, walkways and appurtenances. These should be designed with the overall environment in mind and should be in visual keeping with related buildings, structures and places.
- (c) Multiple Facades. In making recommendations affecting new buildings or structures which will have more than one (1) important facade, such as those which will face two (2) streets or a street and the San Antonio River, the historic and design review commission shall consider the above visual compatibility standards with respect to each important facade.

FINDINGS:

- a. The applicant has proposed to construct fencing and screening for a utility structure on the public property located at 300 Haskin, commonly known as Haskin Park. The structure is to house equipment for Google Fiber.
- b. This request was reviewed by the Design Review Committee on December 13, 2016, where committee member noted that the existing fencing around the hut is appropriate, asked questions regarding automobile access drives, asked questions regarding the installation of landscaping and noted that the lack of an asphalt driveway was appropriate.
- c. Per the UDC Section 35-640, the Historic and Design Review Commission will consider application affecting public properties such as city parks, open spaces, plazas, parking lots, signs and appurtenances.
- d. The applicant has proposed to construct a utility structure that features a footprint of 12'x30', an overall height of 10' 11" and materials that consist of aggregate exterior panels and a metal roof. The proposed utility structure is located on a concrete foundation and is surrounded by an eight (8) foot tall wood privacy fence. This utility structure is located at the rear of the park, 209 feet from the public right of way at Haskin Drive.
- e. The applicant worked closely with the Council office and neighborhood association representatives to agree on the design of the fencing.


- f. Staff finds the installation of the fencing to screen the utility structure appropriate; however, staff recommends that additional steps be taken to screen the structure's mechanical equipment from view with landscaping.
- g. ARCHAEOLOGY- The development project shall comply with all federal, state, and local laws, rules, and regulations regarding archaeology.

RECOMMENDATION:

Staff recommends approval based on findings a through d with the stipulation that the applicant install additional landscaping items around the base of the fencing and that the development project shall comply with all federal, state, and local laws, rules, and regulations regarding archaeology.

CASE MANAGER:

Edward Hall

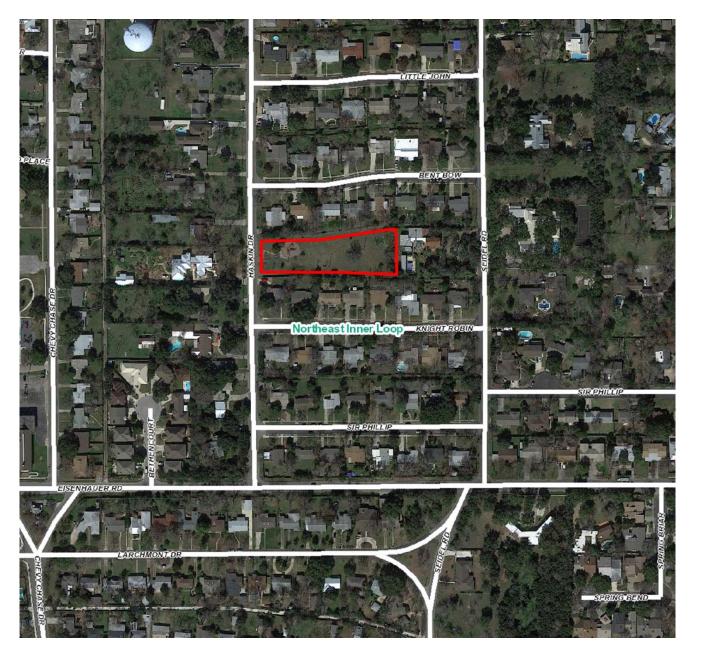




Flex Viewer

Powered by ArcGIS Server

Printed:Dec 13, 2016

The City of San Antonio does not guarantee the accuracy, adequacy, completeness or usefulness of any information. The City does not warrant the completeness, timeliness, or positional, thematic, and attribute accuracy of the GIS data. The GIS data, cartographic products, and associated applications are not legal representations of the depicted data. Information shown on these maps is derived from public records that are constantly undergoing revision. Under no circumstances should GIS-derived products be used for final design purposes. The City provides this information on an "as is" basis without warranty of any kind, express or implied, including but not limited to warranties of merchantability or fitness for a particular purpose, and assumes no responsibility for anyone's use of the information.

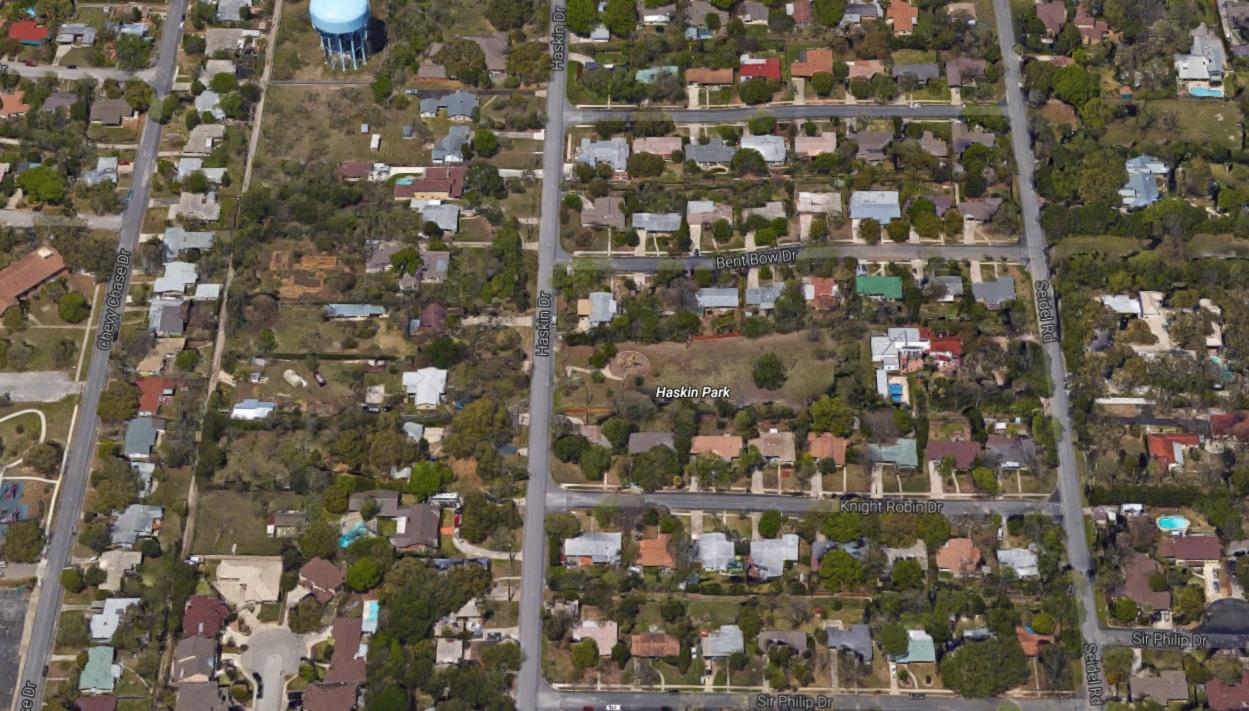









Historic and Design Review Commission Design Review Committee Report & Recommendation

DATE: DECEMBER 13, 2016 HDR	RC Case#_1016-514
ADDRESS: 300 HASKIN/HASKIN PARK Mee	eting Location: 1901 S ALAMO
APPLICANT: GOOGLE FIBER TEXAS, LLL	
DRC Members present: JOHN LAFFOCH, EN	NARD GARZA
Staff present: ENVAPO HALL, SHANON	-
(TU) Others present: <u>MAPA SIPBU, LINCOLN</u> A	CTCI) HVANT, MARCUS HAMMER, JOSEPH DECEN
REQUEST: THE INSTALLATION OF A UTILL	TY STEUCTURE IN HASKIN PARK.
COMMENTS/CONCERNS: ALL THE FENCIN	16 ADOUND THE HUT IS
APPEOPRIATE FOR THE SETTING. MS:	GF IS OPEN TO WORKING W/
EACH NEIGHBORHOOD ASSOCIATION REG	APPLING FENCE DESIGN/MATERIALS.
MS SETBACK OF HUT IS AT PEAR	LL QUESTIONS DEGAPAING
PEOPOSED ACCESS POINTS/AUTOMOBILE	APIVE IL MOST LOCATIONS
WOULD PROBABLY PREFER WOOD F	ENCUIG PATHEE THAN CHAIN
LINK PENCING MH! VARIOUS LOCATION	IS MAY PREFER DIFFERENT
FENCING THE ELIMINATION OF THE	ASPHALT DOAL WAS WARDETANT.
COMMITTEE RECOMMENDATION: A APPROVE WITH COMMENTS/STIPULATIO	PPROVE[] DISAPPROVE[] NS:
John Lathan	[z·/3·/6
Committee Chair Signature (or representative)	Date

ILL QUESTIONS DEGARDING THE INSTALLATION OF ADDITIONAL LANDSCAPIN ADDUND THE FENCING.

militario programma de la compañía La compañía de la co

Distribution dae dame in to other b**illio**n, so det

HDRC Documents

December 2016

Overview of Fiber Huts

An important piece of the Google Fiber network architecture is the "hut", which is a shelter for communications equipment. Below are some key considerations for where and how these huts are placed in cities

Hut Specifications

- Huts are pre-fabricated structures that measure about 11' 9" W x 29' 6" L x 9' H.

 The measurement of the entire leased site itself can vary, but is generally about 32ft x 50ft.

 We find that parcels measuring at least 2000 sq ft generally work well.
- Each hut sits on a concrete slab.
- The hut has a standard aggregate finish (also known as a "washed stone" finish).
- Huts are typically surrounded by a 10ft fence.
- Each hut runs on electricity, but has a backup generator on-site that also sits on the concrete slab and runs on natural gas. Generators are tested monthly, but otherwise only run in power outage situations. The noise level with the backup generator running is roughly 76dB avg @ 23ft.
- Huts have HVAC units attached, with noise levels of about 65dB at 20ft (about as loud as a midsize pickup truck idling).
- Each hut serves a maximum of 40,000 households.
- We require 24-hour access to the huts, 365 days a year.

Hut Site Selection Considerations


- The hut site requires vehicular access for construction and maintenance. As such, the site should have access to a road and include parking space.
- The huts require electric power, natural gas for a backup generator, and a telephone line for security. As such, the hut needs to be located within reasonable proximity to natural gas, telephone, and electric service access points (120/240V Delta single phase 400A service).
- Huts need to be distributed throughout the city and in proximity to residential areas they serve (i.e. they cannot all be concentrated in one corner or industrial area of the city).

Haskin Park


Photos of Structure: Haskin Park



Site Plan: Haskin Park

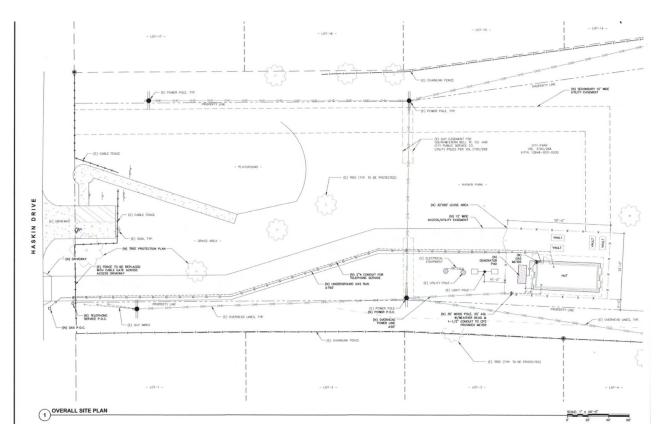


Hut Description

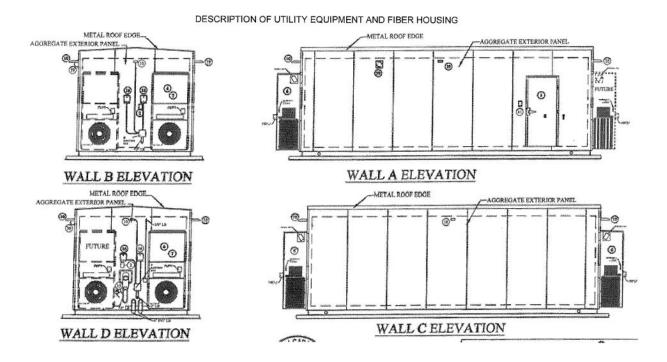



Hut Design

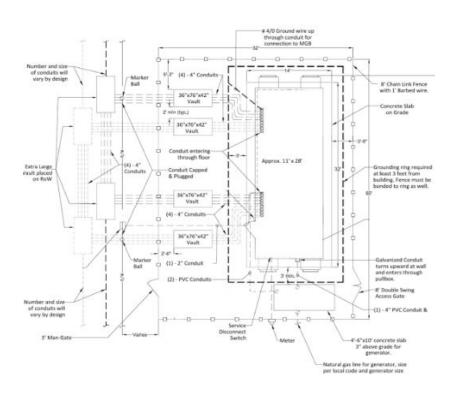

Restoration and Fencing

Restoration (Seed)



Landscaping - Parks Approved Options

Mexican Heather



- Gold Star Esperanza
- Shrub
- 6-7ft, tall



- Compact Texas Sage
- Shrub
- 4-5ft
- Will grow tall



- Mexican Feather Grass
- Grass
- 1-3ft, will grow flat




- Purple Fountain Grass
- Grass
- Medium height, 2-4ft/2-3 ft



- Autumn Sage or Salvia Greggii
- Shrub
- 3-5ft High



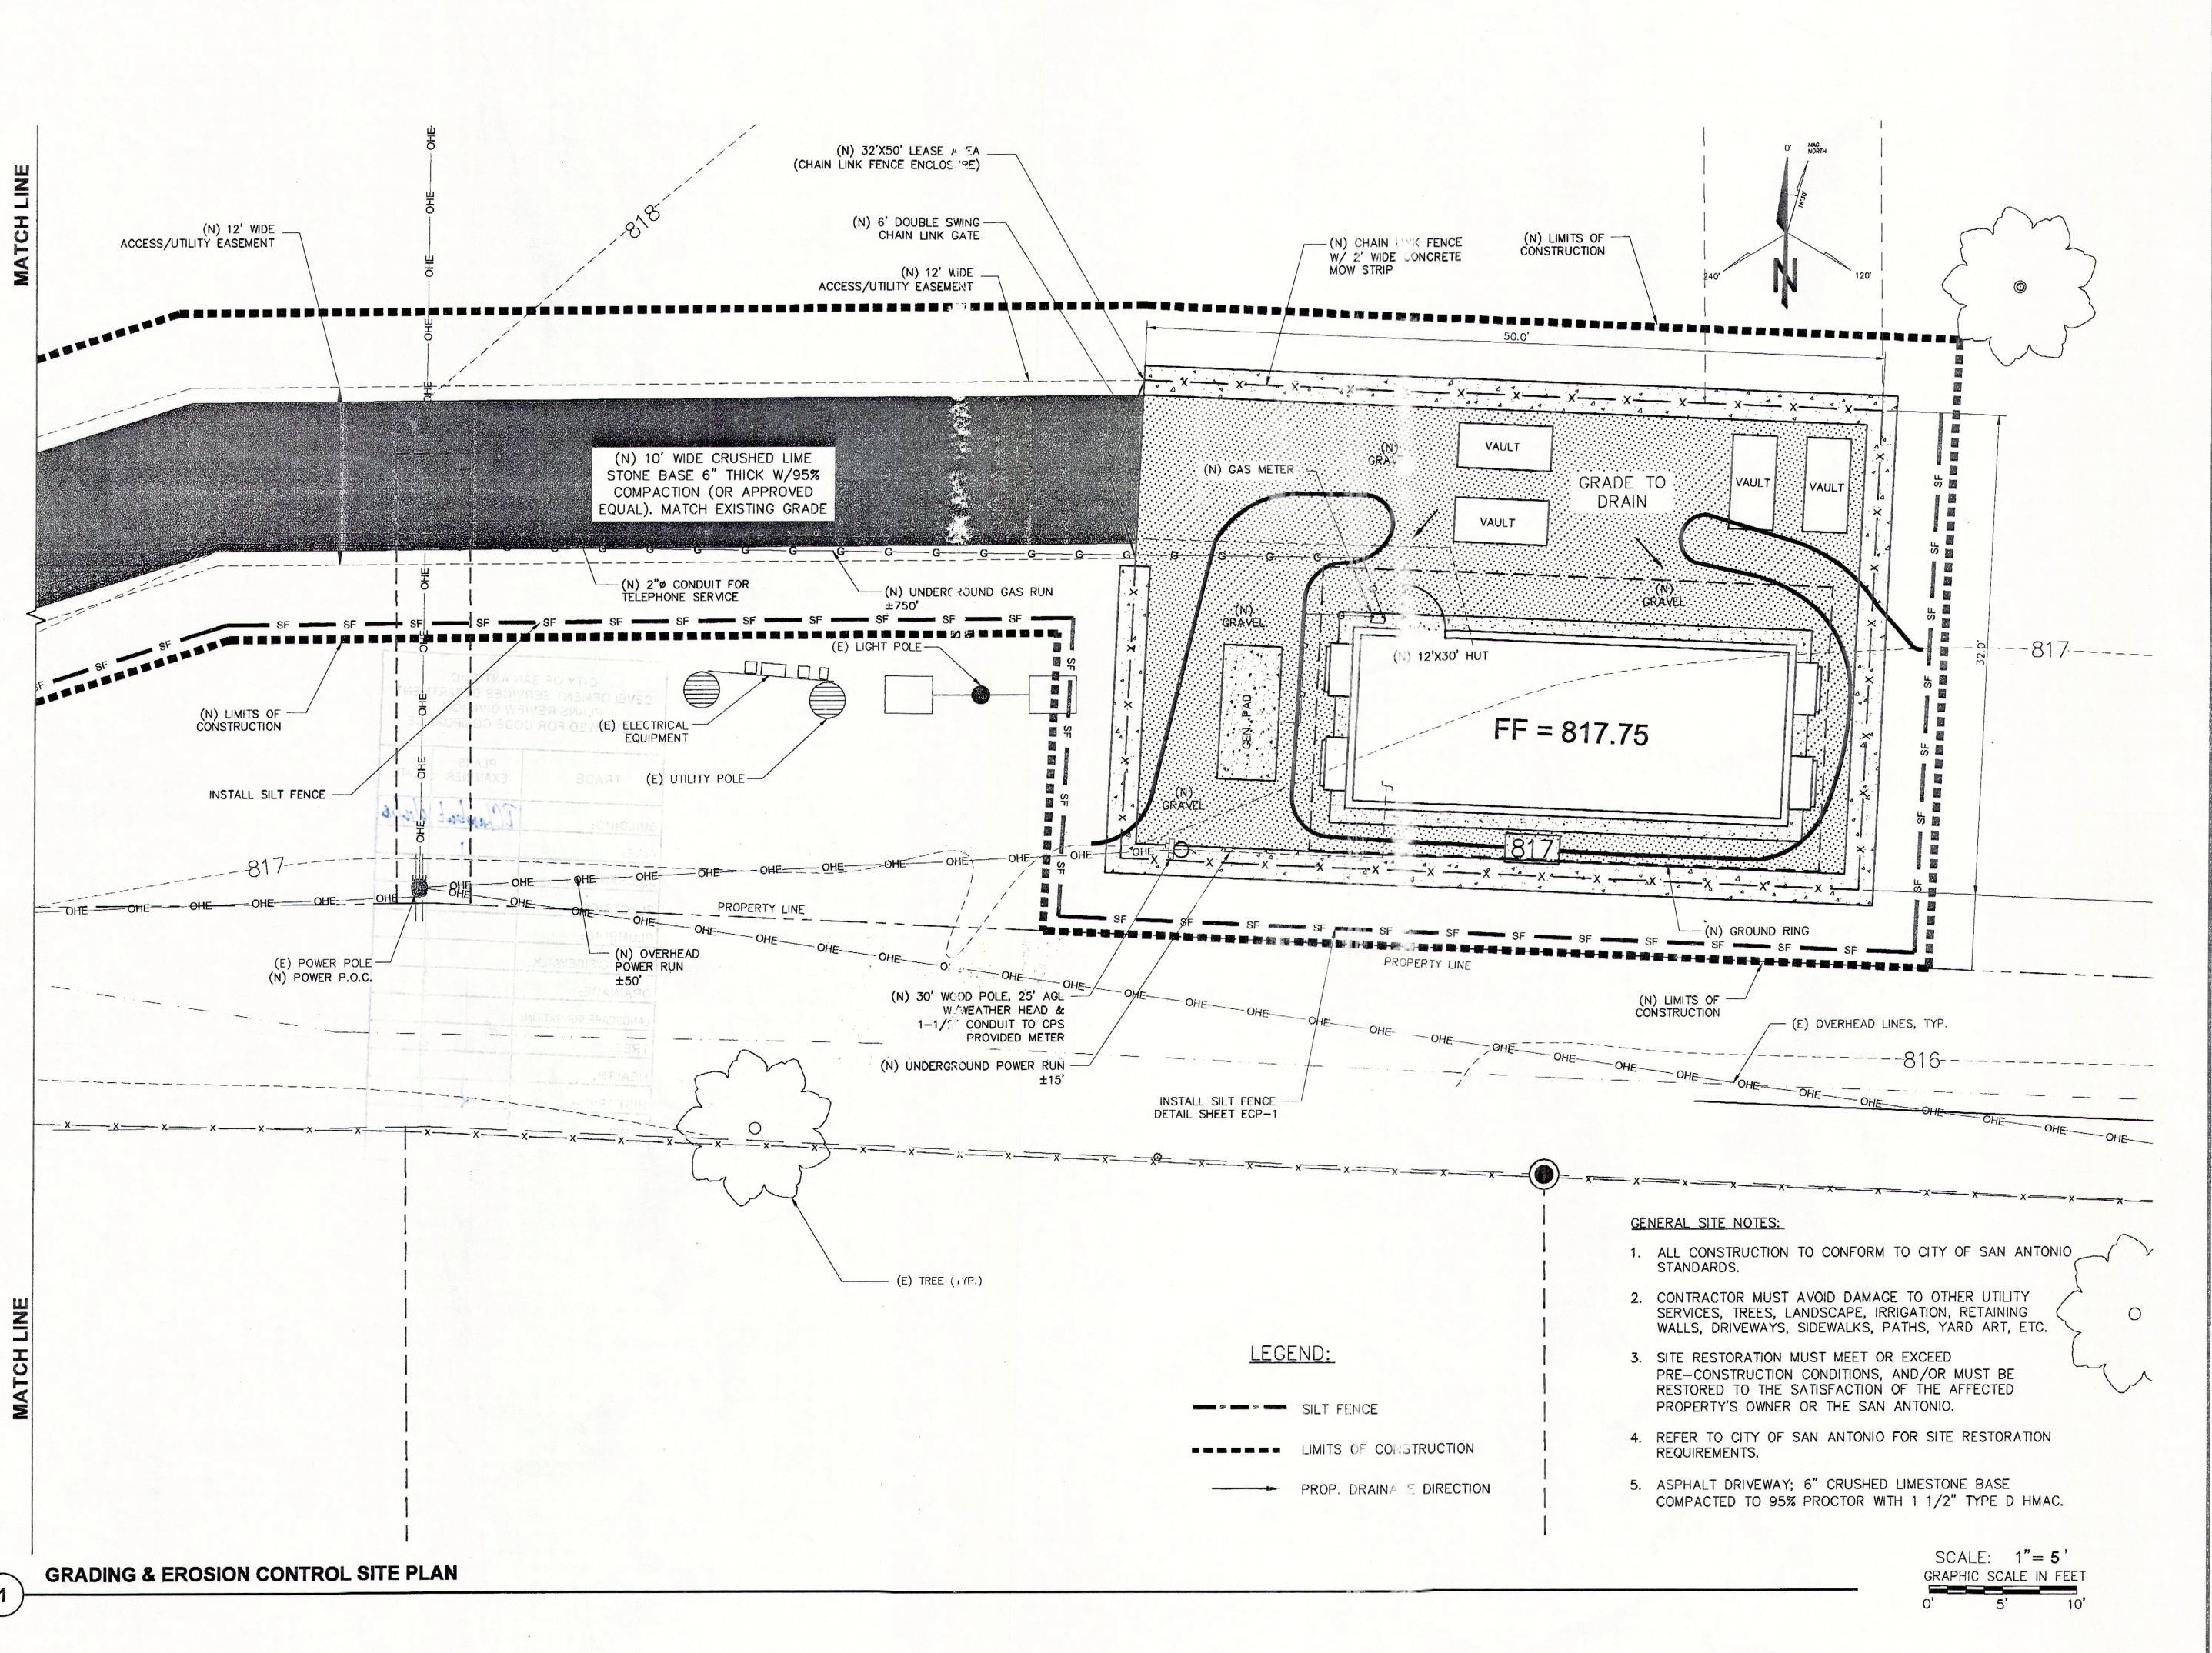

PREPARED FOR:

Gfiber

1220 CHARLESTON ROAD MOUNTAIN VIEW, CA 94043

Vend



tect:



4780 CHABOT DRIVE, SUITE 104 PLEASANTON, CA 94588 Phone: (925) 398-6000

PROJECT NO:

DRAWN BY: JA

CHECKED BY: NHP

Issued For:
CONSTRUCTION

1000		CON	SIKUCHON	
36				
1	4	09/25/15	ELEC. & GAS CHANGES	K
	3	09/16/15	SITE CHANGES	K
Section 1	2	09/04/15	100% ISSUED FOR REVIEW	K
	1	09/01/15	100% ISSUED FOR REVIEW	F

0 07/23/15 90% ISSUED FOR REVIEW J

Licensor:

OF 7444

KENNETH A. McCANNON

REV DATE DESCRIPTION

10-1-2015
IT IS A VIOLATION OF LAW FOR

ANY PERSON, UNLESS THEY ARE
ACTING UNDER THE DIRECTION OF
A LICENSED PROFESSIONAL
ENGINEER, TO ALTER THIS
DOCUMENT


Project info:

HUT ID: 108

300 HASKIN DRIVE SAN ANTONIO, TX 78209 BEXAR COUNTY

SHEET TITLE:
GRADING, DRAINAGE
& EROSION CONTROL
SITE PLAN

SHEET NUMBER:

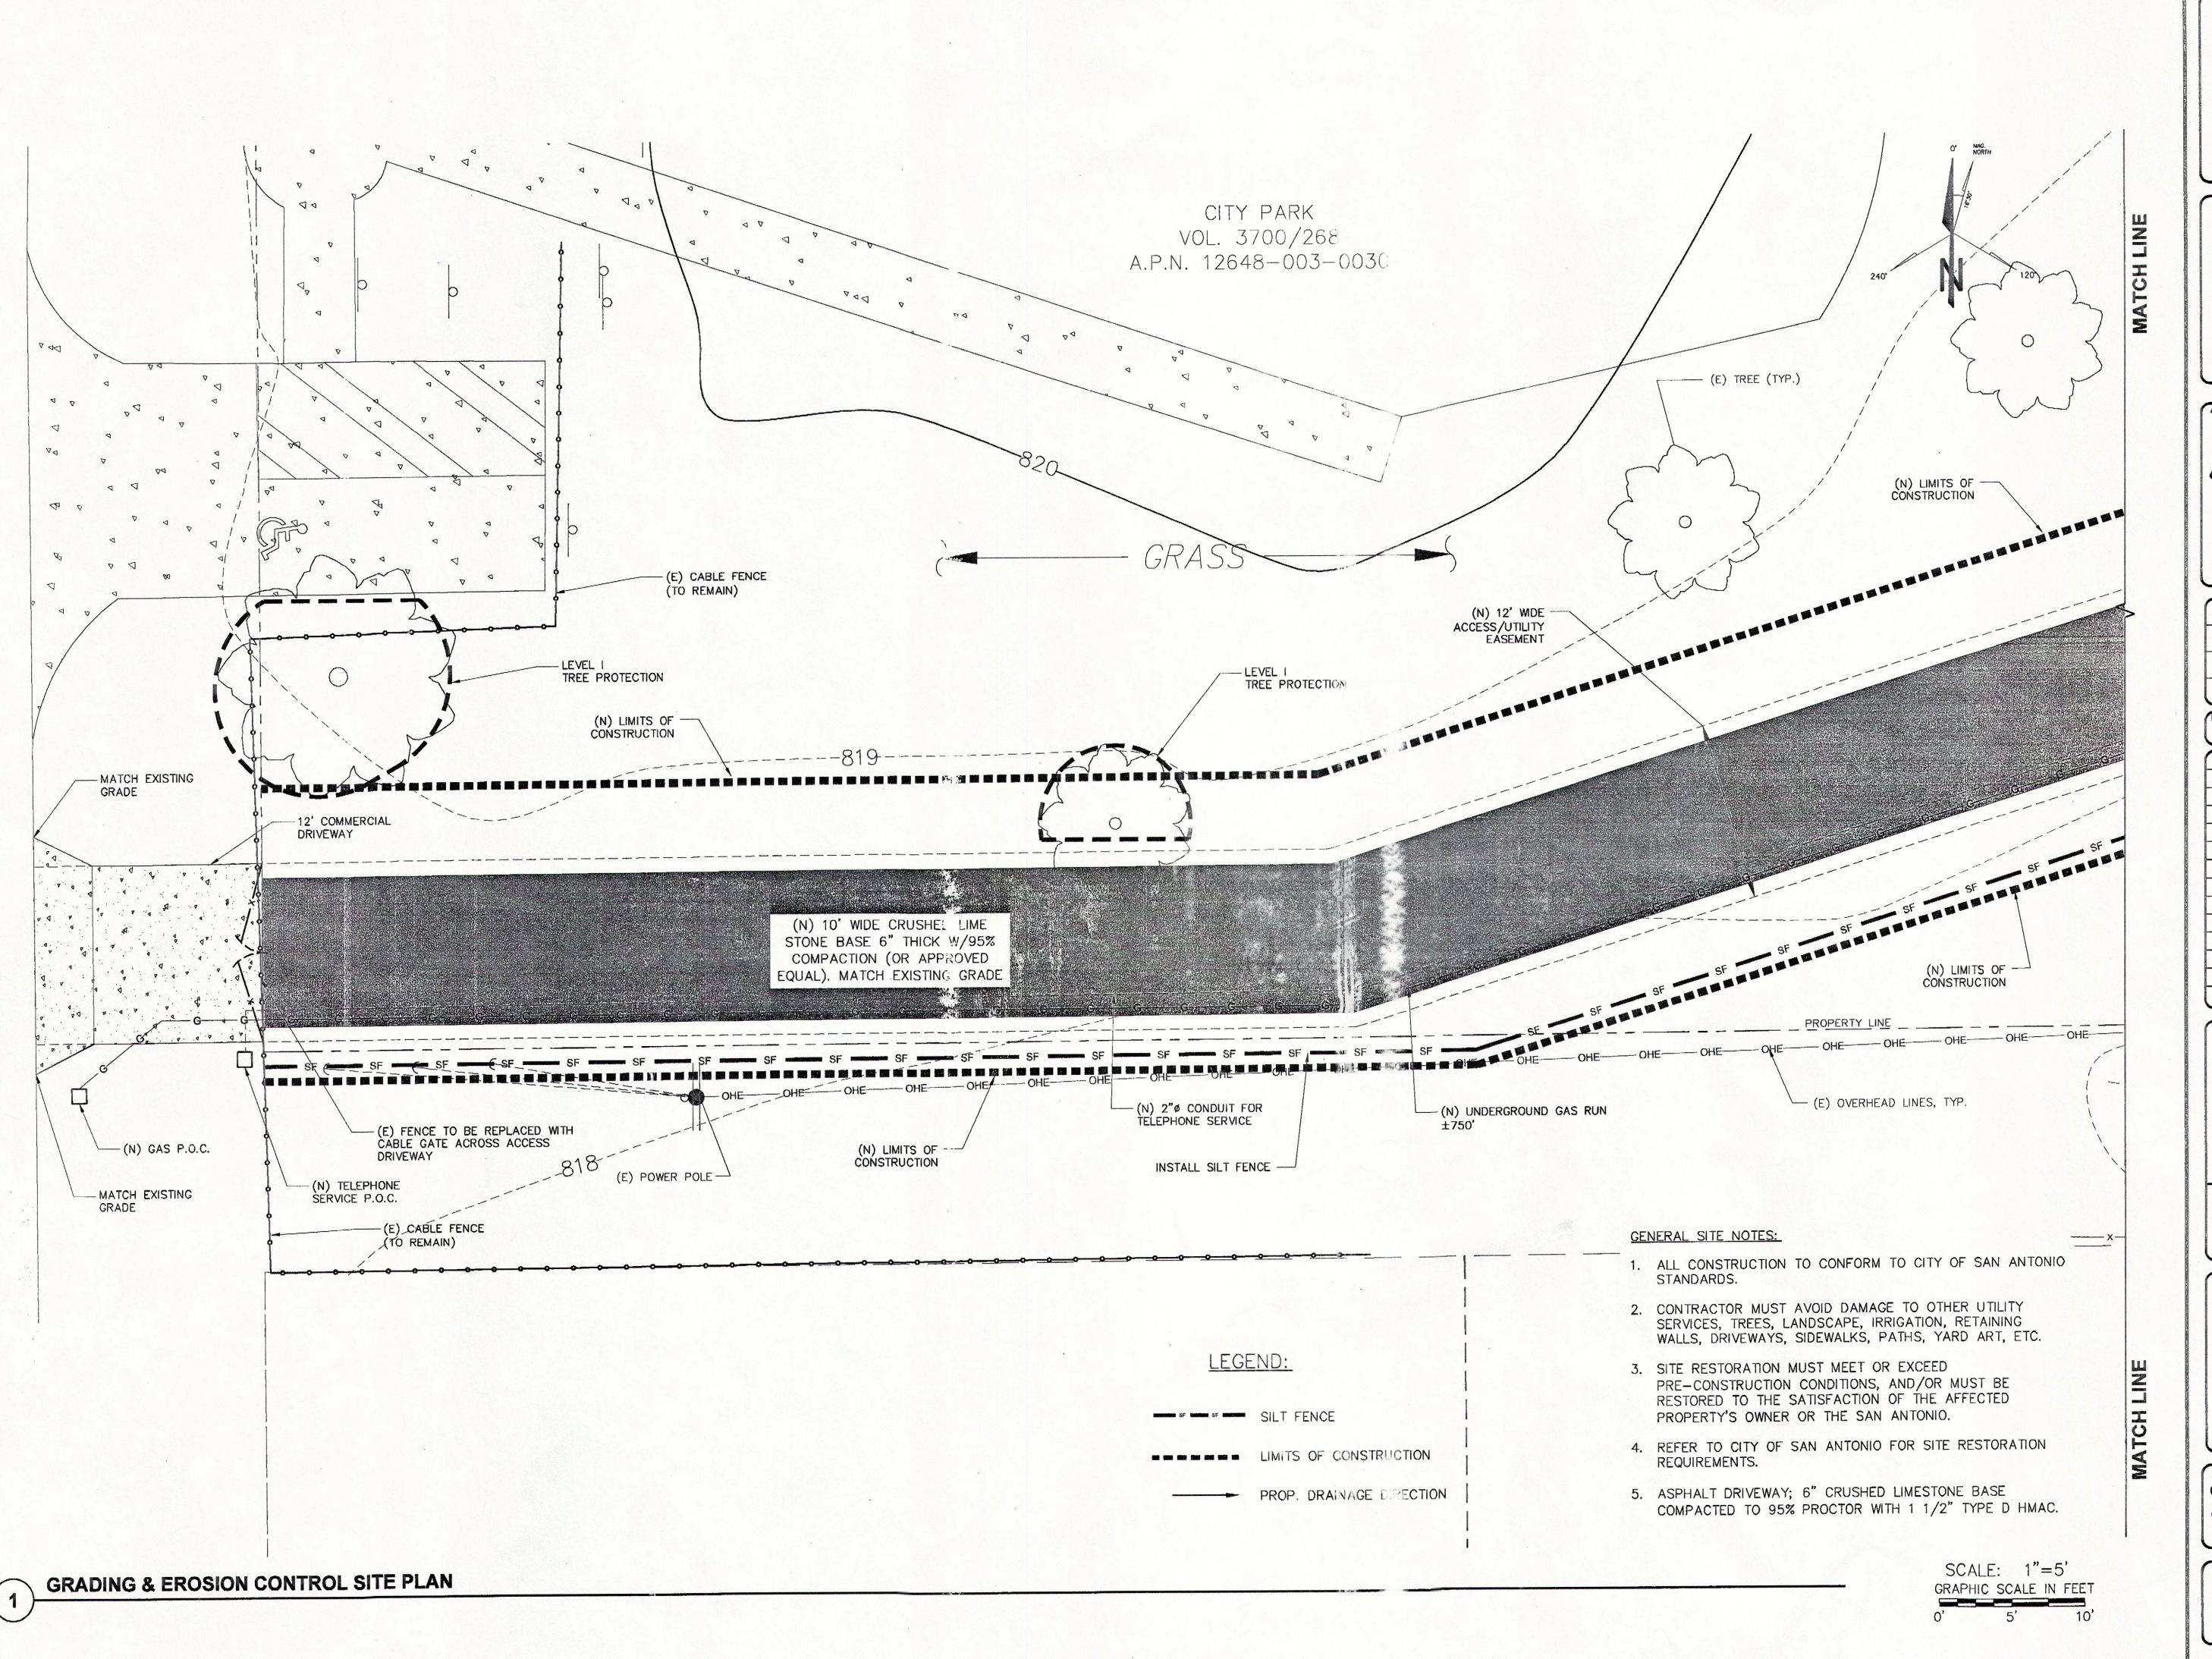

PREPARED FOR:

1220 CHARLESTON ROAD MOUNTAIN VIEW, CA 94043



enco consulting 1100 Lakeway Drive, Suite 100 Lakeway, Texas 78734 Voice: 512-261-3001 Fax: 512-261-7001 TX BOARD FIRM #F-6745



4780 CHABOT DRIVE, SUITE 104 PLEASANTON, CA 94588 Phone: (925) 398-6000

HUT ID:	108
PROJECT NO:	
DRAWN BY:	JA
CHECKED BY:	NHP

CONSTRUCTION

			-
			*
			-
			-
4	09/25/15	ELEC. & GAS CHANGES	-
3	09/16/15	SITE CHANGES	
2	09/04/15	100% ISSUED FOR REVIEW	
1	09/01/15	100% ISSUED FOR REVIEW	
0	07/23/15	90% ISSUED FOR REVIEW	
REV	DATE	DESCRIPTION	




IT IS A VIOLATION OF LAW FOR ANY PERSON, UNLESS THEY ARE ACTING UNDER THE DIRECTION OF A LICENSED PROFESSIONAL ENGINEER, TO ALTER THIS DOCUMENT

HUT ID: 108


300 HASKIN DRIVE SAN ANTONIO, TX 78209 BEXAR COUNTY

SHEET TITLE: GRADING, DRAINAGE & EROSION CONTROL SITE PLAN

SHEET NUMBER:

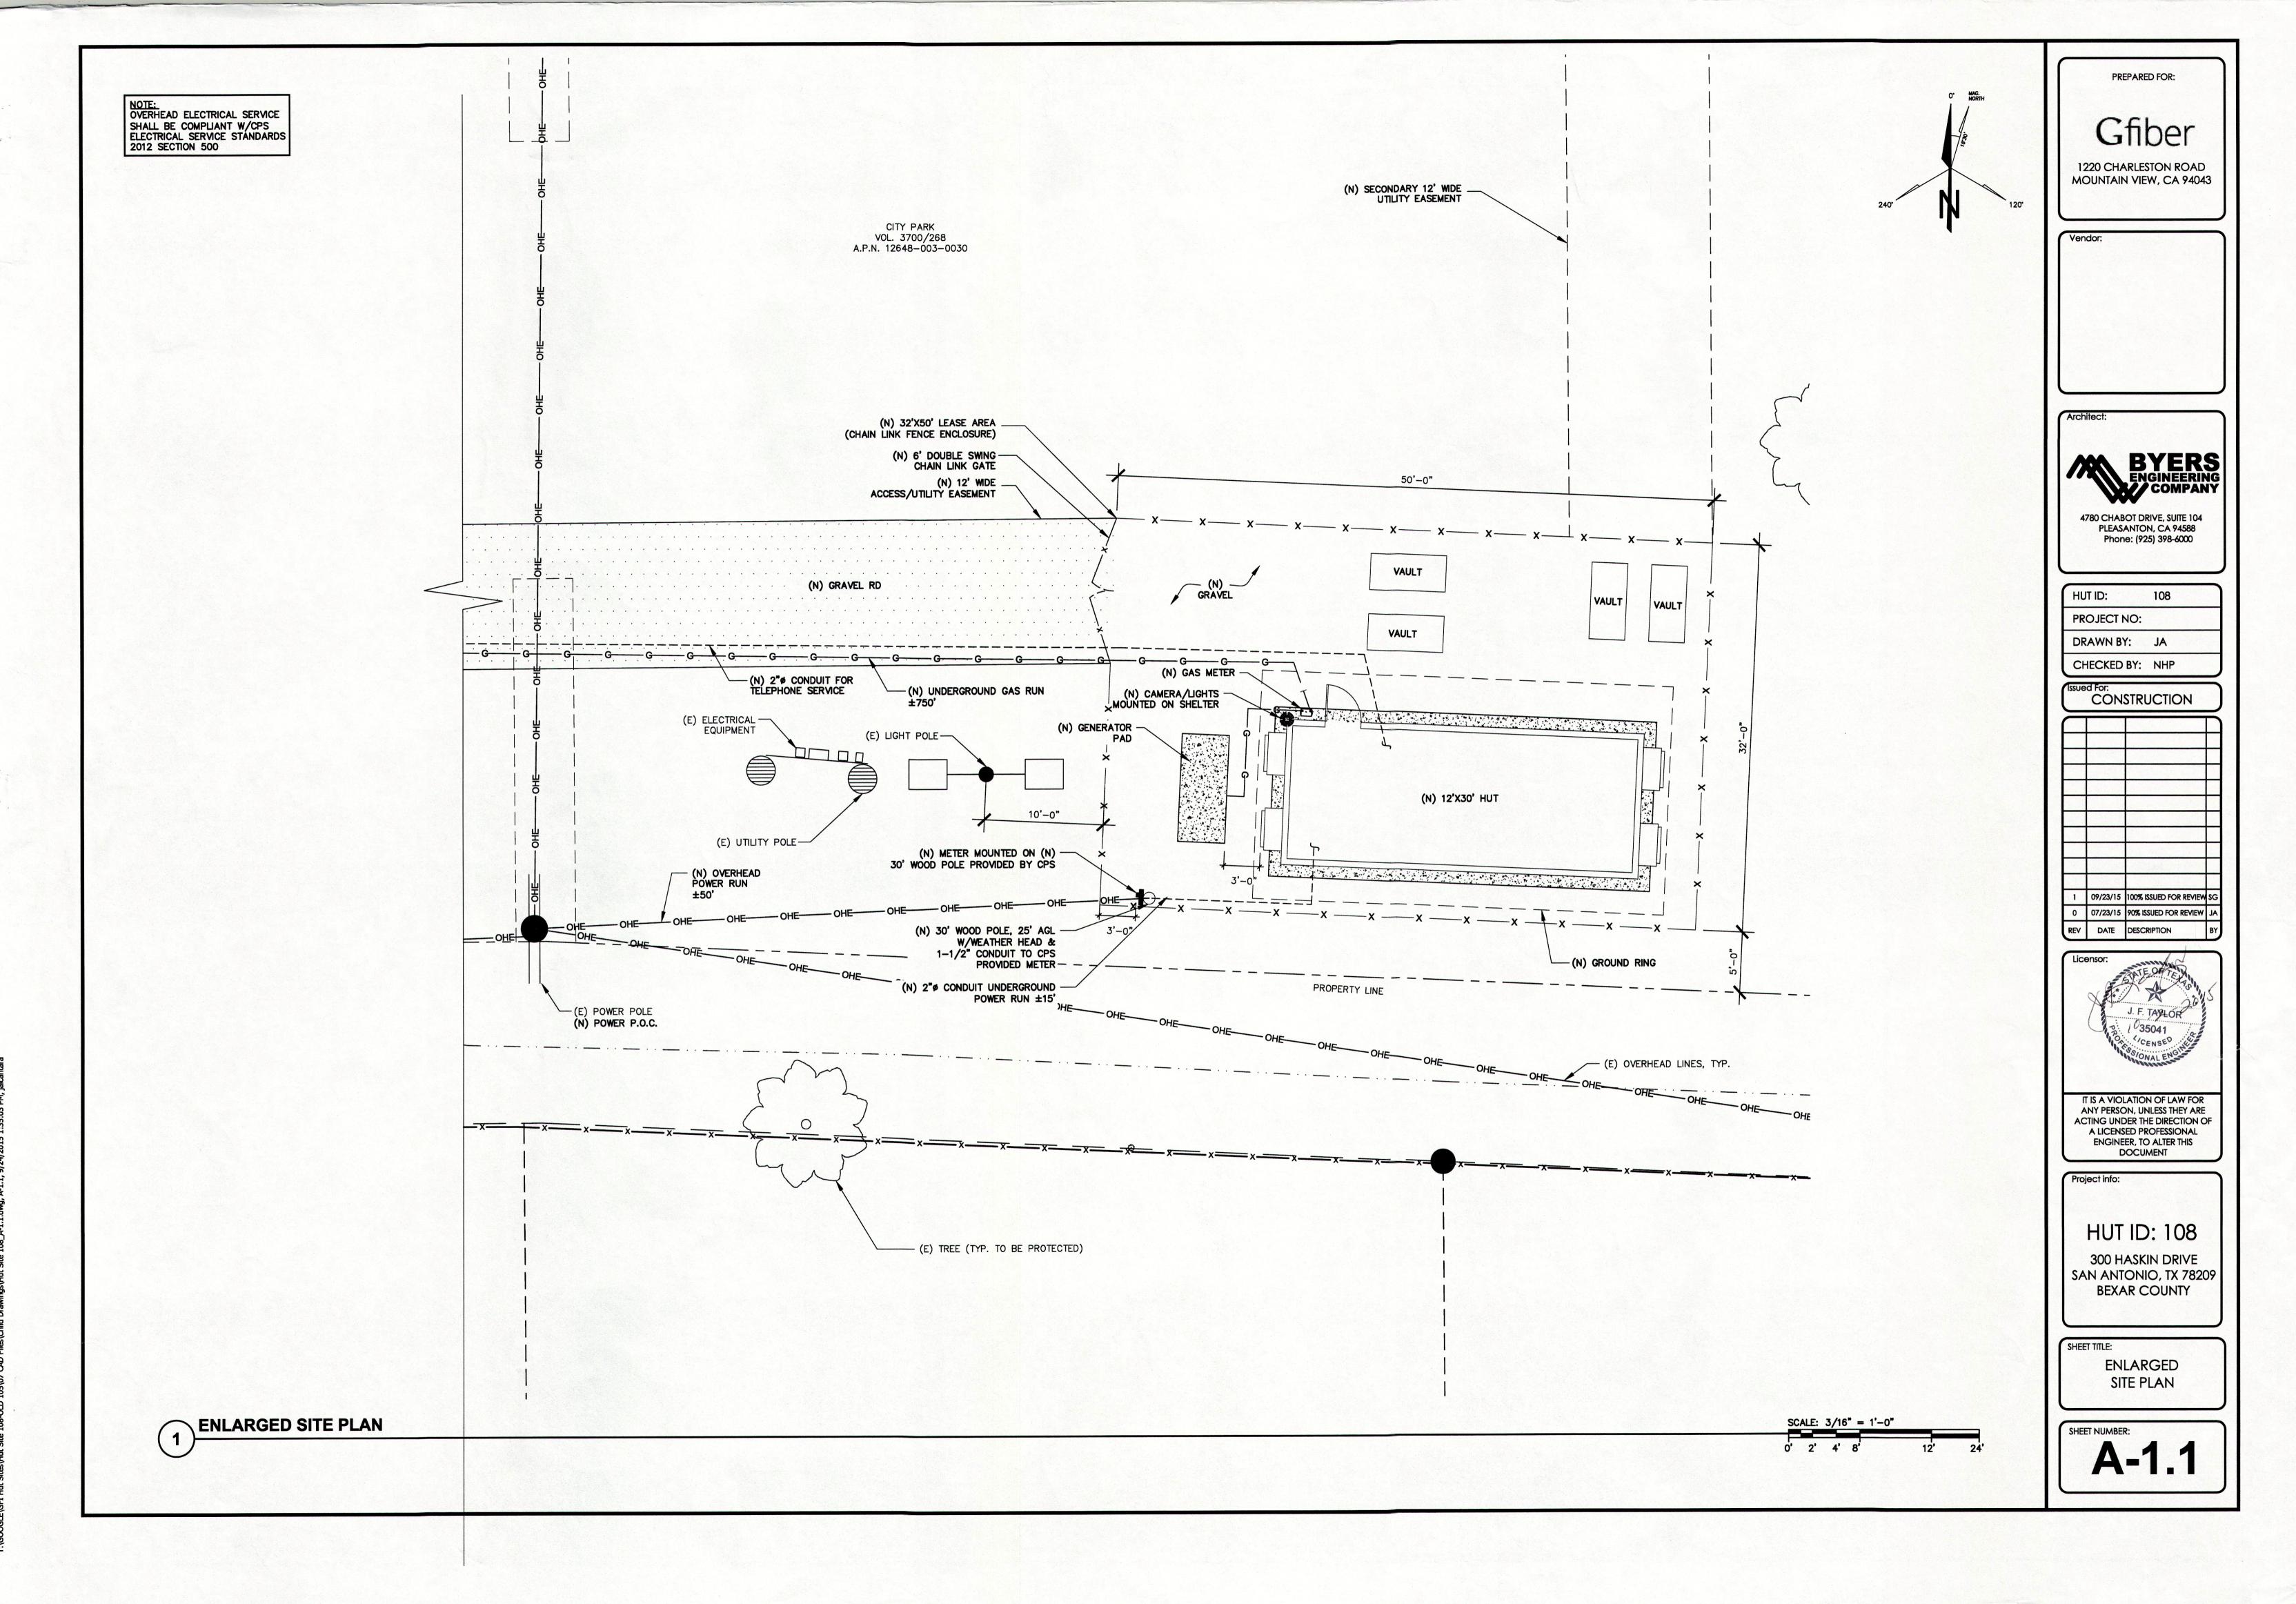

A 1 1 dura A 100 Ct D 4000 TO 700 Elizable Designable City 400 A 1 1 dura A 1 1

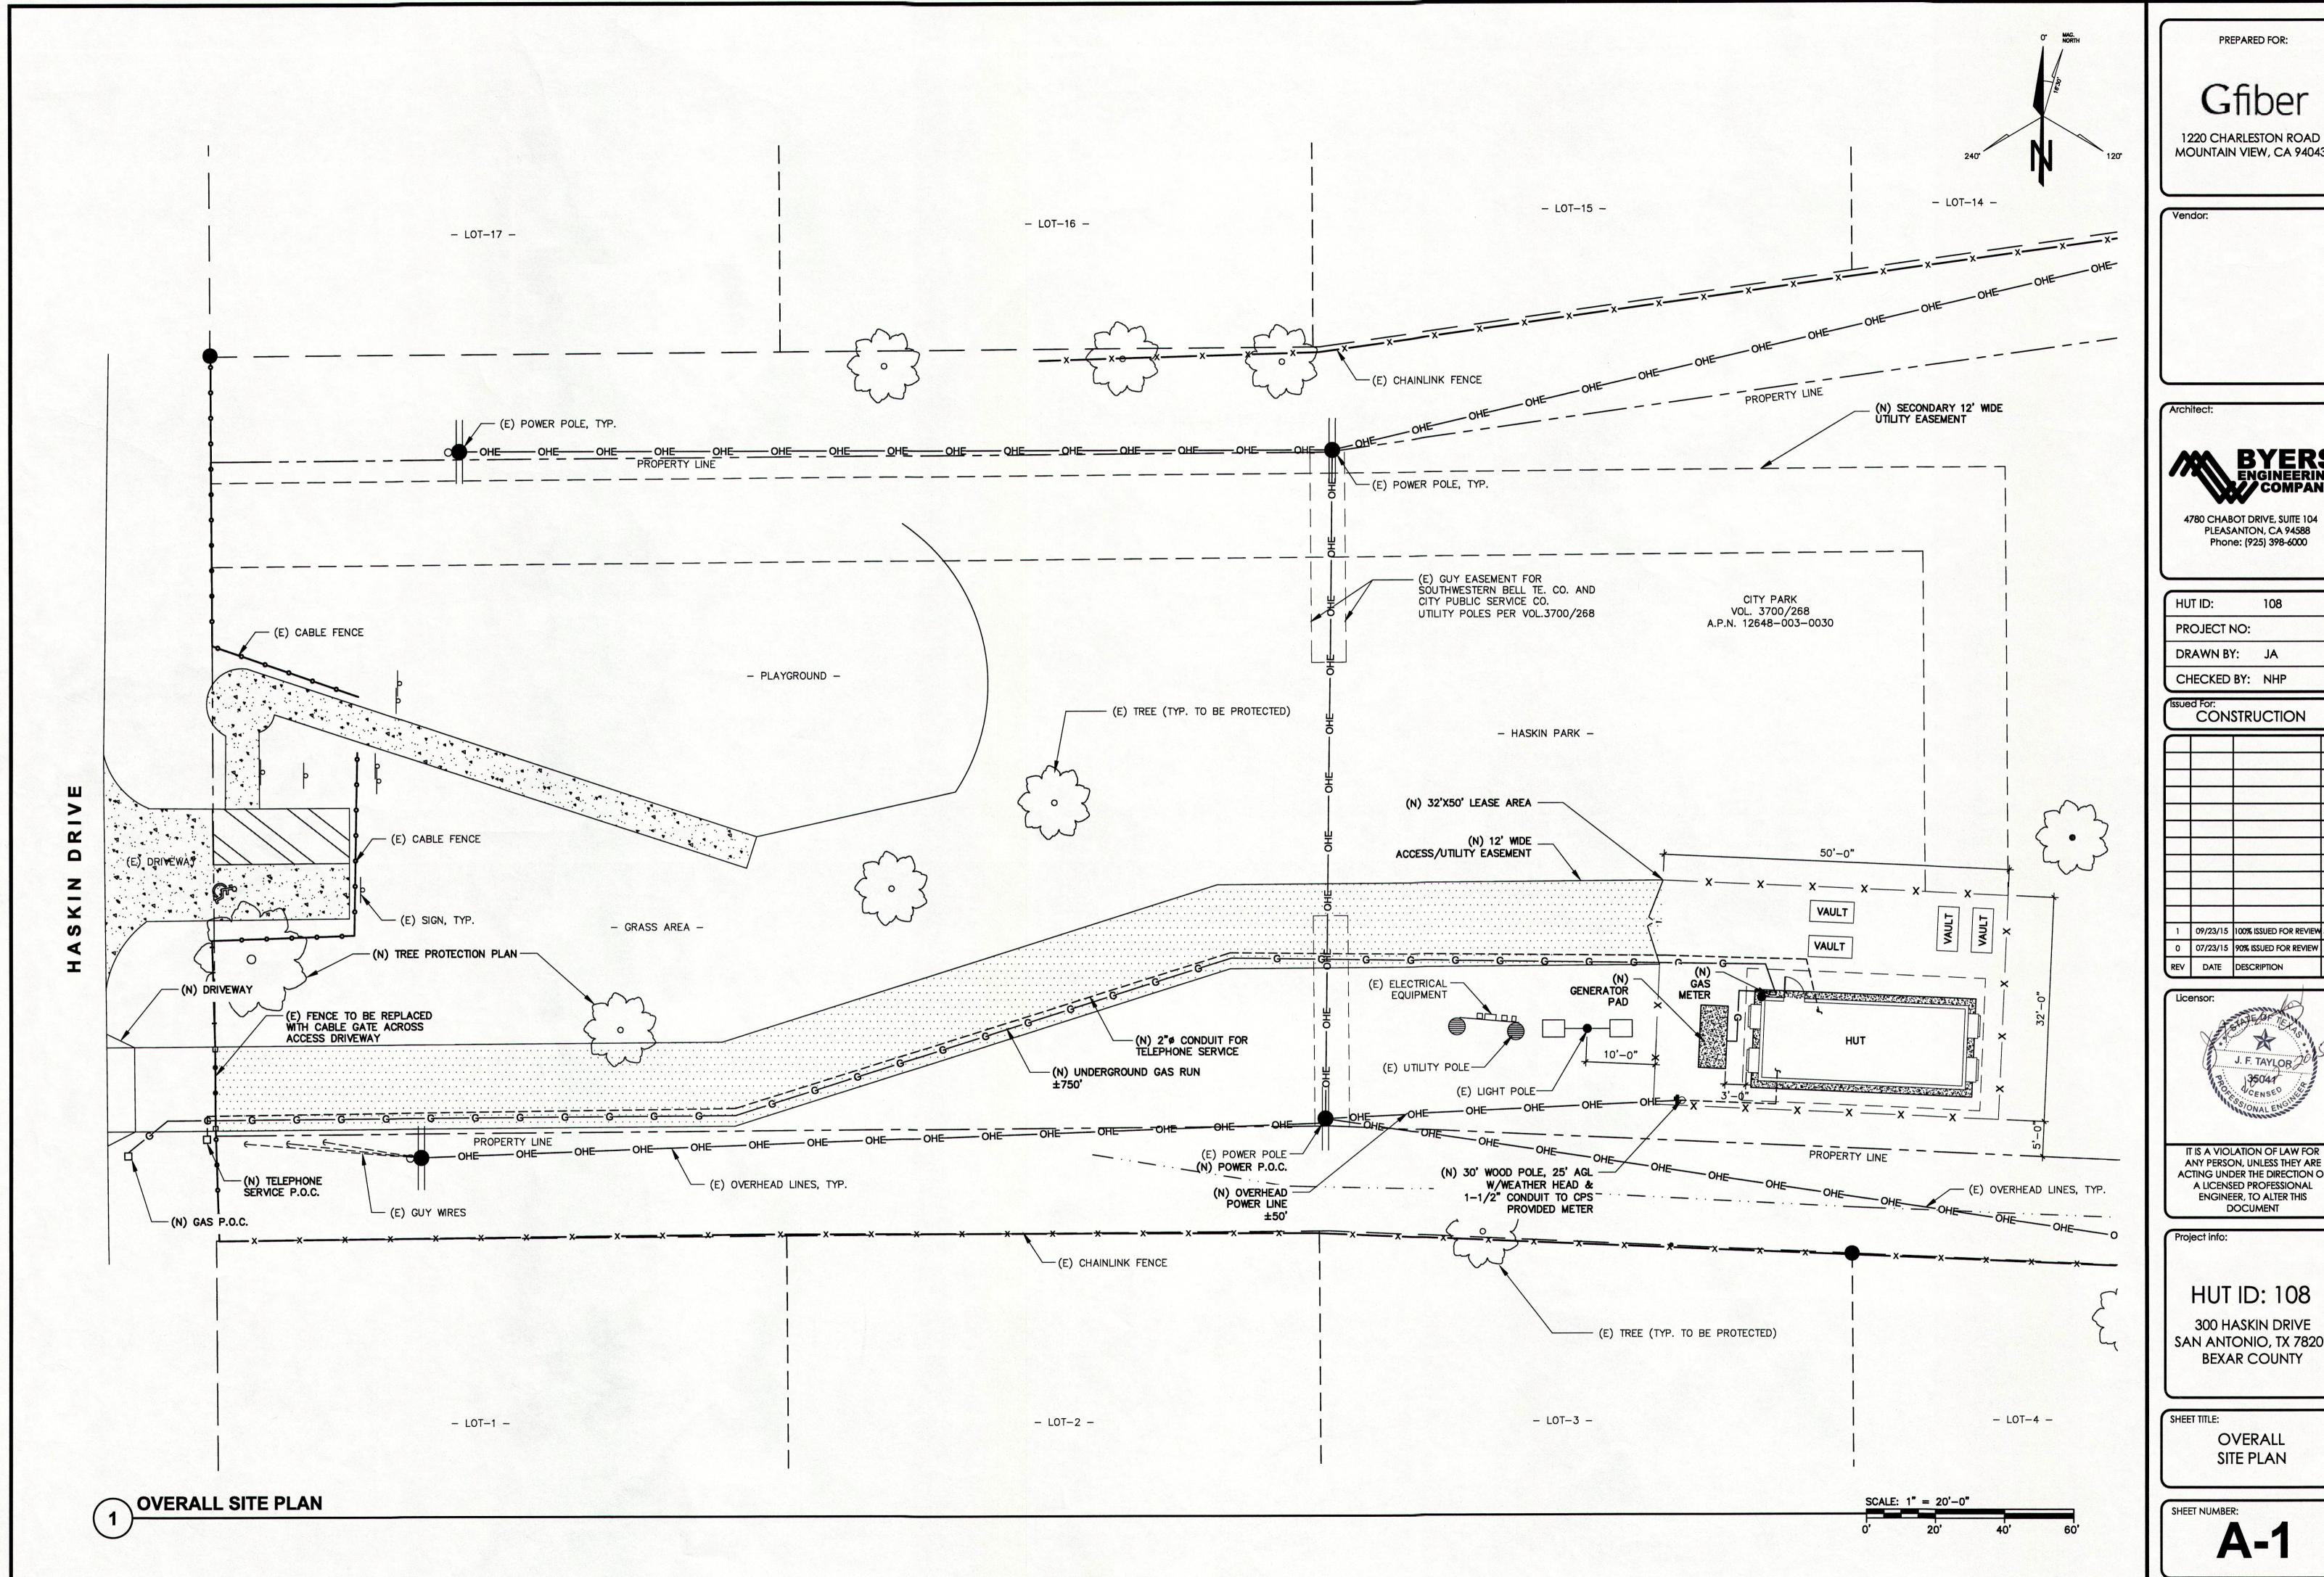

PREPARED FOR:

1220 CHARLESTON ROAD MOUNTAIN VIEW, CA 94043



108


PROJECT NO:

DRAWN BY: JA

CONSTRUCTION

1 09/23/15 100% ISSUED FOR REVIEW SG

0 07/23/15 90% ISSUED FOR REVIEW J REV DATE DESCRIPTION

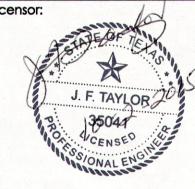

IT IS A VIOLATION OF LAW FOR ANY PERSON, UNLESS THEY ARE ACTING UNDER THE DIRECTION OF A LICENSED PROFESSIONAL ENGINEER, TO ALTER THIS DOCUMENT


Project info:

HUT ID: 108

300 HASKIN DRIVE SAN ANTONIO, TX 78209 BEXAR COUNTY

> **OVERALL** SITE PLAN

SHEET NUMBER: **A-1**

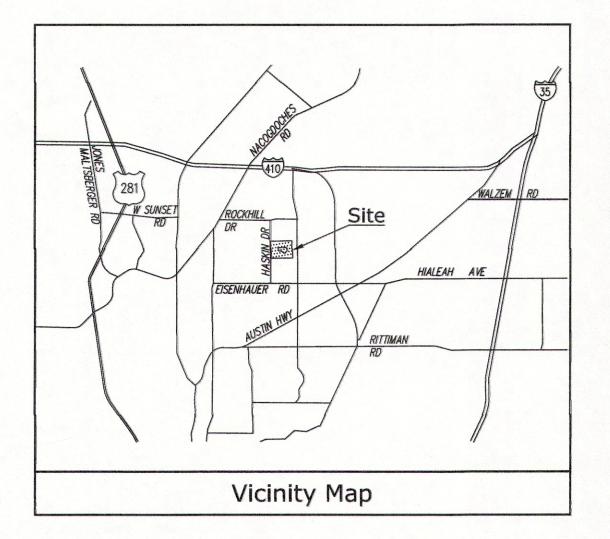

Title Report PREPARED BY: THE ACCURATE GROUP OF TEXAS, LLC

MAY 28, 2015

Legal Description

CITY PARK, OF SHERWOOD PARK, IN THE CITY OF SAN ANTONIO, COUNTY OF BEXAR, STATE OF TEXAS, AS SHOWN ON PLAT FILED IN VOLUME 3700 PAGE 268, DEED AND PLAT RECORDS OF BEXAR COUNTY, TEXAS.

Assessor's Parcel No.

Certificate of Survey

THIS IS TO CERTIFY THAT THIS TOPOCRAPHIC MAP AND IMPROVEMENTS SHOWN ARE CORRECTED THE BEST OF THE KNOWLEDGE AND BELIEF.

REFERENCE IS MADE TO A COMMITMENT FOR TITLE INSURANCE, NUMBER 1916487, ISSUED BY THE ACCURATE GROUP OF TEXAS, LLC, AND HAVING AN EFFECTIVE DATE OF MAY 28, 2015. THIS SURVEYOR HAS MADE NO INVESTIGATION OR INDEPENDENT SEARCH FOR EASEMENTS OF RECORD, ENCUMBRANCES, RESTRICTIVE COVENANTS, OWNERSHIP TITLE EVIDENCE. OR ANY OTHER FACTS THAT AN ACCURATE AND CURRENT TITLE SEARCH MAY DISCLOSE. THE LESSOR'S LEGAL DESCRIPTION AND RECORD BOUNDARY ARE SHOWN HEREON FOR REFERENCE ONLY. THIS SURVEY DOES NOT CONSTITUTE A BOUNDARY SURVEY OF THE LESSOR'S PROPERTY.

Easements

NO EASEMENTS ATTACHED TO SAID TITLE REPORT.

Access/Utility Easement and Lease Area

ALL WITHIN A PORTION OF CITY PARK, OF SHERWOOD PARK, IN THE CITY OF SAN ANTONIO, COUNTY OF BEXAR, STATE OF TEXAS, AS SHOWN ON PLAT FILED IN VOLUME 3700 PAGE 268, DEED AND PLAT RECORDS OF BEXAR COUNTY, TEXAS:

ACCESS/UTILITY EASEMENT:
BEING A STRIP OF LAND 12.00 FEET IN WIDTH, LYING 6.00 FEET ON EACH SIDE OF THE FOLLOWING DESCRIBED CENTERLINE: COMMENCING AT THE SOUTHWEST CORNER OF PLAT FILED IN VOLUME 3700 PAGE 268, IN THE OFFICE OF THE COUNTY RECORDER OF SAID COUNTY: THENCE ALONG SAID EASTERLY RIGHT-OF-WAY OF HASKIN DRIVE, NO0"23"43"W, 6.71 FEET TO THE POINT OF BEGINNING; THENCE N89'36'17"E, 74.11 FEET; THENCE N72'39'51"E 74.93 FEET; THENCE N89'36'17"E, 63.26 FEET TO A POINT HEREINAFTER REFERRED TO AS POINT "A" AND TO THE END OF SAID STRIP.

THE SIDELINES OF SAID STRIP SHALL BE PROLONGED OR SHORTENED AS TO TERMINATE ON THE EASTERLY RIGHT-OF-WAY OF HASKIN

LEASE AREA:

A PORTION OF LAND MORE PARTICULARLY DESCRIBED AS FOLLOWS: BEGINNING AT POINT "A" AS DESCRIBED ABOVE; THENCE NO2'35'19"E, 6.00 FEET; THENCE S87"24'41"E, 43.99 FEET TO A POINT HEREINAFTER REFERRED TO AS POINT "B"; THENCE CONTINUING S87"24"41"E, 6.01 FEET; THENCE S02"35"19"W, 32.00 FEET; THENCE N87"24"41"W, 50.00 FEET; THENCE N02"35"19"E, 26.00 FEET TO THE POINT OF BEGINNING.

CONTAINING 1,600 SQUARE FEET OF LAND.

SECONDARY UTILITY EASEMENT:

BEING A STRIP OF LAND 12.00 FEET IN WIDTH, LYING 6.00 FEET ON EACH SIDE OF THE FOLLOWING DESCRIBED CENTERLINE: BEGINNING AT POINT "B" AS DESCRIBED ABOVE; THENCE NO0"23"43"W, 54.87 FEET; THENCE S89"36"17"W, 253.30 FEET TO THE END

THE SIDELINES OF SAID STRIP SHALL BE PROLONGED OR SHORTENED AS TO TERMINATE ON THE EASTERLY RIGHT-OF-WAY OF HASKIN

Geographic Coordinates at Proposed Lease Area

1983 DATUM: LATITUDE 29° 29' 51.14"N LONGITUDE 98° 26' 44.01"W ELEVATION = 817.3 FEET ABOVE MEAN SEA LEVEL

CERTIFICATION: THE LATITUDE AND LONGITUDE SHOWN ABOVE ARE ACCURATE TO WITHIN +/- 15 FEET HORIZONTALLY AND THAT THE ELEVATIONS SHOWN ABOVE ARE ACCURATE TO WITHIN +/- 3 FEET VERTICALLY. THE HORIZONTAL DATUM (GEOGRAPHIC COORDINATES) IS IN TERMS OF THE NORTH AMERICAN DATUM OF 1983 (NAD 83) AND IS EXPRESSED IN DEGREES (*), MINUTES (') AND SECONDS ("), TO THE NEAREST HUNDREDTH OF A SECOND. THE VERTICAL DATUM (ELEVATIONS) IS IN TERMS OF THE NORTH AMERICAN VERTICAL DATUM OF 1988 (NAVD 88) AND IS DETERMINED TO THE NEAREST TENTH

Basis of Bearings


THE STATE PLANE COORDINATE SYSTEM OF 1983 (NAD 83), TEXAS SOUTH CENTRAL ZONE.


Bench Mark

THE NATIONAL GEODETIC SURVEY CENTER C.O.R.S "TXAN", ELEVATION = 952.15 FEET (NAVD 88).


Date of Survey

MAY 31, 2015

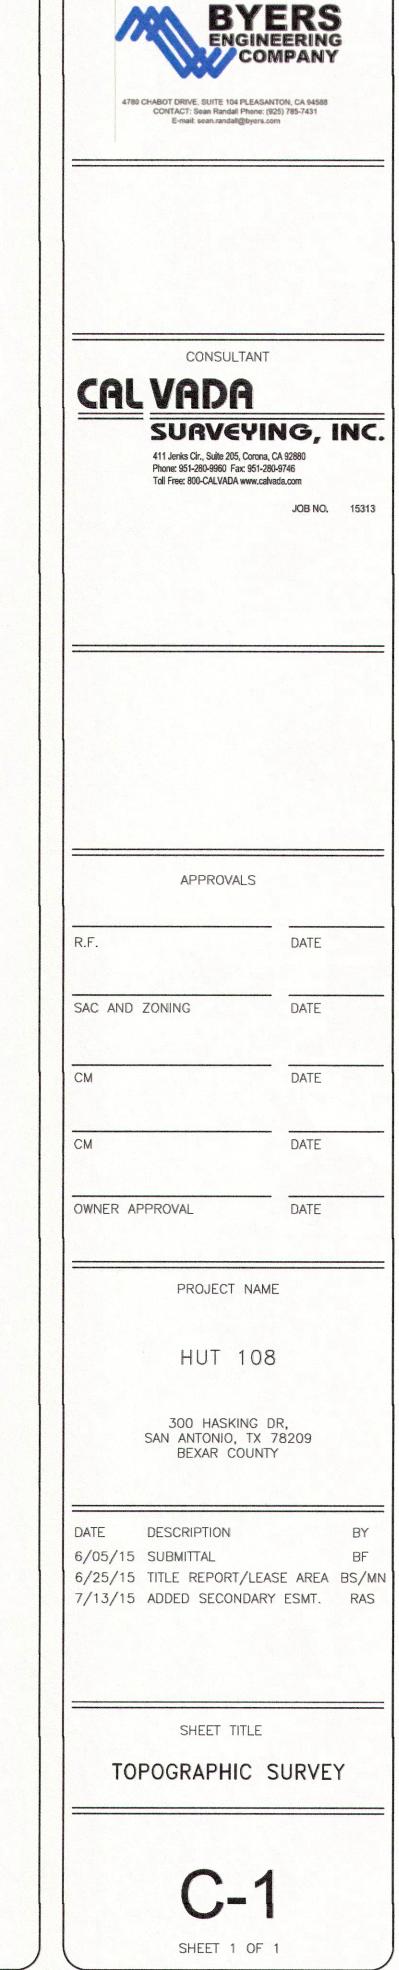

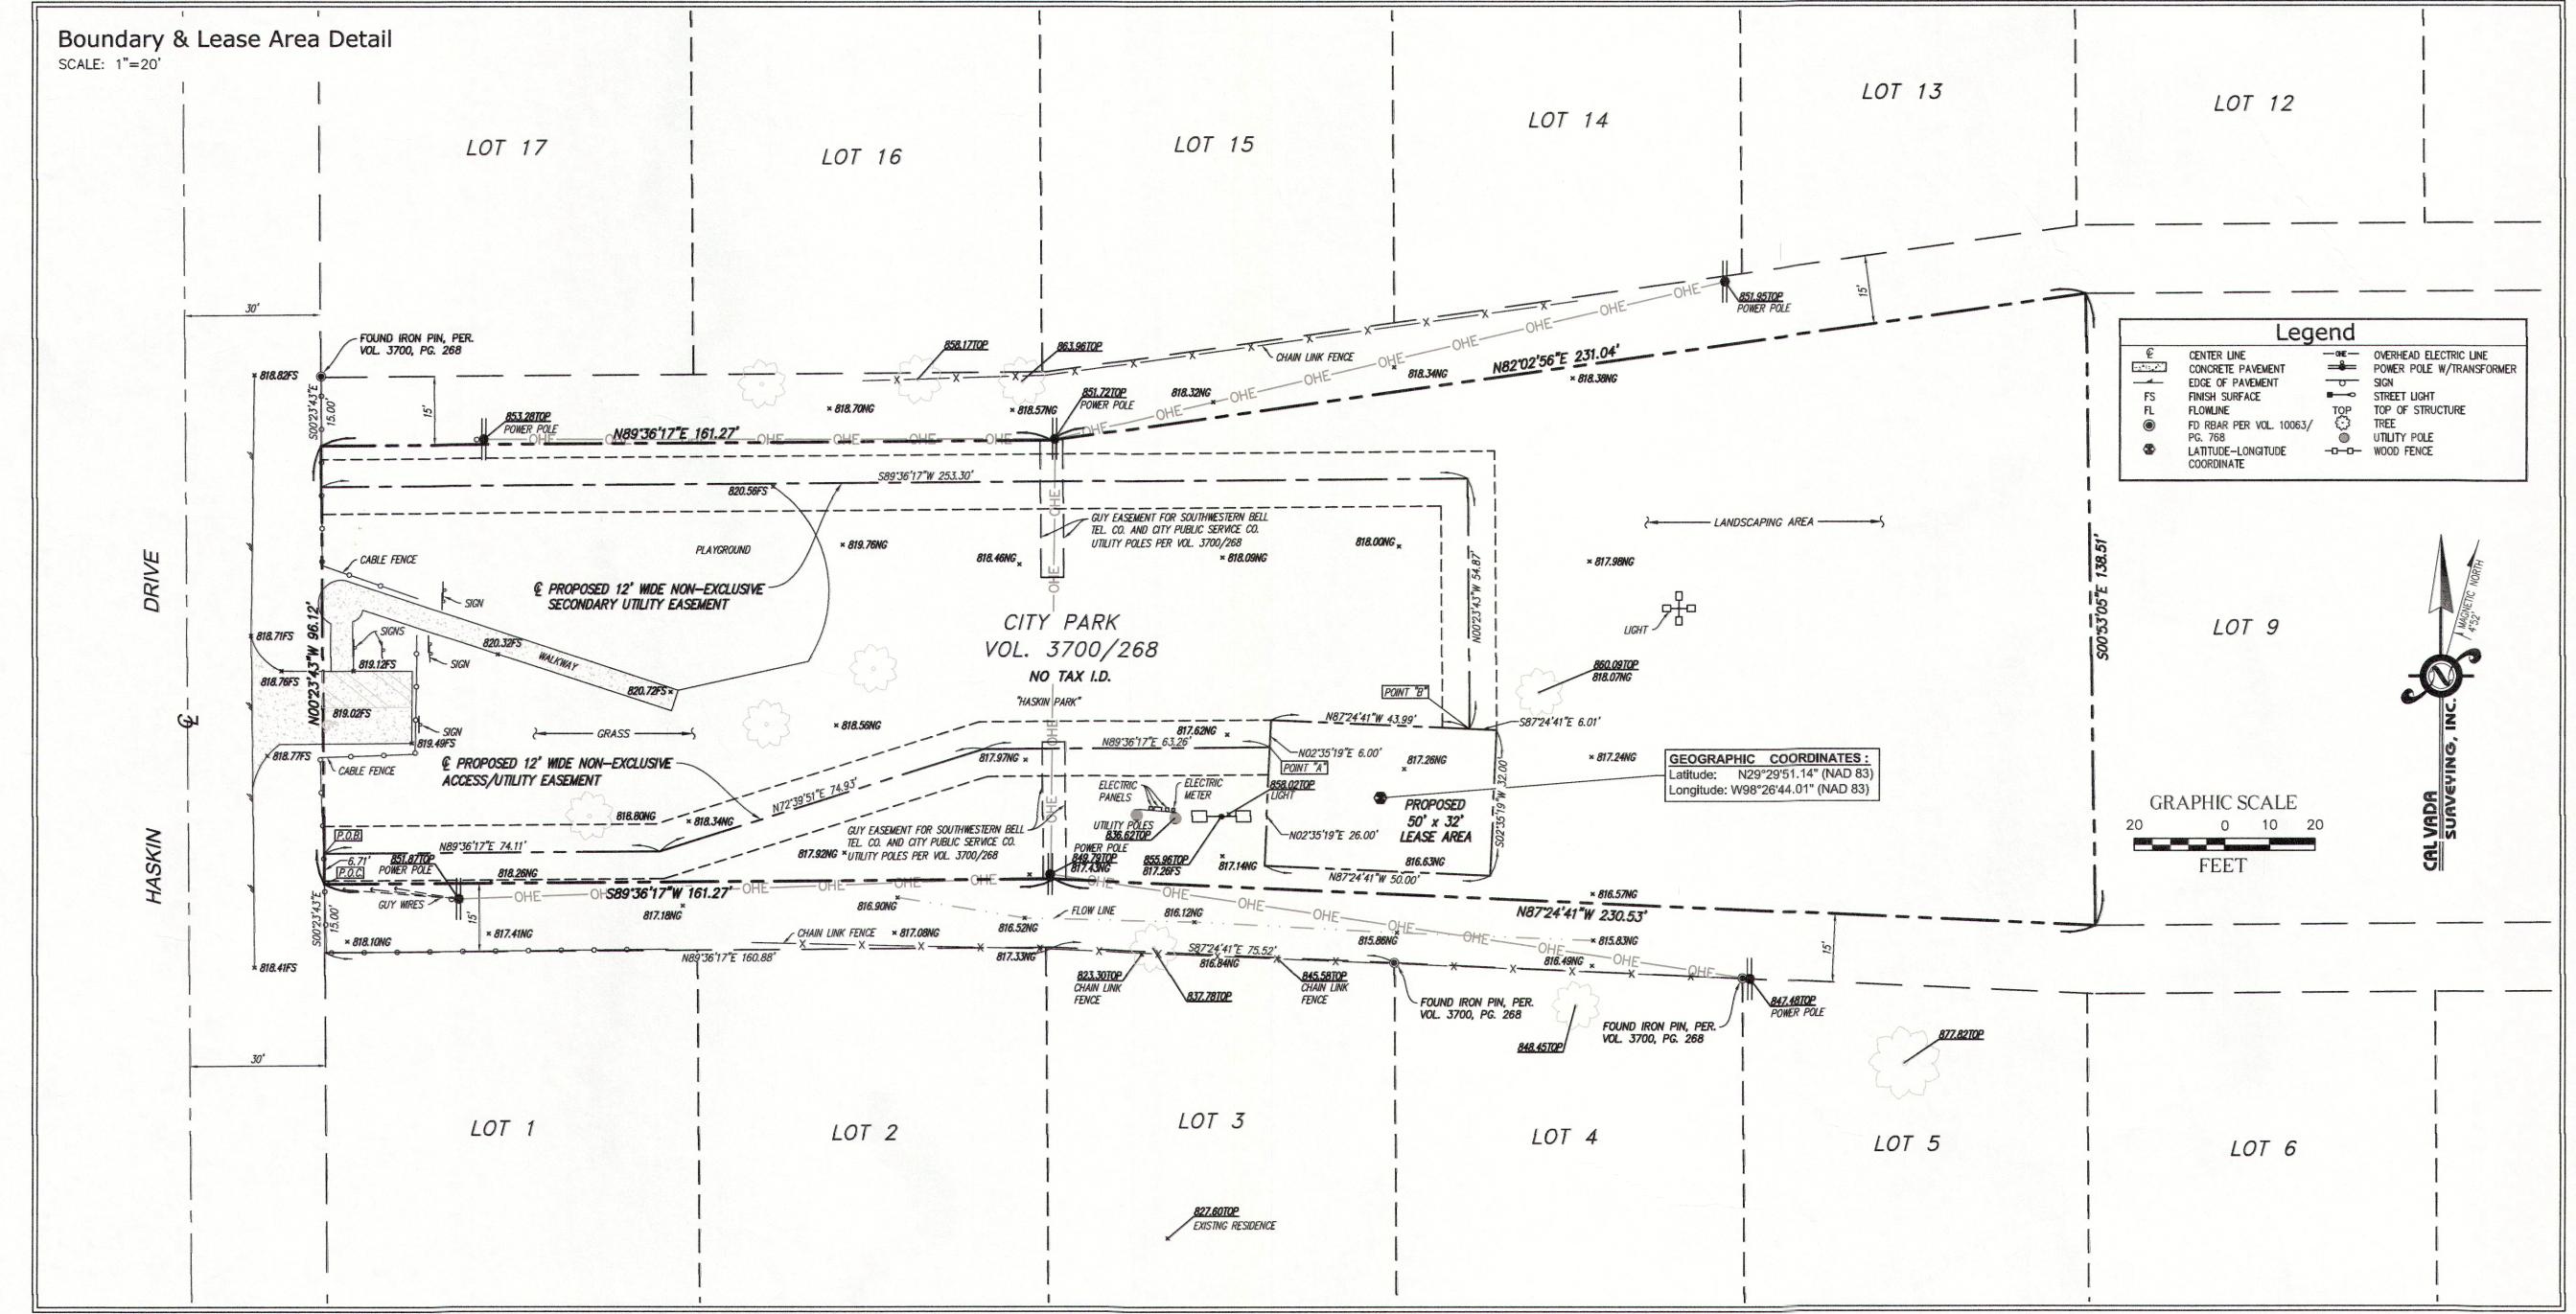

NOTE:
PUBLIC UTILITIES— BOTH ELECTRICAL AND
NATURAL GAS MAY REQUIRE SEPARATE
ROUTING AND/OR EASEMENT DEPENDING
ON POC

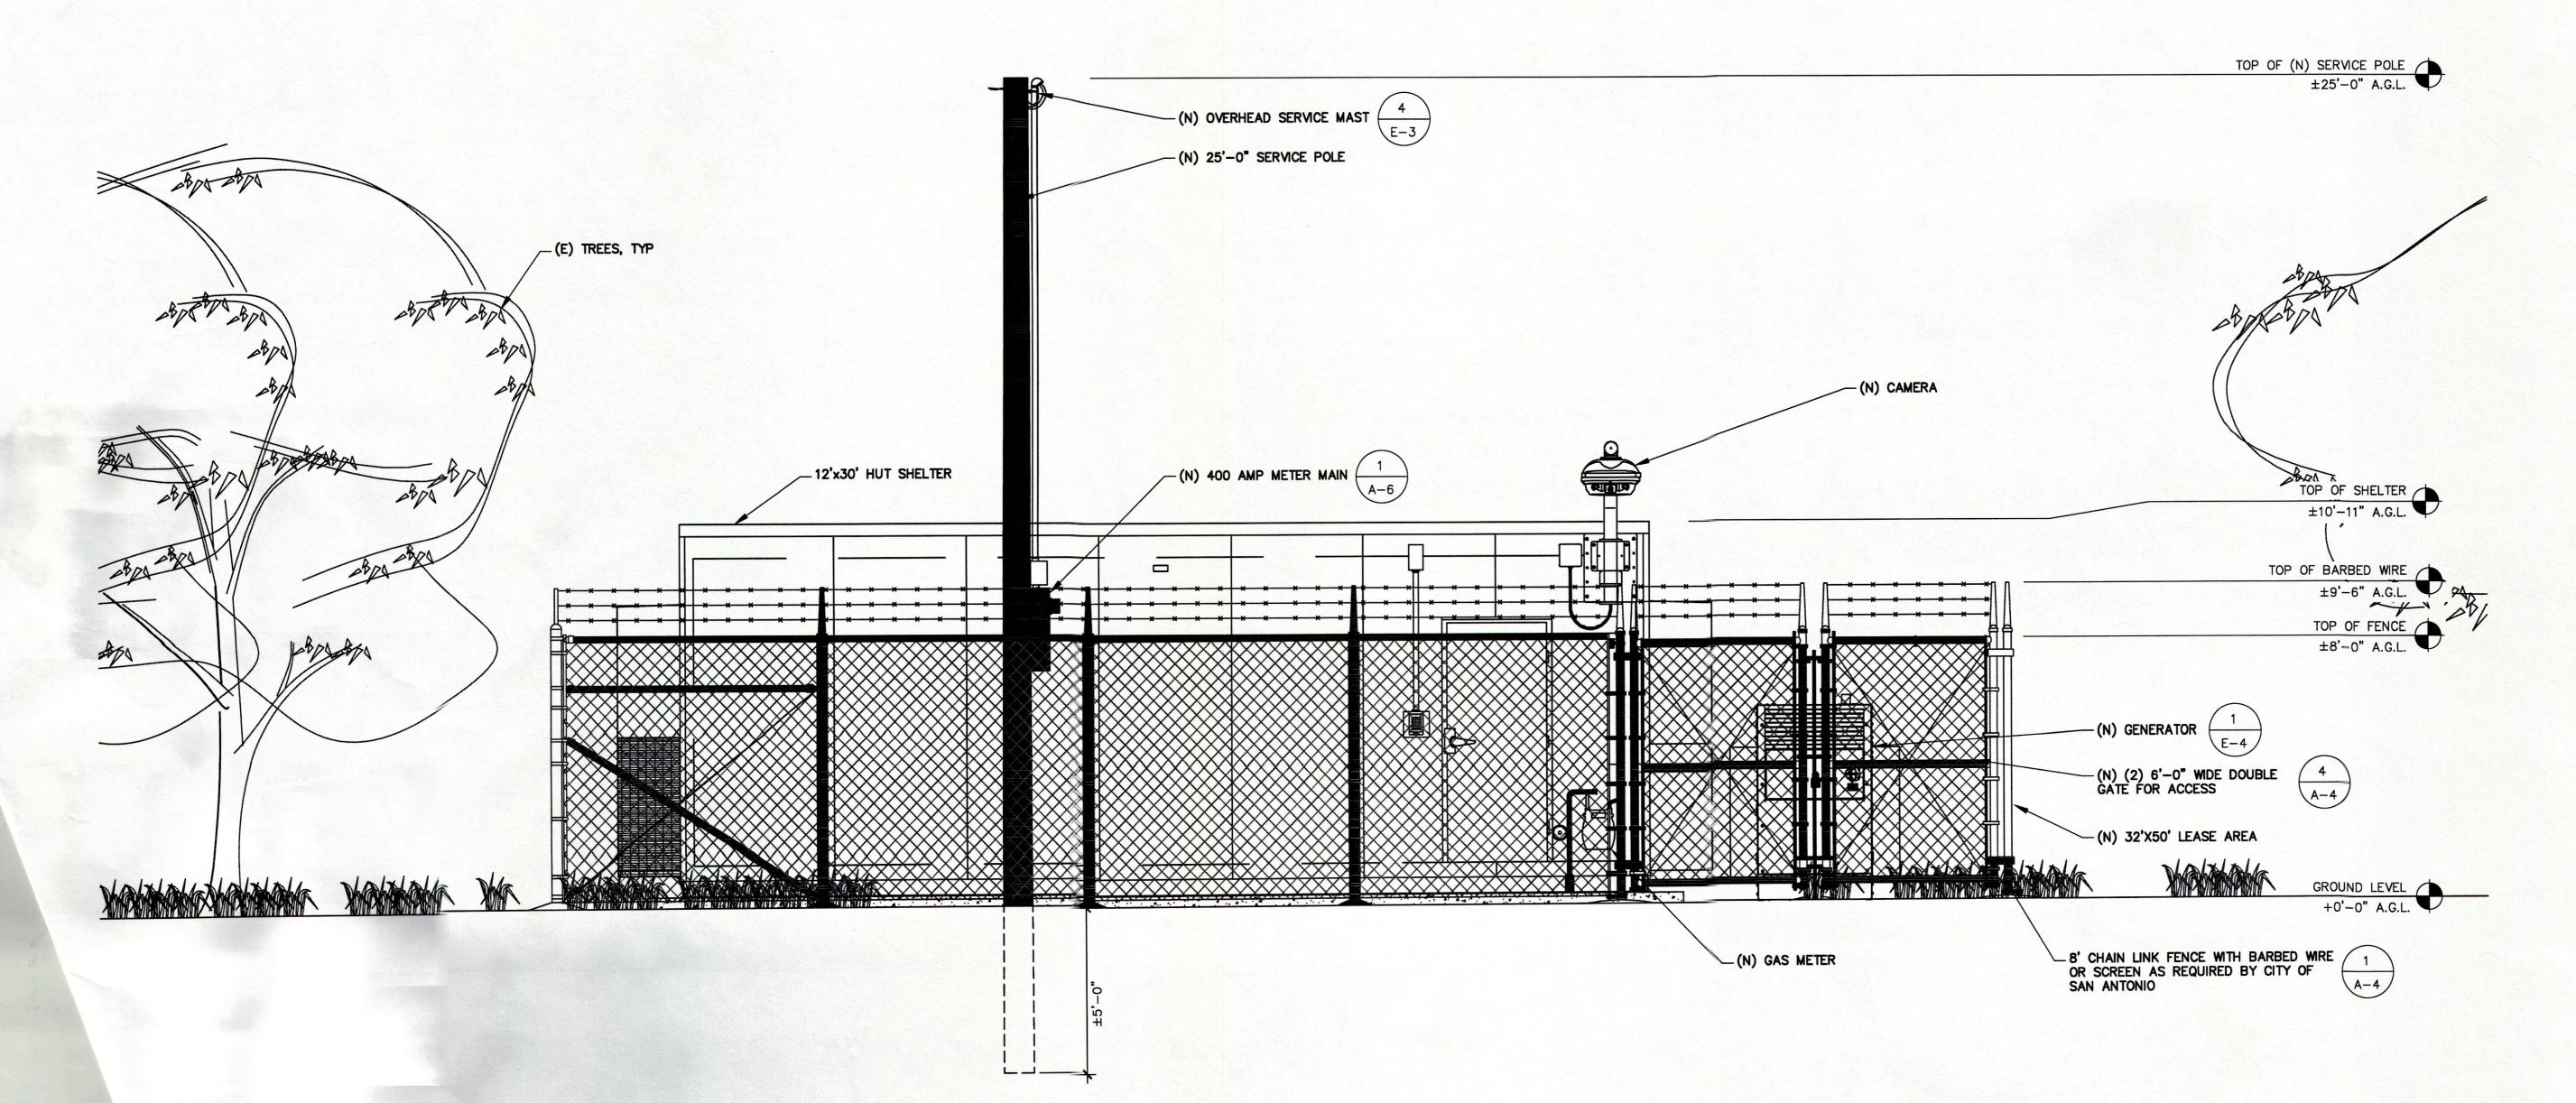

PREPARED FOR:

Gfiber

1220 CHARLESTON ROAD MOUNTAIN VIEW, CA 94043

Vendor:

Architect:




4780 CHABOT DRIVE, SUITE 104 PLEASANTON, CA 94588 Phone: (925) 398-6000

HUT ID: PARENT
PROJECT NO:
DRAWN BY: JA
CHECKED BY: RK

Issued For:
CONSTRUCTION

S. F. May			
			35
	1.321		
1	09/30/15	100% ISSUED FOR REVIEW	SC
0	07/23/15	90% ISSUED FOR REVIEW	J
REV	DATE	DESCRIPTION	В

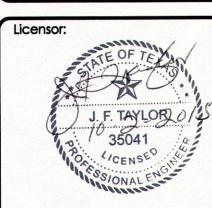

IT IS A VIOLATION OF LAW FOR ANY PERSON, UNLESS THEY ARE ACTING UNDER THE DIRECTION OF A LICENSED PROFESSIONAL ENGINEER, TO ALTER THIS DOCUMENT

Project info:

GFI HUT PARENT DRAWINGS SAN ANTONIO, TEXAS, BEXAR COUNTY

SHEET TITLE:

PROPOSED FRONT HUT ELEVATION

SHEET NUMBER:

SCALE: 3/8" = 1'-0"

A-3.1

FRONT HUT ELEVATION

TOP OF (N) SERVICE POLE ±25'-0" -(N) 25'-0" SERVICE POLE (BY OTHERS) TOP OF SHELTER ±10'-11" A.G.L. TOP OF BARBED WIRE ±9'-6" A.G.L. TOP OF FENCE ±8'-0" A.G.L. -(N) 400 AMP METER MAIN -(N) 32'X50' LEASE AREA

NOTE:
PUBLIC UTILITIES— BOTH ELECTRICAL AND
NATURAL GAS MAY REQUIRE SEPARATE
ROUTING AND/OR EASEMENT DEPENDING
ON POC

PREPARED FOR:

1220 CHARLESTON ROAD MOUNTAIN VIEW, CA 94043




4780 CHABOT DRIVE, SUITE 104 PLEASANTON, CA 94588 Phone: (925) 398-6000

PARENT HUT ID: PROJECT NO: DRAWN BY: JA CHECKED BY: RK

CONSTRUCTION

1 09/30/15 100% ISSUED FOR REVIEW 0 07/23/15 90% ISSUED FOR REVIEW REV DATE DESCRIPTION

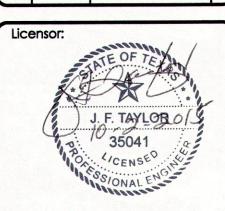

IT IS A VIOLATION OF LAW FOR ANY PERSON, UNLESS THEY ARE ACTING UNDER THE DIRECTION OF A LICENSED PROFESSIONAL ENGINEER, TO ALTER THIS DOCUMENT

GFI HUT PARENT **DRAWINGS**


SAN ANTONIO, TEXAS, BEXAR COUNTY


SHEET TITLE:

PROPOSED LEFT **HUT ELEVATION**

SHEET NUMBER:

A-3

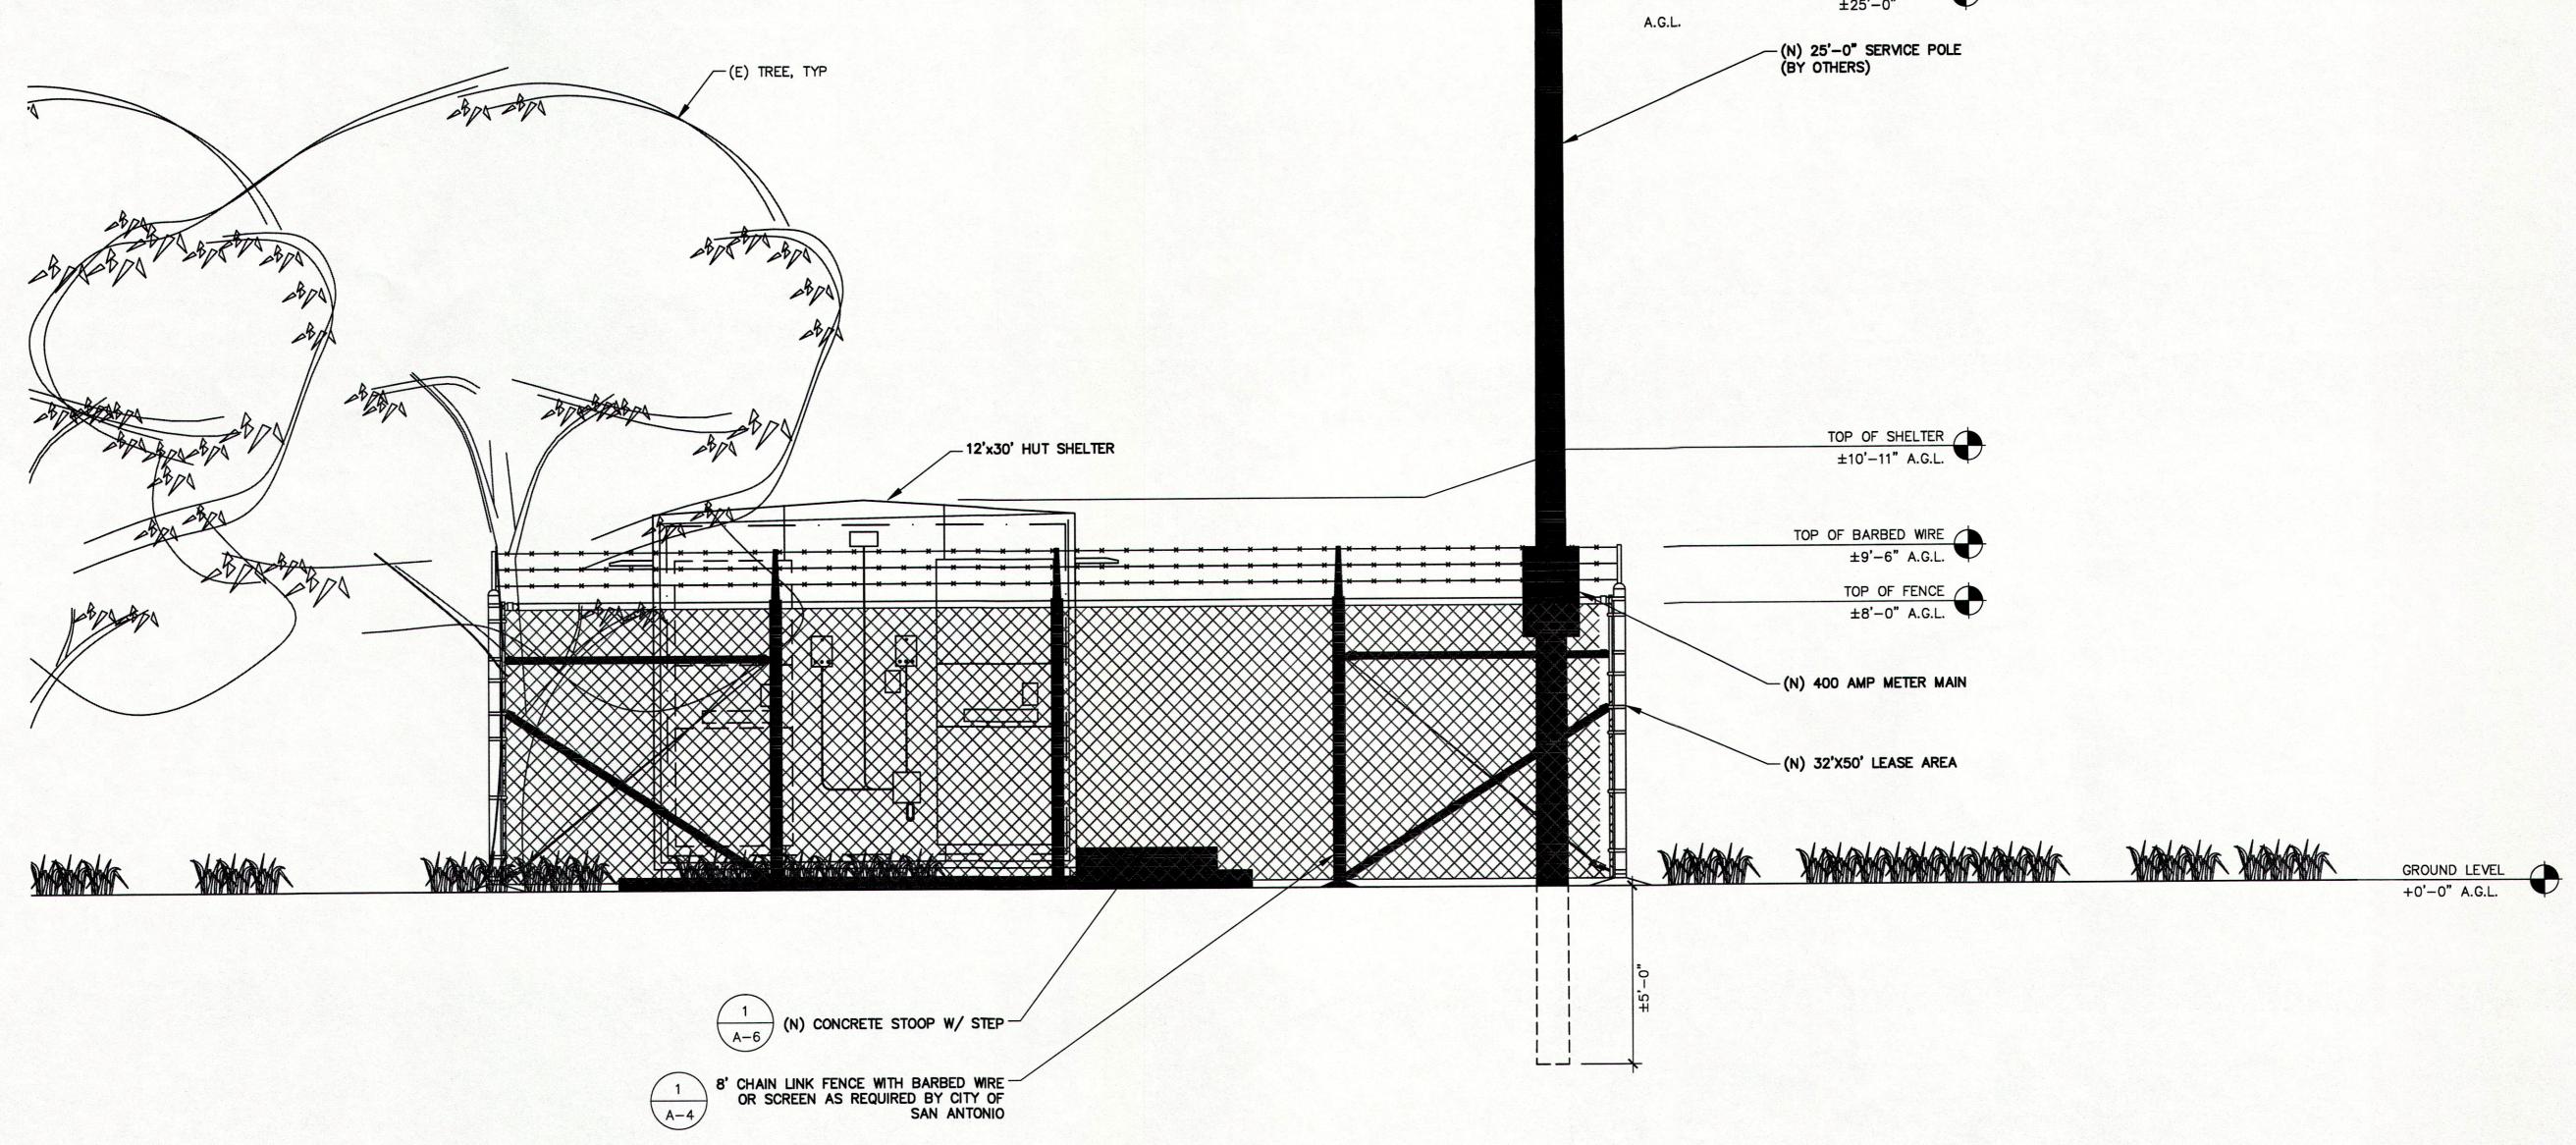

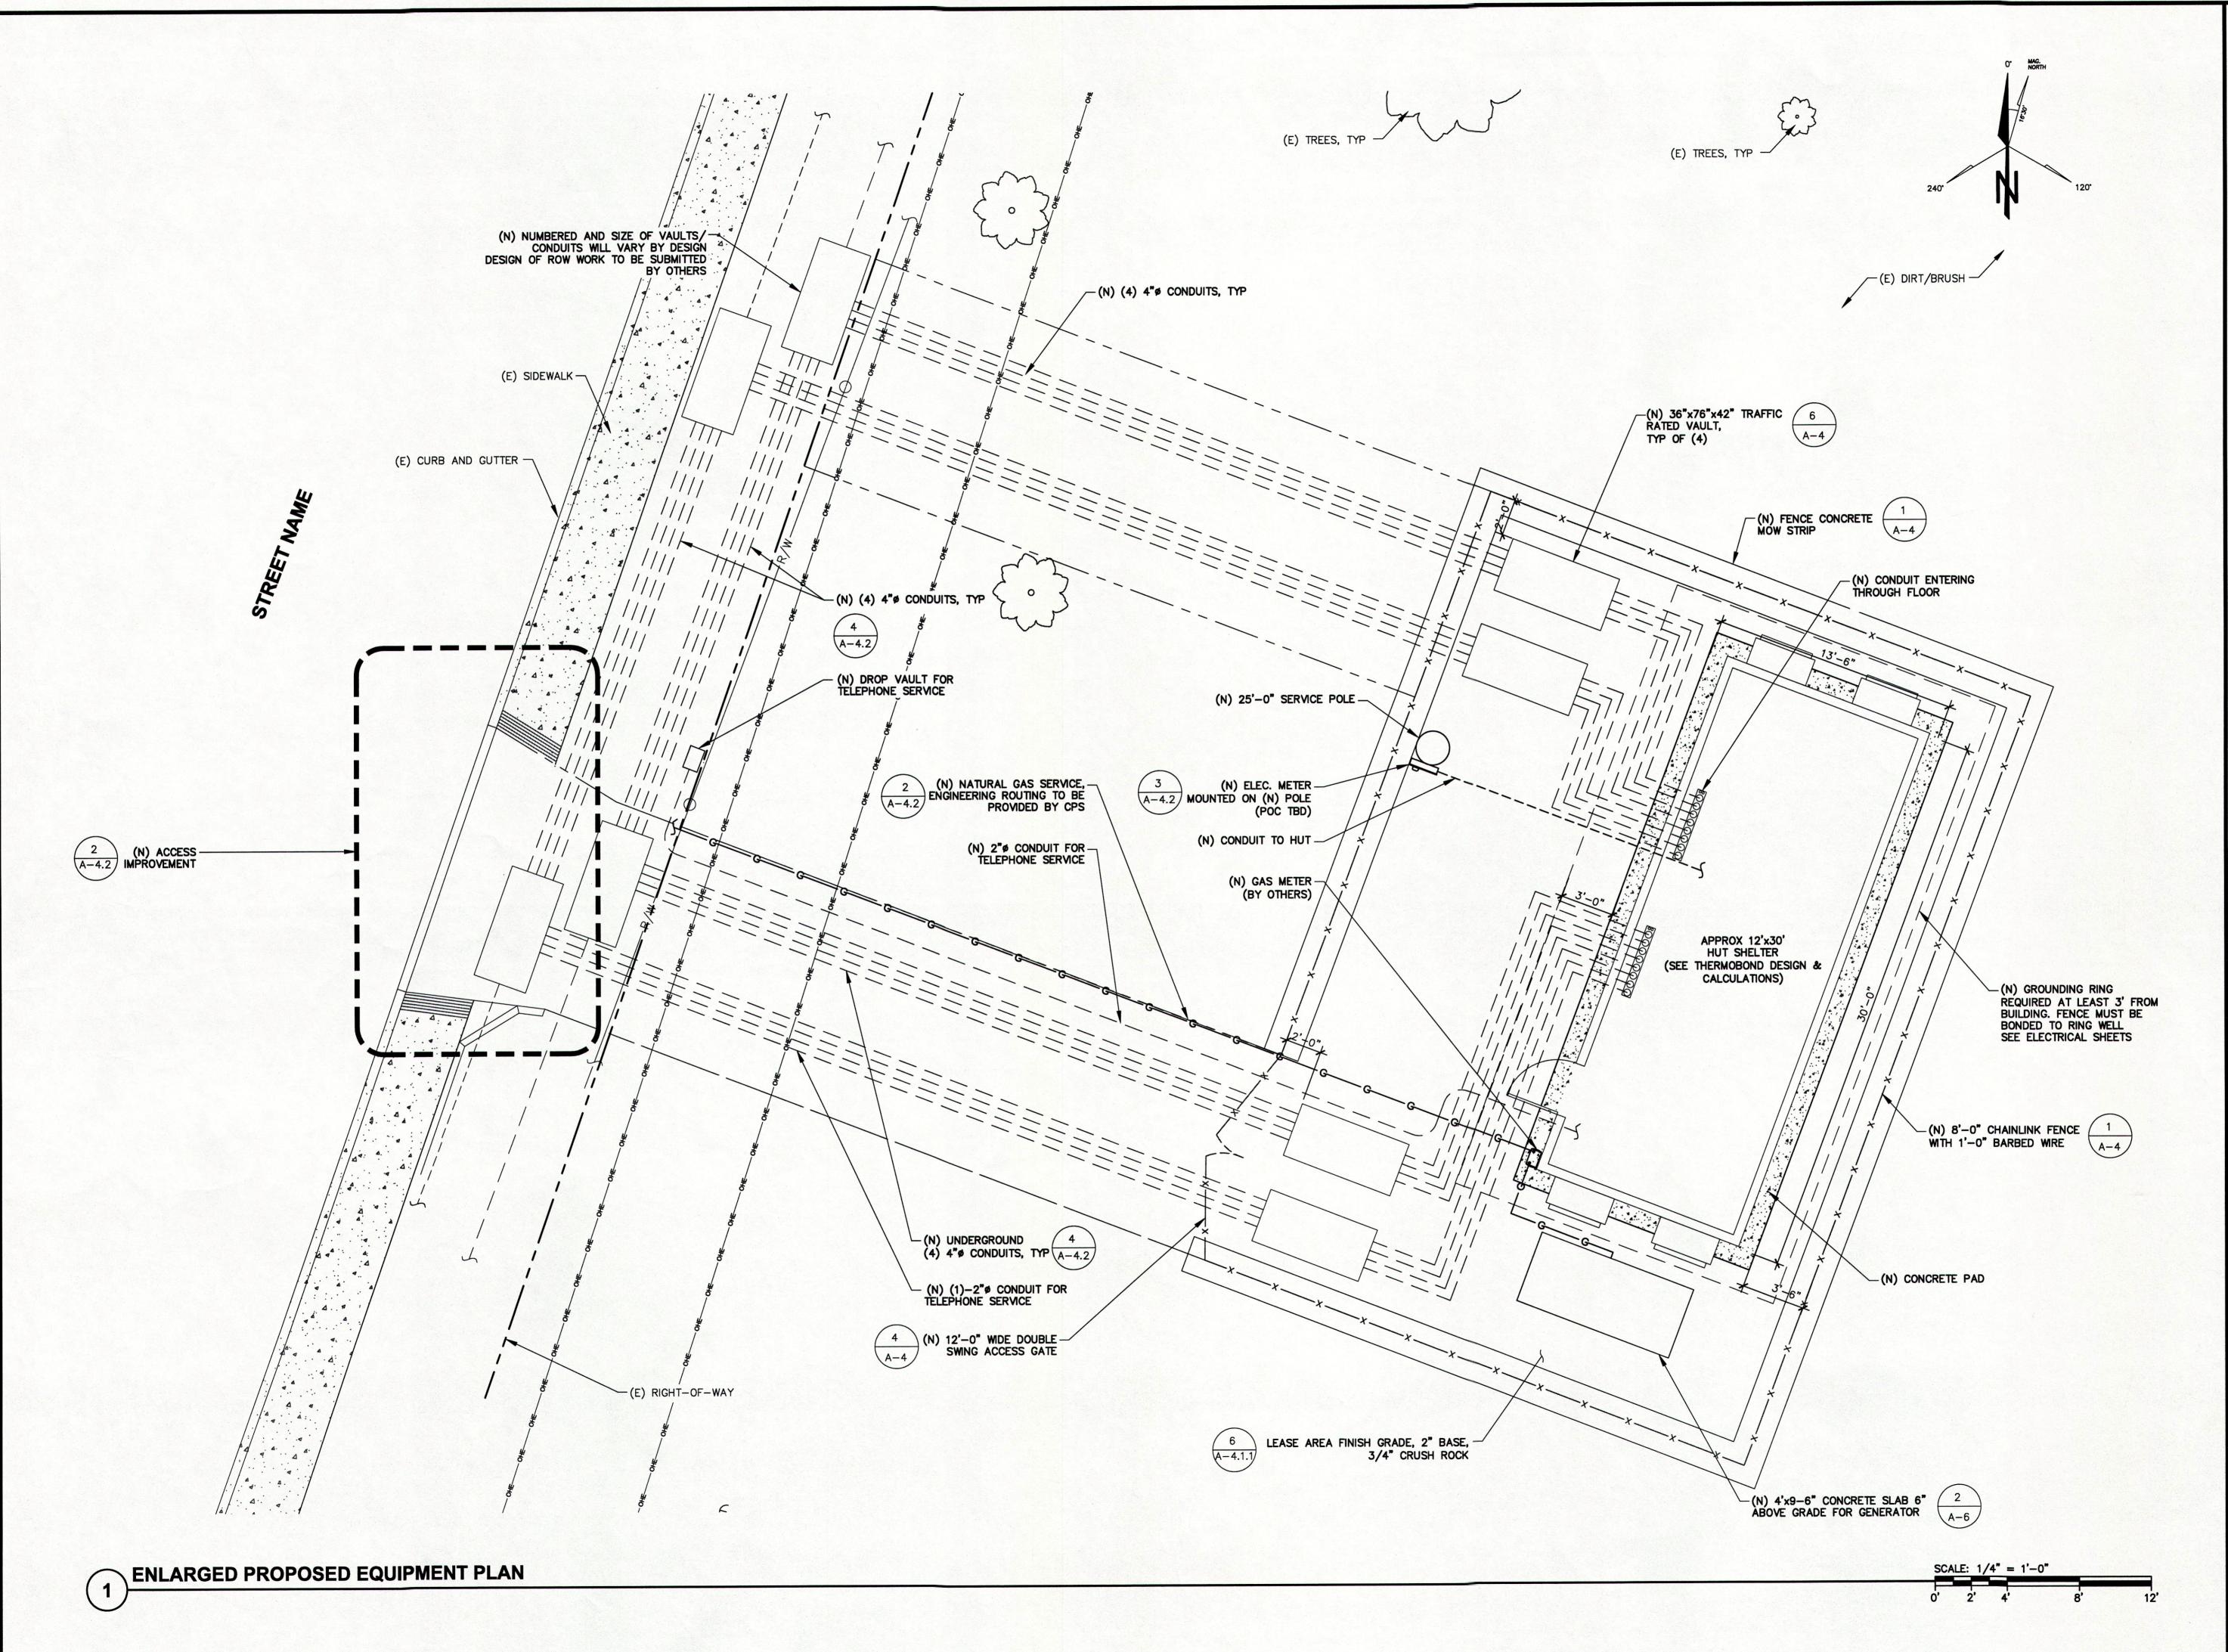


PREPARED FOR:

Gfibe

1220 CHARLESTON ROAD MOUNTAIN VIEW, CA 94043

Vendor:

Architect:

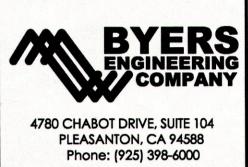

HUT ID: PARENT

PROJECT NO:


DRAWN BY: JA

CHECKED BY: RK

ued For:

1 09/30/15 100% ISSUED FOR REVIEW SG
0 07/23/15 90% ISSUED FOR REVIEW JA
REV DATE DESCRIPTION BY

J.5 TAYLOR 35041

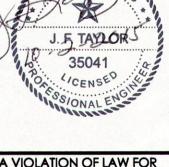

IT IS A VIOLATION OF LAW FOR ANY PERSON, UNLESS THEY ARE ACTING UNDER THE DIRECTION OF A LICENSED PROFESSIONAL ENGINEER, TO ALTER THIS DOCUMENT

Project info:

GFI HUT PARENT DRAWINGS SAN ANTONIO, TEXAS,

BEXAR COUNTY

HEET TITLE:
ENLARGED
PROPOSED
EQUIPMENT PLAN

SHEET NUMBER:

A-2

300 HASKIN DRIVE SAN ANTONIO, TX 78209

JURISDICTION: CITY OF SAN ANTONIO

LATITUDE: 29°-29'-51.15" N

LONGITUDE: 98°-26'-44.41" W

PREPARED FOR:

Gfiber

1220 CHARLESTON ROAD MOUNTAIN VIEW, CA 94043




HUT ID:

PROJECT DESCRIPTION	PROJECT INFORMATION PROJECT TEAM		PROJECT INFORMATION		TEAM		SHEET INDEX	REV
MODIFICATION OF UNMANNED TELECOMMUNICATIONS FACILITY. 1) INSTALLATION OF STATE OF TEXAS APPROVED 12" X 30' X 9' HUT IN PRESCRIBED LEASE AREA. INCLUDES ALL CIVIL CONCRETE WORK, FENCING, LANDSCAPING (IF REQUIRED). 2) INSTALLATION OF UTILITY SUB STRUCTURE INCLUDING, BUT NOT LIMITED TO; UNDERGROUND CONDUIT AND/OR OWNER OWNED UTILITY POLE. 3) INSTALLATION OF BACK—UP GENERATOR ON CONCRETE PAD ADJACENT TO FIBER HUT GENERATOR TO BE FUELED BY NATURAL GAS.	PROPERTY INFORMATION: SITE NAME: HUT ID 108 SITE ADDRESS: 300 HASKIN DRIVE SAN ANTONIO, TX 78209 CURRENT USE: TELECOMMUNICATIONS FACILITY PROPOSED USE: TELECOMMUNICATIONS FACILITY JURISDICTION: CITY OF SAN ANTONIO LATITUDE: 29°-29'-51.15" N LONGITUDE: 98°-26"-44.41" W GROUND ELEVATION: 763 FT (ASL)	PROPERTY OWNER: CITY OF SAN ANTONIO 1901 SAN ANTONIO, TX 78283-3966 (210)-207-6000 POWER AGENCY: CPS ENERGY P.O. BOX 2678 SAN ANTONIO, TX 78289-0001 (800)-773-3077	APPLICANT/LESSEE: BYERS ENGINEERING COMPANY 4780 CHABOT DR. SUITE 104 PLEASANTON, CA 94588 CONTACT: RONALD KELLER PH: (925) 398-6013 EMAIL: ron.keller@byers.com SITE ACQUISITION MANAGER: BYERS ENGINEERING COMPANY 4780 CHABOT DR. SUITE 104 PLEASANTON, CA 94588 CONTACT: RONALD KELLER PH: (925) 398-6013 EMAIL: ron.keller@byers.com ZONING: BYERS ENGINEERING COMPANY 4780 CHABOT DR. SUITE 104 PLEASANTON, CA 94588 CONTACT: RONALD KELLER PH: (925) 398-6013 EMAIL: ron.keller@byers.com CONSTRUCTION: ERVIN CABLE CONSTRUCTION, LLC, 450 PRYOR BLVD., P.O. BOX 10, STURGIS, KY 42459	ARCHITECT: BYERS ENGINEERING COMPANY 4780 CHABOT DRIVE STE. 104 PLEASANTON, CA 94588 CONTACT: SEAN RANDALL PH: (925) 785-7431 EMAIL: Sean.Randall@Byers.com	T-1 C-1 A-1 A-1.1 CVL-1 CVL-2	TITLE SHEET SURVEY SHEET OVERALL SITE PLAN ENLARGED SITE PLAN GRADING, DRAINAGE & EROSION CONTROL SITE PLAN GRADING, DRAINAGE & EROSION CONTROL SITE PLAN		

DRAWN BY: JA CHECKED BY: NHP CONSTRUCTION

1 09/23/15 100% ISSUED FOR REVIEW SC 0 07/23/15 90% ISSUED FOR REVIEW J REV DATE DESCRIPTION

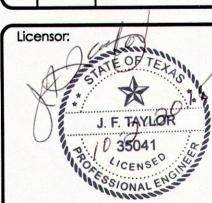

IT IS A VIOLATION OF LAW FOR ANY PERSON, UNLESS THEY ARE ACTING UNDER THE DIRECTION OF A LICENSED PROFESSIONAL ENGINEER, TO ALTER THIS DOCUMENT

HUT ID: 108

300 HASKIN DRIVE SAN ANTONIO, TX 78209 BEXAR COUNTY

SHEET TITLE:

TITLE SHEET

SHEET NUMBER:

CODE COMPLIANCE

ALL WORK AND MATERIALS SHALL BE PERFORMED AND INSTALLED IN ACCORDANCE WITH THE CURRENT EDITIONS OF THE FOLLOWING CODES AS ADOPTED BY THE LOCAL GOVERNING AUTHORITIES. NOTHING IN THESE PLANS IS TO BE CONSTRUED TO PERMIT WORK NOT CONFORMING TO THESE CODES.

- 1) 2015 INTERNATIONAL BUILDING CODE
- 2) 2015 INTERNATIONAL RESIDENTIAL CODE
- 3) 2015 INTERNATIONAL EXISTING BUILDING CODE
- 4) 2015 INTERNATIONAL MECHANICAL CODE 5) 2015 INTERNATIONAL PLUMBING CODE
- 6) 2015 INTERNATIONAL FUEL GAS CODE
- 7) 2015 INTERNATIONAL FIRE CODE
- 8) 2015 INTERNATIONAL ENERGY CONSERVATION CODES
- 9) 2014 NATIONAL ELECTRIC CODE

\$	i i i i i i i i i i i i i i i i i i i	
The state of the s		
	, o 1	
I Committee		
 SITE		
	00	

OCCUPANCY: S-2 (UNMANNED)

203.5-ELECTRICAL EQUIPMENT ROOM

2012 TEXAS ACCESSIBILITY STANDARDS TEXAS EXEMPTION PER SECTION

CONSTRUCTION TYPE: IIB

VICINITY MAP

DIRECTIONS FROM OFFICE AT , 9606 NORTH MOPAC EXPRESSWAY, AUSTIN, TX 78759 0.3 MI 86 FT

DIRECTIONS FROM GOOGLE

GET ON TX-1 LOOP S 0.3 MI HEAD SOUTH ON MOPAC SERVICE RD 86 FT SLIGHT LEFT ONTO THE TEXAS 1 LOOP S RAMP 0.2 MI FOLLOW TX-1 LOOP S, I-35 S AND I-410 W TO I- 410 ACCESS RD/NW LOOP 410 IN SAN ANTONIO. TAKE EXIT 11 FROM I-410 W 93.8 MI MERGE ONTO TX-1 LOOP S 10.6 MI TAKE THE TEXAS 360 LOOP S/CAPITAL OF TX HWY EXIT ON THE LEFT .4 MI MERGE ONTO TX-360 LOOP S 0.5 MI TAKE THE U.S. 290 E/TEXAS 71 E RAMP ON THE LEFT TO BASTROP 0.6 MI MERGE ONTO TX-71 E/US-290 E 2.2 MI

TAKE THE INTERSTATE 35 N EXIT TOWARD U.S. 290 E/WACO 0.5 MI KEEP RIGHT AT THE FORK AND MERGE ONTO 1-35 S 64.1 MI TAKE EXIT 166 FOR INTERSTATE 410 W/TEXAS 368 LOOP S 0.4 MI KEEP RIGHT TO CONTINUE ON EXIST 26, FOLLOW SIGNS FOR TX-368 LOOP

SPECIAL INSPECTIONS

CONTINUE ONTO TX-368 LOOP S SLIGHT RIGHT ONTO EISENHAUER ROAD TURN RIGHT ONTO HASKIN DRIVE

DO NOT SCALE DRAWINGS

APPROVED BY:

GOOGLE:

ZONING:

POWER:

CONSTRUCTION:

LEASING / LANDLORD:

93.8 MI

10.6 MI

0.4 MI

0.5 MI

0.6 MI

2.2 MI

0.5 MI

64.1 MI

0.4 MI

0.3 MI

0.7 MI

1.9 MI

1.1 MI

0.3 MI

3.2

THESE DRAWINGS ARE FORMATTED TO BE FULL SIZE AT 24" x 36". CONTRACTOR SHALL VERIFY ALL PLANS AND EXISTING DIMENSIONS AND CONDITIONS ON THE JOBSITE AND SHALL IMMEDIATELY NOTIFY THE ARCHITECT/ENGINEER IN WRITING OF ANY DISCREPANCIES BEFORE PROCEEDING WITH THE WORK OR MATERIAL ORDERS OR BE RESPONSIBLE FOR THE SAME.

GENERAL CONTRACTOR NOTES

APPROVALS

SIGNATURE

Know what's below. Call before you dig.

DATE:

-	
Drawings\Hut Site108 T-1.dwg,	
2	
D	
-	
-	
~	
\approx	
=	
(D)	
#3	
72	
=	
=	
_	
To	
Ö	
_	
.2	
≥	
ĺ	
$\overline{}$	
_	
D	
=	
£	
Q	
10	
T.	
=	
ш	
0	
9	
U	
-	
0	
-	
5	
0	
-	
18-OLD 105\07 CAD Files\Child Dra	1
-	3
$\overline{}$	
Y	
œ	
~	