HISTORIC AND DESIGN REVIEW COMMISSION

February 01, 2017 Agenda Item No: 2

HDRC CASE NO: 2017-040

ADDRESS: 800 E GUENTHER ST **LEGAL DESCRIPTION:** NCB 2916 BLK 5 LOT 1

ZONING: RM-4,H

CITY COUNCIL DIST.: 1

DISTRICT: King William Historic District

APPLICANT: Ralph Laborde

OWNER: Ralph & Kathleen Laborde
TYPE OF WORK: Historic Tax Certification

REQUEST:

The applicant is requesting Historic Tax Certification for the property at 800 E Guenther.

APPLICABLE CITATIONS:

UDC Section 35-618. Tax Exemption Qualifications:

- (a) Assessed Valuation. In accordance with the provisions of this article, a building, site, or structure which meets the definition of a historically significant site in need of tax relief to encourage preservation and which is substantially rehabilitated and/or restored as certified by the historic and design review commission and approved by the city tax assessor-collector, shall have an assessed value for ad valorem taxation as follows regardless of ownership during the granted time period:
- (1) A residential property shall have the assessed value for ad valorem taxation for a period of ten (10) tax years equal to the assessed value prior to preservation.
- (b) Applicability. This exemption shall begin on the first day of the first tax year after verification of completion of the preservation required for certification; provided the building shall comply with the applicable zoning regulations for its use and location.
- (c) Application. Application for a historic structure preservation tax exemption pursuant to this division is to be filed with the office of historic preservation. The historic preservation officer shall be the agent of the city for the purposes of administering this division provided that the historic preservation officer request a recommendation from the historic and design review commission. Each application shall be signed and sworn to by the owner of the property and shall:
 - (1) State the legal description of the property proposed for certification;
 - (2) Include an affidavit by the owner describing the historic significance of the structure in need of tax relief;
 - (3) Include a final complete set of plans for the historic structure's restoration or rehabilitation;
 - (4) Include a statement of costs for the restoration or rehabilitation work;
 - (5) Include a projection of the estimated construction, time and predicted completion date of the historic restoration or rehabilitation;
 - (6) Authorize the members of the historic and design review commission, the city tax assessor-collector and city officials to visit and inspect the property proposed for certification and the records and books of the owners as necessary to certify that the property in question is in substantial need of restoration or rehabilitation;
 - (7) Include a detailed statement of the proposed use for the property; and
 - (8) Provide any additional information to the historic and design review commission which the owner deems relevant or useful such as the history of the structure or access to the structure by the public.

Each application shall contain sufficient documentation confirming or supporting the information submitted therein.

(d) Certification.

- (1) Historic and Design Review Commission Certification. Upon receipt of the owner's sworn application the historic and design review commission shall make an investigation of the property and shall certify the facts to the city tax assessor-collector within thirty (30) days along with the historic and design review commission's documentation for recommendation of either approval or disapproval of the application for exemption.
- (2) Tax Assessor-Collector Approval. Upon receipt of the certified application for tax exemption as well as the recommendation of the historic and design review commission, the city's tax assessor-collector shall within thirty (30) days approve or disapprove eligibility of the property for tax relief pursuant to this division. In determining eligibility, the tax assessor-collector shall first determine that all the requirements of this division have been complied with and that only the historic structure and the land reasonably necessary for access and use thereof is to be provided favorable tax relief.
- (g) Eligibility.
- (1) The tax exemption options outlined in subsection (f), above, will remain in effect unless terminated by designation status being removed pursuant to subsection 35-606(g) of this article.

FINDINGS:

- a. The applicant is requesting Historic Tax Certification for the property at 800 E Guenther, in the King William Historic District.
- b. At the August 3, 2016, HDRC hearing, the applicant received an HDRC Certificate of Appropriateness to rehabilitate the primary historic structure as well as to construct a rear addition, remove non-original additions to the primary historic structure and accessory structure and rehabilitate the rear accessory structure.
- c. The requirements for Historic Tax Certification outlined in UDC Section 25-618 have been met and the applicant has provided evidence to that effect to the Historic Preservation Officer including photographs and an itemized list of costs.

RECOMMENDATION:

Staff recommends approval based on findings a through c.

CASE MANAGER:

Edward Hall





Flex Viewer

Powered by ArcGIS Server

Printed:Jun 07, 2016

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LABORDE RESIDENCE

800 E GUENTHER ST, SAN ANTONIO, TX 78210

SITE SURVEY

800 E. GUENTHER SAN ANTONIO, TX 78210 SITE PLAN

GENERAL NOTES & INSTRUCTIONS

GENERAL NOTES:

1. THE INTENT OF THE DRAWINGS AND SPECIFICATIONS IS TO PROVIDE FOR A WATERTIGHT AND WEATHER TIGHT BUILDING. THE CONTRACTOR SHALL REVIEW ALL DETAILS RELATING TO THIS INTENT AND BY ENTERING INTO THIS CONSTRUCTION CONTRACT WARRANTS FOR ONE FULL YEAR THE ADEQUACY OF THESE DETAILS.

. THE INTENT OF THE DRAWING IS TO PROVIDE FOR A PLUMB, LEVEL AND SQUARE STRUCTURE UNLESS OTHERWISE NOTED.

THE BUILDING SHALL BE CONSTRUCTED IN FULL COMPLIANCE WITH CURRENT TERNATIONAL RESIDENTIAL BUILDING CODE AND ALL OTHER APPLICABLE CODES, RDINANCES AND REGULATIONS AS WELL AS THE DRAWINGS AND SPECIFICATIONS.

4. THE CONTRACTOR SHALL BE RESPONSIBLE FOR THE ACCURATE PLACEMENT OF THE BUILDING ON THE SITE AND SHALL VERIFY ALL DIMENSIONS AND EXISTING CONDITIONS. THE OWNER SHALL NOT BE RESPONSIBLE FOR CHANGES TO THE WORK DUE TO THE FAILURE OF THE CONTRACTOR TO FAMILIARIZE HIMSELF OR HERSELF WITH EXISTING CONDITIONS, DRAWINGS AND SPECIFICATIONS.

. DO NOT SCALE THE DRAWINGS. ALL DIMENSIONS SHALL HAVE PREFERENCE OVER SCALE ND SHOULD BE FIELD VERIFIED AND COORDINATED WITH WORK OF ALL TRADES.

DETAILS ARE MEANT TO SHOW METHOD AND MANNER OF ACCOMPLISHING WORK. MINOR IDDIFICATIONS MAY BE REQUIRED TO SUIT JOB DIMENSIONS OR CONDITIONS, ALL

8. THE CONTRACTOR SHALL VERIFY ALL SIZES AND LOCATIONS OF ALL MECHANICAL AND ELECTRICAL PADS AND PANELS AS WELL AS POWER, WATER, AND DRAIN REQUIREMENTS FOR SUCH EQUIPMENT AND EQUIPMENT MANUFACTURERS.

ALL WIDTHS ARE SHOWN AND DIMENSIONED WITH NOMINAL DIMENSIONS (I.E. 6" = 5 1/2"). ID, ELECTRICAL WORK SHALL BE DONE IN ACCORDANCE WITH THE NATIONAL ELECTRICAL

. CONTRACTOR TO PROVIDE DUMPSTER AND TEMPORARY TOILET. SITE SHOULD BE LEANED REGULARLY.

IZ. ALL DIMENSIONS ARE TO FACE OF STUD OR WALL FACE UNLESS OTHERWISE NOTED. 3. INTERIOR WALLS TO BE 2X4 WOOD STUDS AT 16" O.C., UNLESS OTHERWISE NOTED FOR

4. EXTERIOR WALLS TO BE 2X4 WOOD STUDS AT 16" O.C., UNLESS OTHERWISE NOTED

5. ALL RESIDENTIAL STRUCTURES SHALL USE 5/8" TYPE X SHEETROCK FOR ALL NEW TRUCTURE AND WHERE GREATER THAN 50% OF A WALL SURFACE IS REMOVED. CONCRETE OARD OR HARDIS BACKER TYPE MATERIAL AT ALL "WET ARAS". USE CEMENT BACKER OARD AT ALL TILED WALLS. OR FULL SET MORTAR BACKING AT TILED WALLS.

16. ELECTRICAL AND HVAC INSTALLER TO COORDINATE THEIR WORK.

17. A/C PLAN TO BE PROVIDED BY CONTRACTOR AND COORDINATED WITH ARCHITECT AND OTHER TRADES, MAIN SUPPLY TRUNK LINES TO BE RIGID FIBERGLASS BOARD, SECONDARY LINES CAN BE INSULATED FLEX DUCT, UNITS TO BE MINIMUM 16 SEER, HEAT PUMP UNITS BY LENOX OR EQUAL, ALL WORK TO BE IN ACCORDANCE TO CURRENT BUILDING CODES. TE FOR HIGH EFFICIENCY VARIABLE SPEED ZONED SYSTEM WITH AXIMUM EFFICIENCY FILTERING SYSTEM

19. FULL ICYNENE OR EQUAL INSULATION AT SLOPED ROOFS AND EXTERIOR WALLS, PROVIDE FULL BATT INSULATION AT ALL BATHROOM WALLS, ALL BEDROOM WALLS, AND HEREVER ACOUSTICAL PRIVACY IS NEEDED.

22. EXTERIOR WALL SHEATHING \(\frac{1}{2}\) PLYWOOD OR ORIENTED STRAND BOARD WRAPPED WITH TYVEK EXTERIOR WATER RESISTANT BARRIER, SEE PROJECT MANUAL FOR CORRECT INSTALLATION OF TYVEK.

23. FOR WATER DISTRIBUTION PIPING ONLY TYPE L SHALL BE USED. TYPE M COPPER, CPVC & PEX NOT ALLOWED.

24. INTERIOR WALLS TO BE LIGHT TEXTURE FINISH WITH 3 COATS PAINT (SATIN). INTERIOR TRIM TO BE PREPARED FOR PAINTING - 3 COATS PAINT (SEMI-GLOSS) INTERIOR TRIM - ALL INTERIOR TRIM TO BE PAINTED WOOD.

25. ALL PLYWOOD AND HARDWOODS AT CABINETS AND SHELVING TO BE "PREMIUM GRADE" AND TO BE FORMALDEHYDE FREE.

26. PROVIDE SEWER CLEANOUTS AS REQUIRED TO SERVICE ALL PLUMBING. VERIFY LOCATIONS WITH ARCHITECT/OWNER PRIOR TO INSTALLATION.

27. CONTRACTOR SHALL COMPLY WITH REQUIREMENTS FOR BACKFLOW PREVENTION DEVICES ON ALL INDIVIDUAL PIECES OF EQUIPMENT AS INDICATED IN TOEQ REGULATIONS.

29. CONTRACTOR SHALL INSTALL ARC FAULT CIRCUIT INTERRUPTION PROTECTION ON ALL

30. SMOKE DETECTORS ARE REQUIRED IN EACH BEDROOM ENTRY AND ADJOINING HALL CEILING. SMOKE DETECTORS SHALL BE ELECTRICALLY HARDWIRED WITH A BATTERY BACKUP, ALL SMOKE DETECTORS SHALL ALSO BE ELECTRICALLY INTERCONNECTED, SO THAT IF ONE GOES INTO ALARM. ALL GO INTO ALARM. DETECTORS SHALL MEET 2006 INTERNATIONAL RESIDENTIAL CODE SECTION 317.11.

31. COMPLIANCE WITH IRC R613.2 FOR WINDOW SILLS.

32. WATER RISER MUST BE METAL ABOVE GROUND, SCHEDULE 40 PVC MAY ONLY BE USED FOR EXTERIOR PIPING THAT IS UNDERGROUND.

33. ALL WALLS WITH DRAW-WASTE-VENT PLUMBING SHALL BE 2X6 LUMBER.

34. ATTIC ACCESS, MINIMUM OPENING 25.5" X 54", SHALL SUPPORT 350 LBS WITH 20

35. ALL MECHANICAL EQUIPMENT EXHAUST MUST TERMINATE ON THE EXTERIOR OF THE

36. ALUMINUM WIRING IS PROHIBITED AND 12/2 WITH GROUND IS THE SMALLEST CONDUCTOR SIZE ALLOWED.

37. NO GREEN/PURPLE ROCK FOR TUB/SHOWER ENCLOSURE

SITE AND PROF NOTES

I. IN ADDITION TO ANY FENCE REQUIREMENTS FOR TREE PROTECTION, ALL BUILDING
SITES ARE REQUIRED TO BE ENCLOSED WITH A TEMPORARY FENCE A MINIMUM OF 6 FEET.
THIS REQUIREMENT APPULES TO EACH SIDE, REAR AND 75% OF THE FROMT YARD DURING
CONSTRUCTION. REMOVAL OF THIS FENCE REQUIRES WRITTEN AUTHORIZATION FROM

3. RESTORE EXISTING LANDSCAPING TO ORIGINAL CONDITION AT THE END OF PROJECT.

4. LOCATE ALL ROOF VENTS FROM STREET VIEW WHERE POSSIBLE. PAINT TO MATCH


STANDARDS AND REGULATIONS

APPLICABLE STANDARDS OF CONSTRUCTION INDUSTRY AND BUILDING CODES HAVE THE SAME FORCE AND AFFECT ON PERFORMANCE OF THE WORK AS IF COPIED DIRECTLY INTO CONTRACT DOCUMENTS, GOVERNING REGULATIONS HAVE PRECEDENCE OVER NONREFERENCED STANDARDS, IN SO FAR AS DIFFERENT STANDARDS MAY CONTAIN OVERLAPPING OR CONFLICTING RECUIREMENTS, COMPLY WITH LOCAL BUILDING CODES AND INDUSTRY STANDARDS. CONTRACTOR IS RESPONSIBLE FOR COMPLIANCE TO THESE STANDARDS AND REGULATIONS AND FOR THE CONSTRUCTION PERMITS. THE INSTALLATION SHALL MEET THE MINIMUM STANDARD PRESCRIBED IN THE LATEST EDITION AND AMENDMENTS OF THE FOLLOWING STANDARDS. THIS PROLECT HAS BEEN DESIGNED IN ACCORDANCE WITH THE 2006 INTERNATIONAL CODES AND THE 2008 NEC.:


1. BUILDING CODES	2015 INTERNATIONAL RESIDENTIAL CODE
	2015 INTERNATIONAL BUILDING CODE
2. PLUMBING CODE	2015 UNIFORM PLUMBING CODE
3. MECHANICAL CODE	2015 INTERNATIONAL MECHANICAL CODE
4 FLECTRICAL CODE	2015 NATIONAL ELECTRICAL CODE

ALL MECHANICAL, ELECTRICAL, AND PLUMBING INDICATED ON DRAWINGS IS SIMPLY TO AID CONTRACTOR ON GENERAL LOCATIONS. THE CONTRACTOR IS RESPONSIBLE FOR ELECTRICAL, PLUMBING AND MECHANICAL SIZING, AND SHALL ADHERE TO THESE CODES.

LOCATION MAP

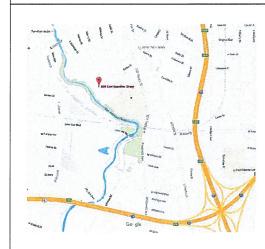

S 31'45'20" € 49,97' LOT 2 E. GUENTHER ST. NOTE: BEARINGS SHOWN HEREON ARE ASSUMED. EPARTY OF PEAR PLOED TOOK DECIMATION OF DISC PROPERTY WITH FRUIT, NO SEASON OF STREET, NO SEASON OF STREET, NOW AND SEASON FIRM PERSONATURE Westar Alamo

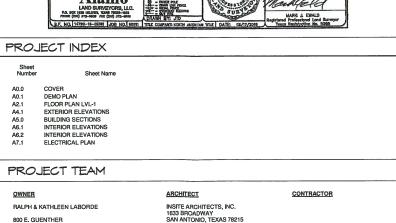

CONTACT: MIKE SCHROEDER

S 31°45'20" E 49.97 ₹SE EXISTING 1 STORY RESIDENCE N.C.B. 2916 LOT 1, BLOCK 5 5,766 SQ.FT 0.132 ACRES 曲 ARBE STREET (50' R.O.M.) 8'-6 E. GUENTHER STREET (55'6" R.O.M.) STEPLAN NEW
TRUE PLAN 1" = 10'-0"



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RESIDENCE **ATNONIO, TX 78210** GUENTHER LABORDE ш 800

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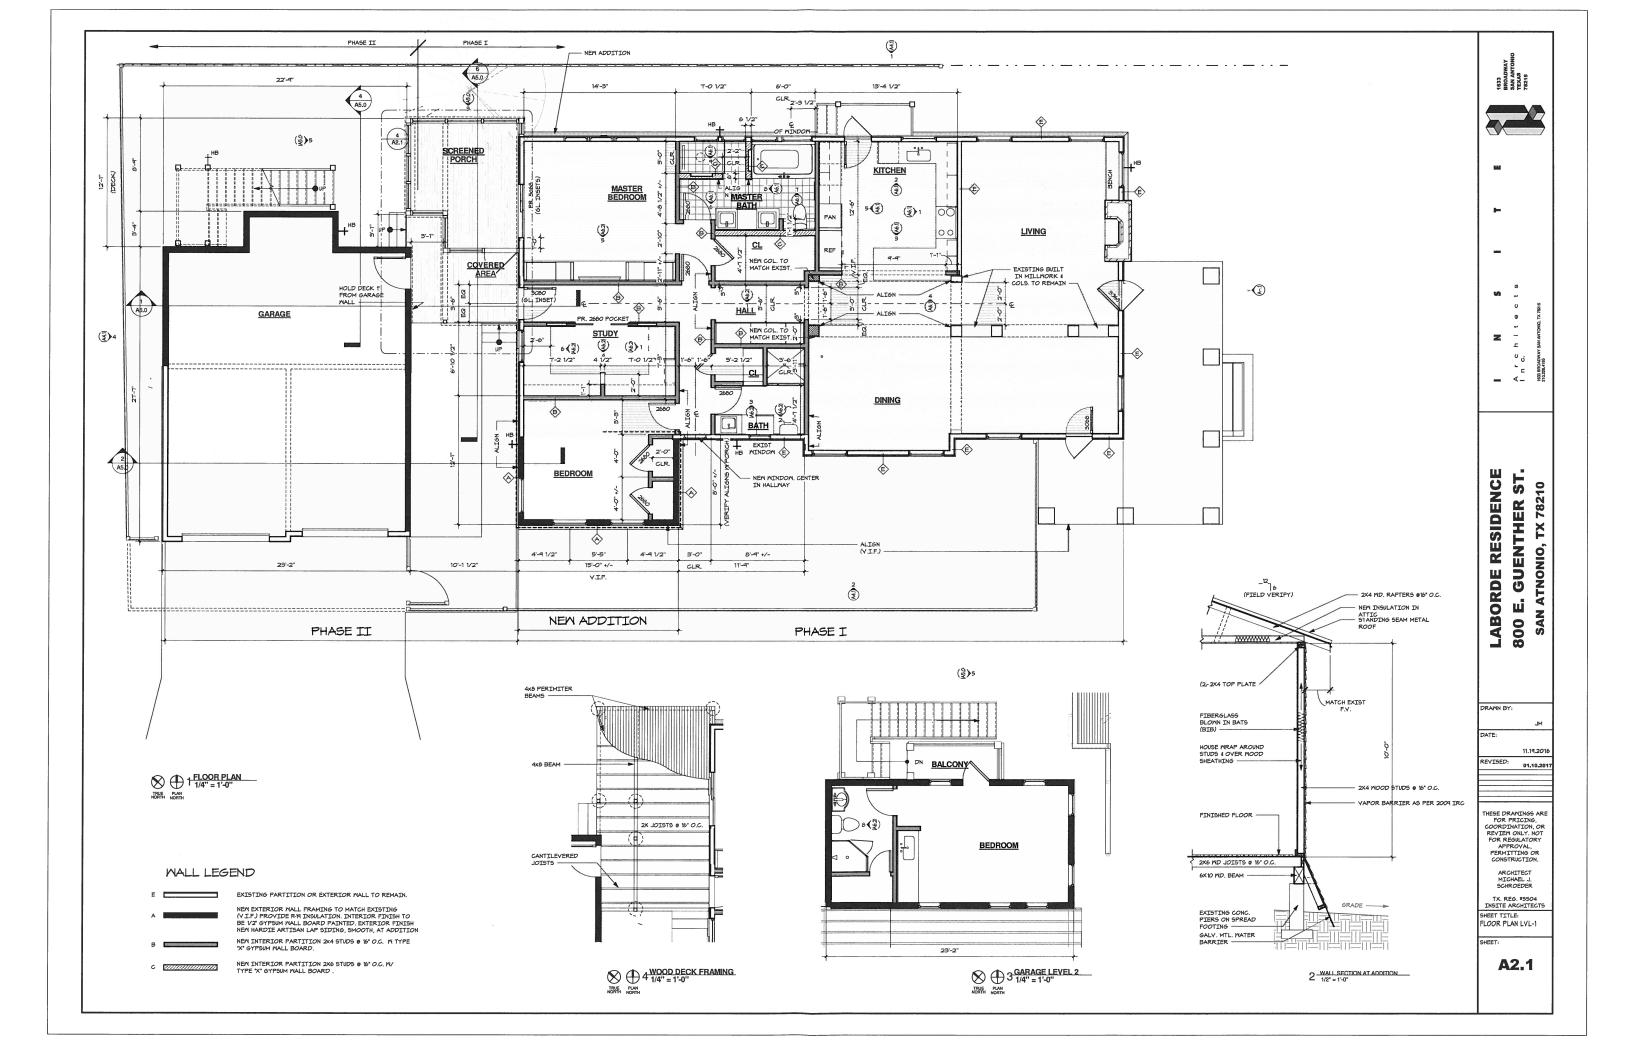
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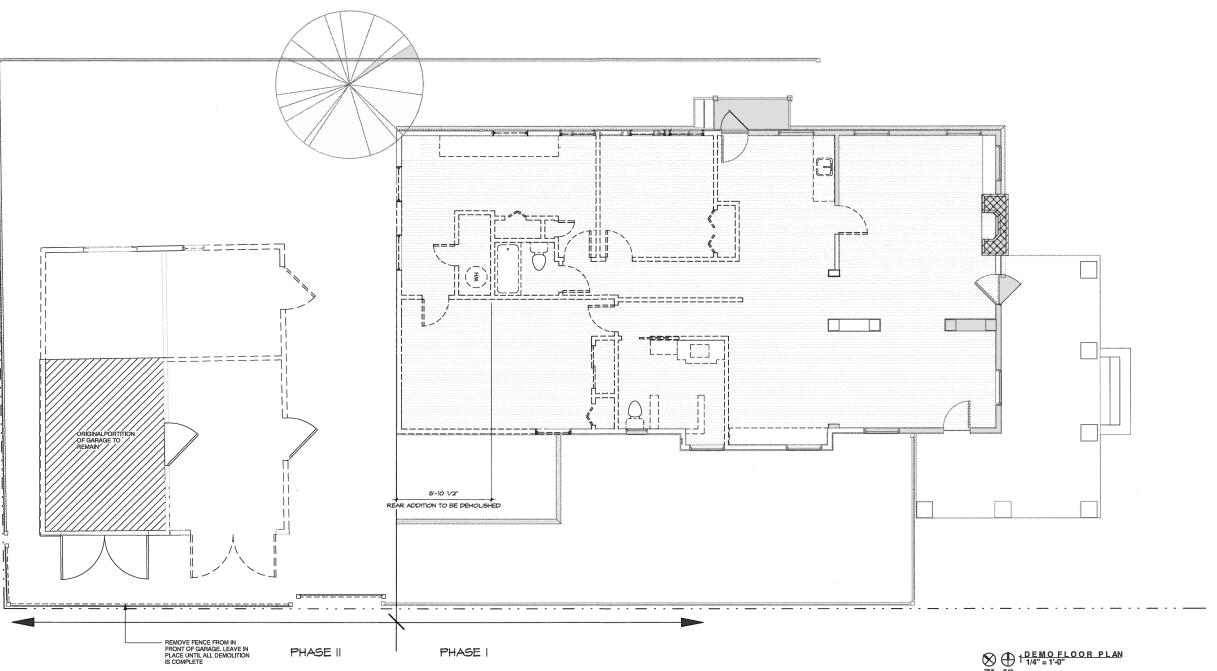
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COORDINATION, OR
REVIEW ONLY. NOT
FOR REGULATORY
APPROVAL,
PERMITTING OR
CONSTRUCTION.

TX. REG. #5504 INSITE ARCHITECTS

SHEET TITLE: OVER

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TRUE PLAN NORTH NORTH

DEMOLITION NOTES:

1. THE GENERAL CONTRACTOR SHALL BE RESPONSIBLE FOR PROVIDING ALL LABOR, EQUIPMENT AND SERVICES TO PROPERLY EXECUTE THE DEMOLITION AND REMOVAL WORK INDICATED ON THESE CONSTRUCTION DOCUMENTS.

2. THE CONTRACTOR SHALL VISIT THE SITE AND INSPECT THE EXISTING BUILDING AND VERIFY THAT ALL ITEMS INDICATED TO BE EXISTING AND SO MARKED ON DRAWINGS ARE IN PLACE AND CORRECT

3. ALL DEMOLITION WORK SHALL BE PERFORMED WITH MINIMUM DAMAGE TO THE EXISTING WORK TO REMAIN. IT SHALL BE RECOGNIZED THAT UTMOST CARE BE TAKEN WHEN PERFORMING THE DEMOLITION WORK, PROVIDE BARRICADES WHERE REQUIRED TO PROTECT THE PUBLIC.

4. PROVISIONS SHALL BE MADE TO ALLEVIATE THE SPREAD OF DEBRIS, DIRT AND DUST TO THE ADJACENT PROPERTIES. THE PROPERTY SHALL BE KEPT CLEAN AS POSSIBLE AT ALL TIMES. ANY ASBESTOS REMOVAL SHALL BE DONE PRIOR TO ANY DEMOLITION WORK, THIS WORK SHALL BE DONE BY A LICENSED BRATEMENT COMPANY.

5. DO NOT REMOVE ANY STRUCTURAL COLUMNS, WALLS OR SUPPORTS. CAREFULLY REMOVE INTERIOR PARTITIONS ONLY. IF THERE IS ANY CONCERN WHETHER A INTERIOR WALL IS BEARING OR NOT, CONTROL RACHIFECT HIMMEDIATELY TO SCHEDULE A VERIFICATION THIS.

6. WHERE ELECTRICAL NEEDS TO BE ABANDONED, REMOVE WIRE FROM OUTLET ALL THE WAY BACK TO THE ELECTRICAL PANEL / SOURCE. ALL WORK SHALL BE DONE BY A LICENSED ELECTRICIAN.

7. WHERE PLUMBING NEEDS TO BE ABANDONED, REMOVE ALL VENT STACK PIPE CAP & ROOF PENETRATION, REMOVE ALL OVERHEAD WATER LINES BACK TO POINT OF ENTRY (CAREFULLY VERIFY IF ANY LINES CAN BE RE-UTILIZED AS A PART OF NEW BUILD-OUT), ALL UNDERGROUND SANITARY, GREASE OR WATER LINES SHALL BE CAPPED-OFF BELOW SLAB. MAKE SURE ALL WATER HAS BEEN TURNED OFF PRIOR TO ANY WORK, ALL WORK SHALL BE OONE BY A LICENSED FLUMBER. NO DEAD WATER LEGS.

8. WHERE VENTILATION OR AIR CONDITIONING NEEDS TO BE ABANDONED, REMOVE ALL EXHAUST & OUTSIDE AIR DUCTS AS REQUIRED. ROOF TOP FANS SHALL BE REMOVED & THE OPENINGS DRIED-IN TO PREVENT ANY WATER PENETRATION IN THE SPACE. ALL WORK SHALL BE DONE BY A LICENSED HVAC CONTRACTOR.

9. WHERE GAS LINES OR SERVICE NEEDS TO BE ABANDONED, CAREFULLY REMOVE ALL PIPING, SHUT-OFF VALUES & FITTING AS REQUIRED, GAS METER & REQUIATOR SHALL BE REMOVED BY UTILITY COMPANY, ALL WORK SHALL BE DONE BY A LICENSED SUB-CONTRACTOR.

10. DATA PRESENTED ON THESE DRAWINGS ARE AS ACCURATE AS SURVEYS AND PLANNING CAN DETERMINE, BUT ABSOLUTE ACCURACY IS NOT GUARANTEED. RIELD VERHIFICATION OF THE PLANS IS THE RESPONSIBILITY OF THE CONTRACTOR SINCE FINAL DISTANCES, LOCATIONS AND HEIGHTS WILL BE GOVERNED BY ACTUAL FIELD CONDITIONS, CONTRACTOR TO RIELD VERHIFY EXISTING CONDITIONS IN AREAS TO BE RENOVATED PRIGN TO BID IN ORDER TO PROVIDE AN ACCURATE BID AND BE AWARE OF ALL CONSTRUCTION METHODS NEEDED TO PROVIDE THE RINISHED PRODUCT AS SHOWN ON THE PLANS, DISCREPANCIES SHALL BE BROUGHT TO THE ATTENTION OF THE ARCHITECT / ENGINEER FOR A DECISION TO RESOLVE CONFLICTS PRIOR TO BID.

11. CONSTRUCTION IN AREAS TO BE RENOVATED SHALL BE CAREFULLY COORDINATED WITH THE OWNER, AND ARCHITECT PRIOR TO CONSTRUCTION. EXISTING EQUIPMENT WILL BE RELOCATED OR STORED AS PER OWNER'S DIRECTION. EQUIPMENT AND PURNISHINGS TO BE STORED SHALL BE PROTECTED FROM DAMAGE AND VANDALISM IN LOCATIONS ACCEPTABLE TO THE OWNER.

12. DASHED LINES ON DEMOLITION PLAN INDICATED EXISTING MATERIALS TO BE REMOVED. EQUIPMENT TO BE REUSED SHALL BE STORED AND PROTECTED FROM DAMAGE DURING CONSTRUCTION. ANY DAMAGE RESULTING FROM CONSTRUCTION WILL BE REPAIRED TO ITS ORIGINAL STATE.

13, ITEMS TO REMAIN AND TO BE PROTECTED ARE DESIGNATED WITH CONTINUOUS LINES. IF DAMAGE OCCURS, PATCH, REPAIR, OR REPLACE DAMAGED ITEMS AT NO COST TO OWNER.

14. REPAIR SOFFIT, CEILING, WALL AND FLOOR FINISHES LEFT VOID OR DAMAGED BY DEMOLITION WORK

15. REPAIR WALLS DAMAGED BY DEMOLITION TO PROVIDE SMOOTH SURFACE, WITH PATCHES DRESSED FLUSH, SMOOTH AND READY TO RECEIVE FINISH MATERIAL. IF GYPSUM BOARD BEHIND FINISH SURFACE IS UNSUITABLE FOR RECONSTRUCTION, REPLACE WITH NEW GYPSUM BOARD

16, DEMOLITION EXPOSING THE INTERIOR OF THE BUILDING TO THE OUTSIDE ELEMENTS OR TO THE PUBLIC SHALL BE PROPERLY SEALED AND PROTECTED TO ELIMINATE DAMAGE FROM VANDALISM OR WEATHER DURING CONSTRUCTION.

17. PROVIDE SCREENING FROM DUST, FUMES, SMOKE, WATER, AND NOISE WHERE DEMOLITION REQUIRES CONSTRUCTION TO BE EXPOSED TO NORMAL OPERATIONS OF THE RESIDENCE.

18. CONTRACTOR SHALL VERIFY EXISTING CONDITIONS PRIOR TO DEMOLITION WORK. PROBLEMS OR DISCREPANCIES IN THE PLAN SHALL BE REPORTED AT ONCE TO THE ARCHITECT AND ALL WORK INVOLVED AT SAID QUESTIONED AREA SHALL BE HALTED UNTIL ARCHITECT GIVES NOTICE TO PROCEED.

19. COORDINATE PLUMBING, MECHANICAL, AND ELECTRICAL DEMOLITION AS INDICATED IN PLUMBING, MECHANICAL, AND ELECTRICAL DRAWINGS WHEN PRESENT. EXISTING MILLWORK, LIGHTING AND PLUMBING FIXTURES NOT TO BE REUSED ARE TO BE REMOVED AND RETURNED TO THE BUILDING OWNER.

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RESIDENCE ST. GUENTHER SAN ATNONIO, TX LABORDE ш

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11.19.2016 REVISED:

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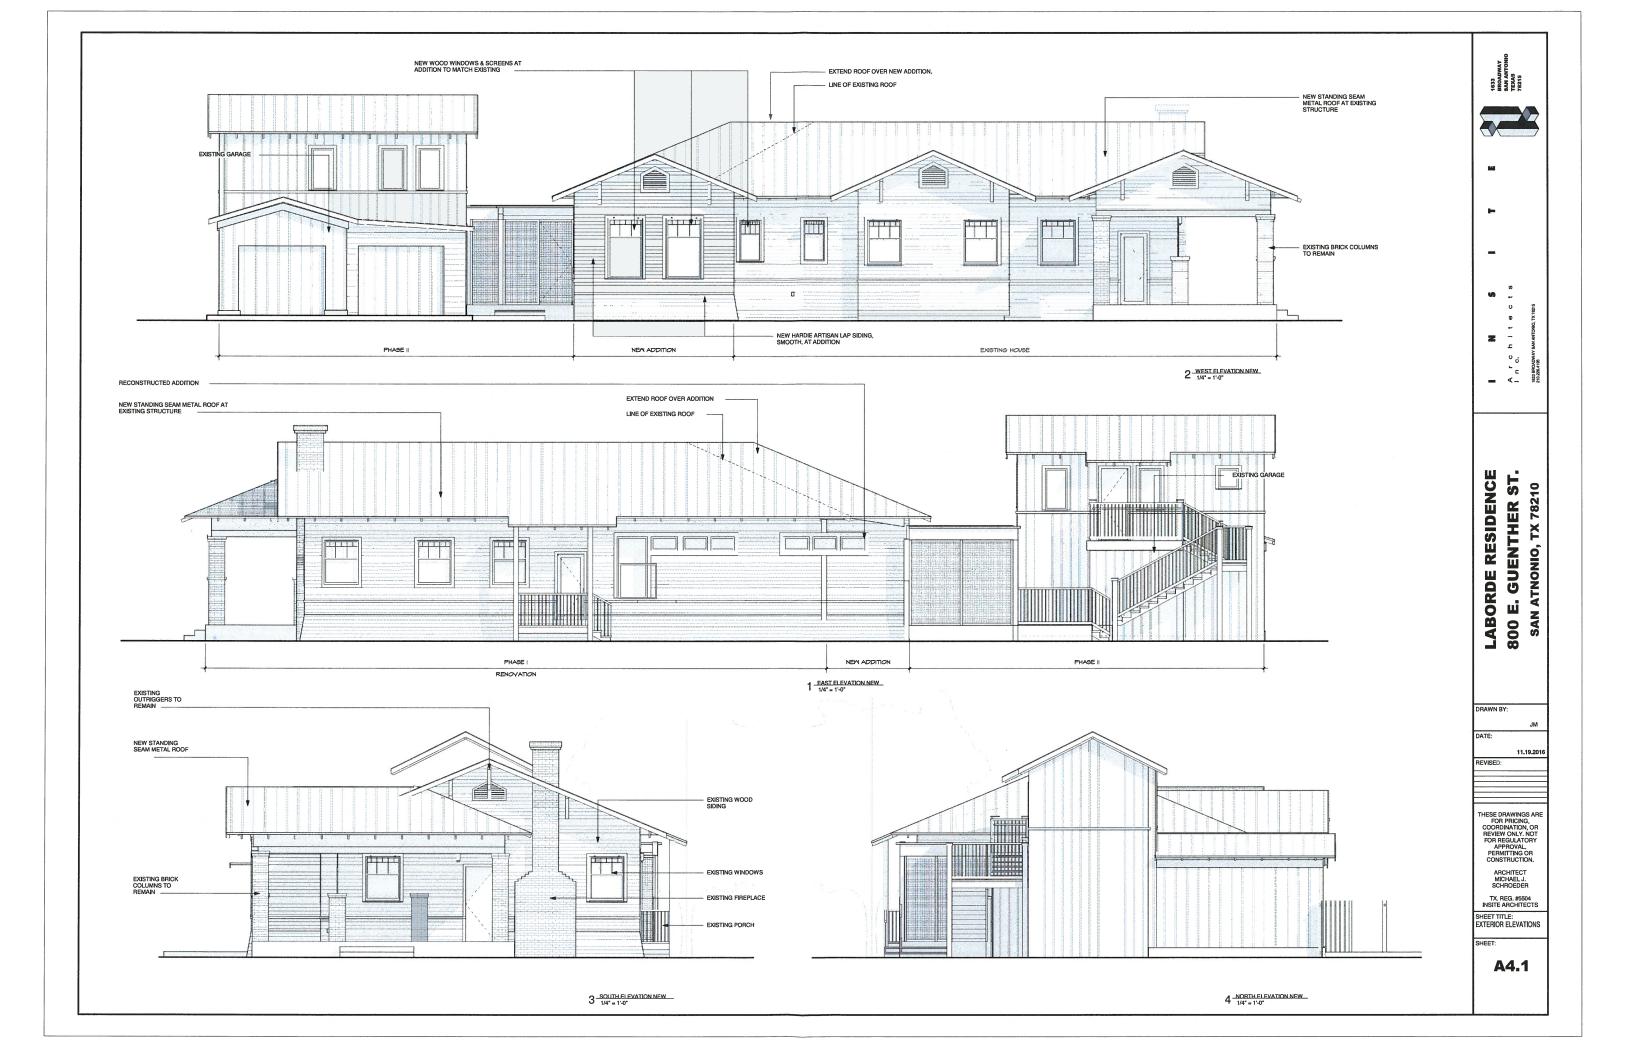
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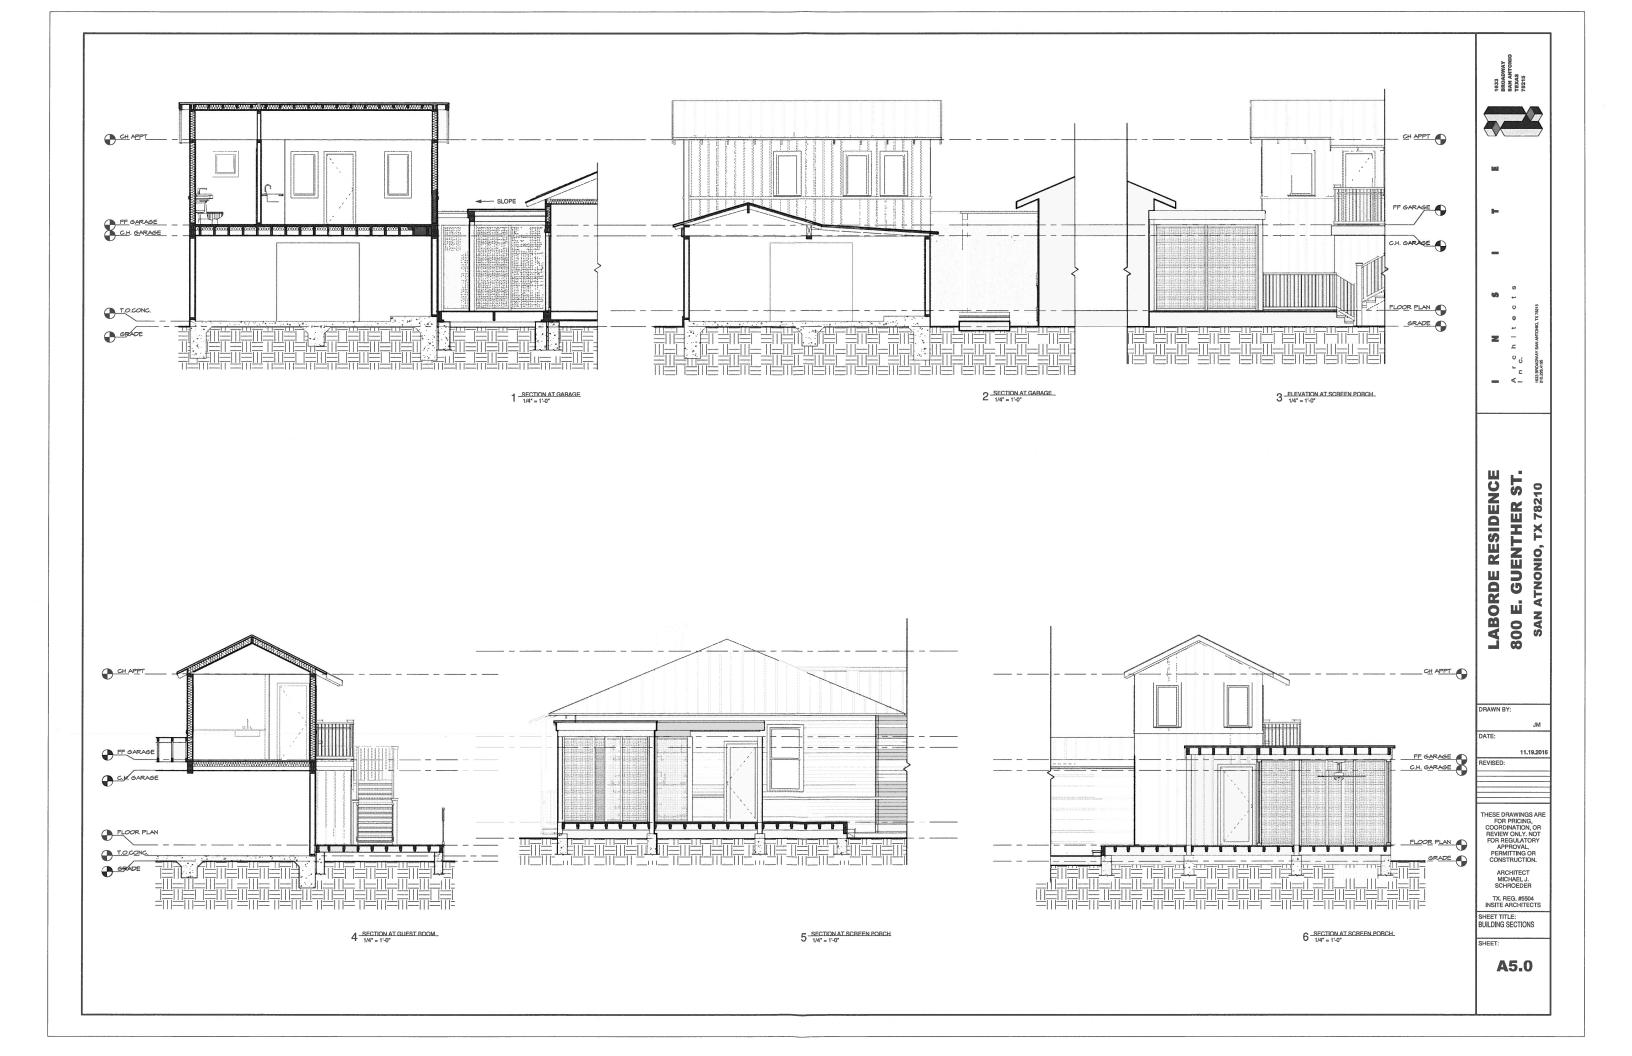
ARCHITECT MICHAEL J. SCHROEDER


TX. REG. #5504 INSITE ARCHITECTS

SHEET TITLE: EMO PLAN

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9 SLEVATION WITHIN SHOWER

\odot	(MARK TYPE) CABINET ACCESSORIES					
MAR K	ACCESSORY	BRAND	FINISH	MODEL#	DIMENSIONS	
1	UNDERCOUNTER MT. SINK	ELKAY	STAINLESS STEEL	ELUH281612	28"L X 16"W X 11-1/2"D	
1.1	TRINSIC PULL DOWN FAUCET	DELTA	STAINLESS STEEL	#D9159ARDST	-	
1.2	WALL MT POT FILLER	DELTA	ACRYLIC STAINLESS	#D1165LFAR	24" DUAL JOINED	
J	ABOYE COUNTER BASIN	DURAYIT	CERAMIC	#04525000001	19 3/4" X 18 1/2" X 5 1/8" D	
J.1	SINGLE CONTROL FAUCET	PFISTER	BRUSHED NICKEL	#PLG42MFOK	-	
K	WATER CLOSET	DURAYIT	CERAMIC	#2157010005	14 5/8" × 25 3/8"	
L	MHIRLPOOL BATH	MIRABELLE	ACRYLIC	MIRBDN6032RNH	60"L X 32"W X 21 1/2" D	
L.1	BATH FAUCET	PFISTER	BRUSHED NICKEL	#PRT65MFK		
	PANTRY PULL-OUT UNIT ON TOP CABINET. BY HAFELE OR EQ.					
N	SLIDE OUT BASE DRAWER BY HAFELE OR EQ.					
_	PULL-OUT CABINET GUIDES FOR SPICE RACK. PROVIDE PROVIDE MILLWORK STRUCTURE FOR SPICE SHELVES					
P	PULL-OUT WASTE BINS					
	EMTEK 86389US26 POLISHED CHROME CARBON FIBER SILVER 6" CTOC BAR CABINET PULL					

2CM ENGINEERED STONE (ES-2) BY: COMPAQ, "ALASKA". (COUNTERTOPS @ BATHROOMS) OVER 3/4* PLYWOOD SUBSTRATE WITH 1-1/2" EASED EDGE PROFILE PLASTIC LAMINATE VENERER COUNTER TOP & DRAWERS (PL-1) ON LOW PROFILE METAL SUPPORTS.

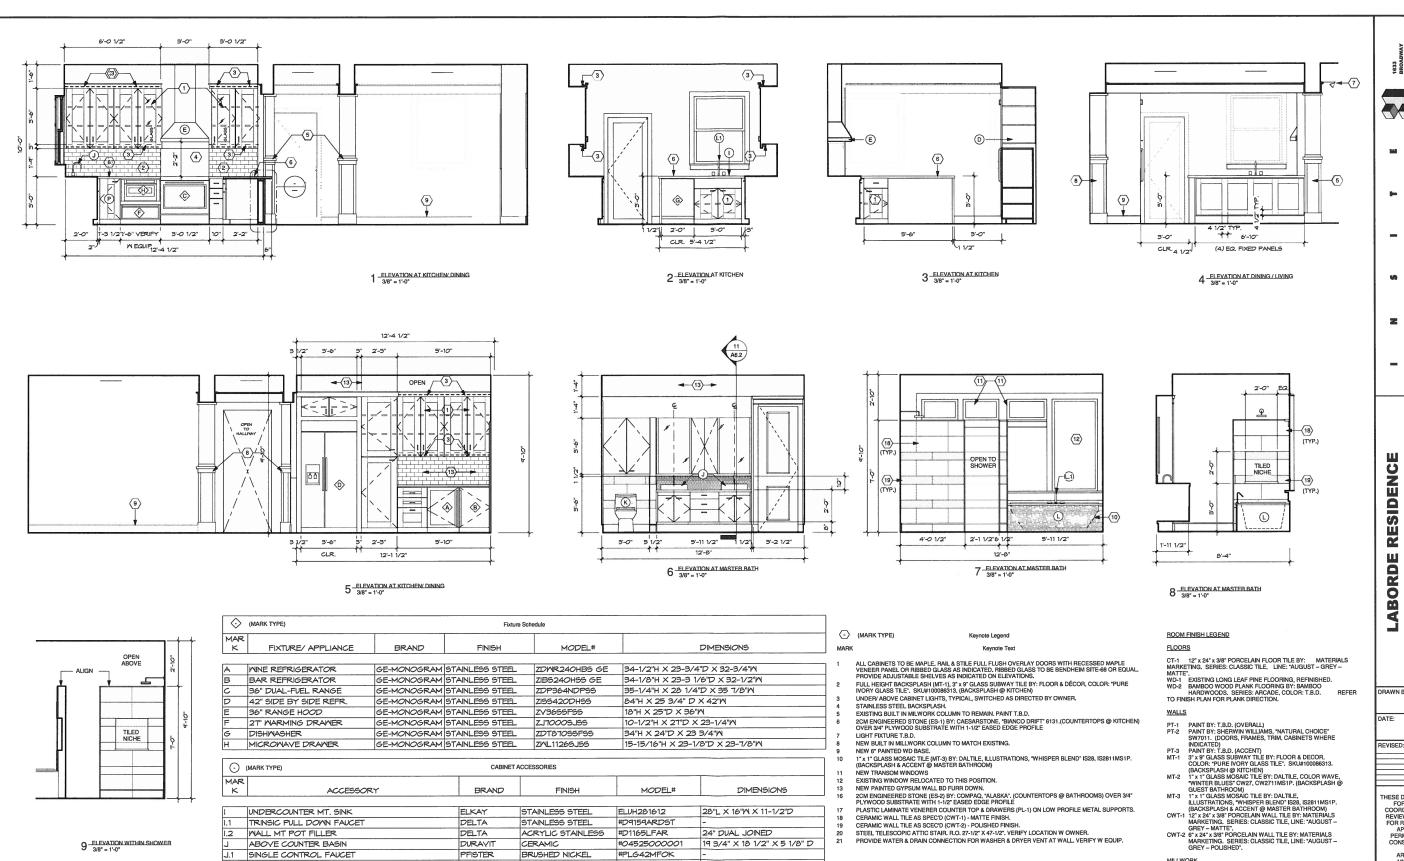CERAMIC WALL TILE AS SPECI (CWT-2) - MATTE FINISH.

CERAMIC WALL TILE AS SECC'D (CWT-2) - POLISHED FINISH.

STEEL TELESCOPIC ATTIC STAIR. R.O. 27-1/2" X 47-1/2". VERIFY LOCATION W OWNER.

PROVIDE WATER & DRAIN CONNECTION FOR WASHER & DRYER VENT AT WALL, VERIFY W EQUIP.

ES-1 2CM ENGINEERED STONE BY: CAESARSTONE, "BIANCO DRIFT 6131, (COUNTERTOPS @ KITCHEN)
ES-2 2CM ENGINEERED STONE BY: COMPAQ,
"ALASKA", (COUNTERTOPS @ BATHROOMS)
PL-1 PLASTIC LAMINATE VENEER BY: WILSONART, "GREY MESH"
4877-38. (WORKSURFACES @ STUDY)

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GUENTHER ST. **SAN ATNONIO, TX 78210** ш 800

11.19.2016

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ARCHITECT MICHAEL J. SCHROEDER

TX. REG. #5504 INSITE ARCHITECTS

SHEET TITLE: INTERIOR ELEVATIONS

SHEET:

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