

HISTORIC AND DESIGN REVIEW COMMISSION

March 15, 2017

HDRC CASE NO: 2017-106
COMMON NAME: 600 BLOCK OF BURLESON / BURLESON AT OLIVE
ADDRESS: 1158 N OLIVE ST
1154 N OLIVE ST
1142 N OLIVE ST
631 BURLESON ST
619 BURLESON ST
LEGAL DESCRIPTION: NCB 515 (URBAN @ OLIVE (IDZ)), BLOCK 17 LOT 32
NCB 515 (URBAN @ OLIVE (IDZ)), BLOCK 17 LOT 33
NCB 515 (URBAN @ OLIVE (IDZ)), BLOCK 17 LOT 36
NCB 515 (URBAN @ OLIVE (IDZ)), BLOCK 17 LOT 23
NCB 515 (URBAN @ OLIVE (IDZ)), BLOCK 17 LOT 20
CITY COUNCIL DIST.: 2
DISTRICT: Dignowity Hill Historic District
APPLICANT: Ricardo Turrubiates/TerraMark TX
OWNER: K/T TX Holdings, LLC
TYPE OF WORK: Approval of additional facade arrangements in addition to previously approved designs

REQUEST:

The applicant is requesting a Certificate of Appropriateness for approval of prototype 4.2, consisting of new elevations to be constructed at the 600 Block of Burleson. The proposed prototype would be located on lots addressed as 1142, 1154 and 1158 N Olive and 619 and 631 Burleson. Prototype 4.2 is a variant of prototype 4.

APPLICABLE CITATIONS:

Historic Design Guidelines, Chapter 4, Guidelines for New Construction

3. Materials and Textures

A. NEW MATERIALS

i. Complementary materials—Use materials that complement the type, color, and texture of materials traditionally found in the district. Materials should not be so dissimilar as to distract from the historic interpretation of the district. For example, corrugated metal siding would not be appropriate for a new structure in a district comprised of homes with wood siding.

ii. Alternative use of traditional materials—Consider using traditional materials, such as wood siding, in a new way to provide visual interest in new construction while still ensuring compatibility.

iii. Roof materials—Select roof materials that are similar in terms of form, color, and texture to traditionally used in the district.

iv. Metal roofs—Construct new metal roofs in a similar fashion as historic metal roofs. Refer to the Guidelines for Alterations and Maintenance section for additional specifications regarding metal roofs.

v. Imitation or synthetic materials—Do not use vinyl siding, plastic, or corrugated metal sheeting. Contemporary materials not traditionally used in the district, such as brick or simulated stone veneer and Hardie Board or other fiberboard siding, may be appropriate for new construction in some locations as long as new materials are visually similar to the traditional material in dimension, finish, and texture. EIFS is not recommended as a substitute for actual stucco.

4. Architectural Details

A. GENERAL

i. Historic context—Design new buildings to reflect their time while respecting the historic context. While new construction should not attempt to mirror or replicate historic features, new structures should not be so dissimilar as to distract from or diminish the historic interpretation of the district.

ii. Architectural details—Incorporate architectural details that are in keeping with the predominant architectural style

along the block face or within the district when one exists. Details should be simple in design and should complement, but not visually compete with, the character of the adjacent historic structures or other historic structures within the district.

Architectural details that are more ornate or elaborate than those found within the district are inappropriate.

iii. Contemporary interpretations—Consider integrating contemporary interpretations of traditional designs and details for new construction. Use of contemporary window moldings and door surroundings, for example, can provide visual interest while helping to convey the fact that the structure is new. Modern materials should be implemented in a way that does not distract from the historic structure.

FINDINGS:

- a. The applicant is requesting a Certificate of Appropriateness for approval to construct prototype 4.2 at the 600 Block of Burlison. The proposed new design is not an amendment to a previously approved design, but a new design to further vary the facades of the new construction within this development. Prototype 4.2 is a variant of prototype 4. The applicant has proposed prototype 4.2 and four variants of prototype 4.2, listed as 4.2 A through D. Prototype 4 was approved by the HDRC on July 15, 2015. Since that time, the applicant has worked with staff to install wood window trim around the approved windows which provides a minimal recess within the window openings. All future prototypes include this window treatment.
- b. DESIGN REVIEW COMMITTEE – The request was reviewed by the DRC on March 10, 2017, where committee members suggested the increase in size of the front façade’s second story window and recommended that the applicant install porches that span the entire front façade of each design.
- c. The applicant has proposed prototype 4.2A, which includes three front porch columns, a front gabled roof, two front facing double windows that are covered by a shed roof, a full porch width shed roof, small fixed windows on both side elevations, a rear stoop with a rear stoop door and two rear windows.
- d. The applicant has proposed prototype 4.2B, features three groupings of front porch columns, a hipped roof, a full width front porch with a shed roof, two groupings of three windows with the second level grouping being covered by a shed roof, fixed windows on both side elevations, double windows on the ground level of the west elevations and a rear stoop, rear stoop door and rear windows.
- e. The applicant has proposed prototype 4.2.C, which includes a front facing gabled roof, two groupings of two windows with the second level grouping being covered by a shed roof, a half width front porch with two front porch columns that extends into the side yard, a rear stoop and stoop door, rear windows, fixed windows on both side elevations, double windows on the ground level of the west elevations.
- f. The applicant has proposed prototype 4.2D, which includes four groupings of front porch columns, a half width front porch that extends into the side yard, two groupings of three front facing windows, a hipped roof, a shed porch roof and shed roof over the second level grouping of windows, fixed windows on both side elevations and double windows on the ground level of the west elevations.
- g. Staff finds that the continued work toward proposing additional façade arrangements is appropriate.

RECOMMENDATION:

Staff recommends approval based on finding a through e with the following stipulations:

- i. That the applicant continue to incorporate the previously agreed upon window treatment.
- ii. That the applicant install a front porch across the front façade of each design.
- iii. That the applicant consider installing an operable window on the front façade’s second floor of each design instead of a fixed window.

CASE MANAGER:

Edward Hall





N

Flex Viewer

Powered by ArcGIS Server

Printed: Jan 09, 2017

The City of San Antonio does not guarantee the accuracy, adequacy, completeness or usefulness of any information. The City does not warrant the completeness, timeliness, or positional, thematic, and attribute accuracy of the GIS data. The GIS data, cartographic products, and associated applications are not legal representations of the depicted data. Information shown on these maps is derived from public records that are constantly undergoing revision. Under no circumstances should GIS-derived products be used for final design purposes. The City provides this information on an "as is" basis without warranty of any kind, express or implied, including but not limited to warranties of merchantability or fitness for a particular purpose, and assumes no responsibility for anyone's use of the information.



urban@olive

New Home Community
Starting in the low \$200K's

- MODERN INTERIORS
- 2-3 BEDROOMS, 2.5 BATH OPTIONS
- PRIVATE YARDS
- GARAGE & CARPORT PLANS AVAILABLE



TERRAMARK
URBAN HOMES

for sales inquiries: LORIE CAMPOS — 210.442.7601
URBANATOLIVE.COM

KEEP OPEN OVERHEAD
DO NOT USE BRUSH
OR POWER TOOLS
KEEP CLEAR

Elevation "C" or "D"



URBAN @ OLIVE

MASTER SITE PLAN

November 15, 2016

Scale: 1" = 30'

Prototype 4.2 Site Plan Exhibit



SEVENTH GENERATION
DESIGN INCORPORATED

FENCING LEGEND


—	STANDARD
—	OPTIONAL
—	COMMON



TERRAMARK
URBAN HOMES

Elevation "A" or "B"



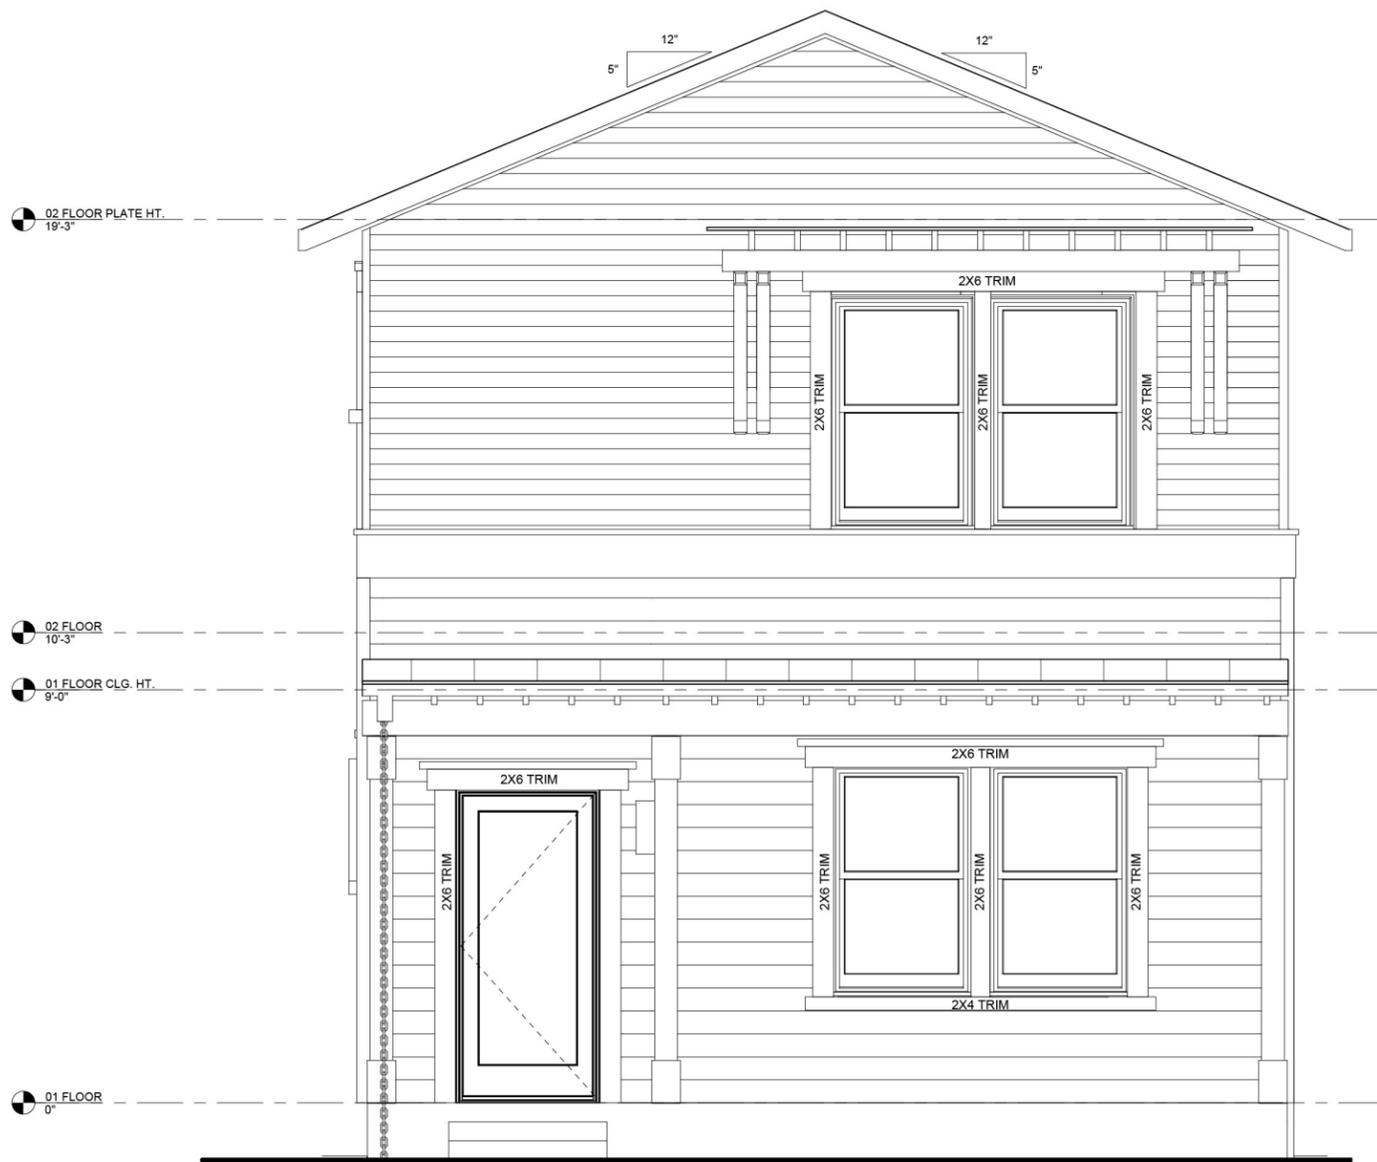

1 PROTOTYPE 4 - AS BUILT
1/4" = 1'-0"



1 PROTOTYPE 4.2A - FRONT ELEVATION
1/4" = 1'-0"



1 PROTOTYPE 4 - AS BUILT
1/4" = 1'-0"



1 PROTOTYPE 4.2B - FRONT ELEVATION
1/4" = 1'-0"



1 PROTOTYPE 4 - AS BUILT
1/4" = 1'-0"



1 PROTOTYPE 4.2C - FRONT ELEVATION
1/4" = 1'-0"



1 PROTOTYPE 4 - AS BUILT
1/4" = 1'-0"



1 PROTOTYPE 4.2D - FRONT ELEVATION
1/4" = 1'-0"


Urban at Olive - PROTOTYPE 4.2D

TERRAMARK Urban Homes

CONSTRUCTION SET

600 Block Burleson San Antonio, TX


February 6, 2017

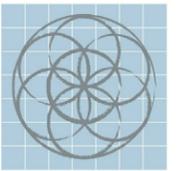

SEVENTH
GENERATION
DESIGN

ARCHITECTURE | SUSTAINABILITY | PRESERVATION

118 Broadway, Suite 519
San Antonio, Texas 78205
TEL (210) 262-6161 TEL (210) 241-7490

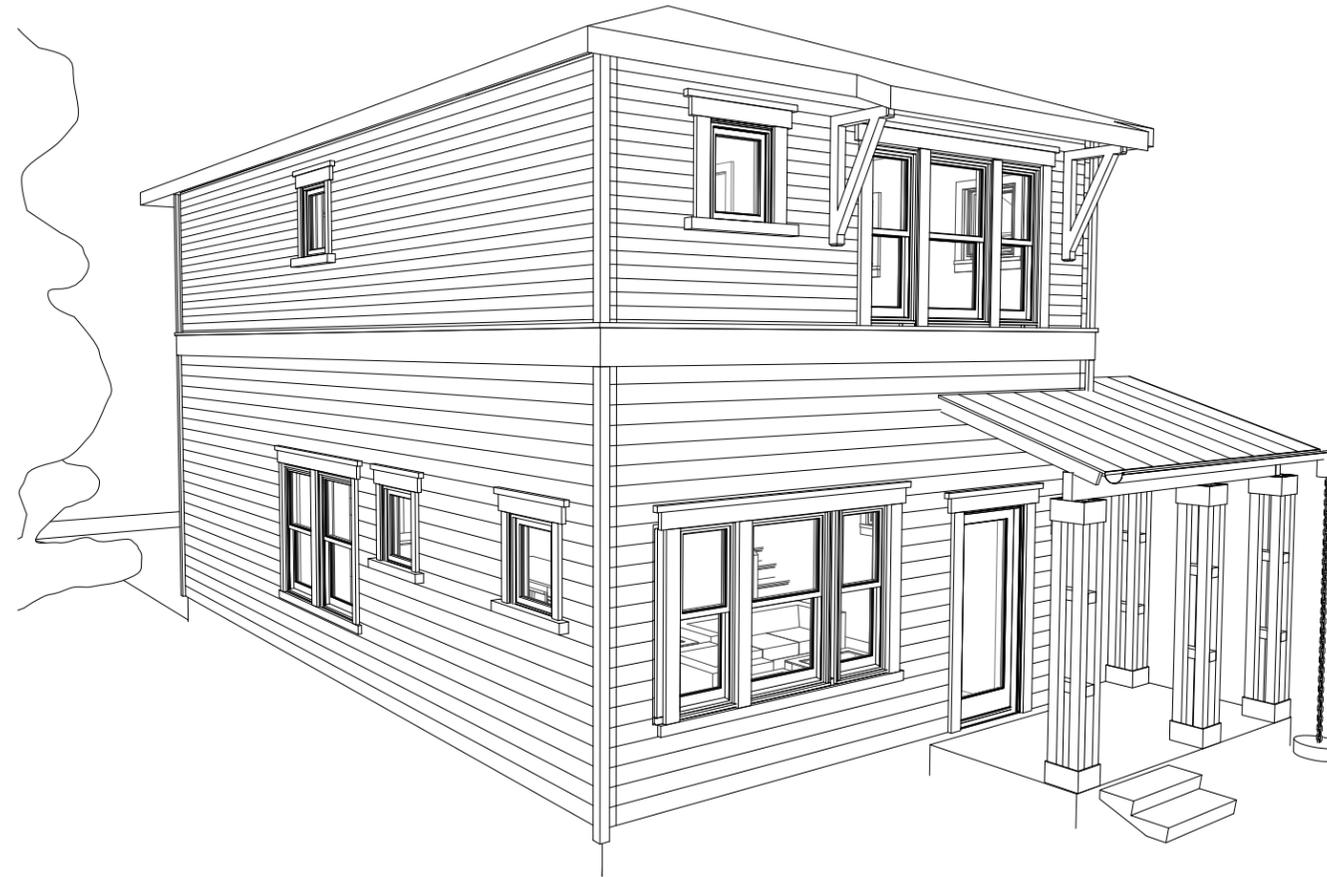

SKETCH IS CONCEPTUAL ONLY NOT FOR CONSTRUCTION

SHEET INDEX - PROTOTYPE 4.2D

NUMBER	NAME
4.2D-A0.00	COVER SHEET
4.2D-A2.03	01 FLOOR PLAN
4.2D-A2.04	02 FLOOR PLAN
4.2D-A2.05	ROOF PLAN
4.2D-A2.06	01 REFLECTED CEILING PLAN
4.2D-A2.07	02 REFLECTED CEILING PLAN
4.2D-A3.01	FRONT ELEVATION
4.2D-A3.02	BACK ELEVATION
4.2D-A3.03	SIDE ELEVATION
4.2D-A3.04	SIDE ELEVATION
4.2D-A4.01	EXTERIOR SECTIONS & DETAIL
4.2D-A4.02	STAIR PLANS SECTIONS & DETAILS
4.2-A5.01	INTERIOR ELEVATIONS & DETAILS
4.2-A5.02	OPTIONAL GARAGE
4.2-A5.03	OPTIONAL CARPORT

Urban at Olive

600 Block Burleson San
Antonio, TX


No.	Date	Description
1	02/06/2017	Construction Set

TERRAMARK
URBAN HOMES



William Carpenter

February 6, 2017

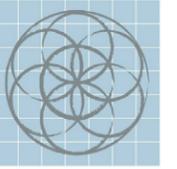

SEVENTH
GENERATION
DESIGN

ARCHITECTURE | SUSTAINABILITY | PRESERVATION

118 Broadway, Suite 519
San Antonio, Texas 78205
TEL (210) 262-6161 TEL (210) 241-7490

Urban at Olive

600 Block Burleson San
Antonio, TX

No.	Date	Description
1	02/06/2017	Construction Set



01 FLOOR PLAN

PROTOTYPE 4.2D




Scott William Carpenter
February 6, 2017

Project number
Date February 6, 2017
Drawn by
Checked by


4.2D-A2.03

Scale

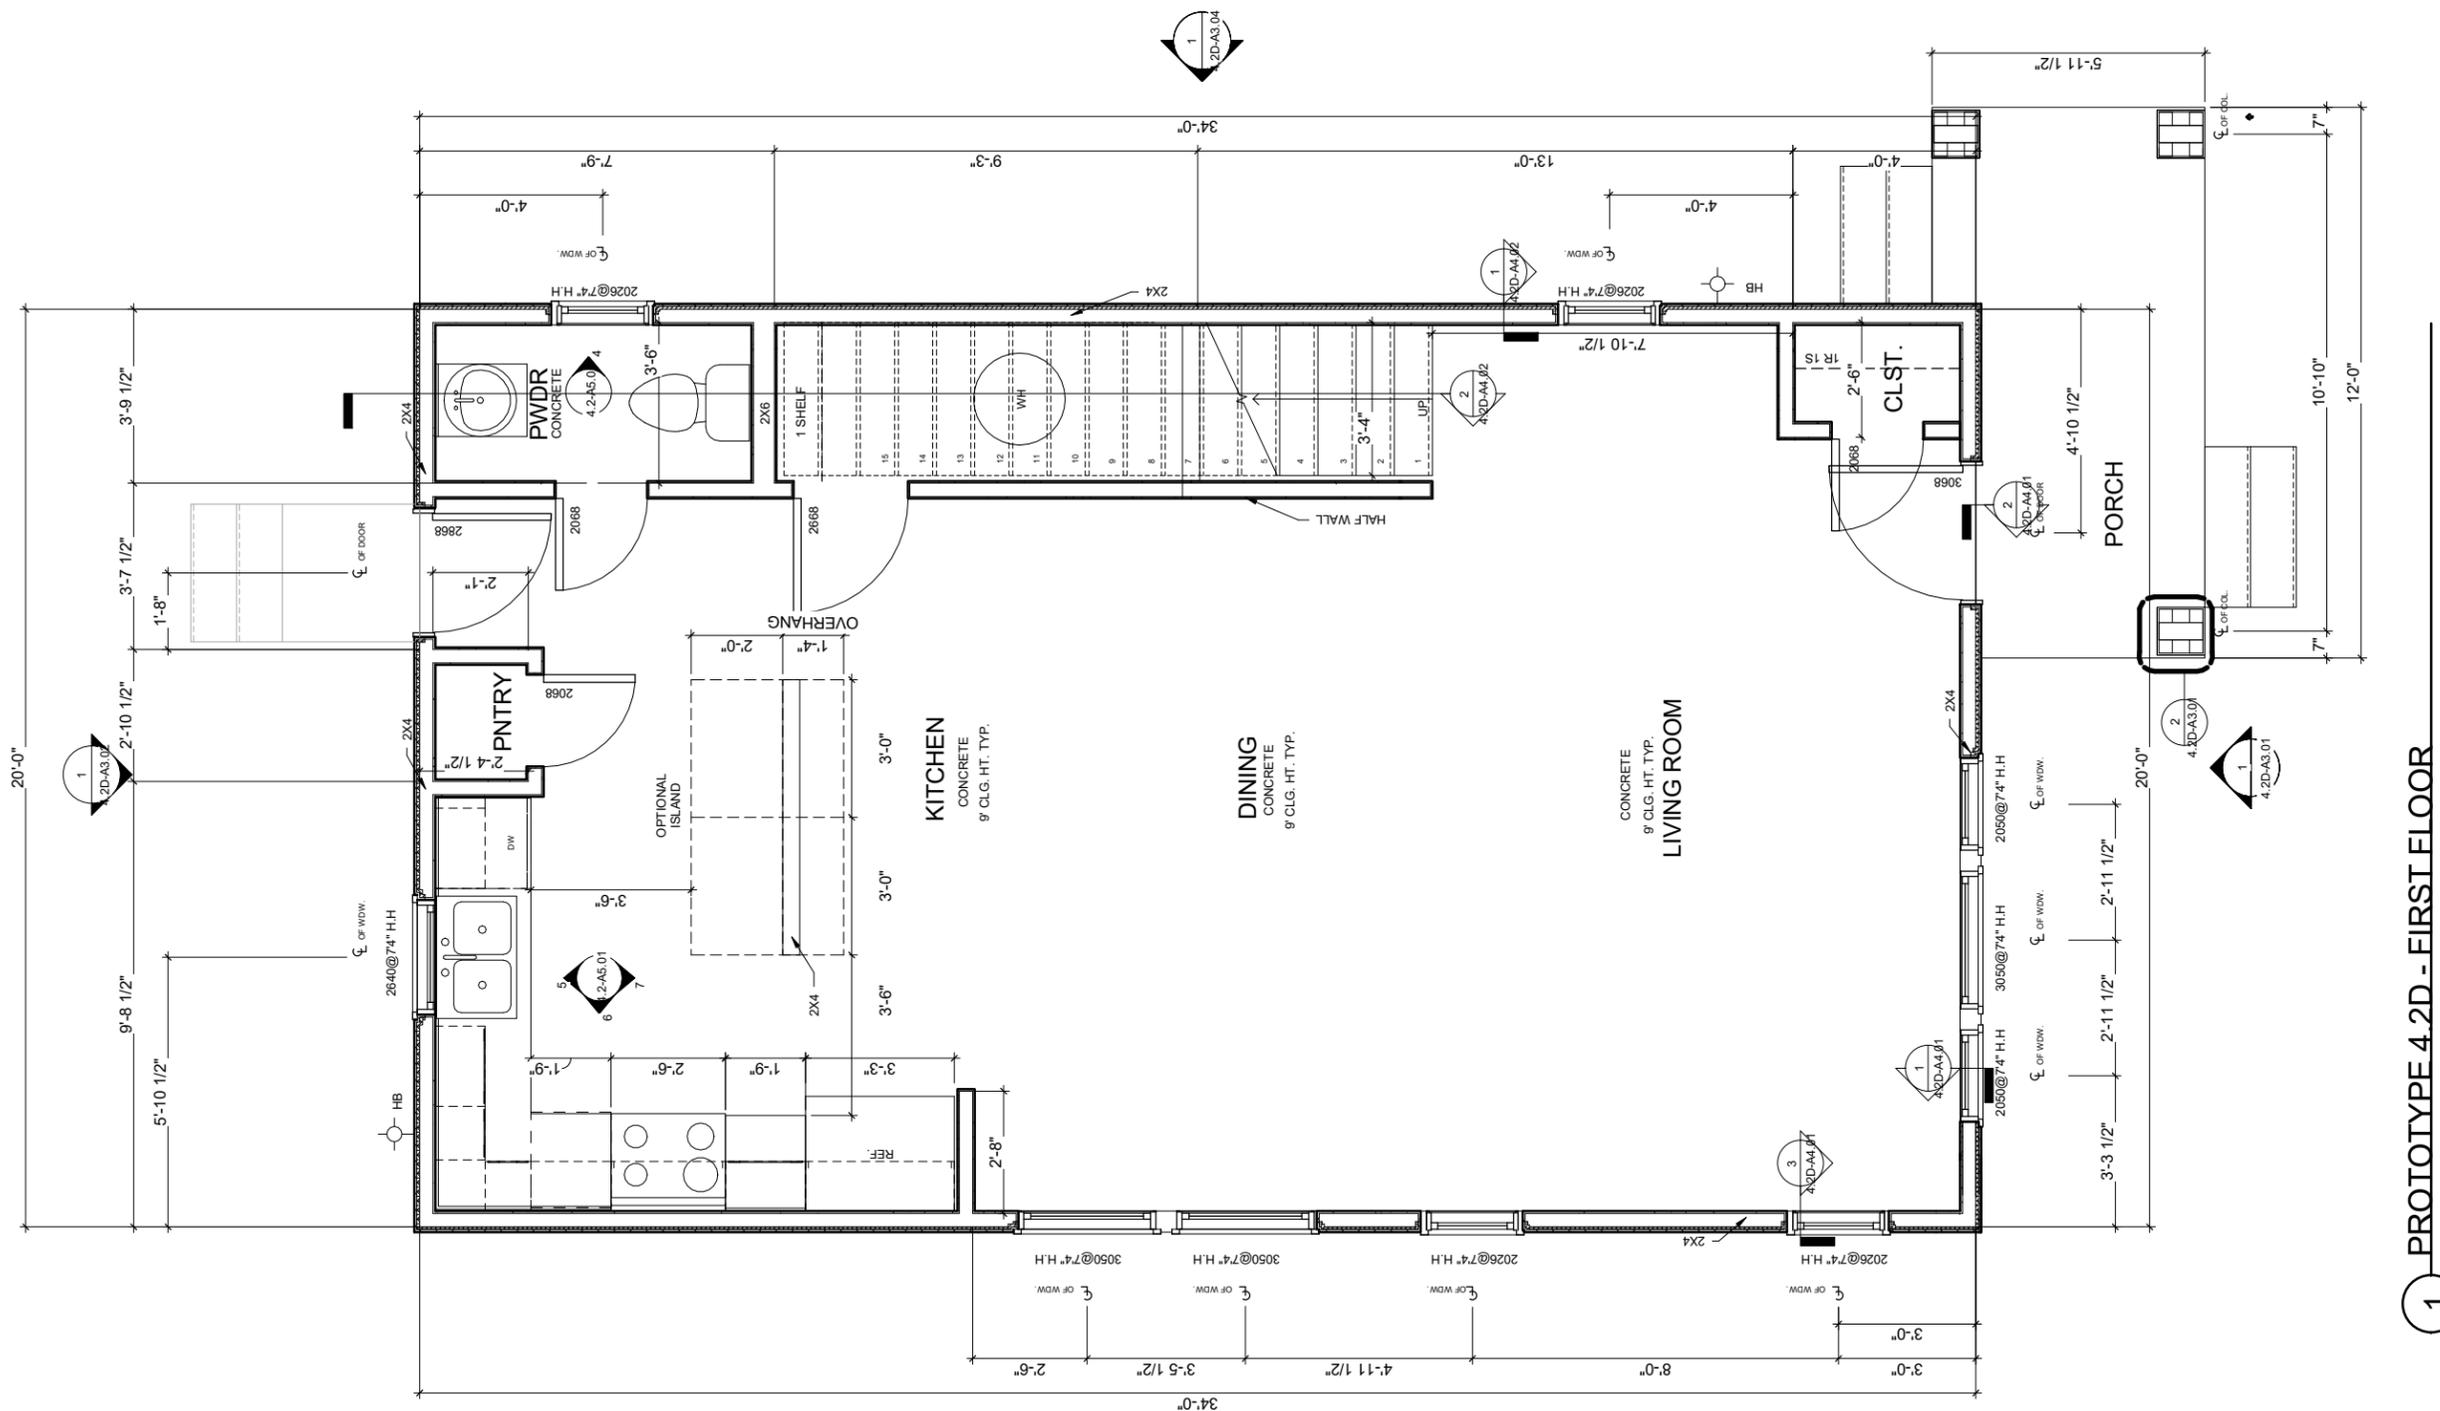

1 PROTOTYPE 4.2D - FIRST FLOOR
1/4" = 1'-0"

OVERALL LIVING + ROOF AREAS	
NAME	AREA
1ST FLOOR LIVING	680 S.F.
2ND FLOOR LIVING	632 S.F.
TOTAL LIVING	1312 S.F.
FRONT PORCH	64 S.F.
TOTAL STRUCTURE	1,376 S.F.
COMP. ROOF AREA	930 S.F.
METAL ROOF AREA	76 S.F.

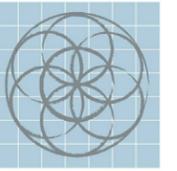

SEVENTH GENERATION DESIGN

ARCHITECTURE | SUSTAINABILITY | PRESERVATION

118 Broadway, Suite 519
San Antonio, Texas 78205
TEL (210) 262-6161 TEL (210) 241-7490

Urban at Olive

600 Block Burleson San Antonio, TX

No.	Date	Description
1	02/06/2017	Construction Set



01 FLOOR REFLECTED CEILING PLAN

PROTOTYPE 4.2D




February 6, 2017

Project number
Date February 6, 2017
Drawn by
Checked by

4.2D-A2.06

Scale

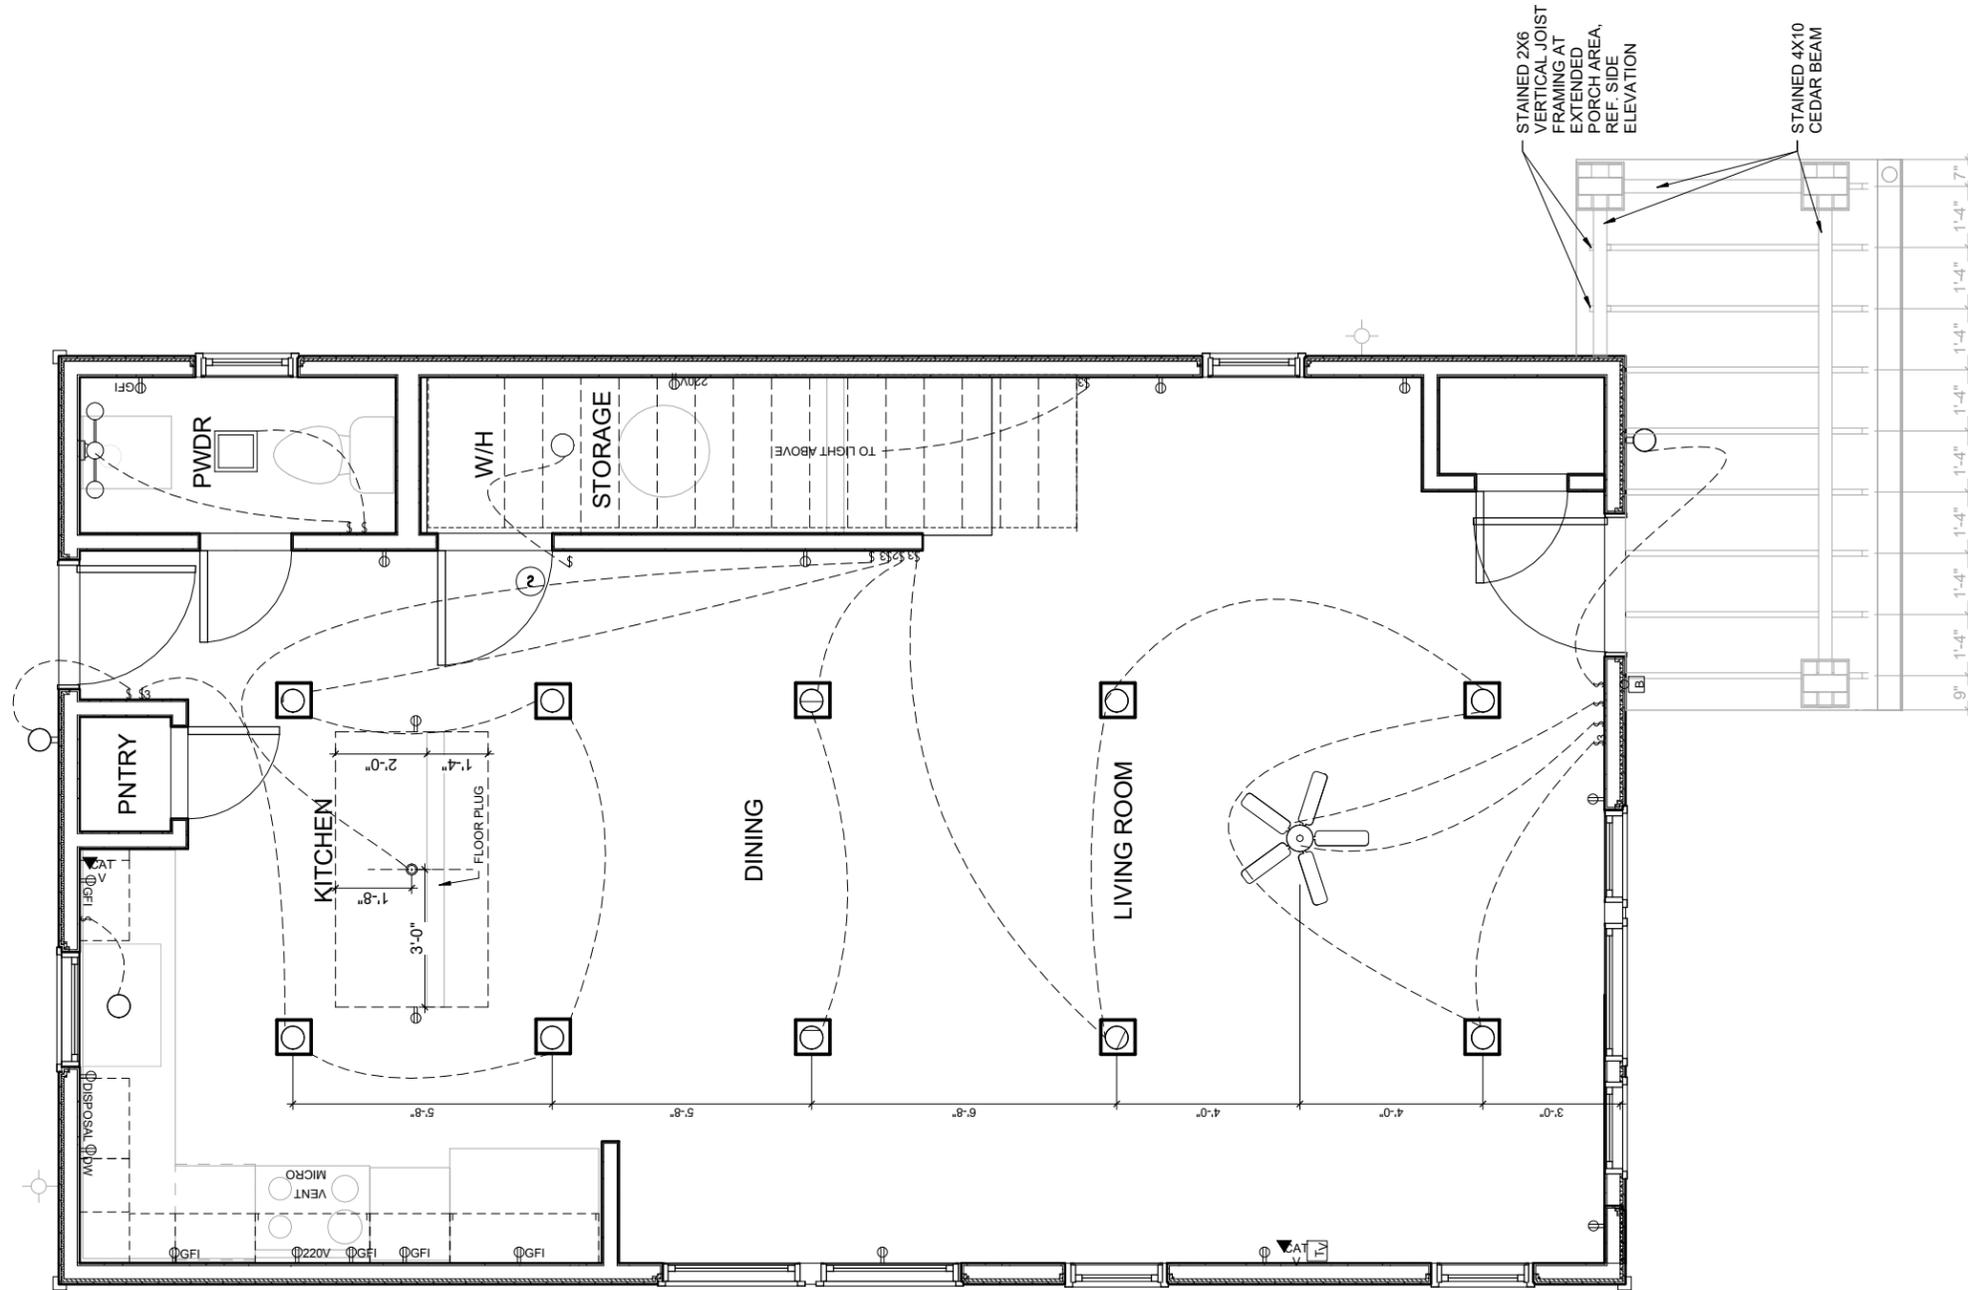

STAINED 2X6 VERTICAL JOIST FRAMING AT EXTENDED PORCH AREA, REF. SIDE, ELEVATION


STAINED 4X10 CEDAR BEAM

1 PROTOTYPE 4.2D - 01 REFLECTED CEILING PLAN
1/4" = 1'-0"

ELECTRICAL & CEILING PLAN LEGEND

	RECESSED LIGHT		110 VOLT DUPLEX OUTLET		THERMOSTAT
	WATERPROOF RECESSED LIGHT		220 VOLT DUPLEX OUTLET		DOORBELL
	PENDANT LIGHT		GROUND FAULT/WATERPROOF DUPLEX OUTLET		ELECTRICAL PANEL
	SURFACE MOUNTED LIGHT		DISHWASHER SWITCH		SMOKE & CARBON MONOXIDE DETECTOR
	WALL MOUNTED LIGHT		GARBAGE DISPOSAL SWITCH		TELEPHONE WALL OUTLET
	WALL MOUNTED VANITY LIGHT		ONE-WAY SWITCH		TELEVISION CABLE OUTLET
	EXHAUST FAN		TWO-WAY SWITCH		SCUTTLE ACCESS
	EXHAUST FAN W/ LIGHT COMBO				
	CEILING FAN WITH LIGHT KIT				

2/7/2017 8:14:32 AM

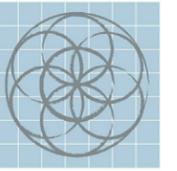

SEVENTH
GENERATION
DESIGN

ARCHITECTURE | SUSTAINABILITY | PRESERVATION

118 Broadway, Suite 519
San Antonio, Texas 78205
TEL (210) 262-6161 TEL (210) 241-7490

Urban at Olive

600 Block Burleson San
Antonio, TX

No.	Date	Description
1	02/06/2017	Construction Set



02 FLOOR REFLECTED
CEILING PLAN

PROTOTYPE 4.2D




February 6, 2017

Project number
Date February 6, 2017
Drawn by
Checked by

4.2D-A2.07

Scale

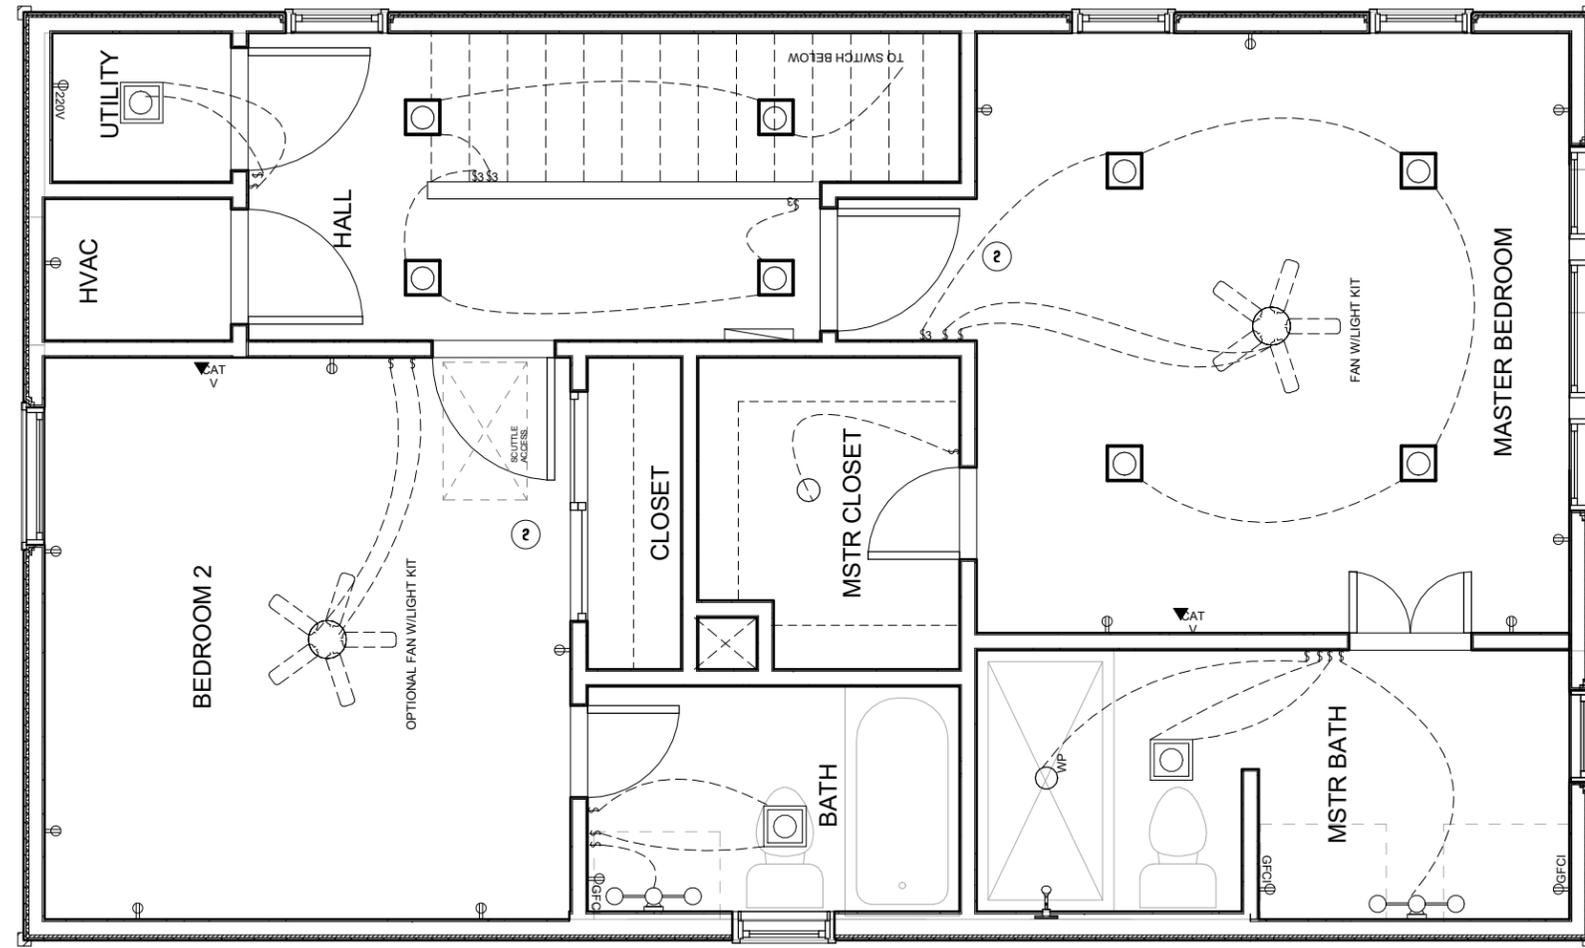


1 PROTOTYPE 4.2D - 02 REFLECTED CEILING PLAN
1/4" = 1'-0"

ELECTRICAL & CEILING PLAN LEGEND

- | | | | | | |
|--|----------------------------|--|---------------------------------------|--|----------------------------------|
| | RECESSED LIGHT | | 110 VOLT DUPLEX OUTLET | | THERMOSTAT |
| | WATERPROOF RECESSED LIGHT | | 220 VOLT DUPLEX OUTLET | | DOORBELL |
| | PENDANT LIGHT | | GROUND FAULT/WATERPROOF DUPLEX OUTLET | | ELECTRICAL PANEL |
| | SURFACE MOUNTED LIGHT | | DISHWASHER SWITCH | | SMOKE & CARBON MONOXIDE DETECTOR |
| | WALL MOUNTED LIGHT | | GARBAGE DISPOSAL SWITCH | | TELEPHONE WALL OUTLET |
| | WALL MOUNTED VANITY LIGHT | | ONE-WAY SWITCH | | TELEVISION CABLE OUTLET |
| | EXHAUST FAN | | TWO-WAY SWITCH | | SCUTTLE ACCESS |
| | EXHAUST FAN W/ LIGHT COMBO | | | | |
| | CEILING FAN WITH LIGHT KIT | | | | |

2/13/2017 4:15:06 PM

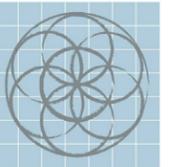

SEVENTH
GENERATION
DESIGN

ARCHITECTURE | SUSTAINABILITY | PRESERVATION

118 Broadway, Suite 519
San Antonio, Texas 78205
TEL (210) 262-6161 TEL (210) 241-7490

Urban at Olive

600 Block Burleson San
Antonio, TX

No.	Date	Description
1	02/06/2017	Construction Set



FRONT ELEVATION

PROTOTYPE 4.2D




February 6, 2017

Project number
Date February 6, 2017
Drawn by
Checked by

4.2D-A3.01


Scale

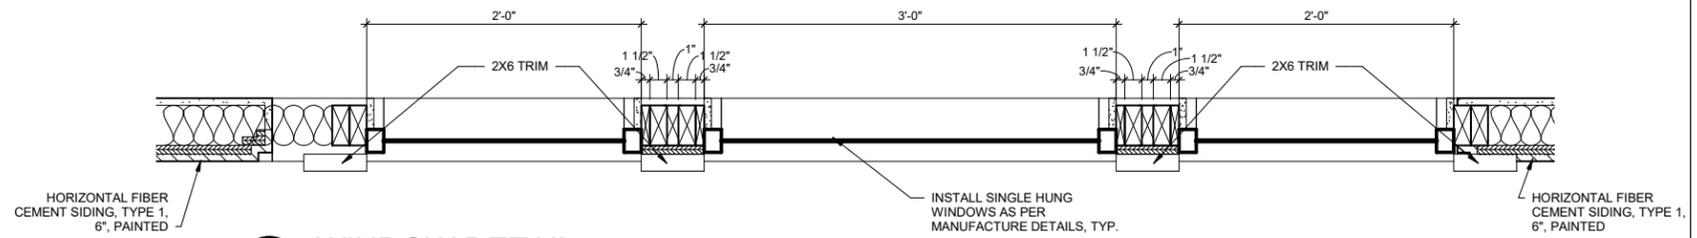


5 WINDOW DETAIL
3/4" = 1'-0"




1 PROTOTYPE 4.2D - FRONT ELEVATION
1/4" = 1'-0"

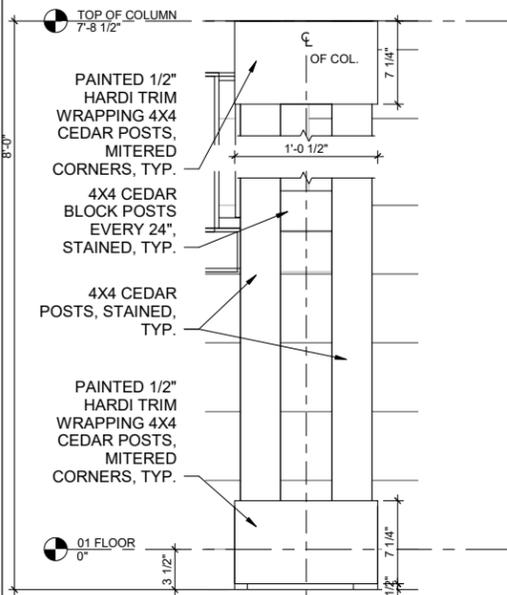

4 BUILT UP COLUMN ELEVATION
3/4" = 1'-0"

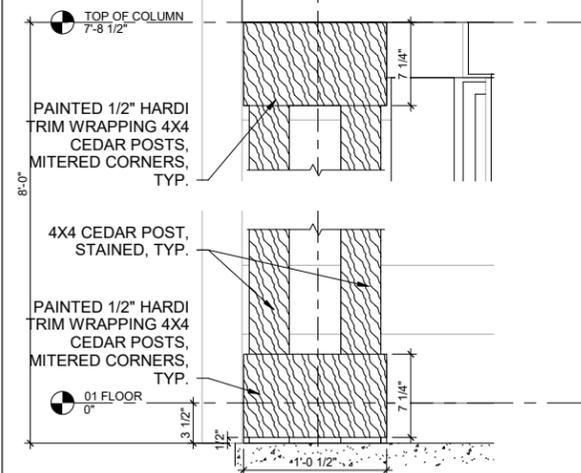


3 BUILT UP COLUMN SECTION
3/4" = 1'-0"

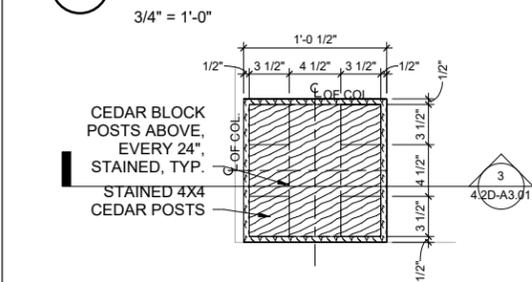

2 BUILT UP COLUMN DETAIL
3/4" = 1'-0"

2/7/2017 8:14:36 AM

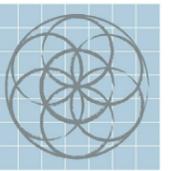

SEVENTH
GENERATION
DESIGN

ARCHITECTURE | SUSTAINABILITY | PRESERVATION

118 Broadway, Suite 519
San Antonio, Texas 78205
TEL (210) 262-6161 TEL (210) 241-7490

Urban at Olive

600 Block Burleson San
Antonio, TX

No.	Date	Description
1	02/06/2017	Construction Set



BACK ELEVATION

PROTOTYPE 4.2D




Scott William Cupron
February 6, 2017

Project number
Date February 6, 2017

Drawn by
Checked by


4.2D-A3.02

Scale

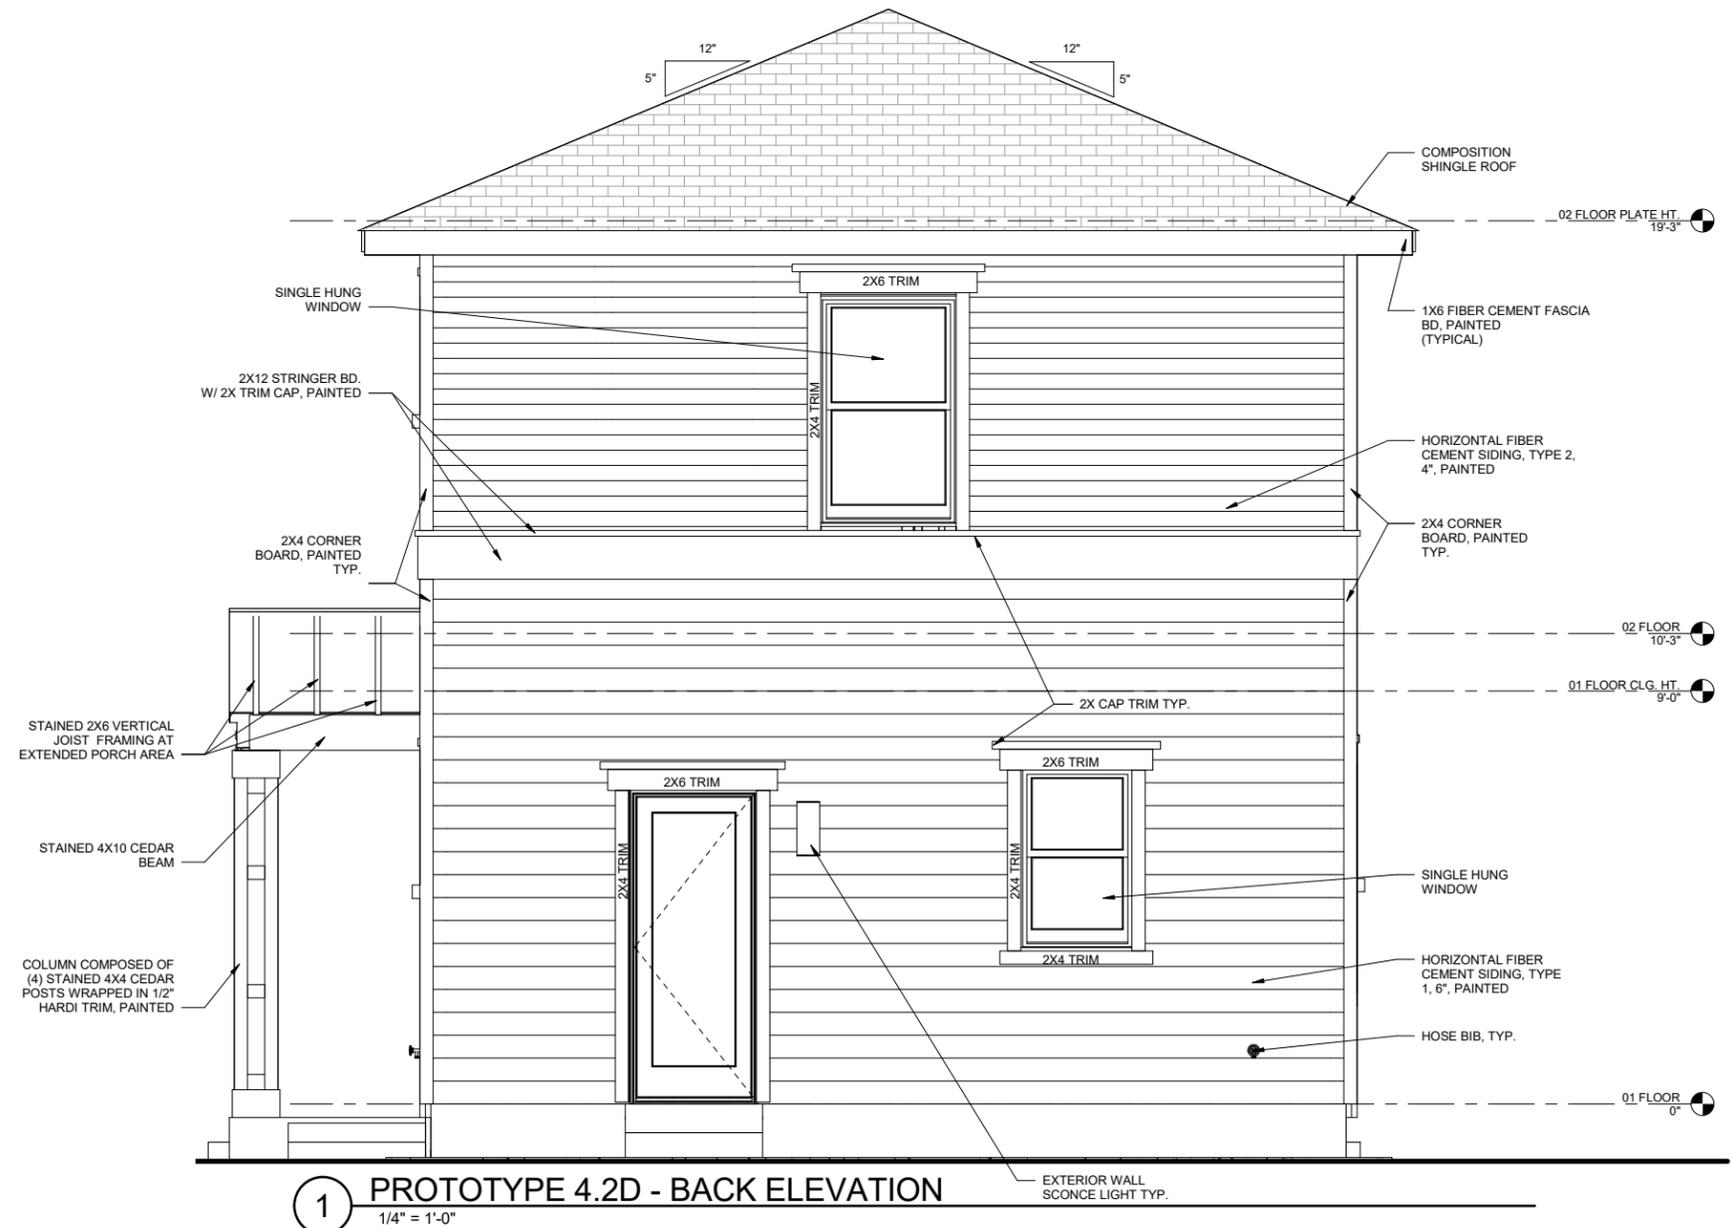

1 PROTOTYPE 4.2D - BACK ELEVATION
1/4" = 1'-0"

2/7/2017 8:16:33 AM

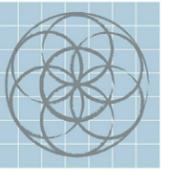

SEVENTH
GENERATION
DESIGN

ARCHITECTURE | SUSTAINABILITY | PRESERVATION

118 Broadway, Suite 519
San Antonio, Texas 78205
TEL (210) 262-6161 TEL (210) 241-7490

Urban at Olive

600 Block Burleson San
Antonio, TX

No.	Date	Description
1	02/06/2017	Construction Set



SIDE ELEVATION

PROTOTYPE 4.2D




William Cupron
February 6, 2017

Project number
Date February 6, 2017


Drawn by
Checked by

4.2D-A3.03

Scale

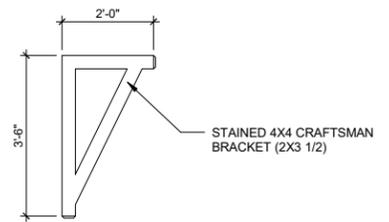


2 CRAFTSMAN BRACKET ELEVATION

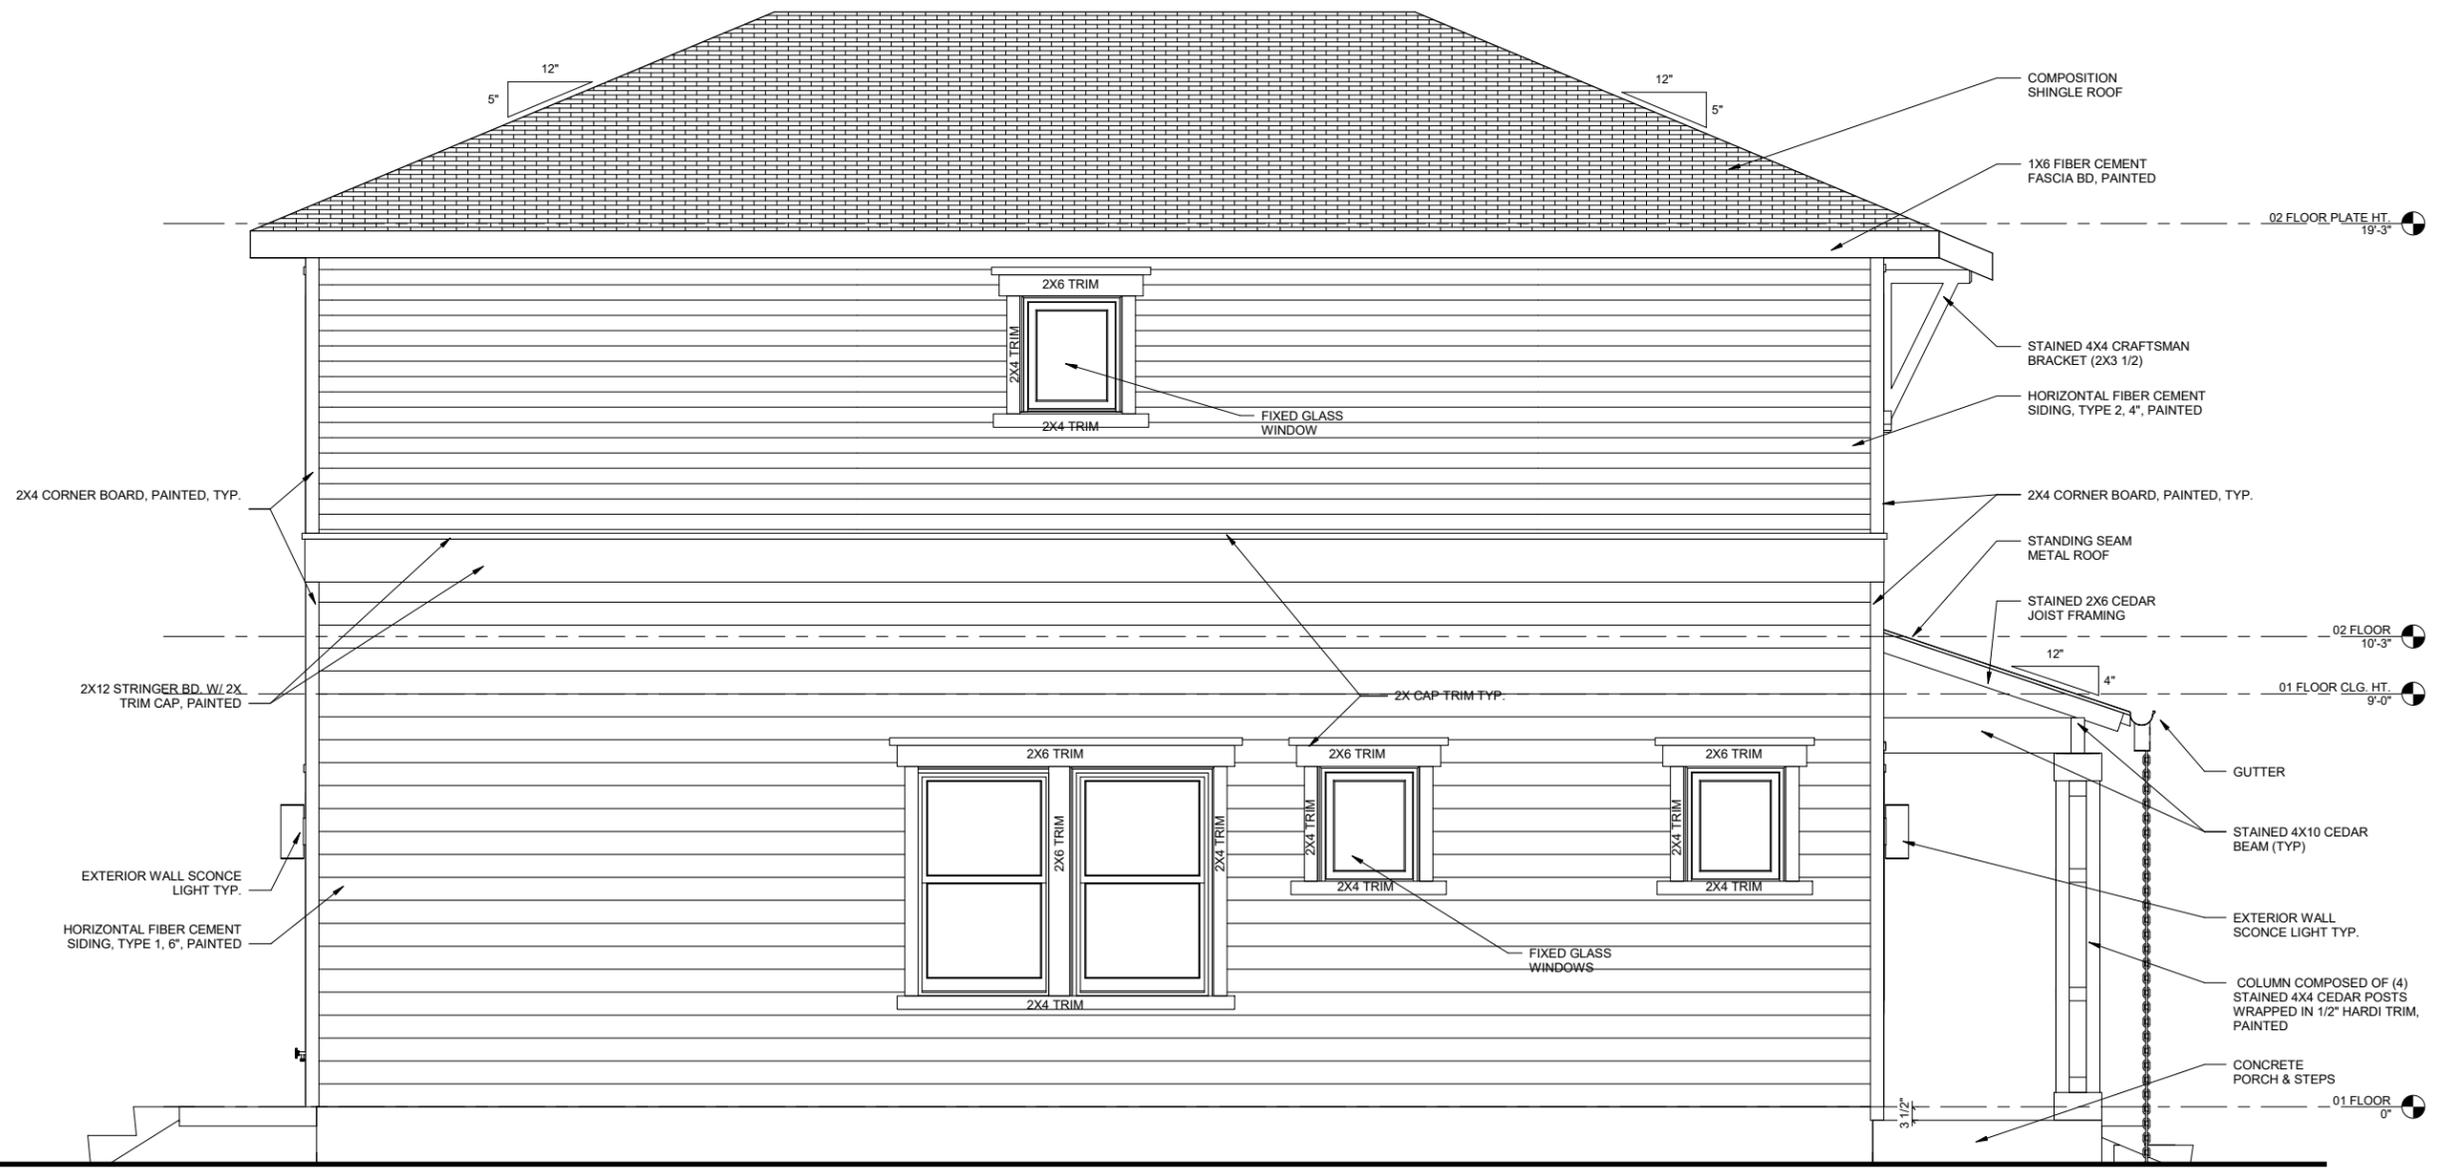

1 PROTOTYPE 4.2D - SIDE ELEVATION
1/4" = 1'-0"

2/7/2017 8:14:40 AM

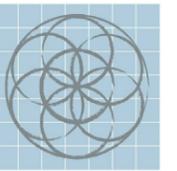

SEVENTH
GENERATION
DESIGN

ARCHITECTURE | SUSTAINABILITY | PRESERVATION

118 Broadway, Suite 519
San Antonio, Texas 78205
TEL (210) 262-6161 TEL (210) 241-7490

Urban at Olive

600 Block Burleson San
Antonio, TX

No.	Date	Description
1	02/06/2017	Construction Set



SIDE ELEVATION

PROTOTYPE 4.2D




William Clifton
February 6, 2017

Project number
Date February 6, 2017
Drawn by
Checked by

4.2D-A3.04

Scale

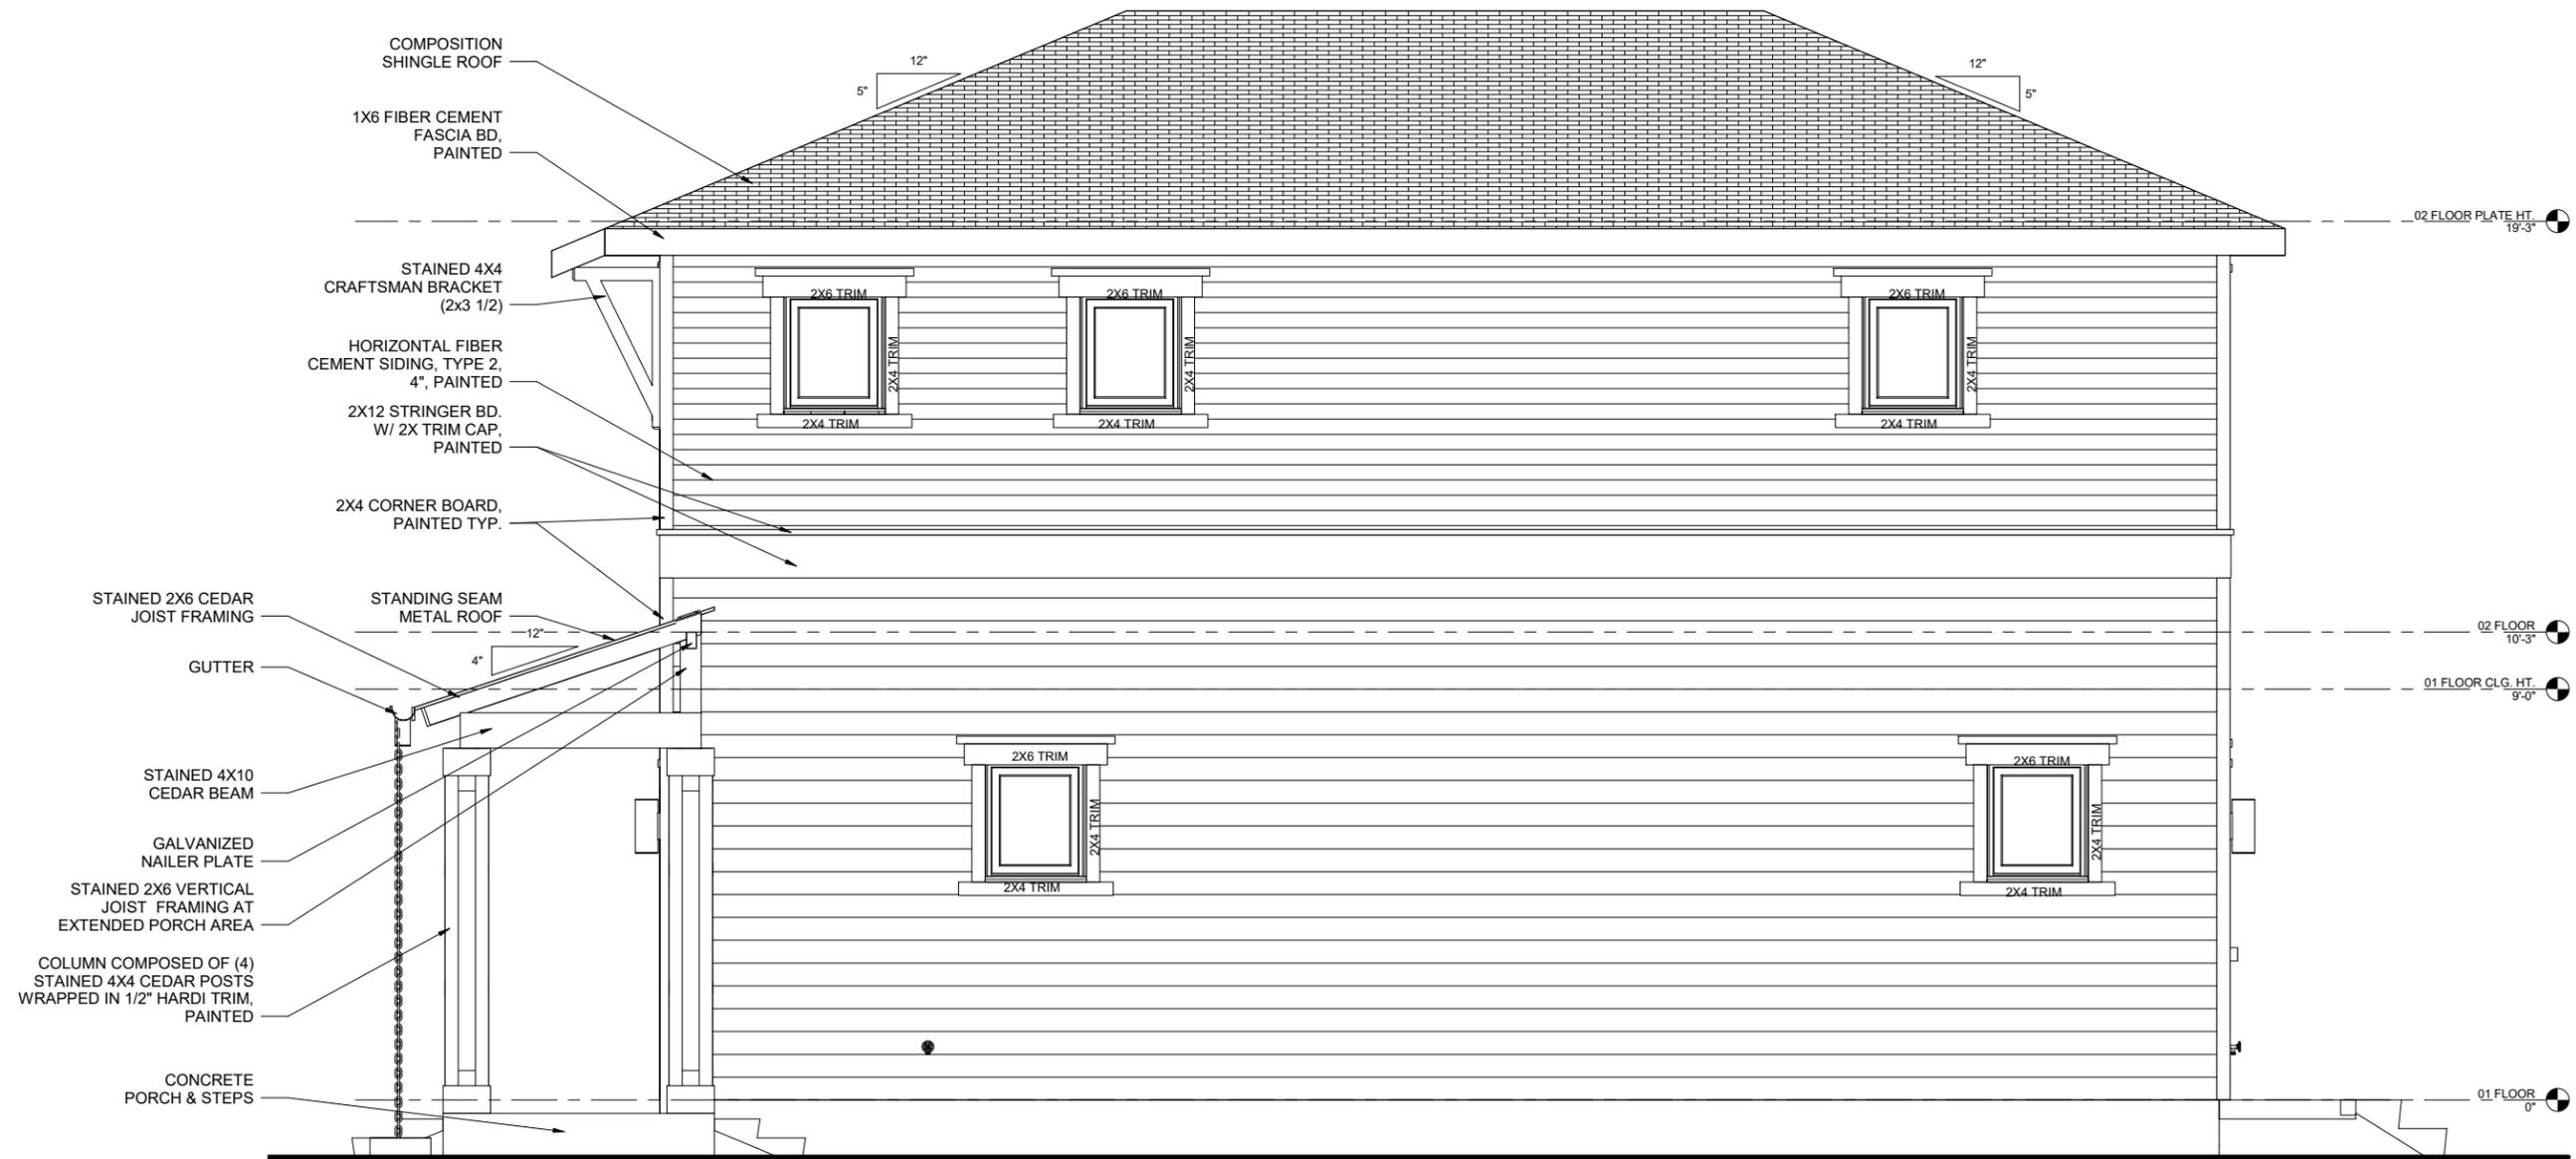


1 PROTOTYPE 4.2D - SIDE ELEVATION
1/4" = 1'-0"


2/7/2017 8:14:42 AM

INSULATION LEGEND

- INDICATES WEATHER BARRIER
- ☼ THERMAL INSULATION (DENOTES THERMAL ENVELOPE)

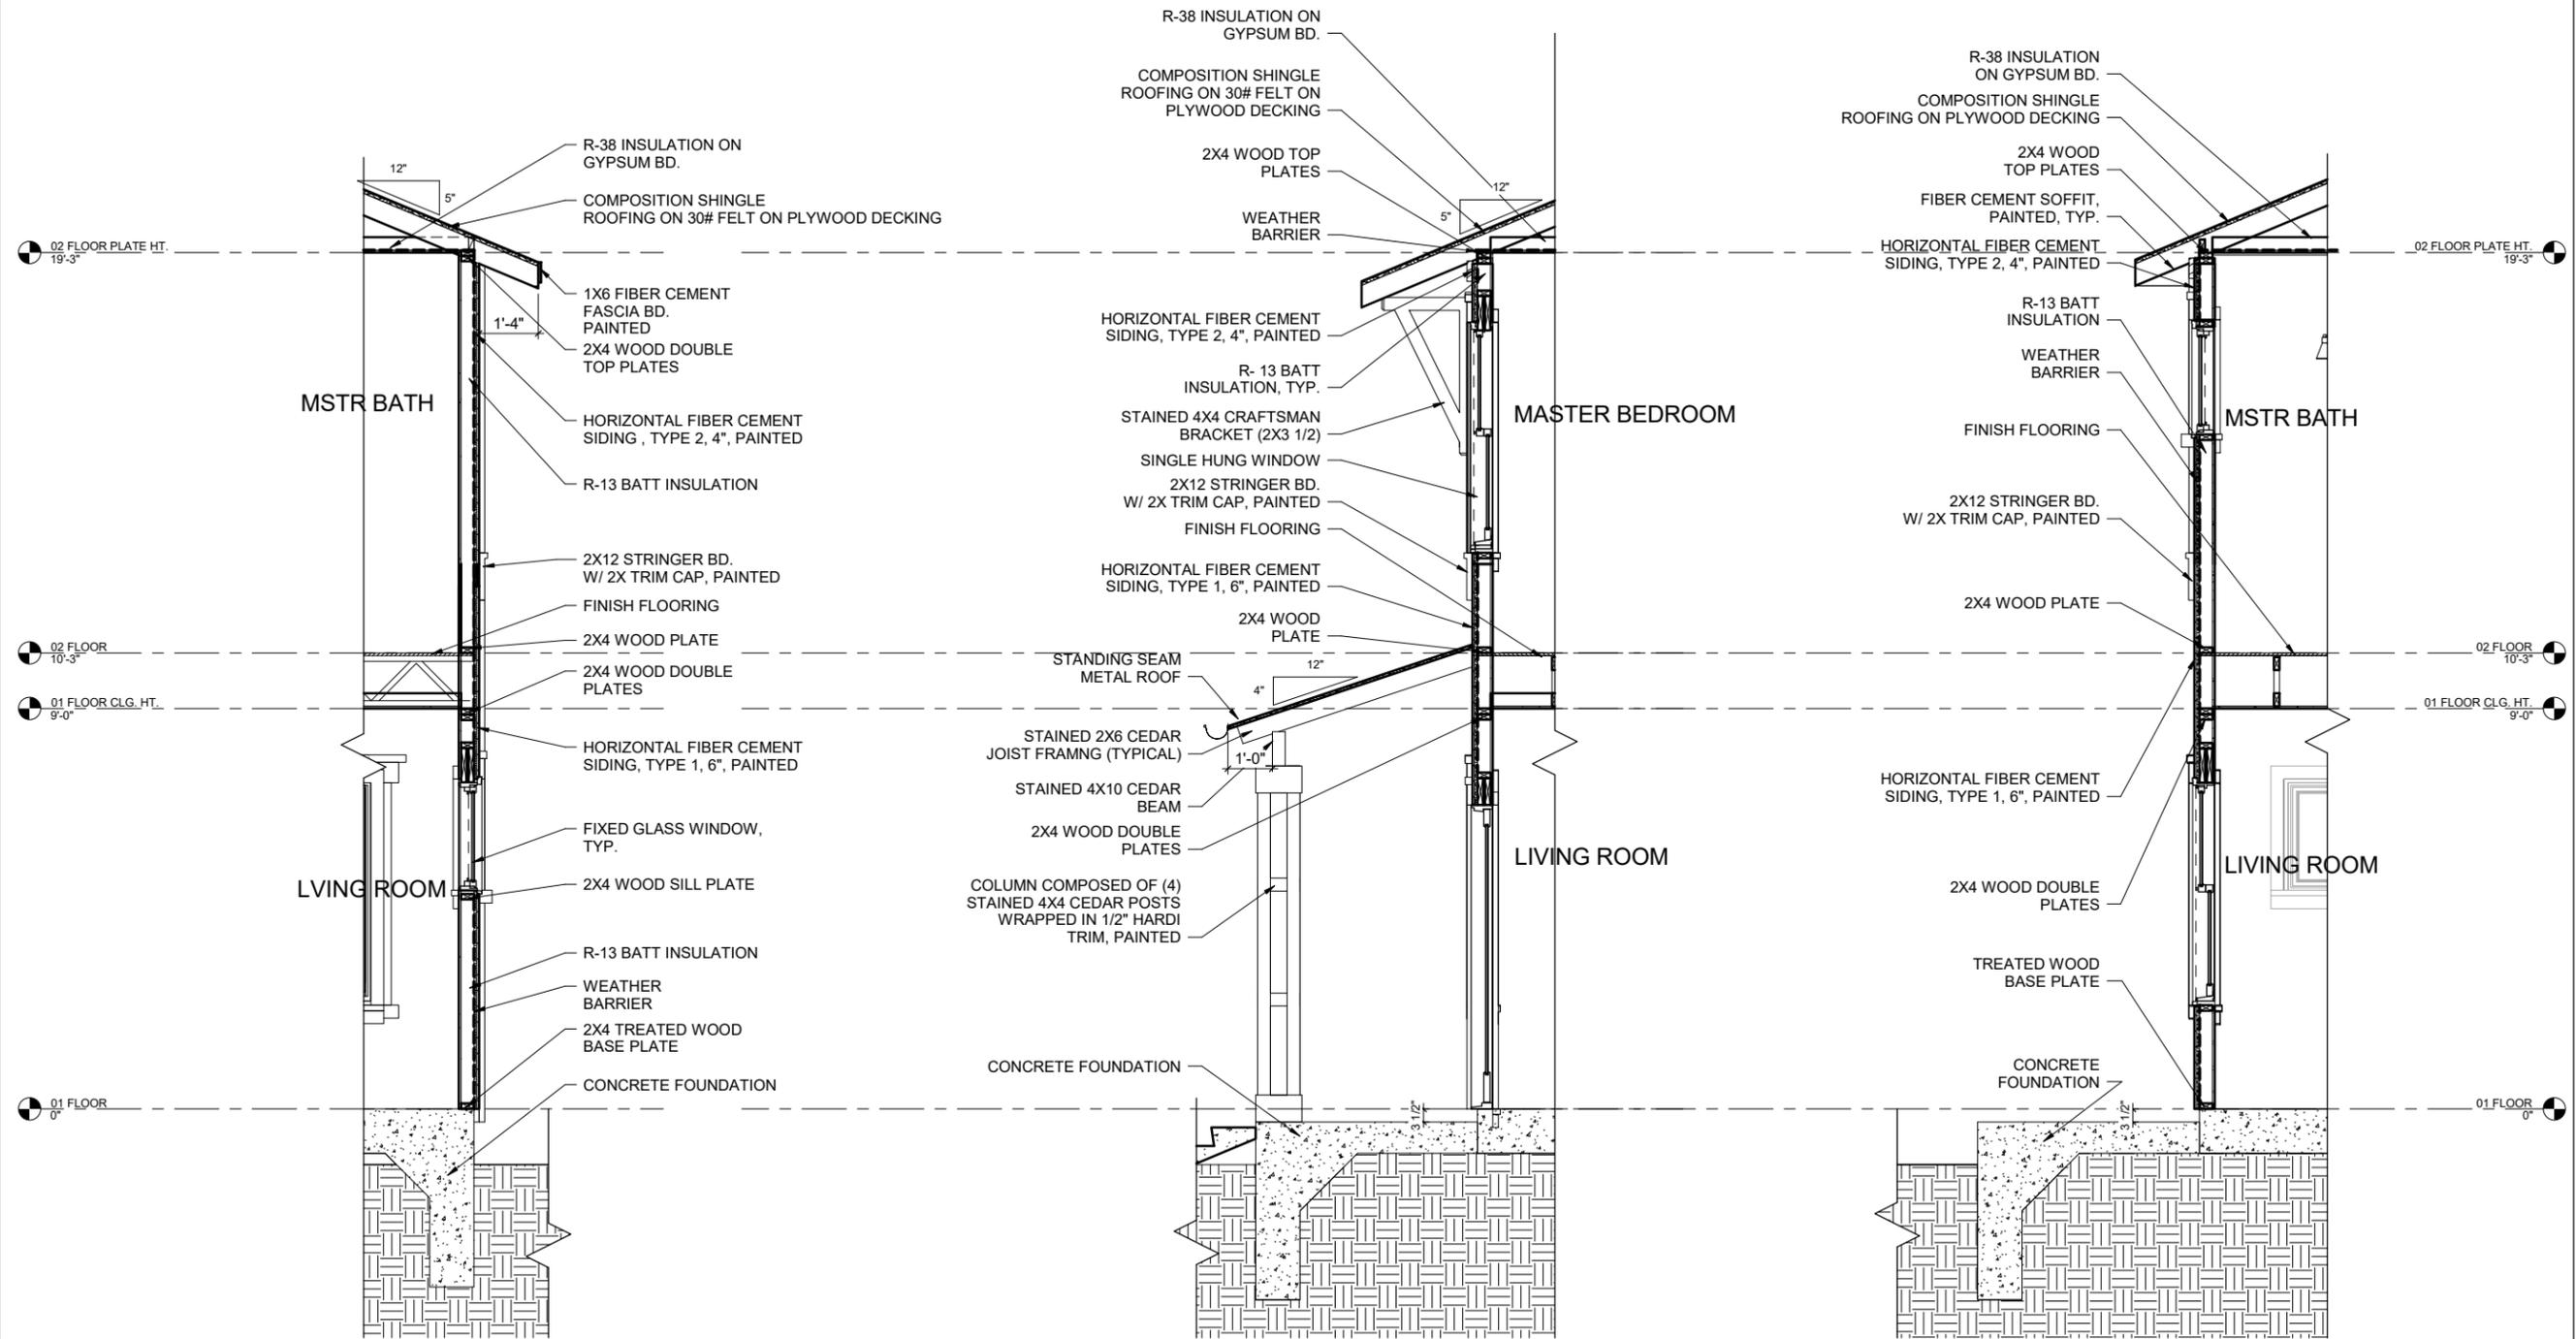

3 1/4" = 1'-0" **PROTOTYPE 4.2D - WALL SECTION AT LIVING RM** 2 1/4" = 1'-0" **PROTOTYPE 4.2D - SECTION AT FRONT WALL** 1 1/4" = 1'-0" **PROTOTYPE 4.2D - PARTIAL SECTION AT PORCH**

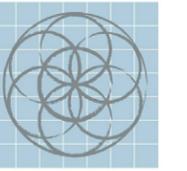

SEVENTH GENERATION DESIGN

ARCHITECTURE | SUSTAINABILITY | PRESERVATION
 118 Broadway, Suite 519
 San Antonio, Texas 78205
 TEL (210) 262-6161 TEL (210) 241-7490

Urban at Olive

600 Block Burleson San Antonio, TX

No.	Date	Description
1	02/06/2017	Construction Set



EXTERIOR SECTIONS & DETAILS


PROTOTYPE 4.2D



February 6, 2017

Project number
 Date February 6, 2017
 Drawn by
 Checked by

4.2D-A4.01
 Scale

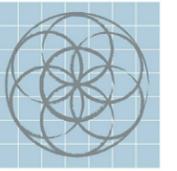

SEVENTH
GENERATION
DESIGN

ARCHITECTURE | SUSTAINABILITY | PRESERVATION

118 Broadway, Suite 519
San Antonio, Texas 78205
TEL (210) 262-6161 TEL (210) 241-7490

Urban at Olive

600 Block Burleson San
Antonio, TX

No.	Date	Description
1	02/06/2017	Construction Set



STAIR PLANS,
SECTIONS & DETAILS

PROTOTYPE 4.2D



William C. Carpenter
February 6, 2017

Project number
Date February 6, 2017


Drawn by
Checked by

4.2D-A4.02


Scale

INSULATION LEGEND


INDICATES WEATHER BARRIER
THERMAL INSULATION (DENOTES THERMAL ENVELOPE)

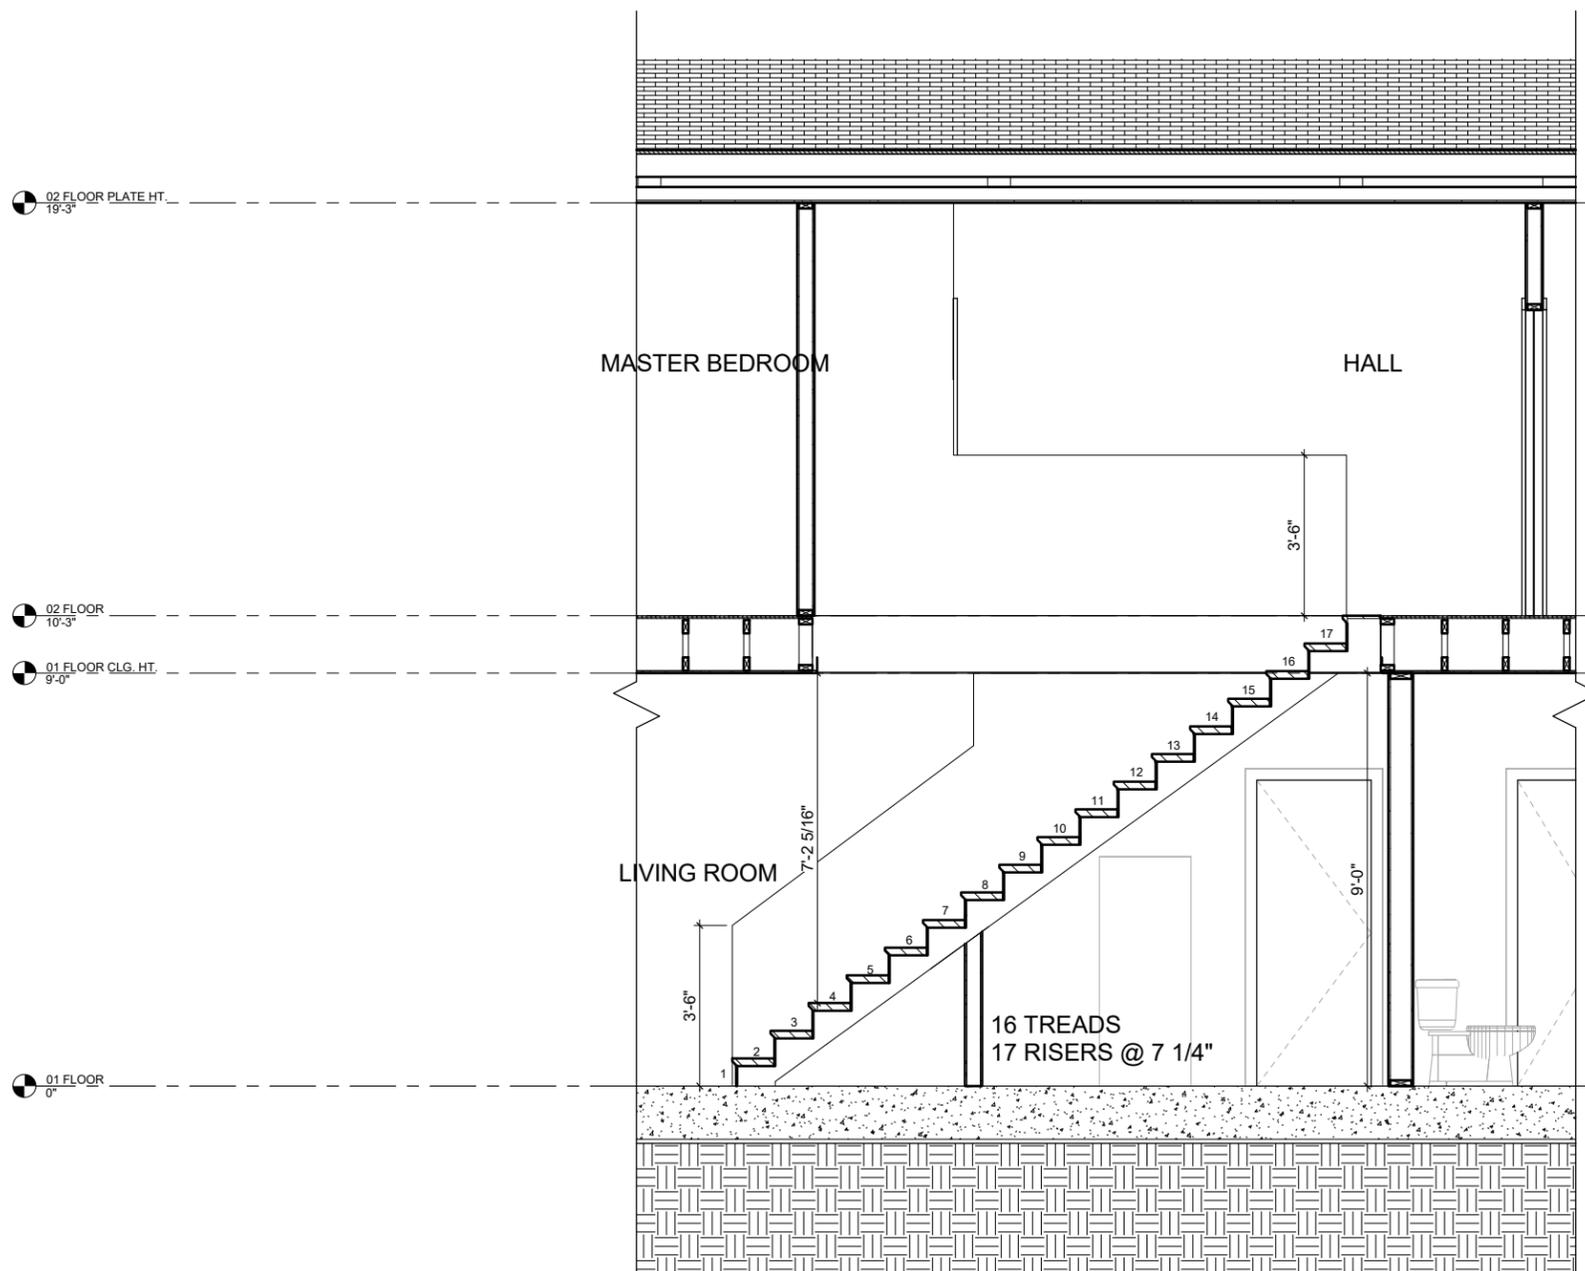

2 PR. 4.2D - STAIRS SECTION
1/4" = 1'-0"

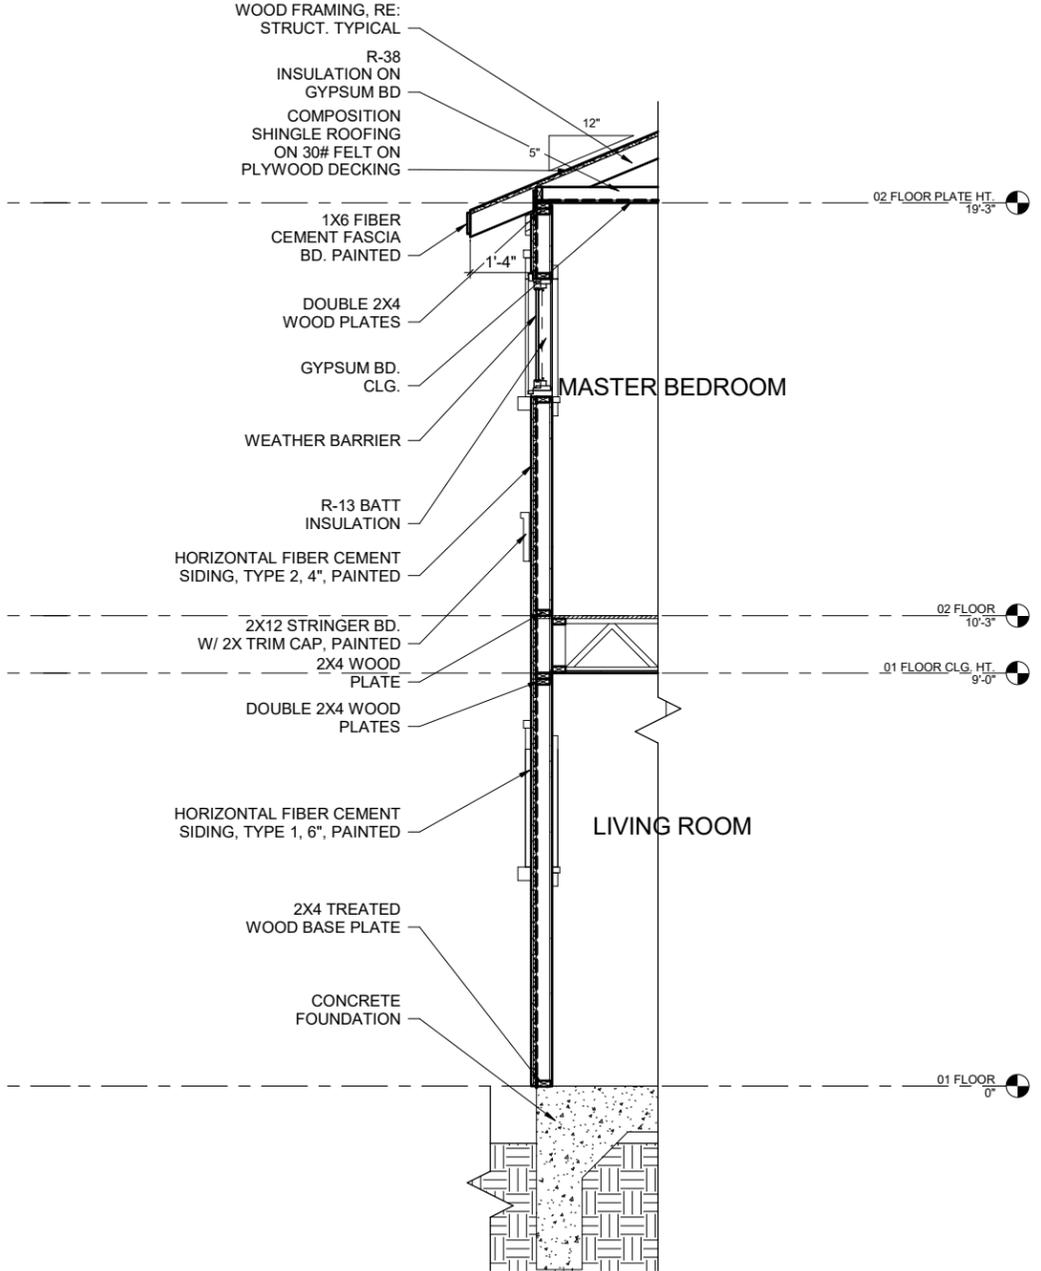

1 PR. 4.2D - WALL SECTION, TYP.
1/4" = 1'-0"

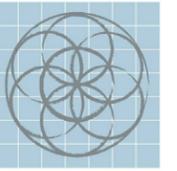

SEVENTH GENERATION DESIGN

ARCHITECTURE | SUSTAINABILITY | PRESERVATION
118 Broadway, Suite 519
San Antonio, Texas 78205
TEL (210) 262-6161 TEL (210) 241-7490

Urban at Olive

600 Block Burleson San Antonio, TX

No.	Date	Description
1	02/06/2017	Construction Set



INTERIOR ELEVATIONS & DETAILS
PROTOTYPE 4.2A OR 4.2B




February 6, 2017

Project number
Date February 6, 2017
Drawn by
Checked by


4.2-A5.01

Scale

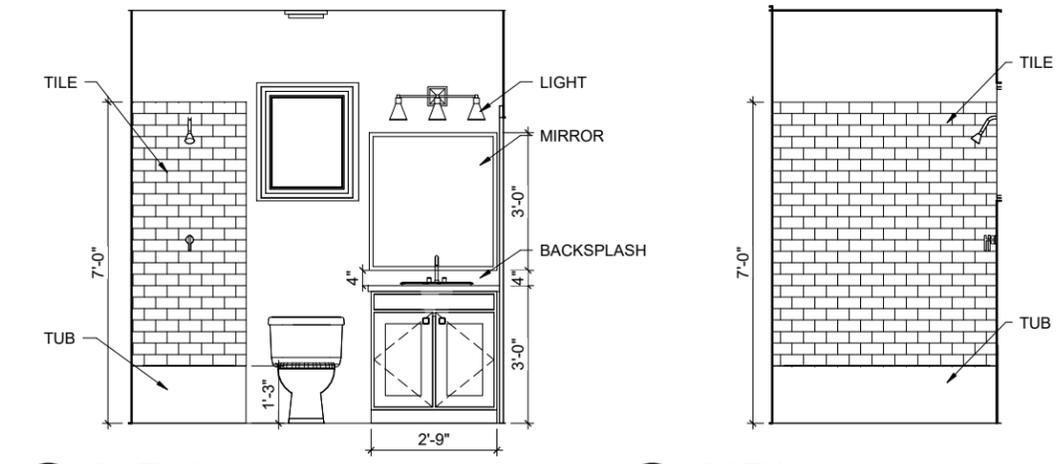


11 BATH 2 c
1/4" = 1'-0"


10 BATH 2 b
1/4" = 1'-0"

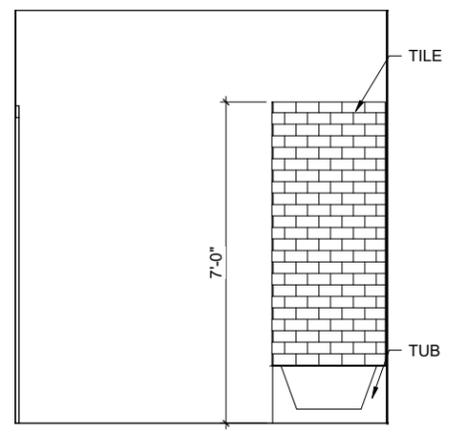

9 BATH 2 a
1/4" = 1'-0"

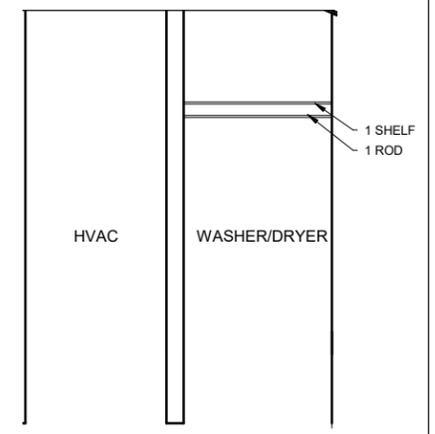


8 UTILITY
1/4" = 1'-0"

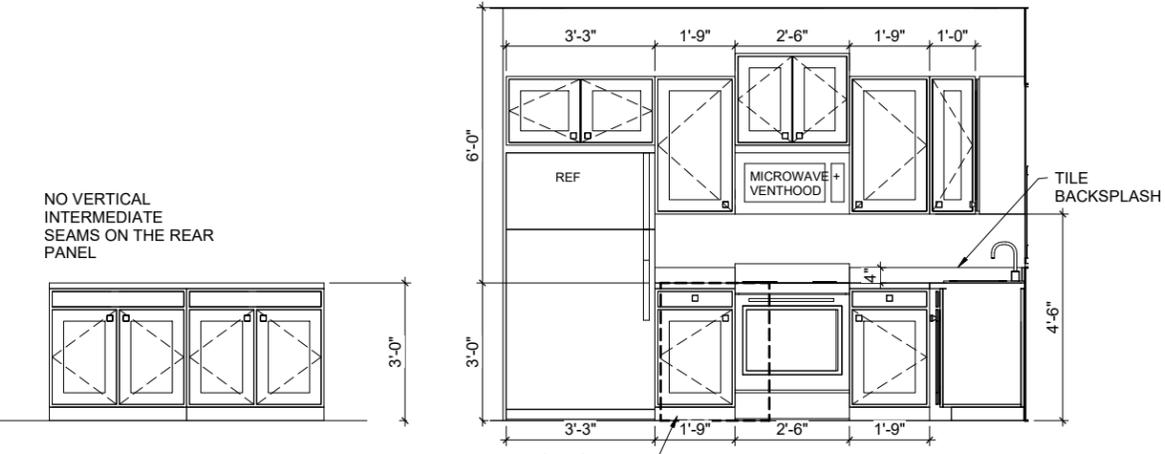


7 OPTIONAL ISLAND
1/4" = 1'-0"


6 KITCHEN b
1/4" = 1'-0"

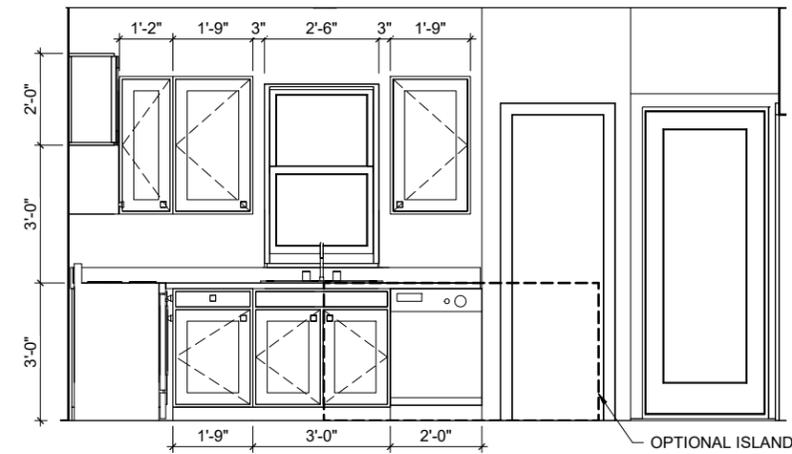


5 KITCHEN a
1/4" = 1'-0"

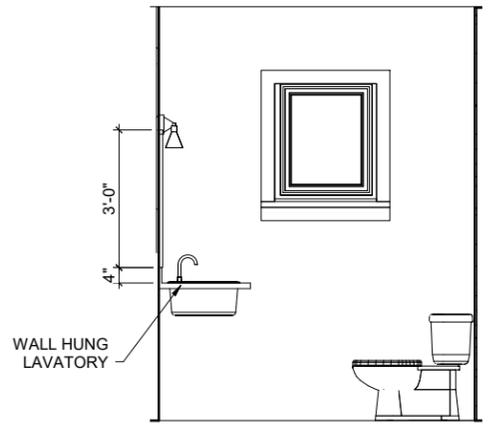


4 PWDR
1/4" = 1'-0"

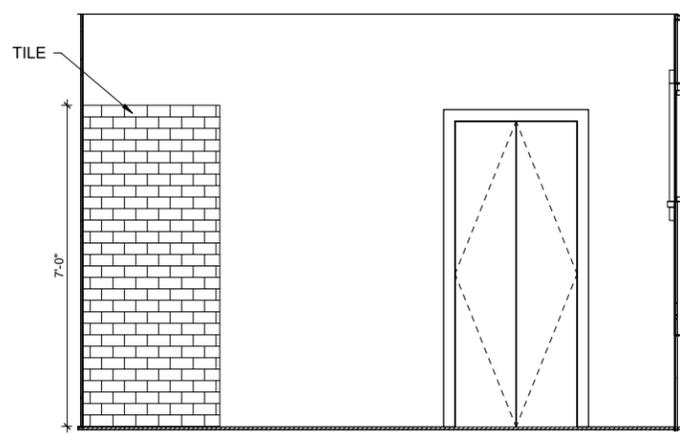


3 MSTR BATH c
1/4" = 1'-0"

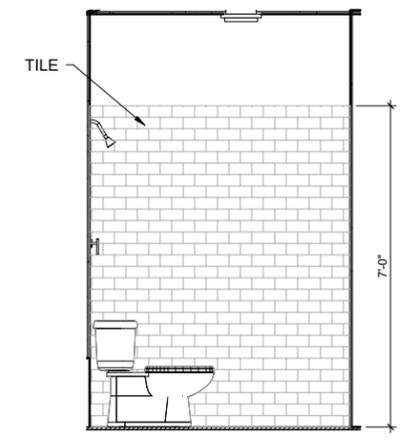

2 MSTR BATH b
1/4" = 1'-0"

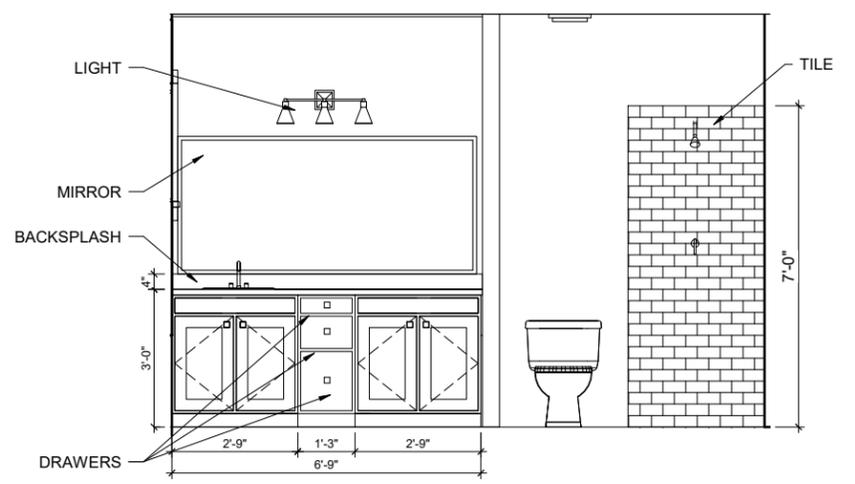

1 MSTR BATH a
1/4" = 1'-0"

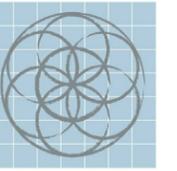

SEVENTH GENERATION DESIGN

ARCHITECTURE | SUSTAINABILITY | PRESERVATION

118 Broadway, Suite 519
San Antonio, Texas 78205
TEL (210) 262-6161 TEL (210) 241-7490

Urban at Olive

600 Block Burleson San Antonio, TX

No.	Date	Description
1	02/06/2017	Construction Set



OPTIONAL GARAGE

PROTOTYPE 4.2A, 4.2B, 4.2C, 4.2D




February 6, 2017

Project number
Date February 6, 2017


Drawn by
Checked by

4.2-A5.02


Scale

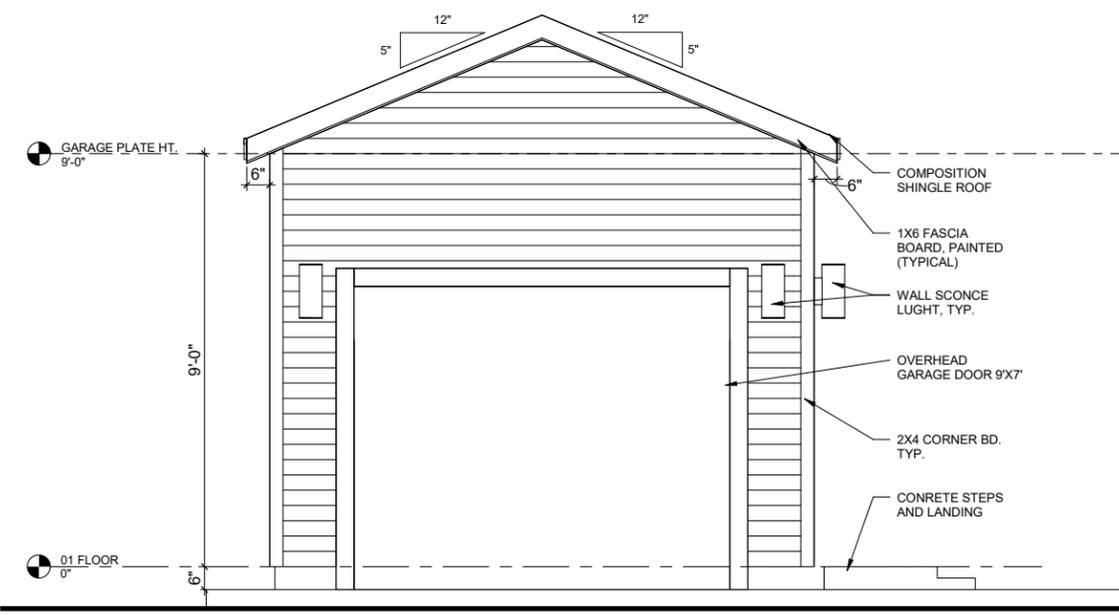

3 FRONT ELEVATION PROTOTYPE 4.2A, 4.2B, 4.2C, 4.2D
1/4" = 1'-0"

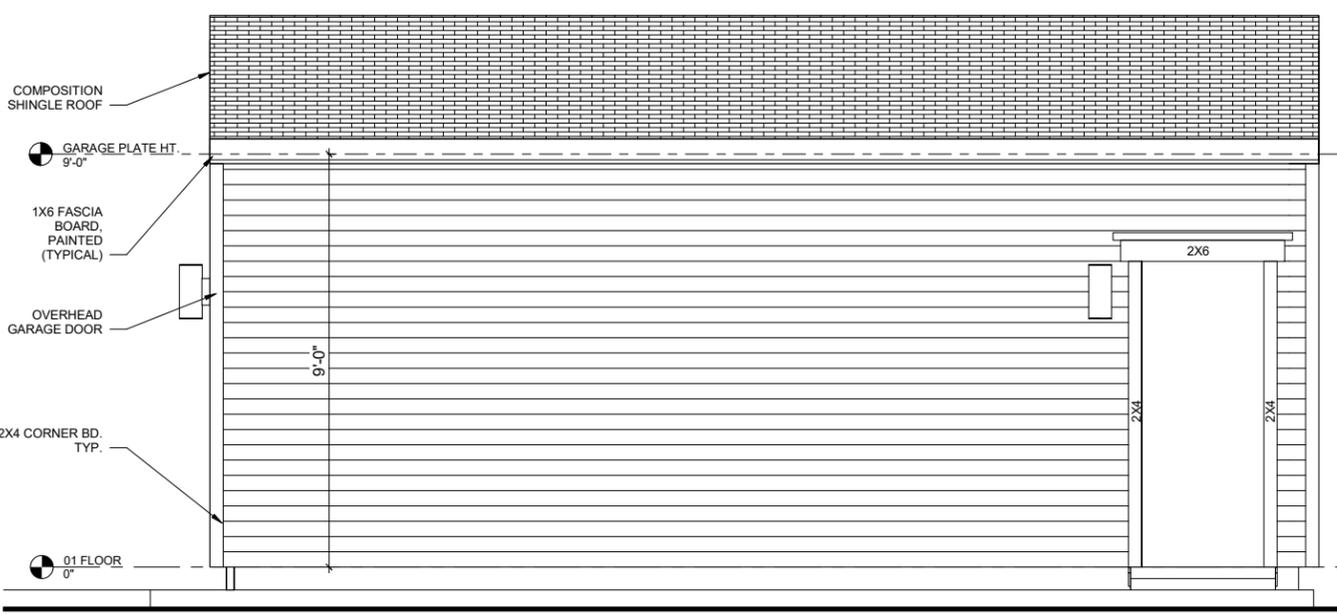


2 SIDE ELEVATION PROTOTYPE 4.2A, 4.2B, 4.2C, 4.2D
1/4" = 1'-0"

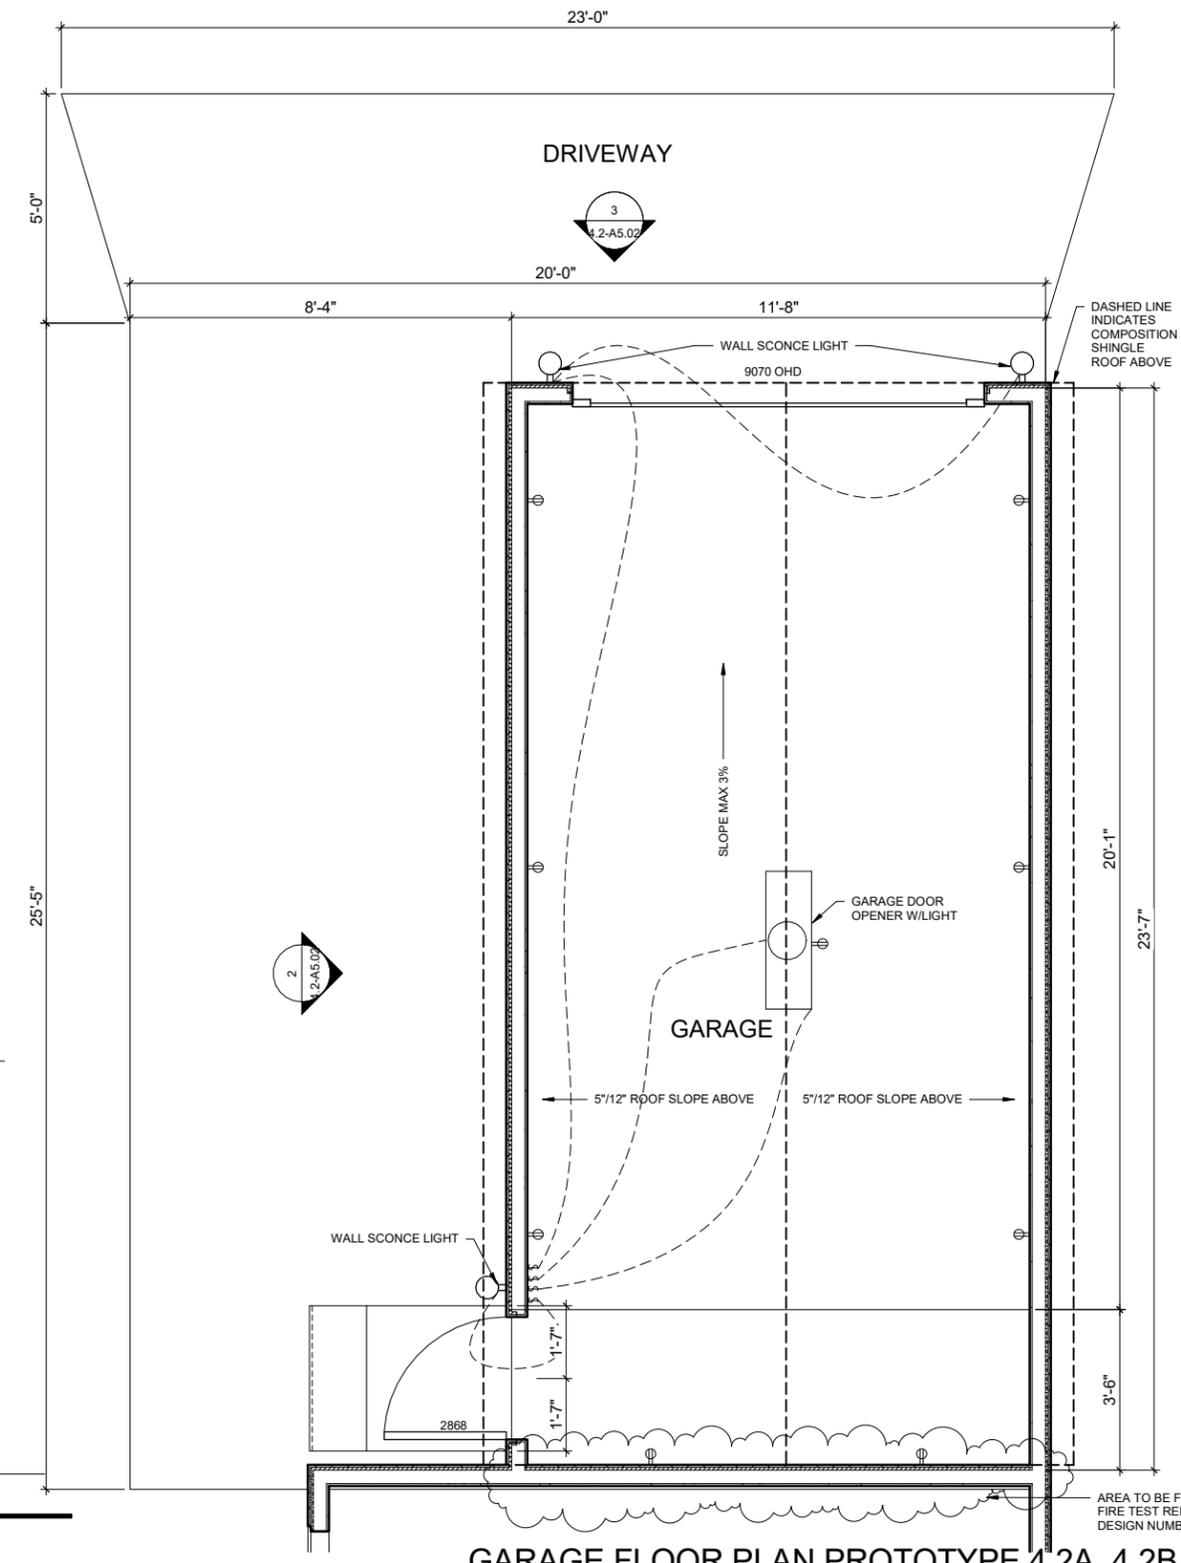

1 GARAGE FLOOR PLAN PROTOTYPE 4.2A, 4.2B, 4.2C, 4.2D
1/4" = 1'-0"

2/13/2017 4:15:02 PM

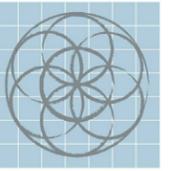

SEVENTH
GENERATION
DESIGN

ARCHITECTURE | SUSTAINABILITY | PRESERVATION

118 Broadway, Suite 519
San Antonio, Texas 78205
TEL (210) 262-6161 TEL (210) 241-7490

Urban at Olive

600 Block Burleson San
Antonio, TX

No.	Date	Description
1	02/06/2017	Construction Set



OPTIONAL CARPORT

PROTOTYPE 4.2A
OR 4.2B



February 6, 2017


Project number
Date February 6, 2017
Drawn by
Checked by

4.2-A5.03


Scale

GENERAL NOTES:


1. USE JOIST HANGERS AT EVERY 2X6 AND 2X8 FRAMING JOISTS.

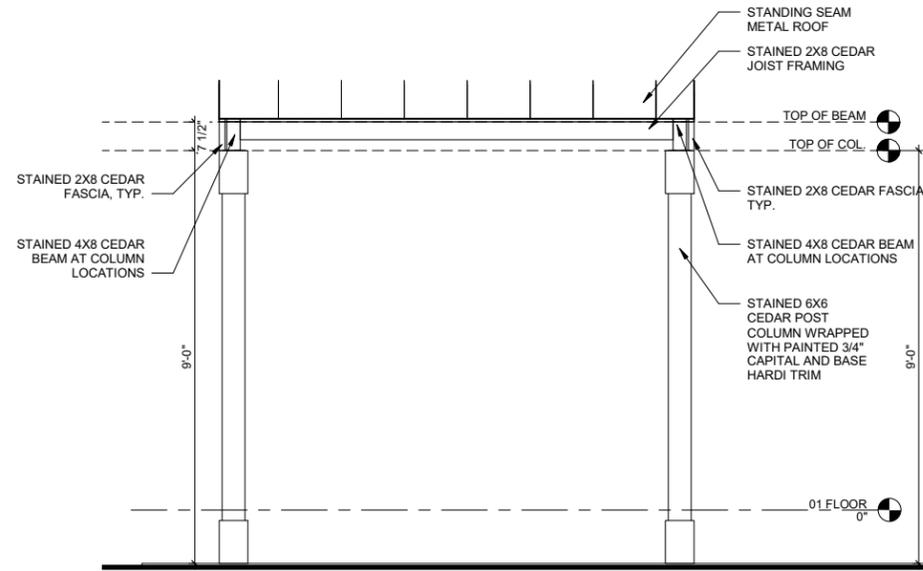

3 FRONT ELEVATION PROTOTYPE 4.2A OR 4.2B
1/4" = 1'-0"

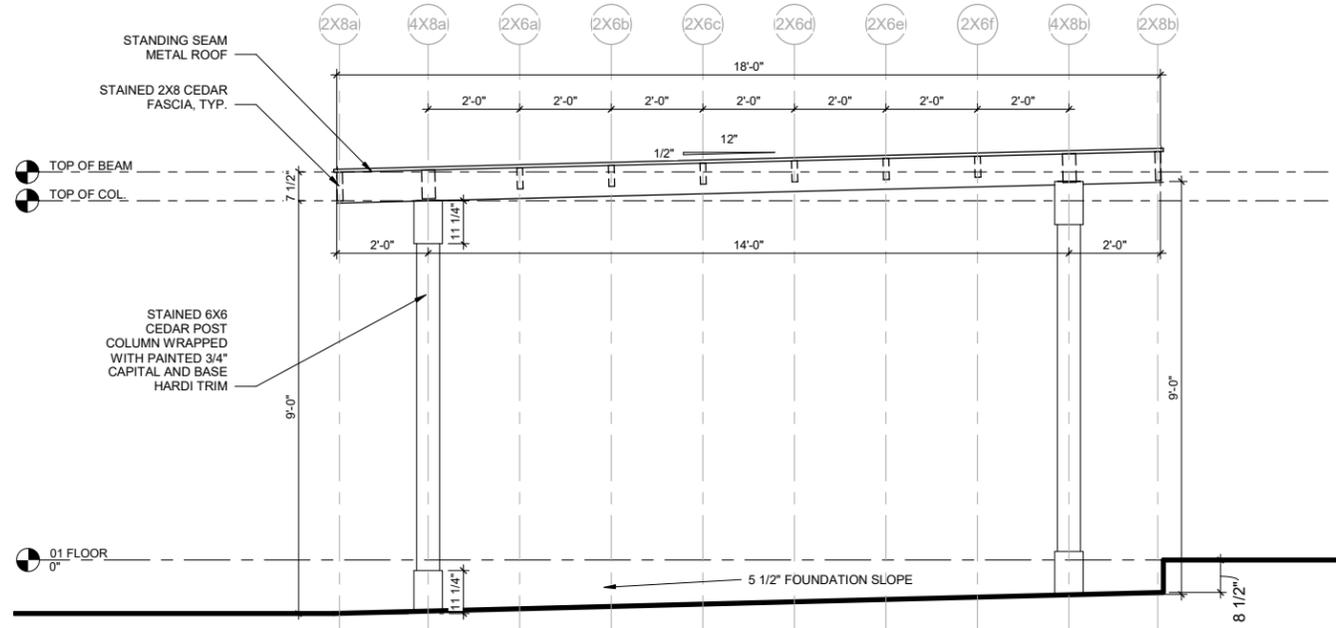

2 SIDE ELEVATION PROTOTYPE 4.2A OR 4.2B
1/4" = 1'-0"

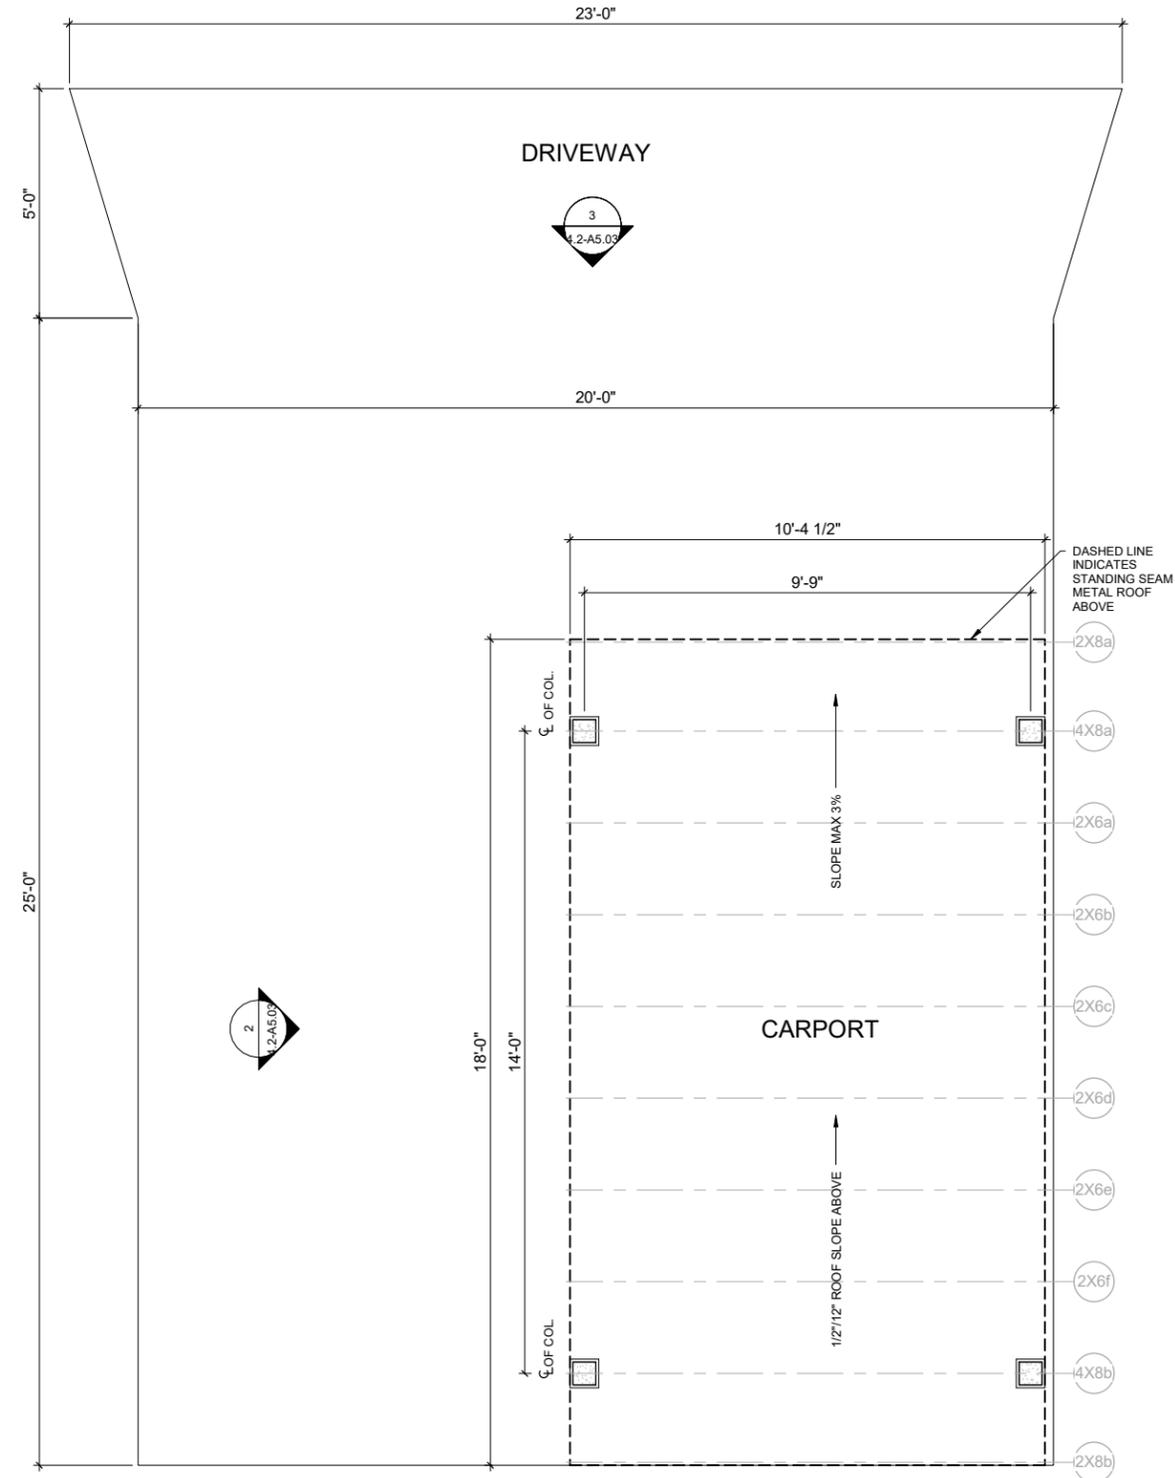

1 CARPORT FLOOR PLAN PROTOTYPE 4.2A OR 4.2B
1/4" = 1'-0"


Urban at Olive - PROTOTYPE 4.2C

TERRAMARK Urban Homes

CONSTRUCTION SET

600 Block Burleson San Antonio, TX

February 6, 2017

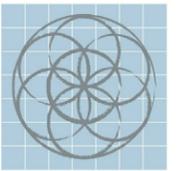

SEVENTH
GENERATION
DESIGN

ARCHITECTURE | SUSTAINABILITY | PRESERVATION

118 Broadway, Suite 519
San Antonio, Texas 78205
TEL (210) 262-6161 TEL (210) 241-7490



SKETCH IS CONCEPTUAL ONLY NOT FOR CONSTRUCTION

SHEET INDEX - PROTOTYPE 4.2C

NUMBER	NAME
4.2C-A0.00	COVER SHEET
4.2C-A2.03	01 FLOOR PLAN
4.2C-A2.04	02 FLOOR PLAN
4.2C-A2.05	ROOF PLAN
4.2C-A2.06	01 REFLECTED CEILING PLAN
4.2C-A2.07	02 REFLECTED CEILING PLAN
4.2C-A3.01	FRONT ELEVATION
4.2C-A3.02	BACK ELEVATION
4.2C-A3.03	SIDE ELEVATION
4.2C-A3.04	SIDE ELEVATION
4.2C-A4.01	EXTERIOR SECTIONS & DETAIL
4.2C-A4.02	STAIR PLANS SECTIONS & DETAILS
4.2-A5.01	INTERIOR ELEVATIONS & DETAILS
4.2-A5.02	OPTIONAL GARAGE
4.2-A5.03	OPTIONAL CARPORT

Urban at Olive

600 Block Burleson San
Antonio, TX


No.	Date	Description
1	02/06/2017	Construction Set

TERRAMARK
URBAN HOMES



William Carpenter

February 6, 2017

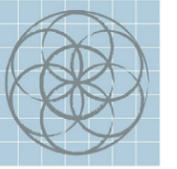

SEVENTH
GENERATION
DESIGN

ARCHITECTURE | SUSTAINABILITY | PRESERVATION

118 Broadway, Suite 519
San Antonio, Texas 78205
TEL (210) 262-6161 TEL (210) 241-7490

Urban at Olive

600 Block Burleson San
Antonio, TX

No.	Date	Description
1	02/06/2017	Construction Set



01 FLOOR PLAN

PROTOTYPE 4.2C




Scott William Carpenter
February 6, 2017

Project number
Date February 6, 2017
Drawn by
Checked by


4.2C-A2.03

Scale

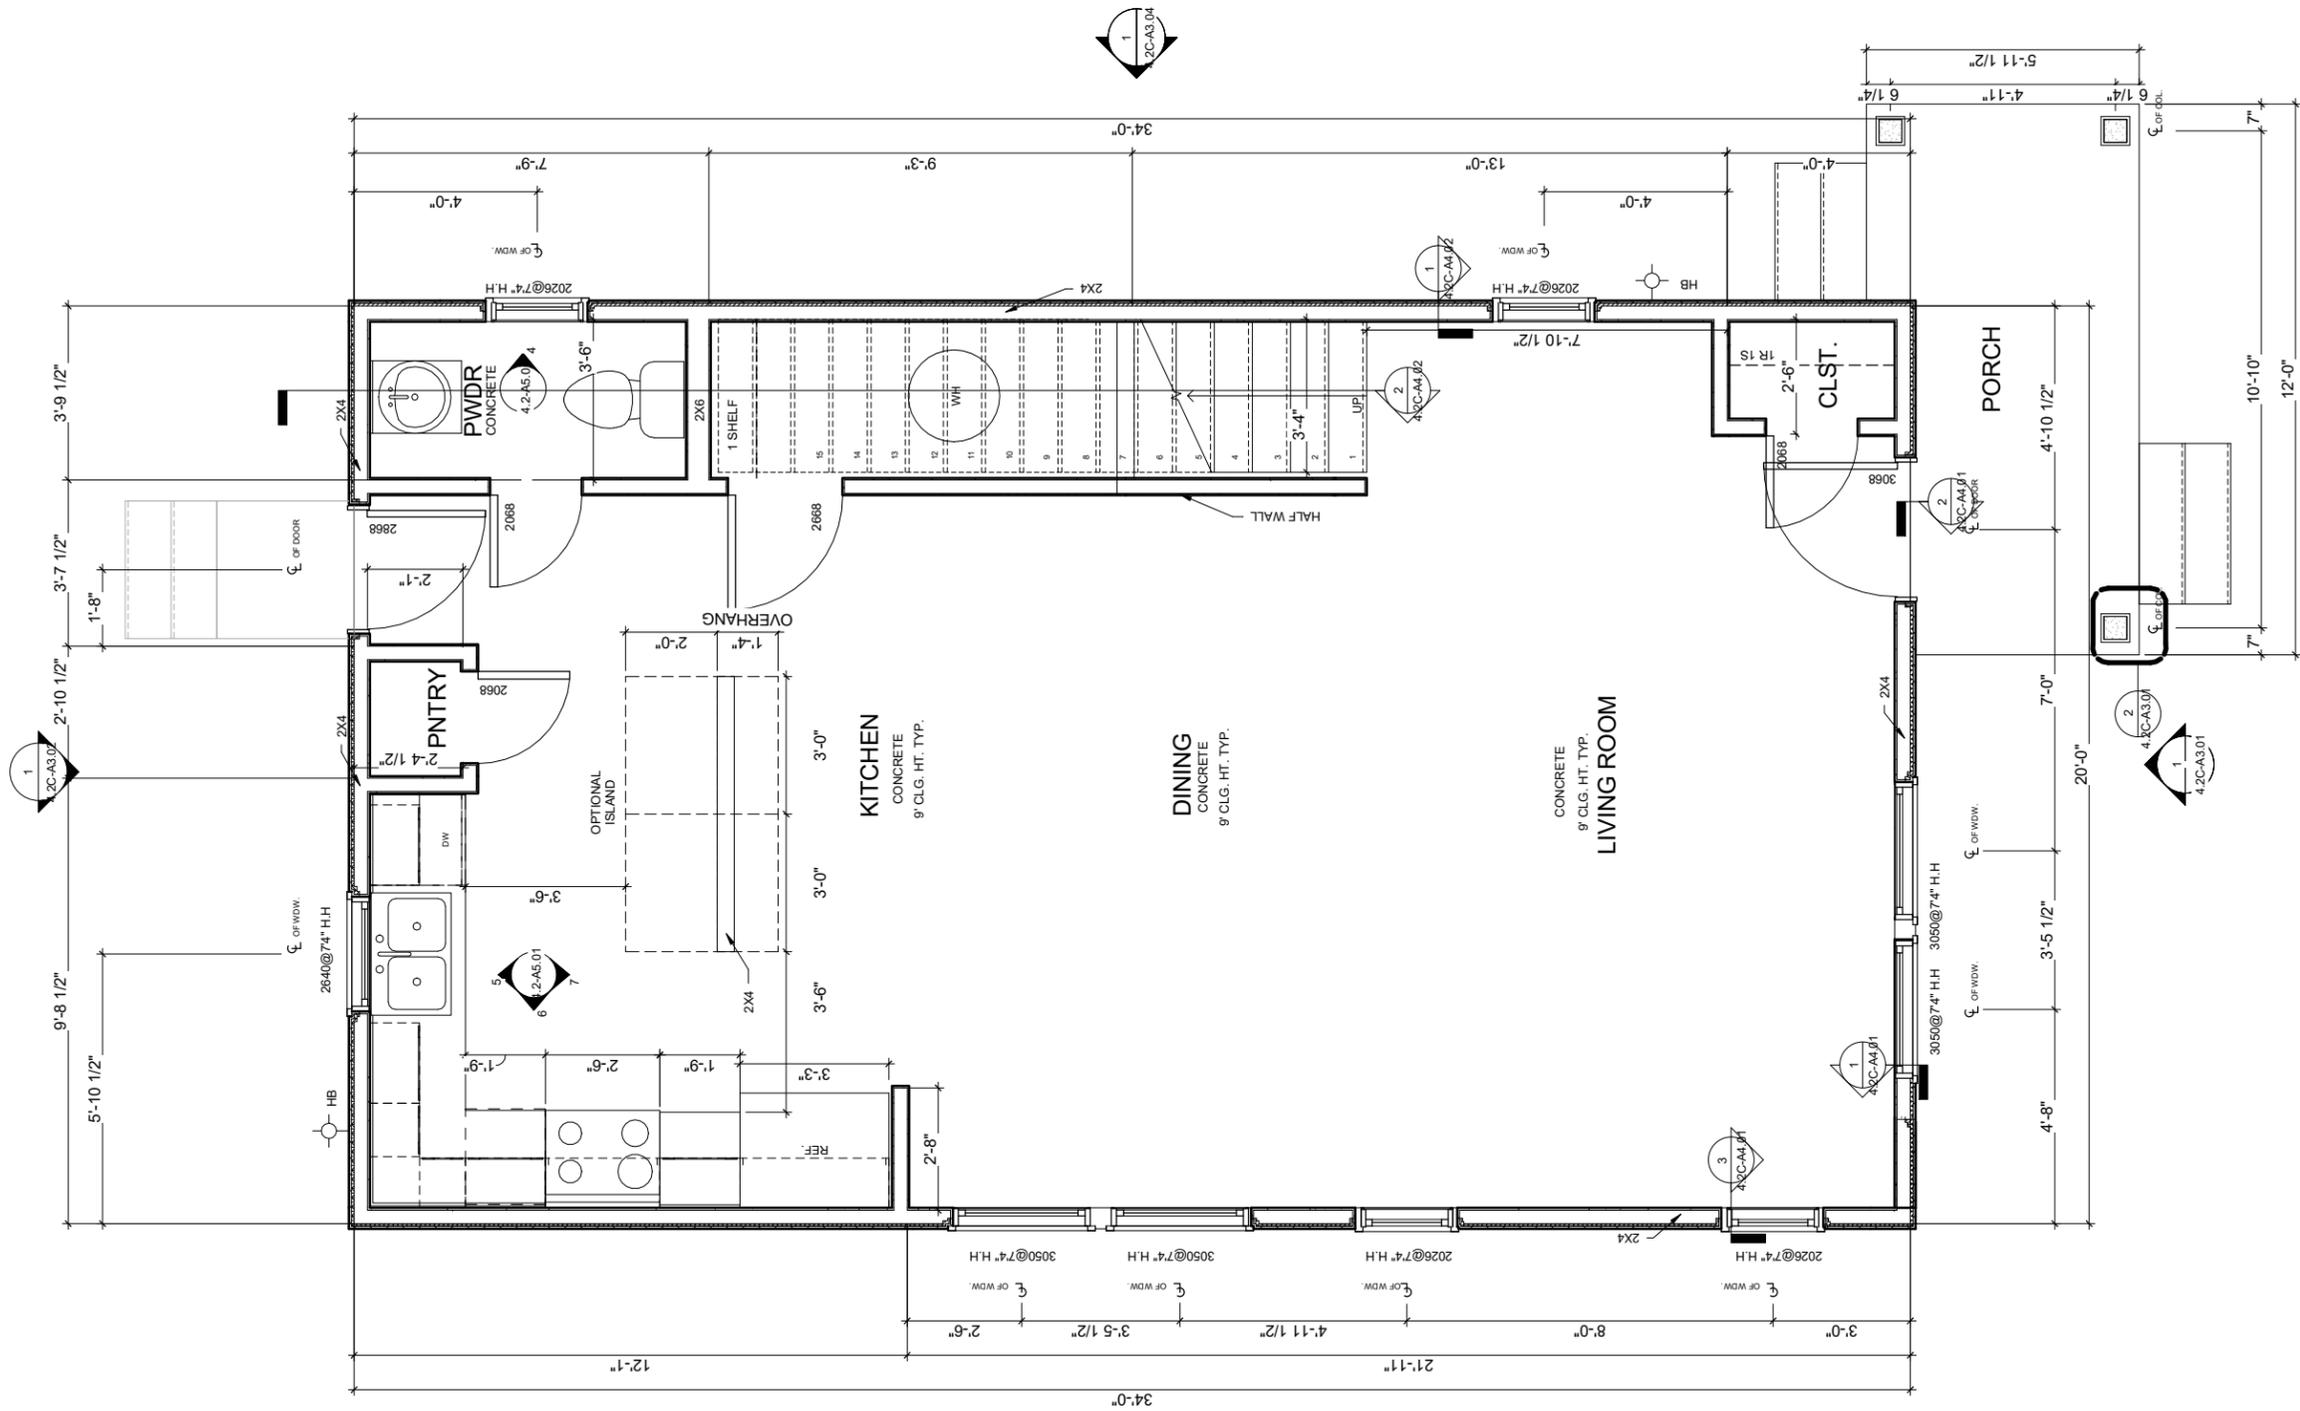

1 PROTOTYPE 4.2C - FIRST FLOOR
1/4" = 1'-0"

OVERALL LIVING + ROOF AREAS	
NAME	AREA
1ST FLOOR LIVING	680 S.F.
2ND FLOOR LIVING	632 S.F.
TOTAL LIVING	1312 S.F.
FRONT PORCH	64 S.F.
TOTAL STRUCTURE	1,376 S.F.
COMP. ROOF AREA	915 S.F.
METAL ROOF AREA	109 S.F.

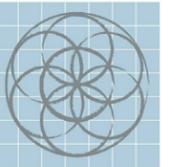

SEVENTH
GENERATION
DESIGN

ARCHITECTURE | SUSTAINABILITY | PRESERVATION

118 Broadway, Suite 519
San Antonio, Texas 78205
TEL (210) 262-6161 TEL (210) 241-7490

Urban at Olive

600 Block Burleson San
Antonio, TX

No.	Date	Description
1	02/06/2017	Construction Set



02 FLOOR PLAN

PROTOTYPE 4.2C




Scott William Carpenter
February 6, 2017

Project number
Date February 6, 2017

Drawn by
Checked by

4.2C-A2.04


Scale

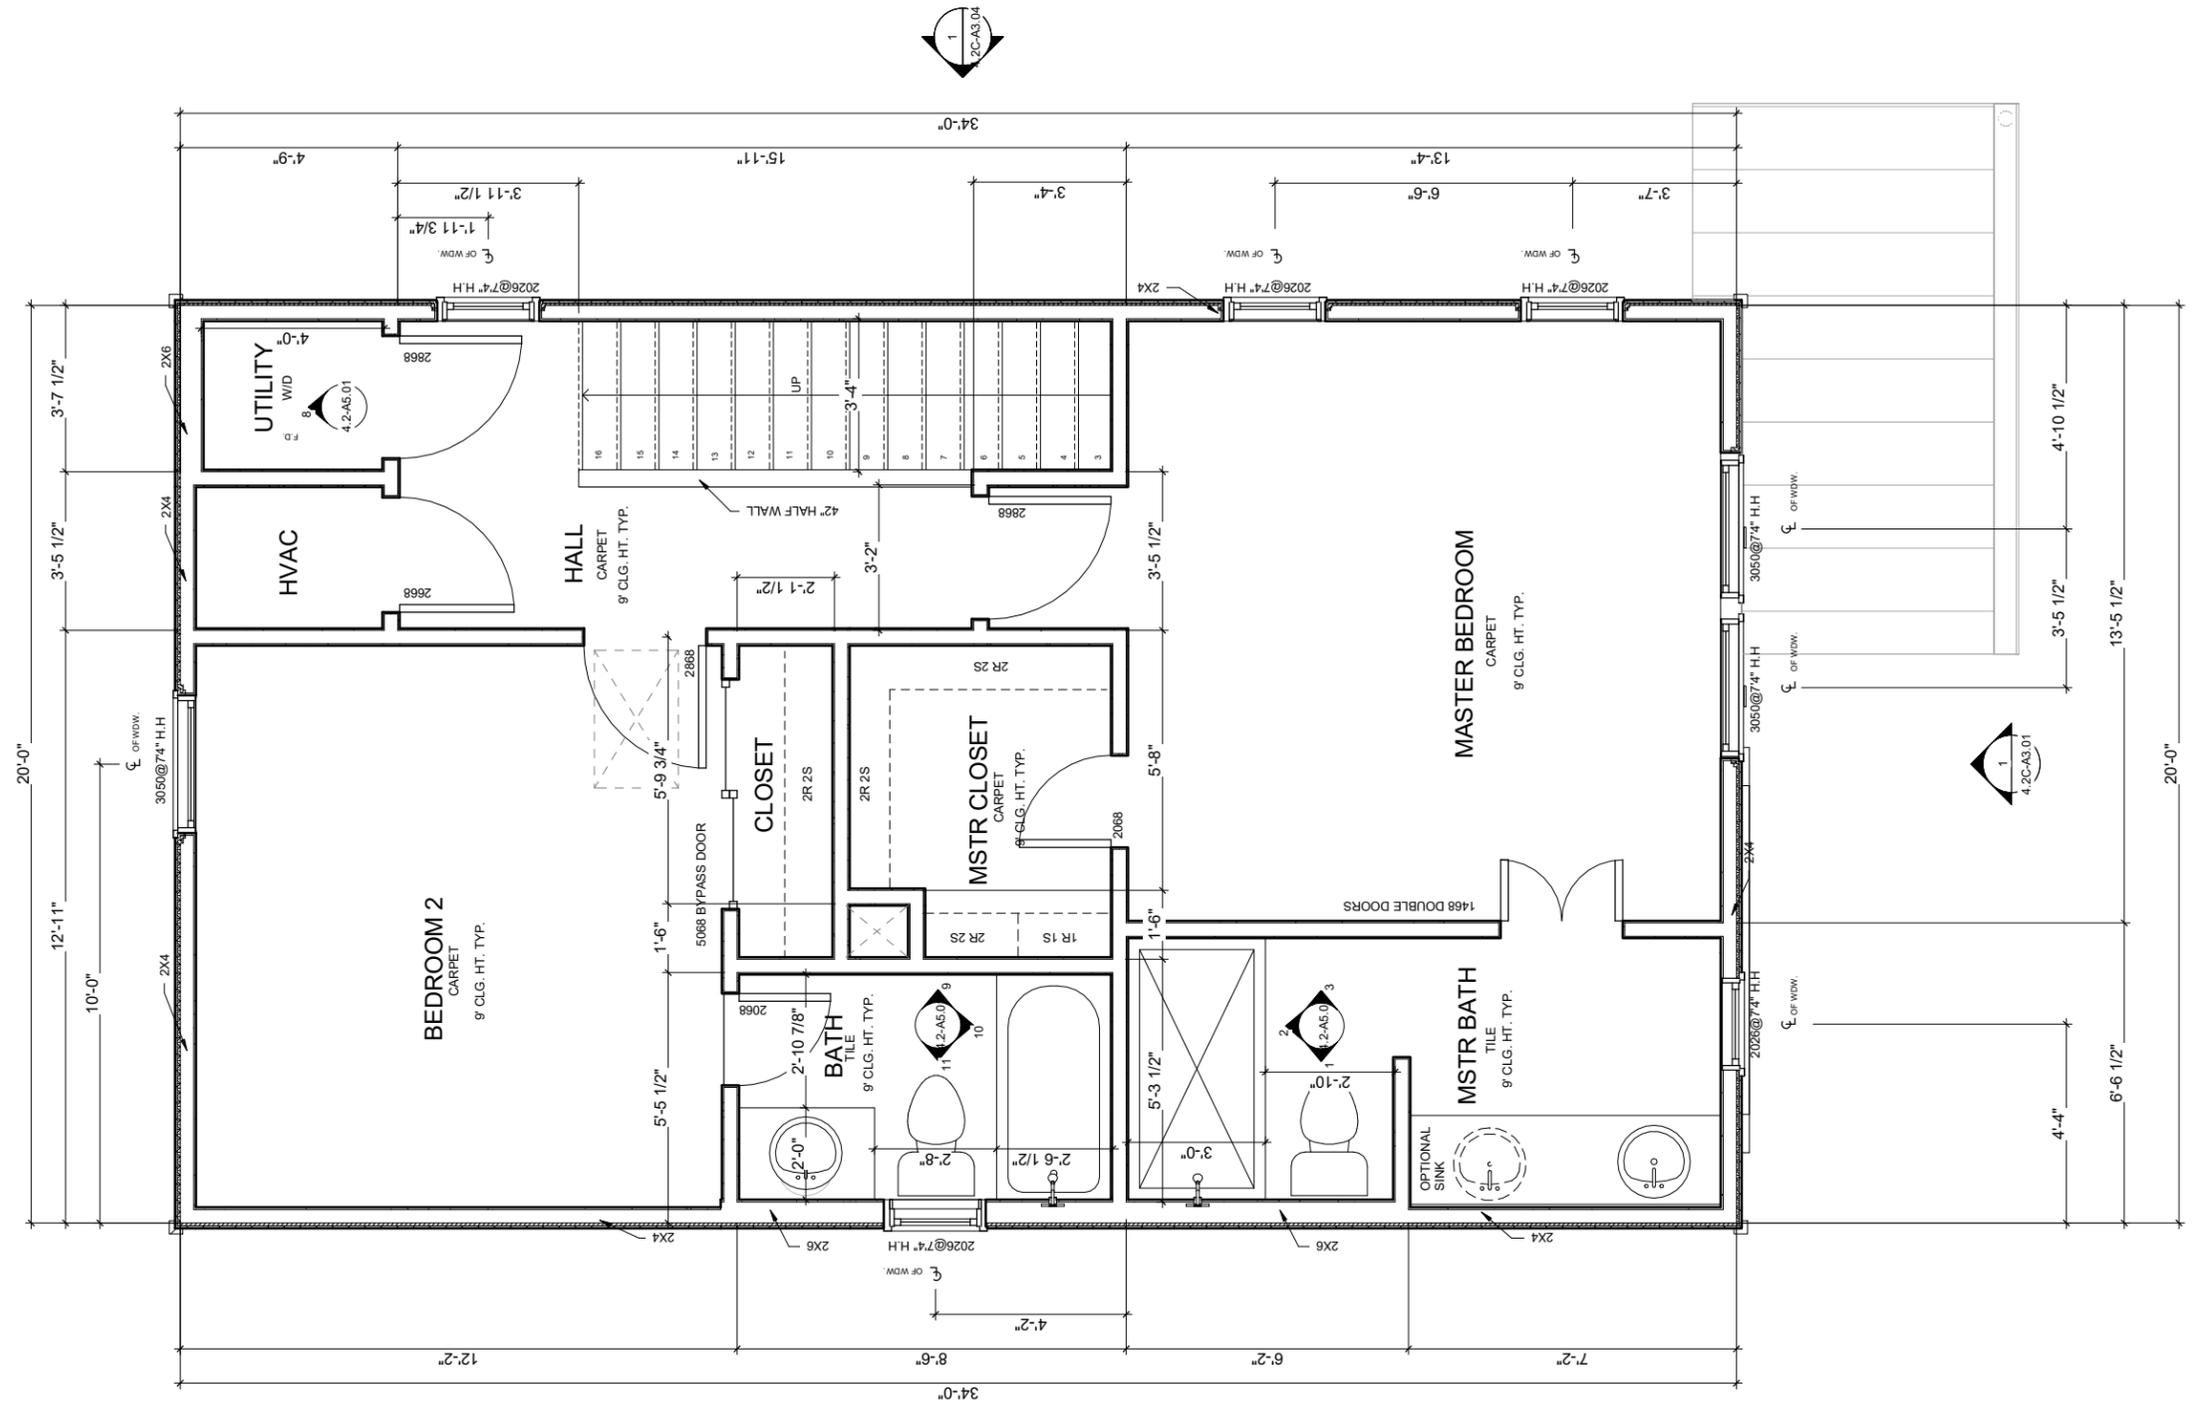


1 PROTOTYPE 4.2C - SECOND FLOOR
1/4" = 1'-0"

OVERALL LIVING + ROOF AREAS	
NAME	AREA
1ST FLOOR LIVING	680 S.F.
2ND FLOOR LIVING	632 S.F.
TOTAL LIVING	1312 S.F.
FRONT PORCH	64 S.F.
TOTAL STRUCTURE	1,376 S.F.
COMP. ROOF AREA	915 S.F.
METAL ROOF AREA	109 S.F.

2/6/2017 3:50:51 PM

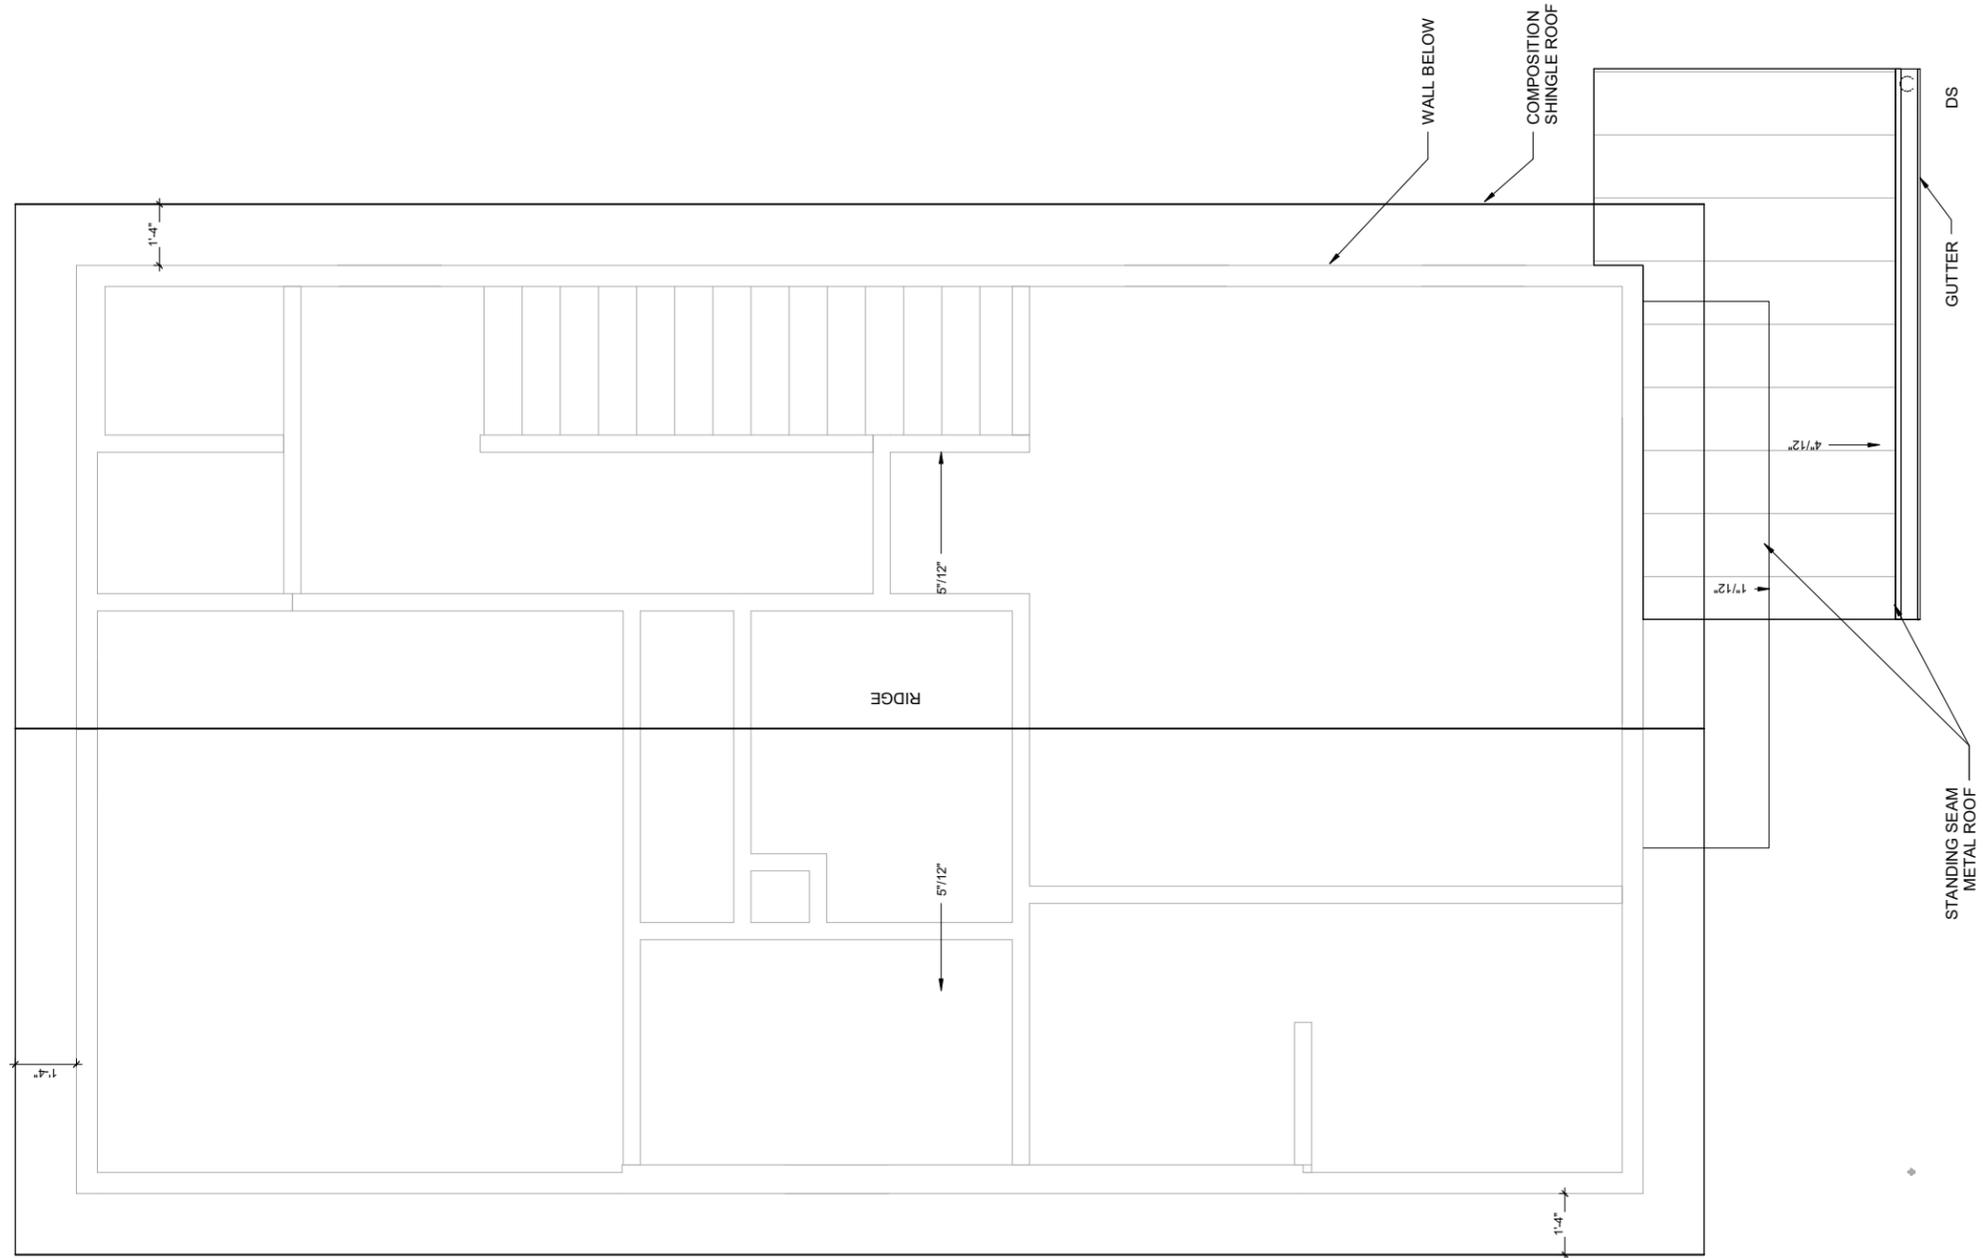

1 PROTOTYPE 4.2C - ROOF PLAN
1/4" = 1'-0"

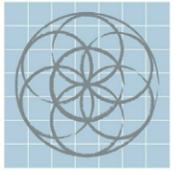

SEVENTH
GENERATION
DESIGN

ARCHITECTURE | SUSTAINABILITY | PRESERVATION
118 Broadway, Suite 519
San Antonio, Texas 78205
TEL (210) 262-6161 TEL (210) 241-7490

Urban at Olive

600 Block Burleson San
Antonio, TX

No.	Date	Description
1	02/06/2017	Construction Set



ROOF PLAN

PROTOTYPE 4.2C




William Cupron
February 6, 2017

Project number
Date February 6, 2017
Drawn by
Checked by

4.2C-A2.05

Scale

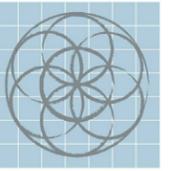

SEVENTH
GENERATION
DESIGN

ARCHITECTURE | SUSTAINABILITY | PRESERVATION

118 Broadway, Suite 519
San Antonio, Texas 78205
TEL (210) 262-6161 TEL (210) 241-7490

Urban at Olive

600 Block Burleson San
Antonio, TX

No.	Date	Description
1	02/06/2017	Construction Set



01 FLOOR REFLECTED
CEILING PLAN

PROTOTYPE 4.2C





February 6, 2017

Project number
Date February 6, 2017
Drawn by
Checked by

4.2C-A2.06

Scale

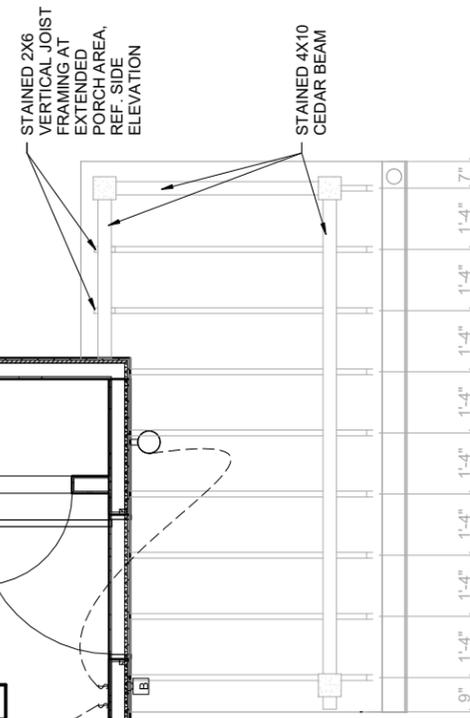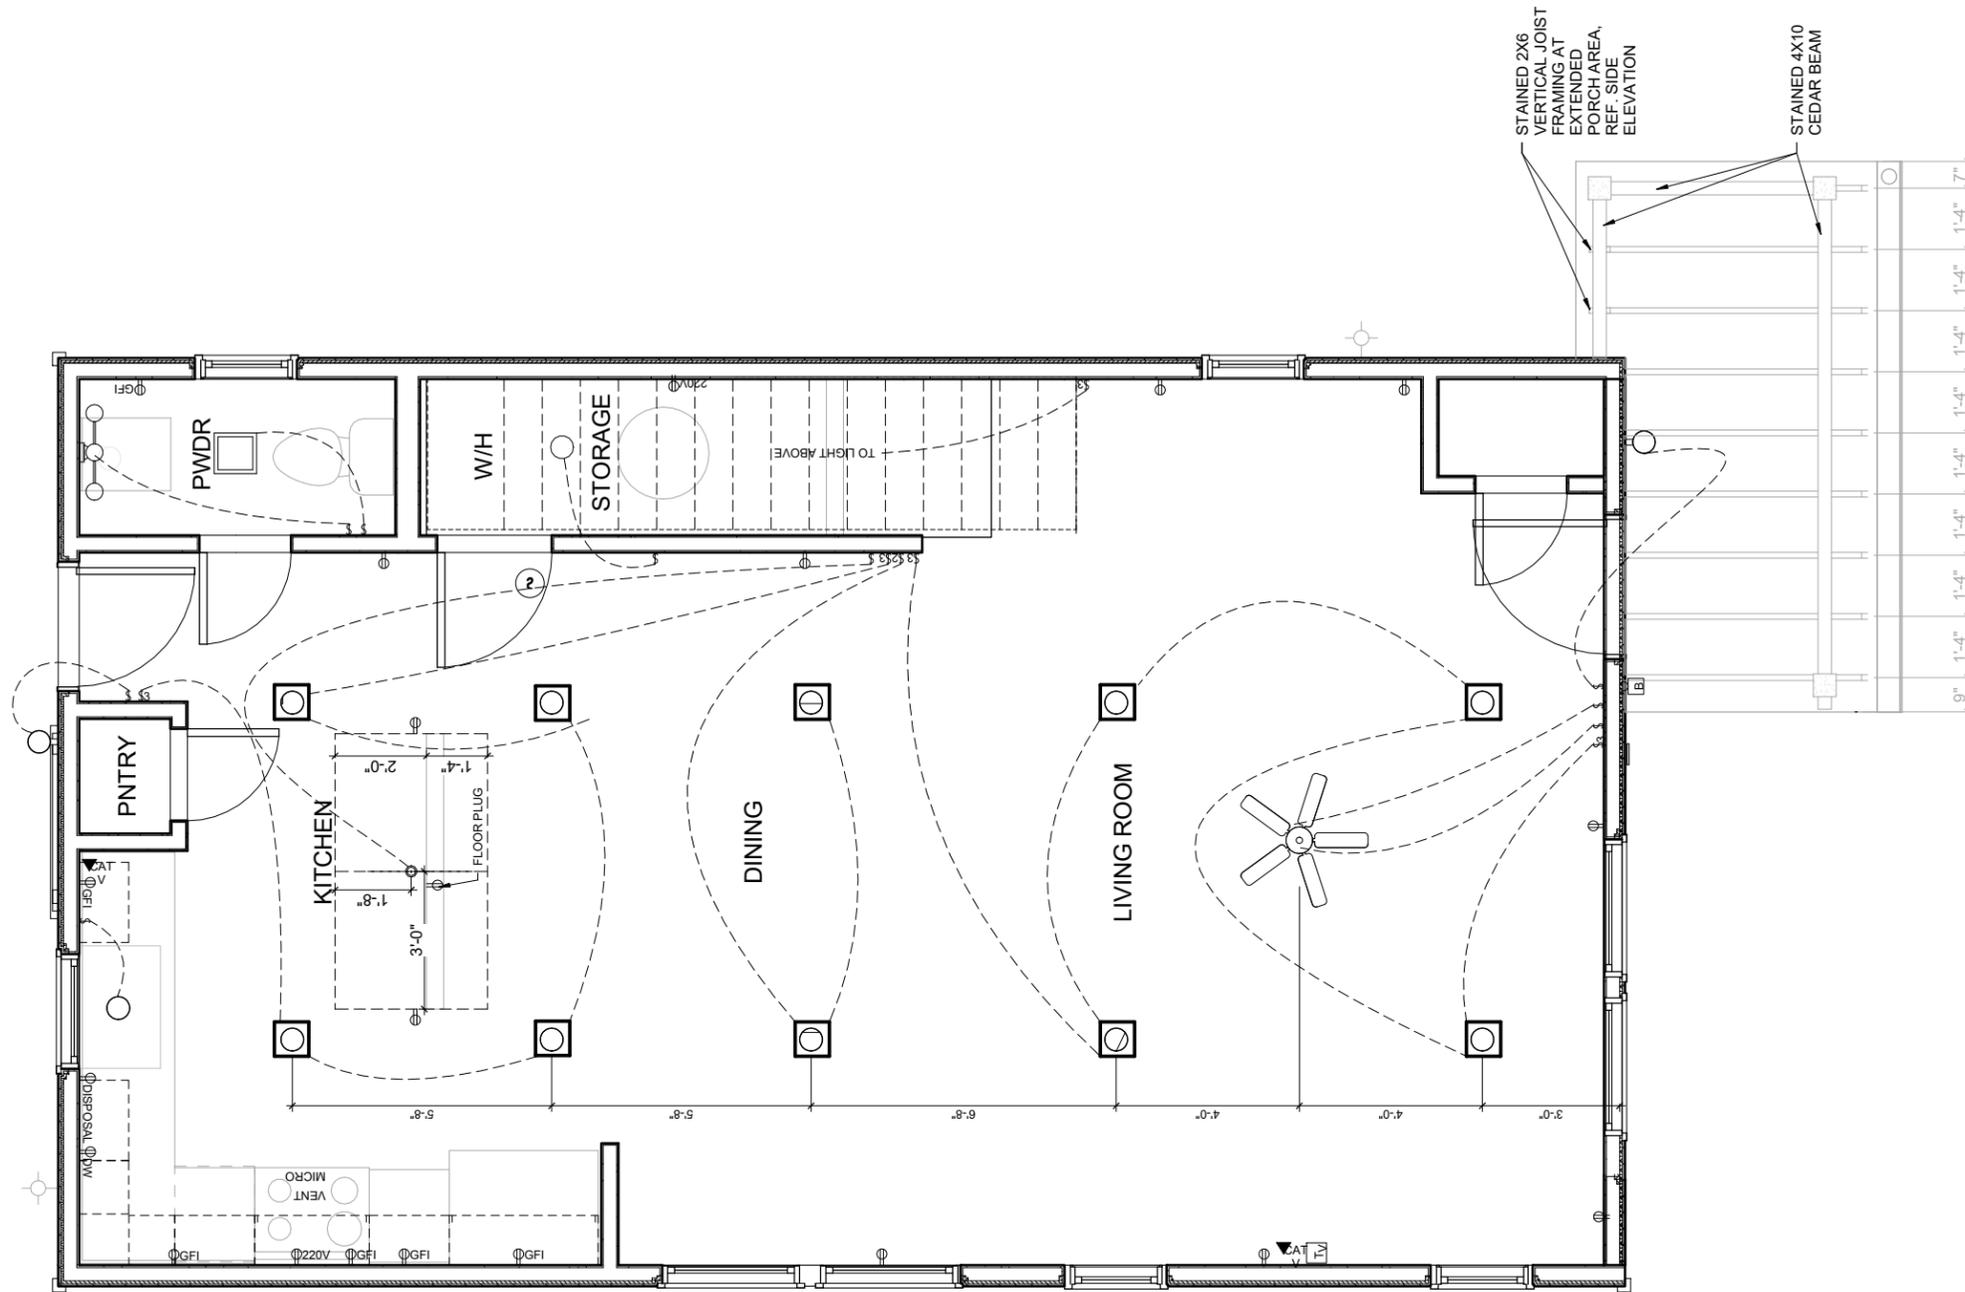


1 PROTOTYPE 4.2C - 01 REFLECTED CEILING PLAN
1/4" = 1'-0"

ELECTRICAL & CEILING PLAN LEGEND

- | | | | | | |
|--|----------------------------|--|---------------------------------------|--|----------------------------------|
| | RECESSED LIGHT | | 110 VOLT DUPLEX OUTLET | | THERMOSTAT |
| | WATERPROOF RECESSED LIGHT | | 220 VOLT DUPLEX OUTLET | | DOORBELL |
| | PENDANT LIGHT | | GROUND FAULT/WATERPROOF DUPLEX OUTLET | | ELECTRICAL PANEL |
| | SURFACE MOUNTED LIGHT | | DISHWASHER SWITCH | | SMOKE & CARBON MONOXIDE DETECTOR |
| | WALL MOUNTED LIGHT | | GARBAGE DISPOSAL SWITCH | | TELEPHONE WALL OUTLET |
| | WALL MOUNTED VANITY LIGHT | | ONE-WAY SWITCH | | TELEVISION CABLE OUTLET |
| | EXHAUST FAN | | TWO-WAY SWITCH | | SCUTTLE ACCESS |
| | EXHAUST FAN W/ LIGHT COMBO | | | | |
| | CEILING FAN WITH LIGHT KIT | | | | |

2/6/2017 3:50:54 PM

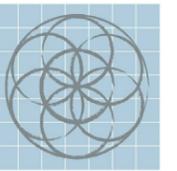

SEVENTH
GENERATION
DESIGN

ARCHITECTURE | SUSTAINABILITY | PRESERVATION

118 Broadway, Suite 519
San Antonio, Texas 78205
TEL (210) 262-6161 TEL (210) 241-7490

Urban at Olive

600 Block Burleson San
Antonio, TX

No.	Date	Description
1	02/06/2017	Construction Set



BACK ELEVATION

PROTOTYPE 4.2C




Scott William Cuppen
February 6, 2017


Project number
Date February 6, 2017
Drawn by
Checked by

4.2C-A3.02

Scale

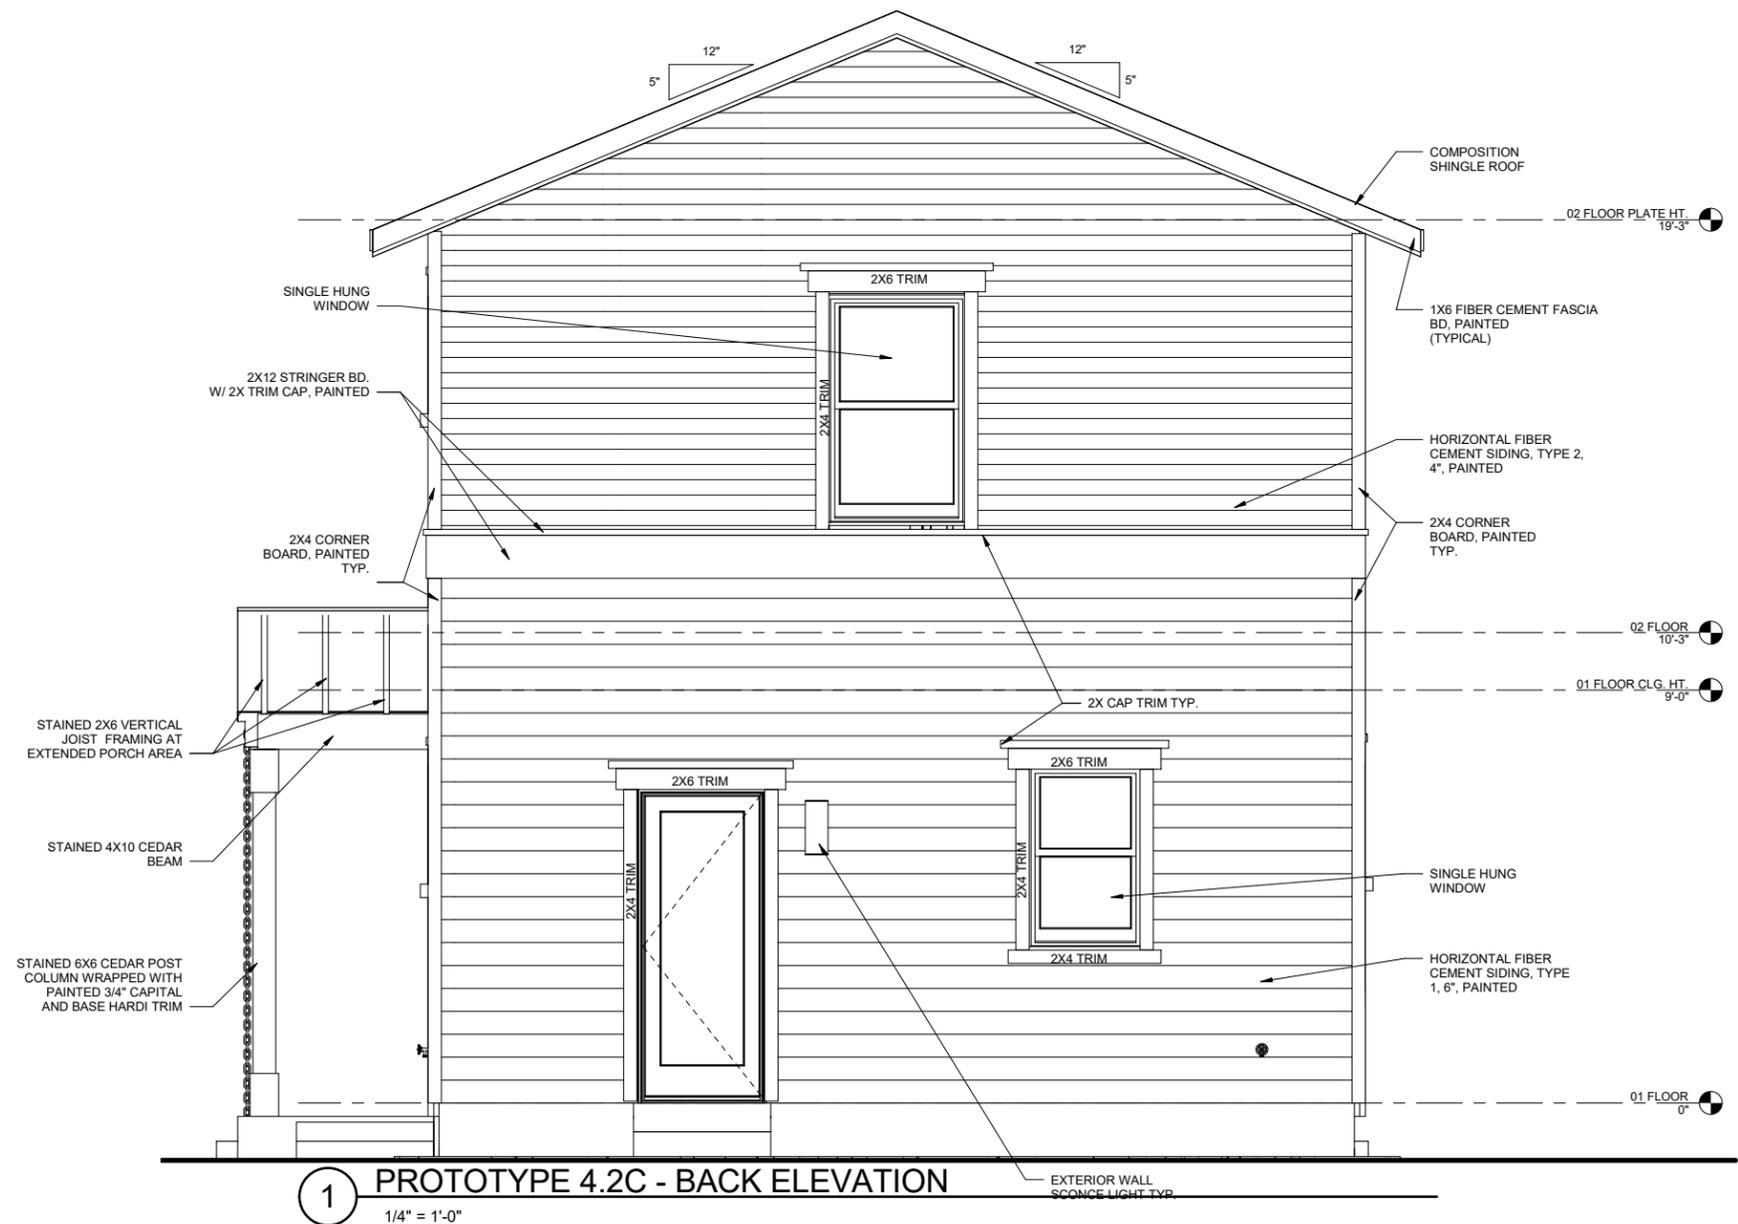


1 **PROTOTYPE 4.2C - BACK ELEVATION**
1/4" = 1'-0"

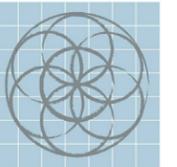


SEVENTH
GENERATION
DESIGN

ARCHITECTURE | SUSTAINABILITY | PRESERVATION

118 Broadway, Suite 519
San Antonio, Texas 78205
TEL (210) 262-6161 TEL (210) 241-7490

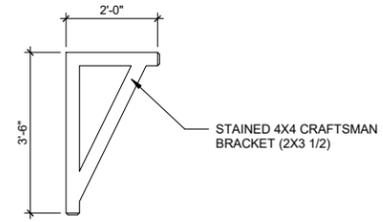

2 CRAFTSMAN BRACKET ELEVATION

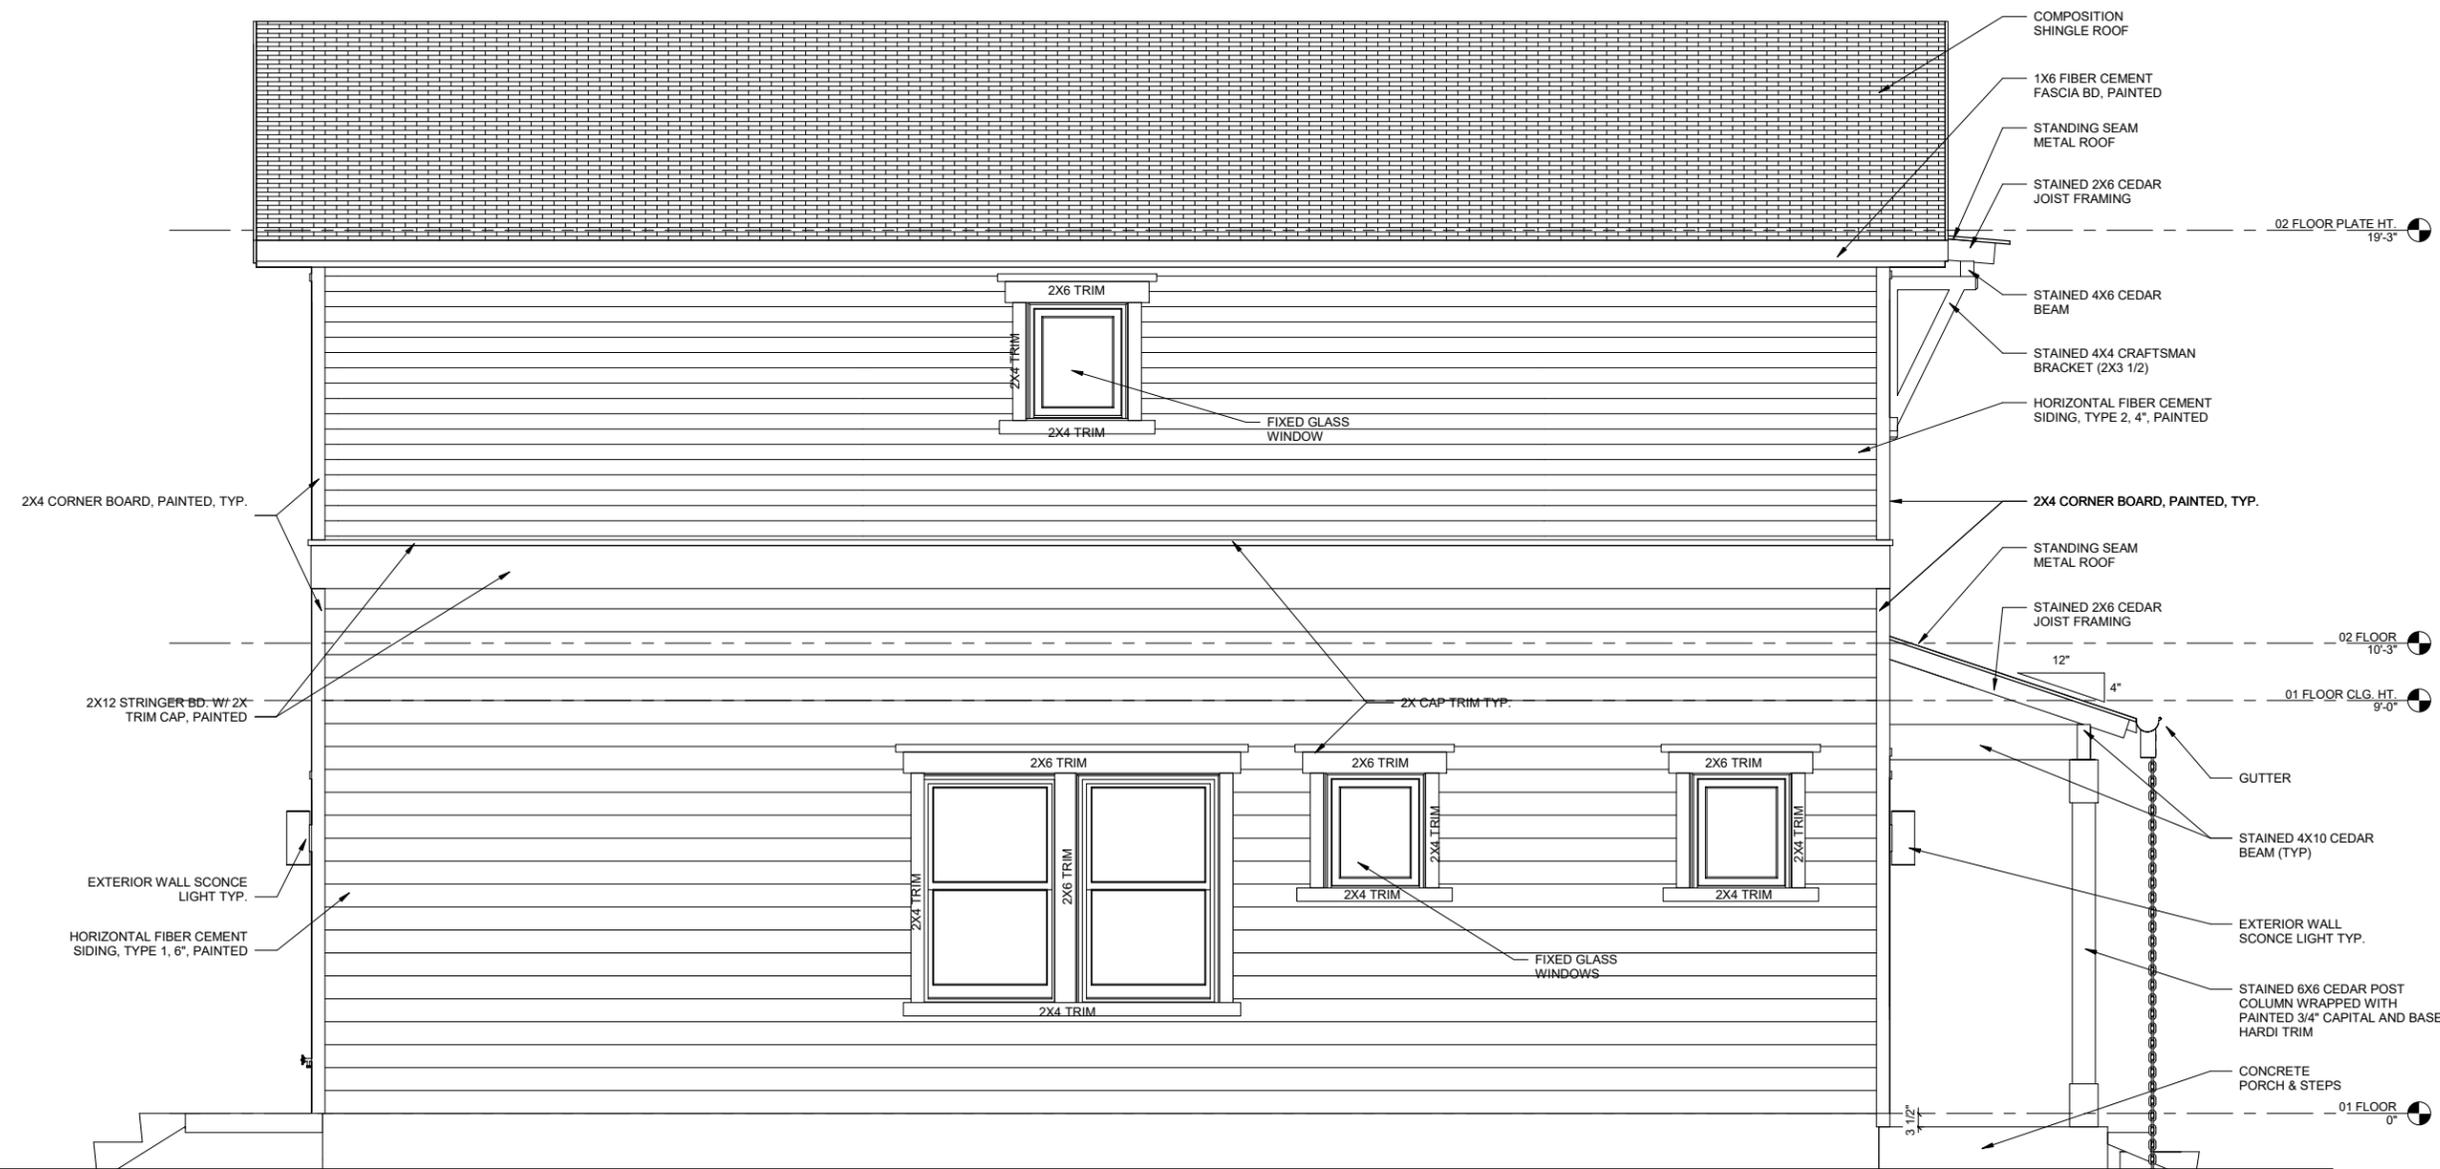

1 PROTOTYPE 4.2C - SIDE ELEVATION

1/4" = 1'-0"

Urban at Olive

600 Block Burleson San Antonio, TX

No.	Date	Description
1	02/06/2017	Construction Set



SIDE ELEVATION

PROTOTYPE 4.2C



William Cupron
February 6, 2017


Project number
Date February 6, 2017

Drawn by
Checked by

4.2C-A3.03

Scale

2/6/2017 3:51:06 PM

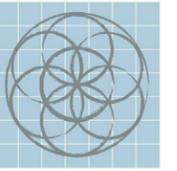

SEVENTH
GENERATION
DESIGN

ARCHITECTURE | SUSTAINABILITY | PRESERVATION

118 Broadway, Suite 519
San Antonio, Texas 78205
TEL (210) 262-6161 TEL (210) 241-7490

Urban at Olive

600 Block Burleson San
Antonio, TX

No.	Date	Description
1	02/06/2017	Construction Set



SIDE ELEVATION

PROTOTYPE 4.2C




February 6, 2017

Project number
Date February 6, 2017

Drawn by
Checked by

4.2C-A3.04

Scale

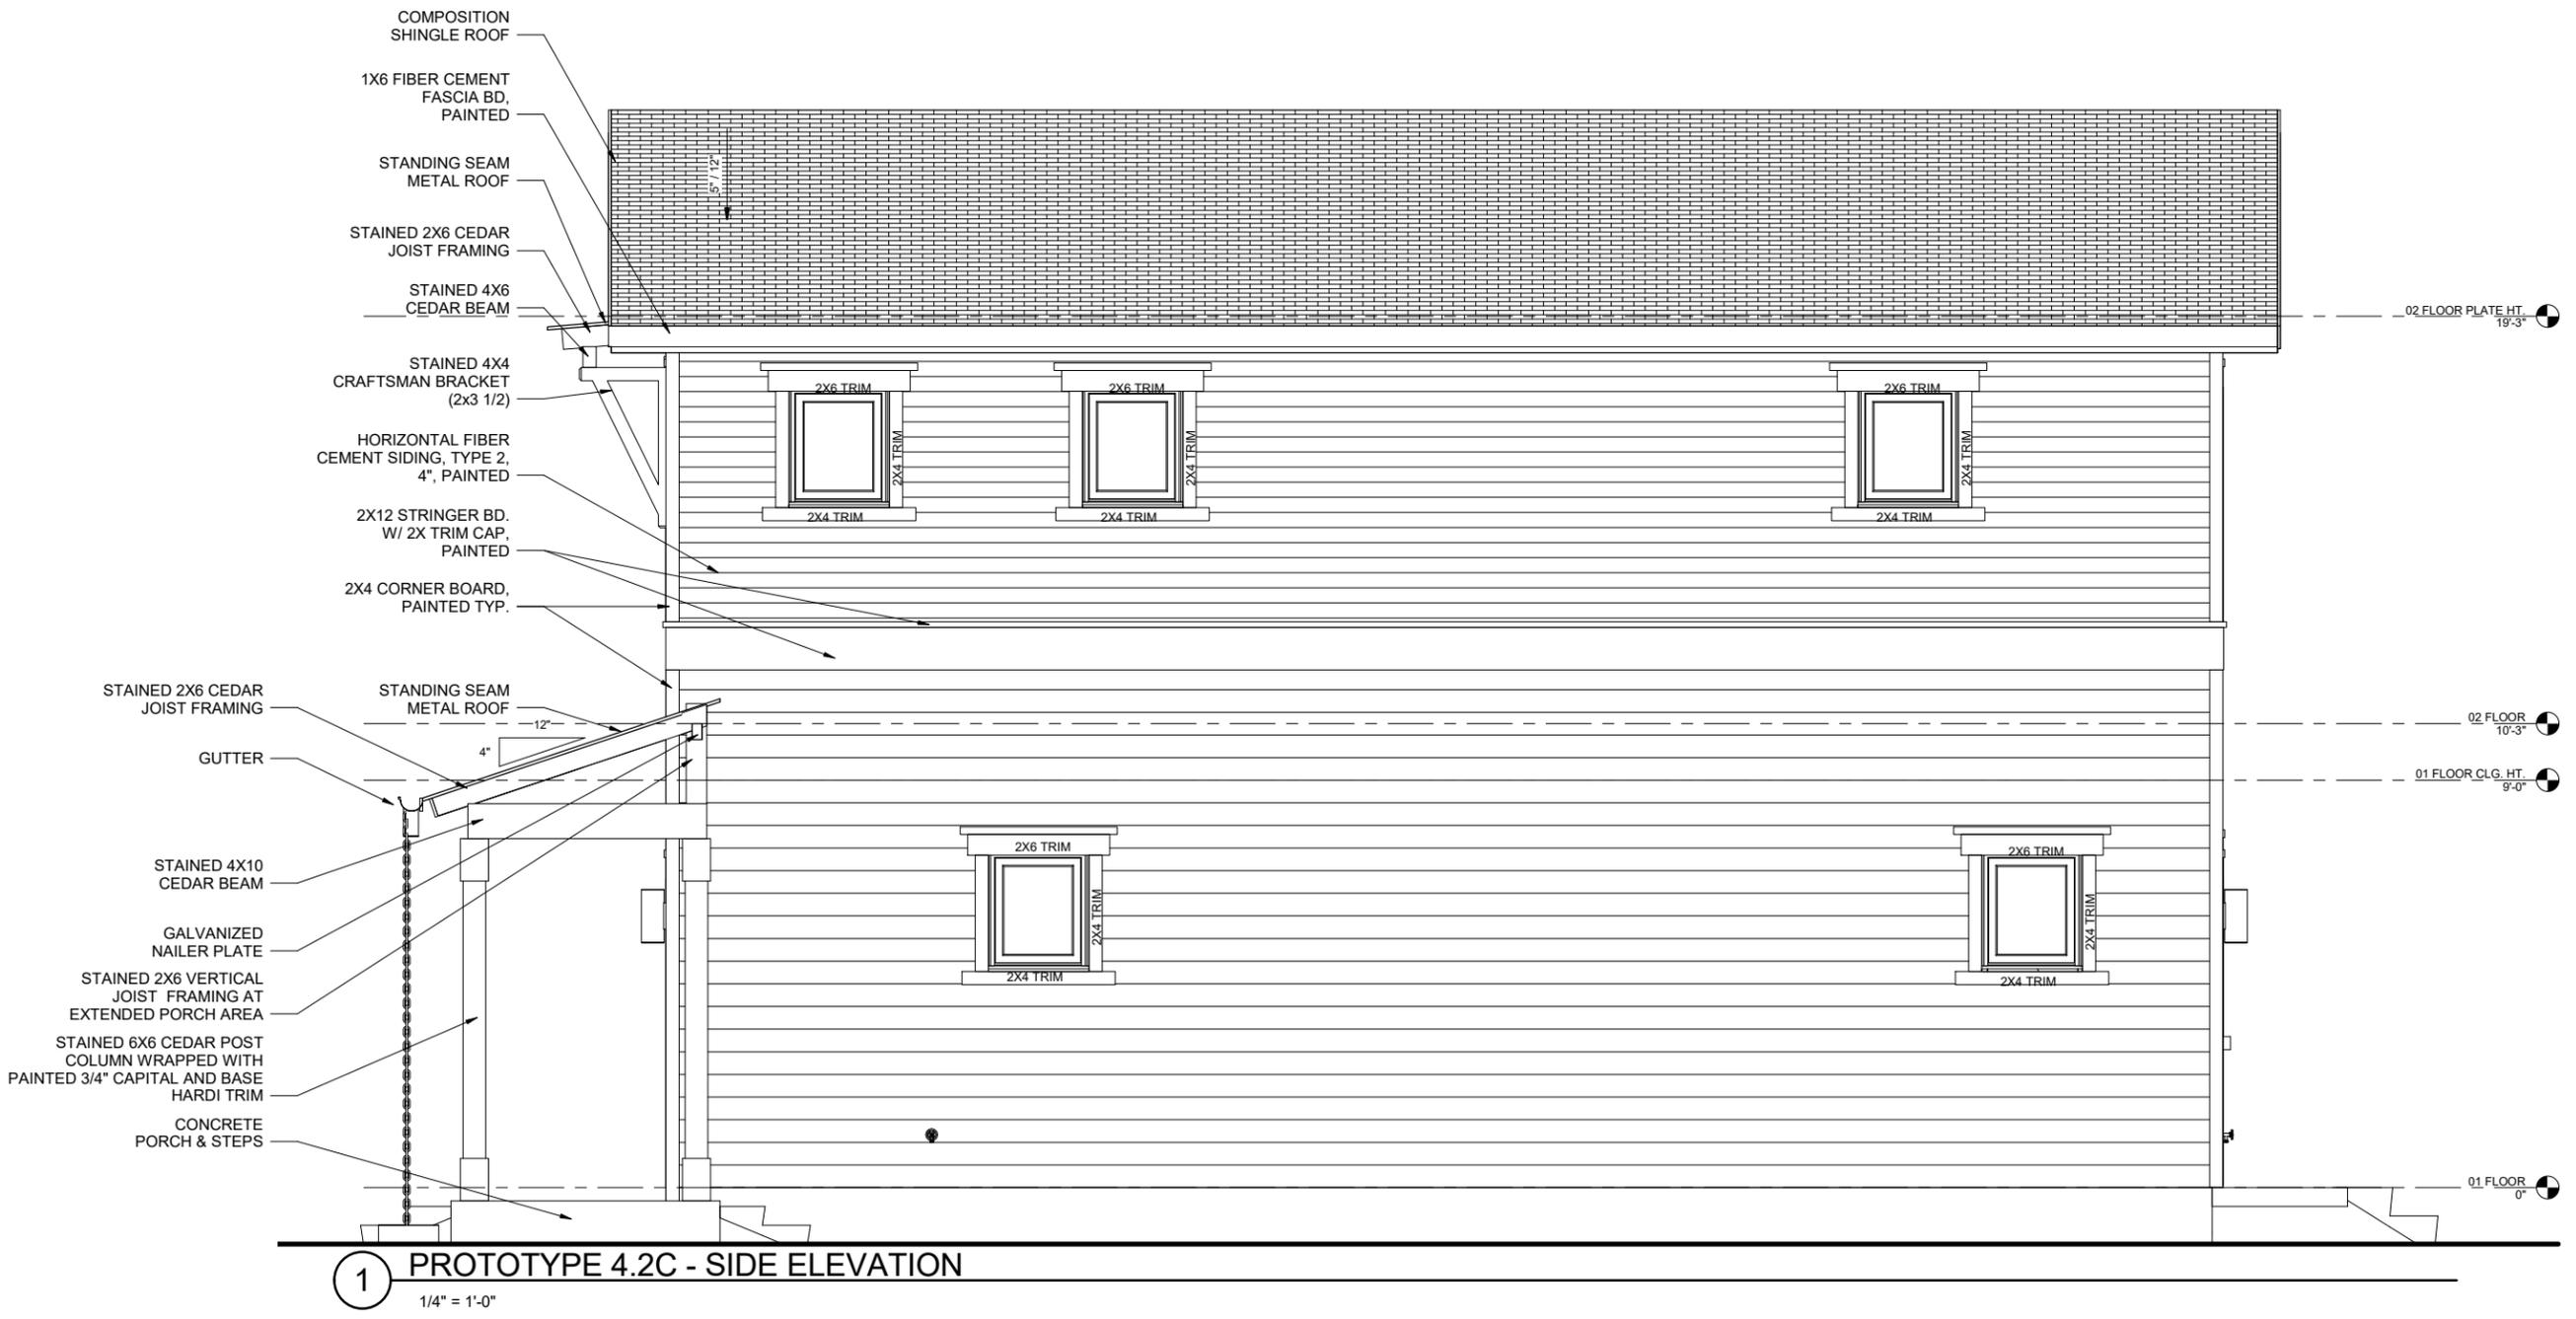


1 PROTOTYPE 4.2C - SIDE ELEVATION
1/4" = 1'-0"

2/6/2017 3:51:08 PM


INSULATION LEGEND

- INDICATES WEATHER BARRIER
- THERMAL INSULATION (DENOTES THERMAL ENVELOPE)

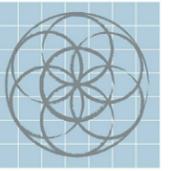

SEVENTH GENERATION DESIGN
ARCHITECTURE | SUSTAINABILITY | PRESERVATION

118 Broadway, Suite 519
San Antonio, Texas 78205
TEL (210) 262-6161 TEL (210) 241-7490

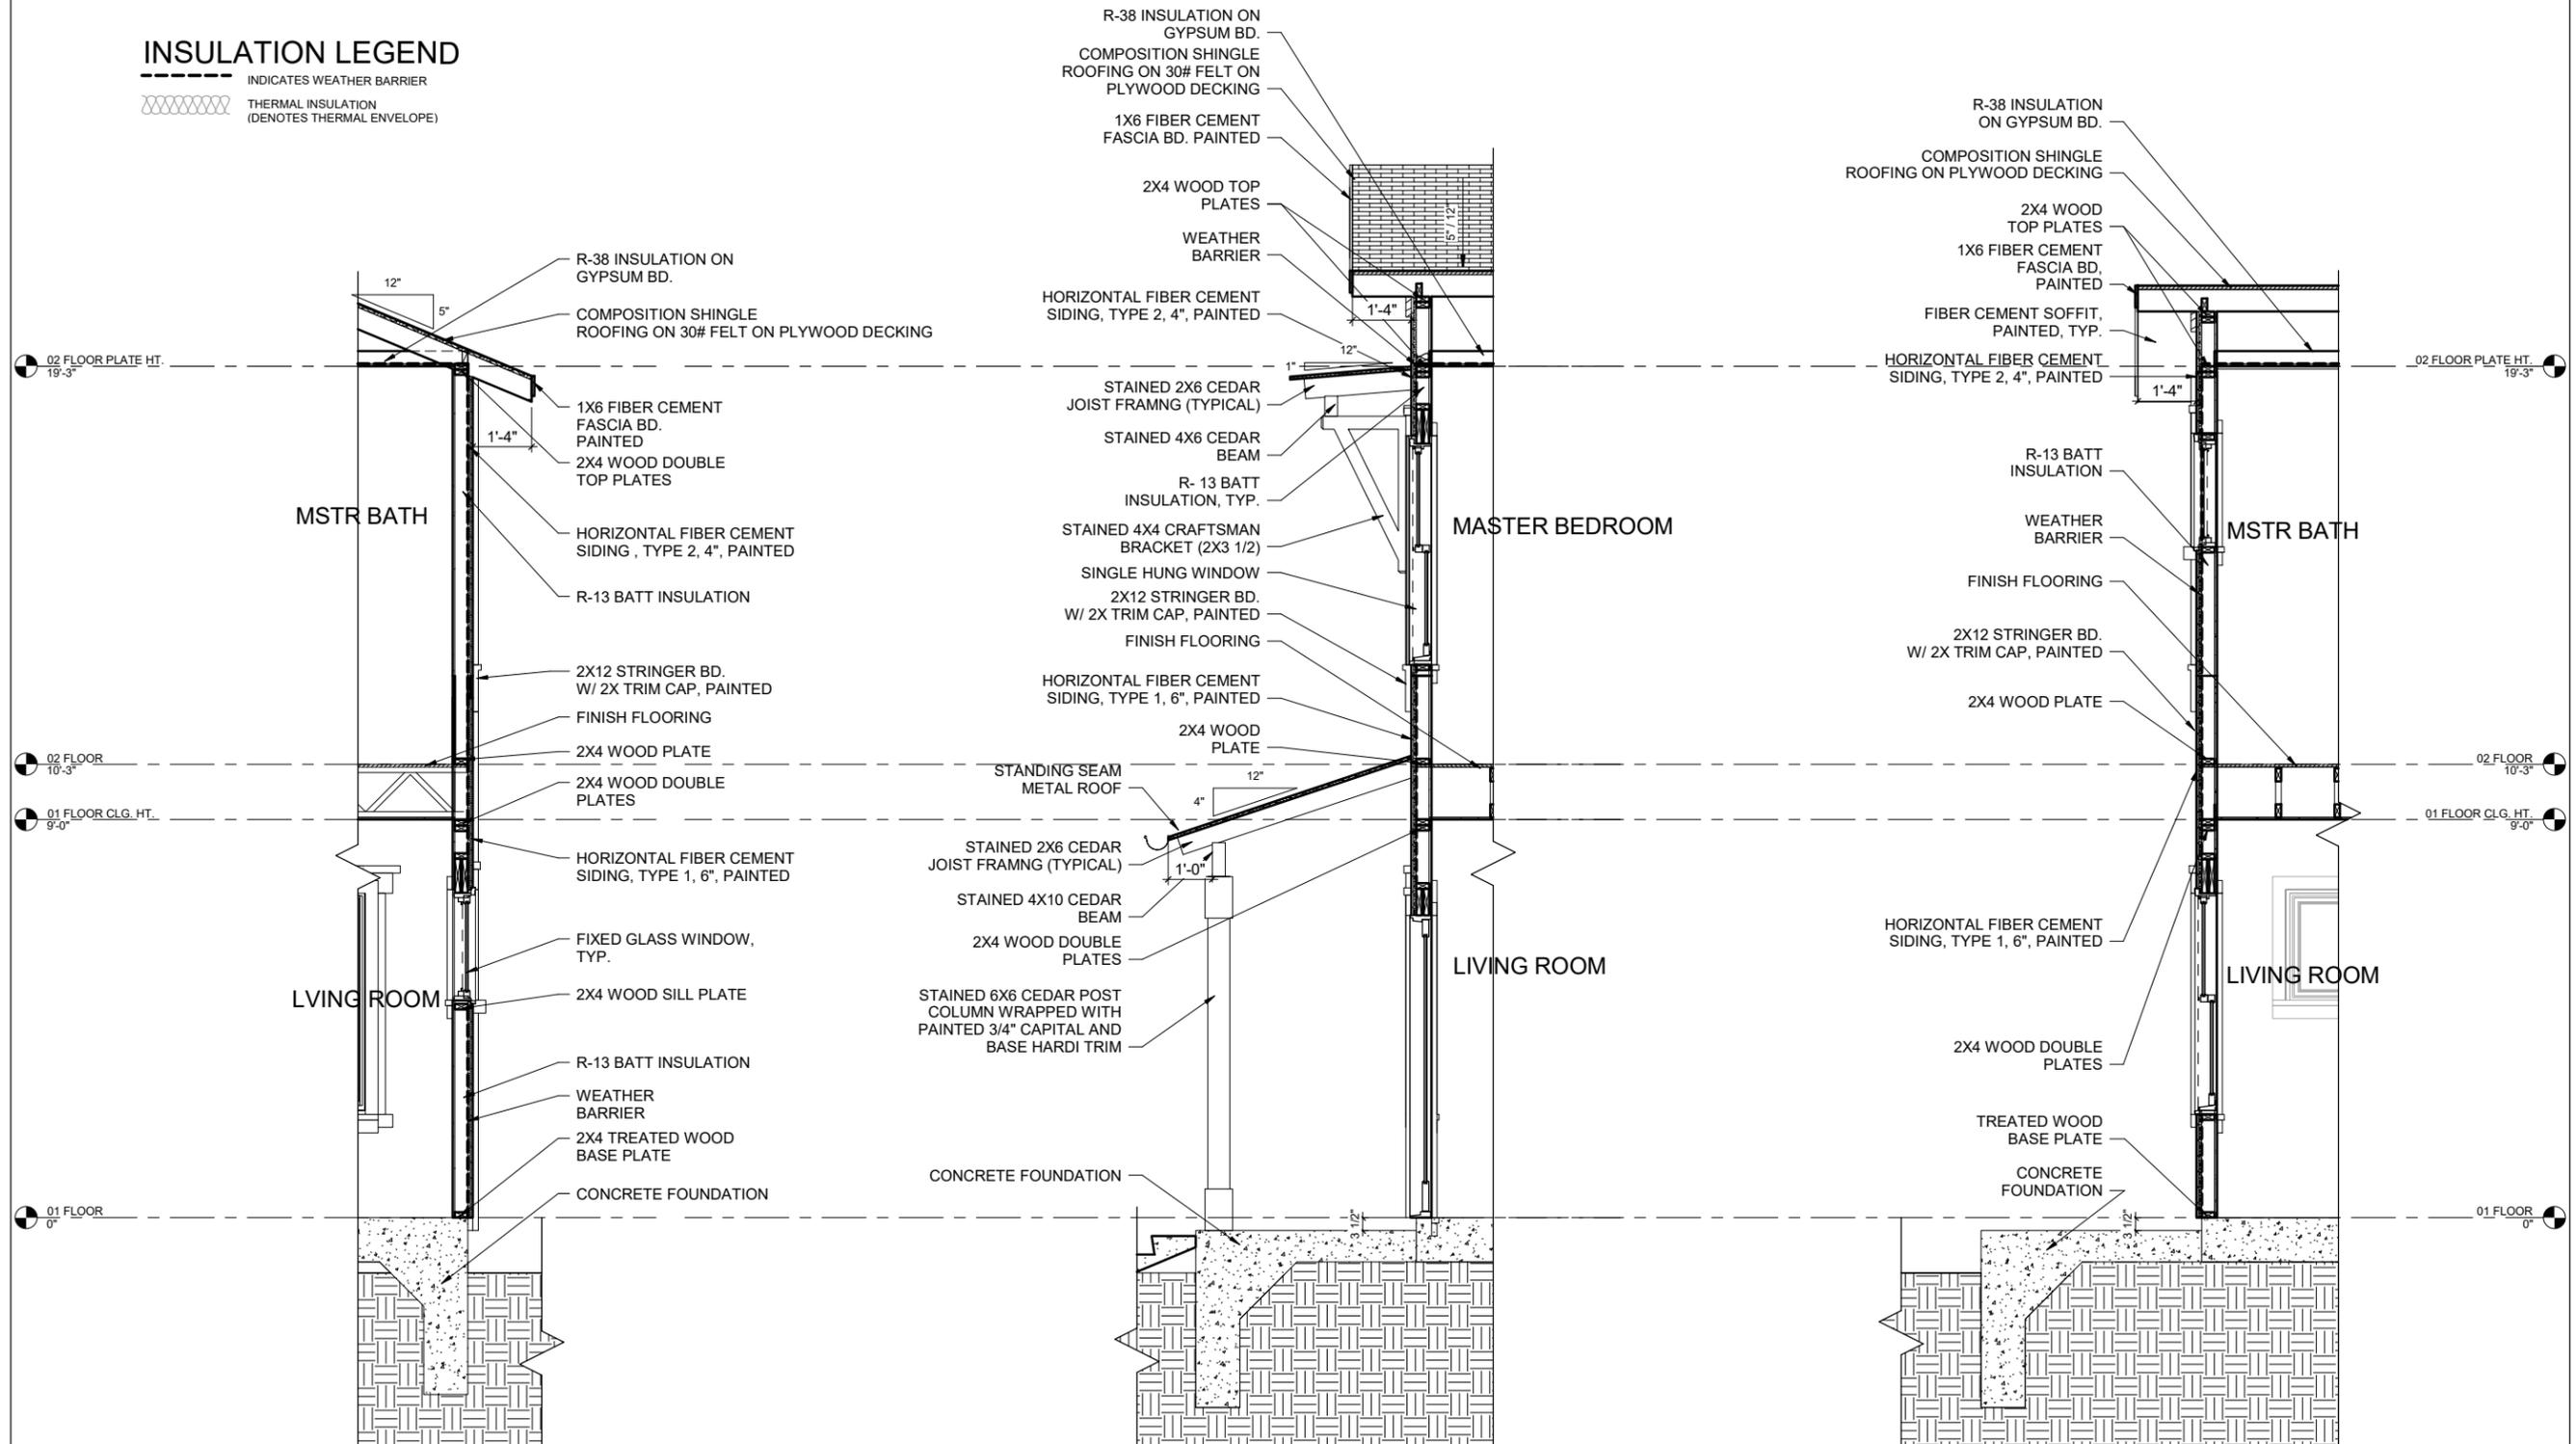

3 PROTOTYPE 4.2C - WALL SECTION AT LIVING RM. 1/4" = 1'-0"

2 PROTOTYPE 4.2C - SECTION AT FRONT WALL 1/4" = 1'-0"

1 PROTOTYPE 4.2C - PARTIAL SECTION AT PORCH 1/4" = 1'-0"

Urban at Olive

600 Block Burleson San Antonio, TX

No.	Date	Description
1	02/06/2017	Construction Set



EXTERIOR SECTIONS & DETAILS

PROTOTYPE 4.2C




February 6, 2017

Project number
Date February 6, 2017
Drawn by
Checked by

4.2C-A4.01

Scale

2/6/2017 3:51:12 PM

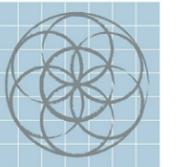


SEVENTH
GENERATION
DESIGN

ARCHITECTURE | SUSTAINABILITY | PRESERVATION


118 Broadway, Suite 519
San Antonio, Texas 78205
TEL (210) 262-6161 TEL (210) 241-7490

INSULATION LEGEND

- INDICATES WEATHER BARRIER
- THERMAL INSULATION (DENOTES THERMAL ENVELOPE)

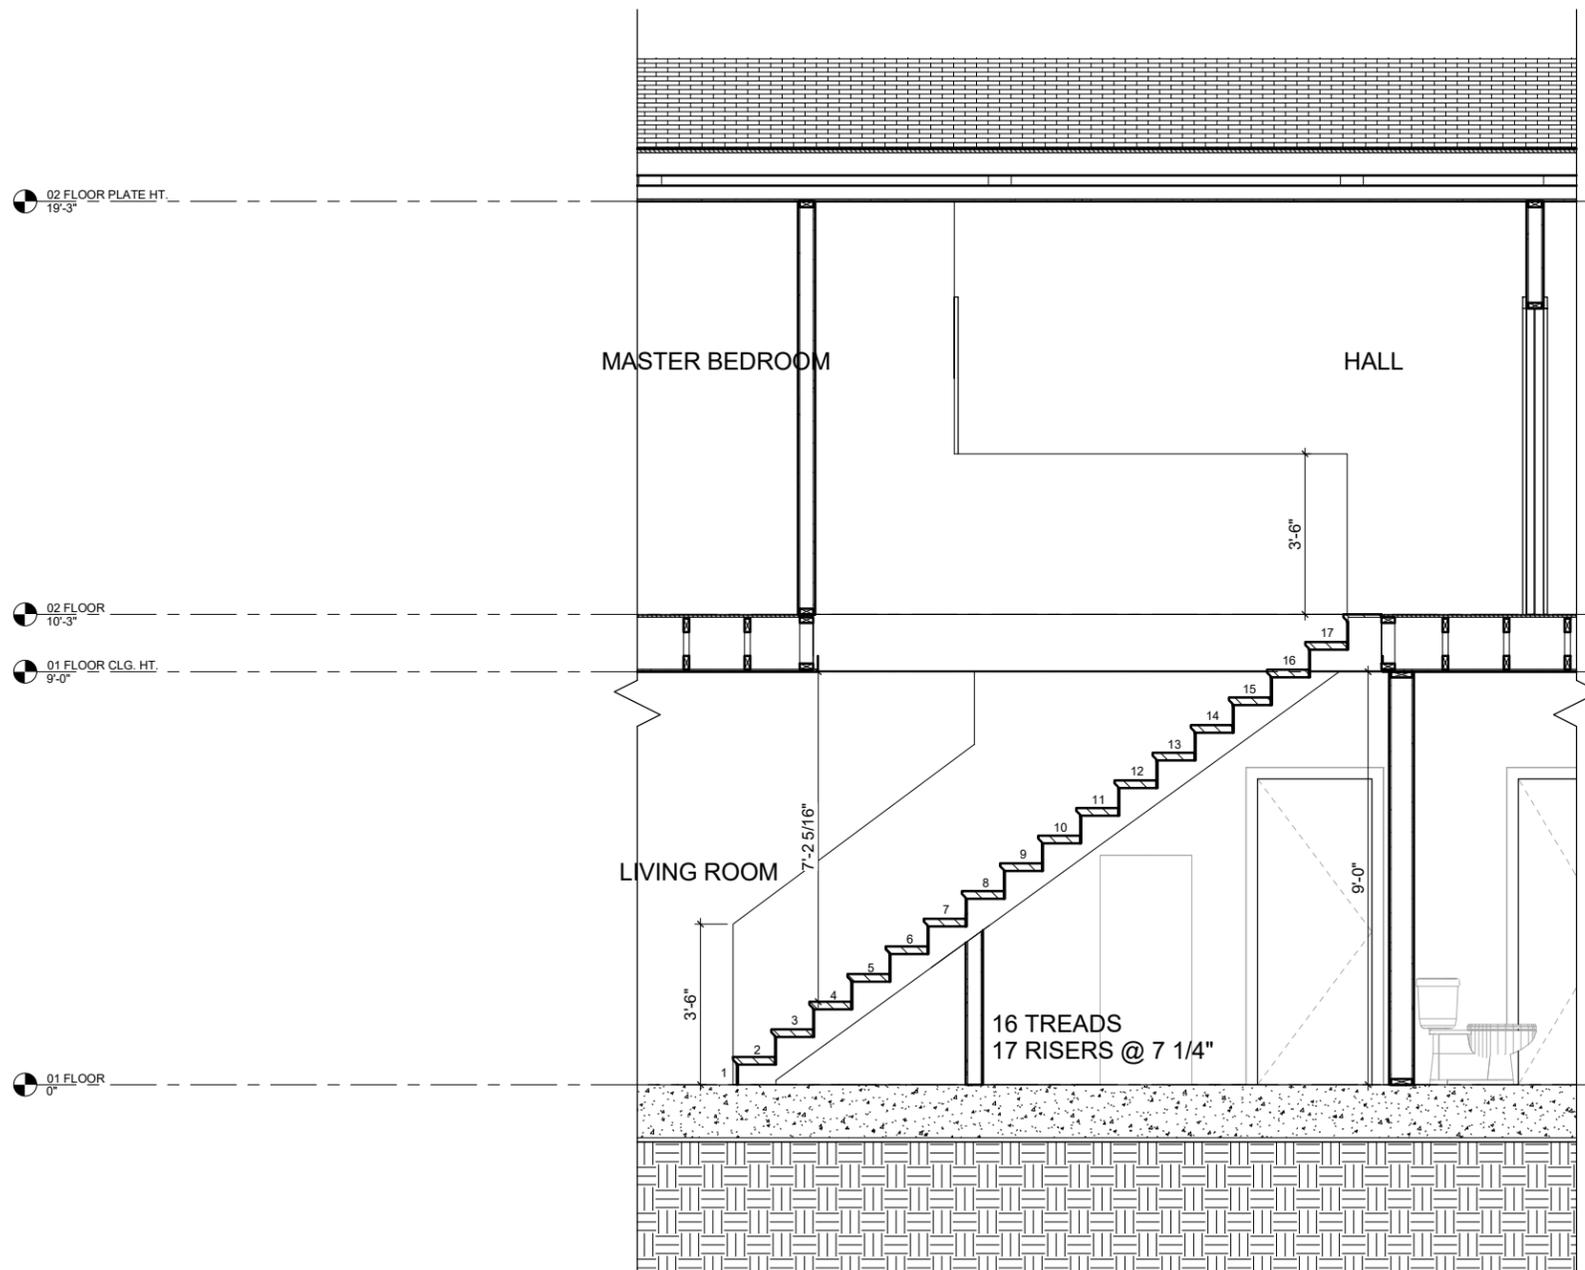

2 PR. 4.2C - STAIRS SECTION
1/4" = 1'-0"

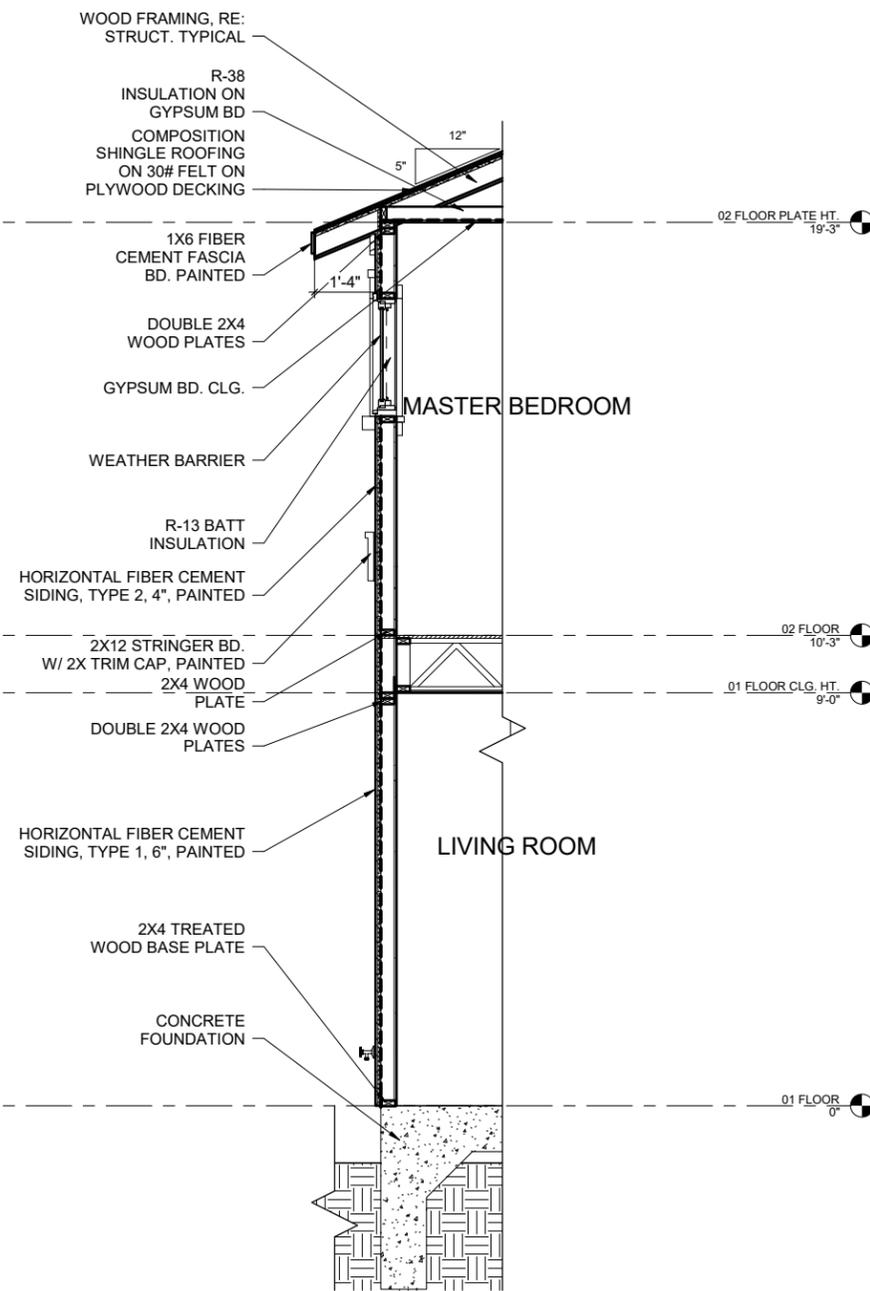

1 PR. 4.2C - WALL SECTION, TYP.
1/4" = 1'-0"

Urban at Olive

600 Block Burleson San Antonio, TX

No.	Date	Description
1	02/06/2017	Construction Set



STAIR PLANS,
SECTIONS & DETAILS

PROTOTYPE 4.2C




February 6, 2017

Project number
Date February 6, 2017
Drawn by
Checked by

4.2C-A4.02

Scale

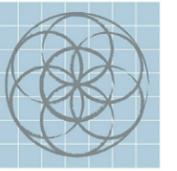

SEVENTH GENERATION DESIGN

ARCHITECTURE | SUSTAINABILITY | PRESERVATION
118 Broadway, Suite 519
San Antonio, Texas 78205
TEL (210) 262-6161 TEL (210) 241-7490

Urban at Olive

600 Block Burleson San Antonio, TX

No.	Date	Description
1	02/06/2017	Construction Set



INTERIOR ELEVATIONS & DETAILS
PROTOTYPE 4.2A OR 4.2B




February 6, 2017

Project number
Date February 6, 2017
Drawn by
Checked by


4.2-A5.01

Scale

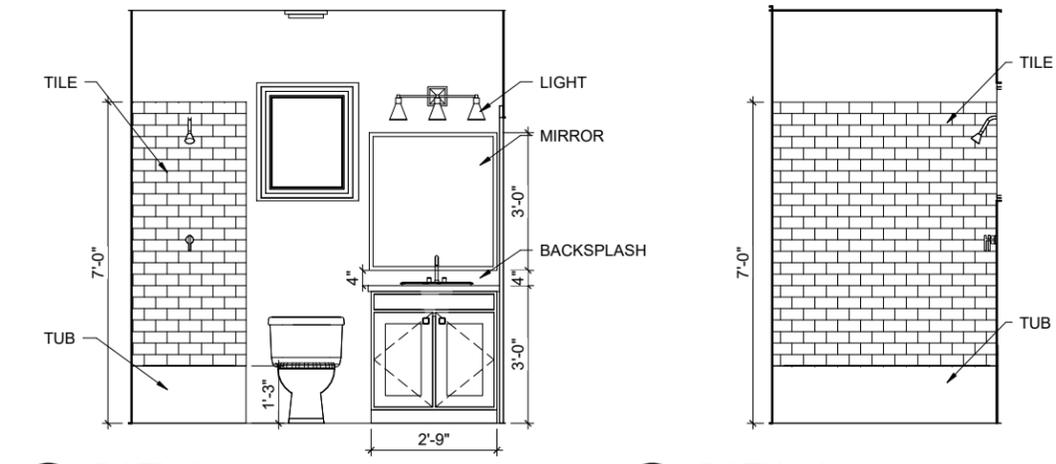


11 BATH 2 c
1/4" = 1'-0"


10 BATH 2 b
1/4" = 1'-0"

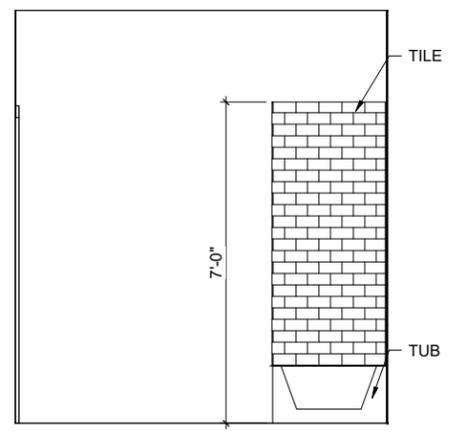

9 BATH 2 a
1/4" = 1'-0"

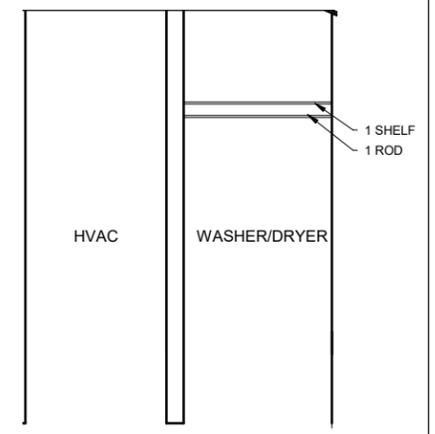


8 UTILITY
1/4" = 1'-0"

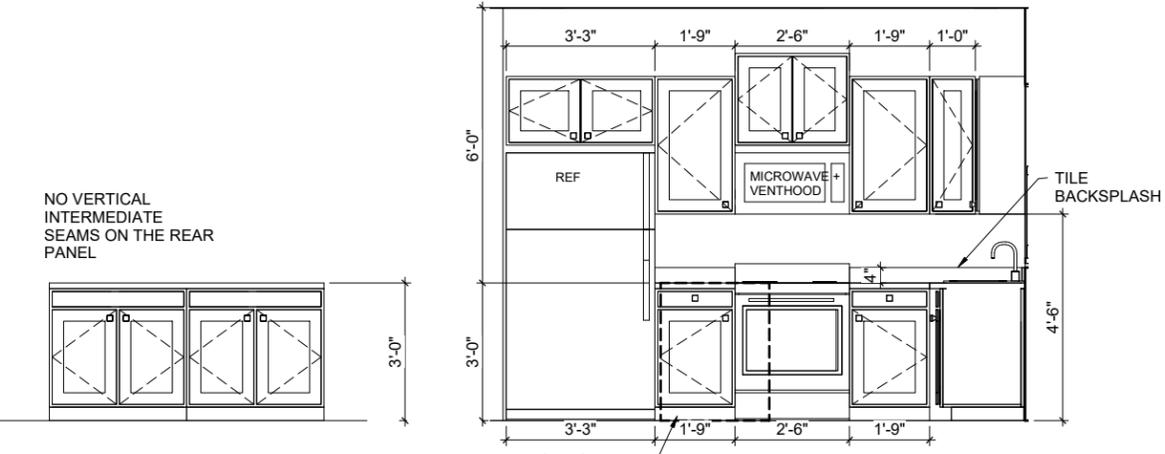


7 OPTIONAL ISLAND
1/4" = 1'-0"


6 KITCHEN b
1/4" = 1'-0"

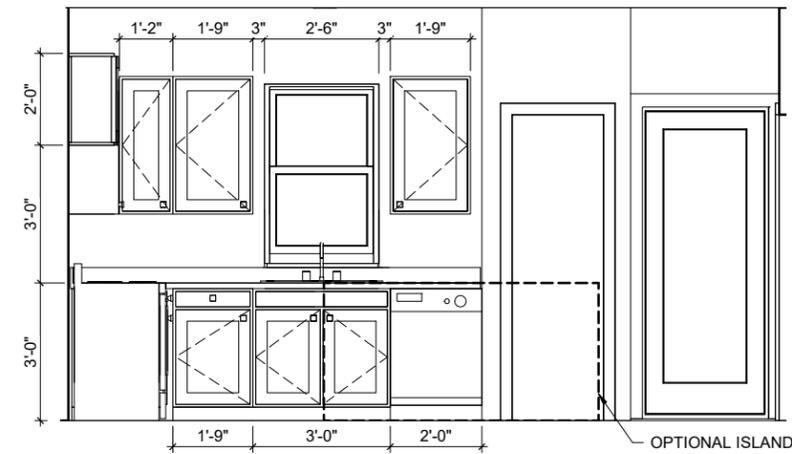


5 KITCHEN a
1/4" = 1'-0"

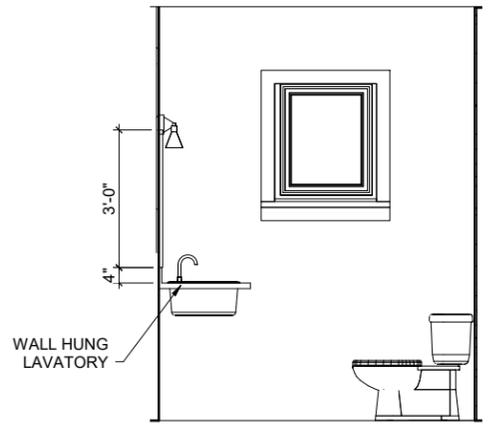


4 PWDR
1/4" = 1'-0"

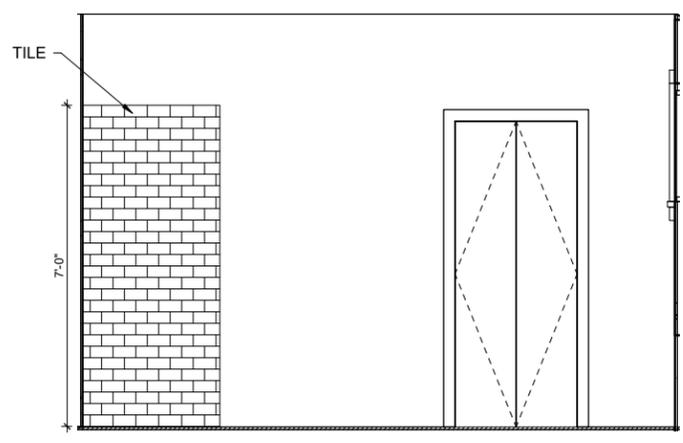


3 MSTR BATH c
1/4" = 1'-0"

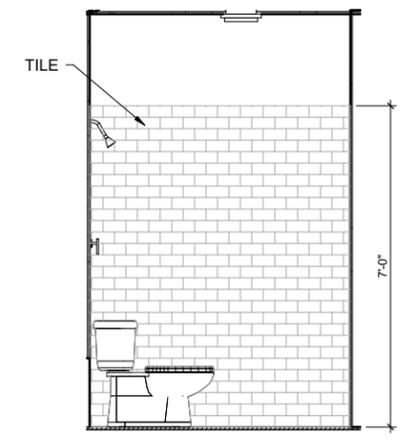

2 MSTR BATH b
1/4" = 1'-0"

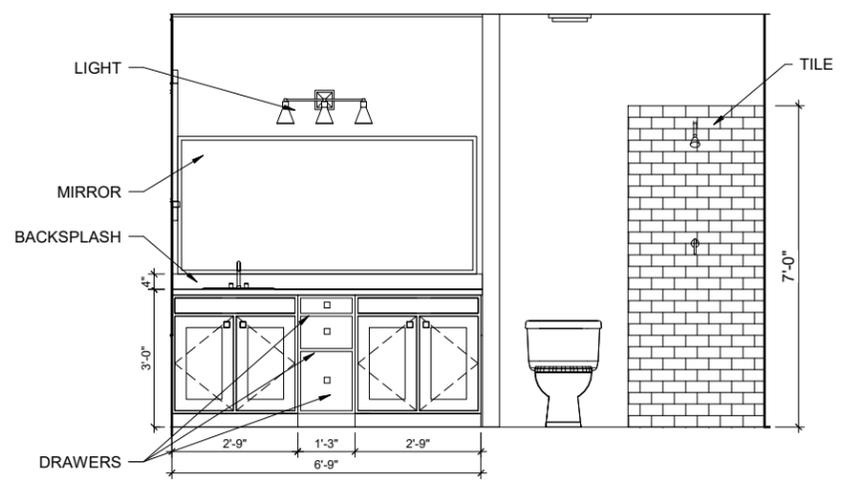

1 MSTR BATH a
1/4" = 1'-0"

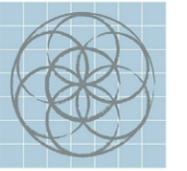

SEVENTH
GENERATION
DESIGN

ARCHITECTURE | SUSTAINABILITY | PRESERVATION

118 Broadway, Suite 519
San Antonio, Texas 78205
TEL (210) 262-6161 TEL (210) 241-7490

Urban at Olive

600 Block Burleson San
Antonio, TX

No.	Date	Description
1	02/06/2017	Construction Set



OPTIONAL GARAGE

**PROTOTYPE 4.2A,
4.2B, 4.2C, 4.2D**




Scott William Campbell
February 6, 2017

Project number
Date February 6, 2017


Drawn by
Checked by

4.2-A5.02


Scale

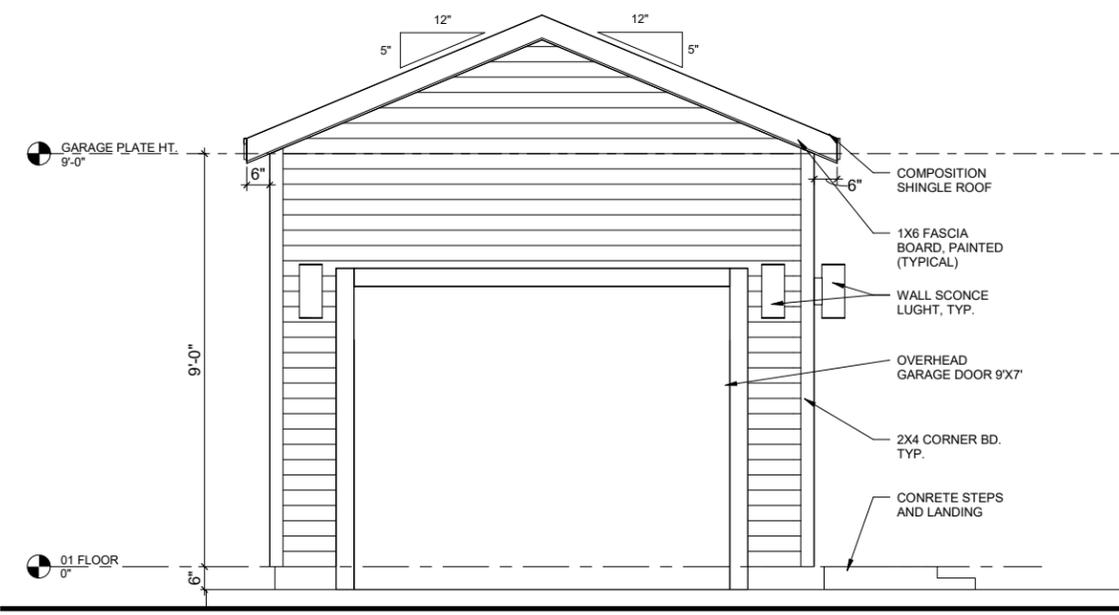

3 FRONT ELEVATION PROTOTYPE 4.2A, 4.2B, 4.2C, 4.2D
1/4" = 1'-0"

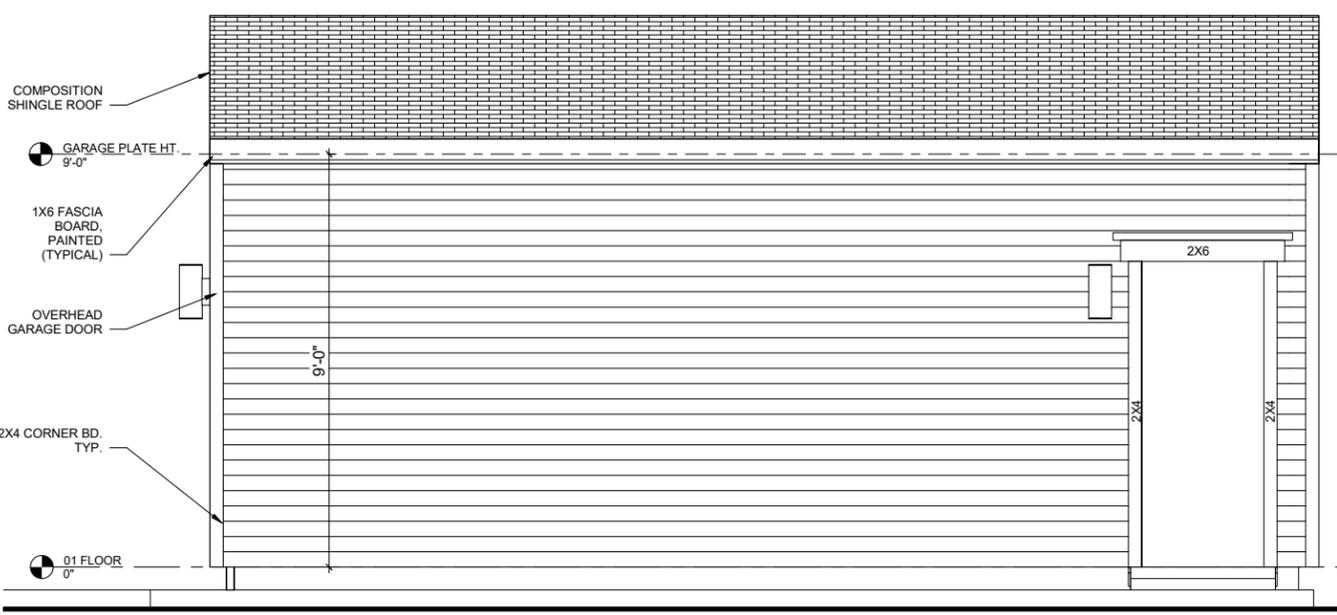


2 SIDE ELEVATION PROTOTYPE 4.2A, 4.2B, 4.2C, 4.2D
1/4" = 1'-0"

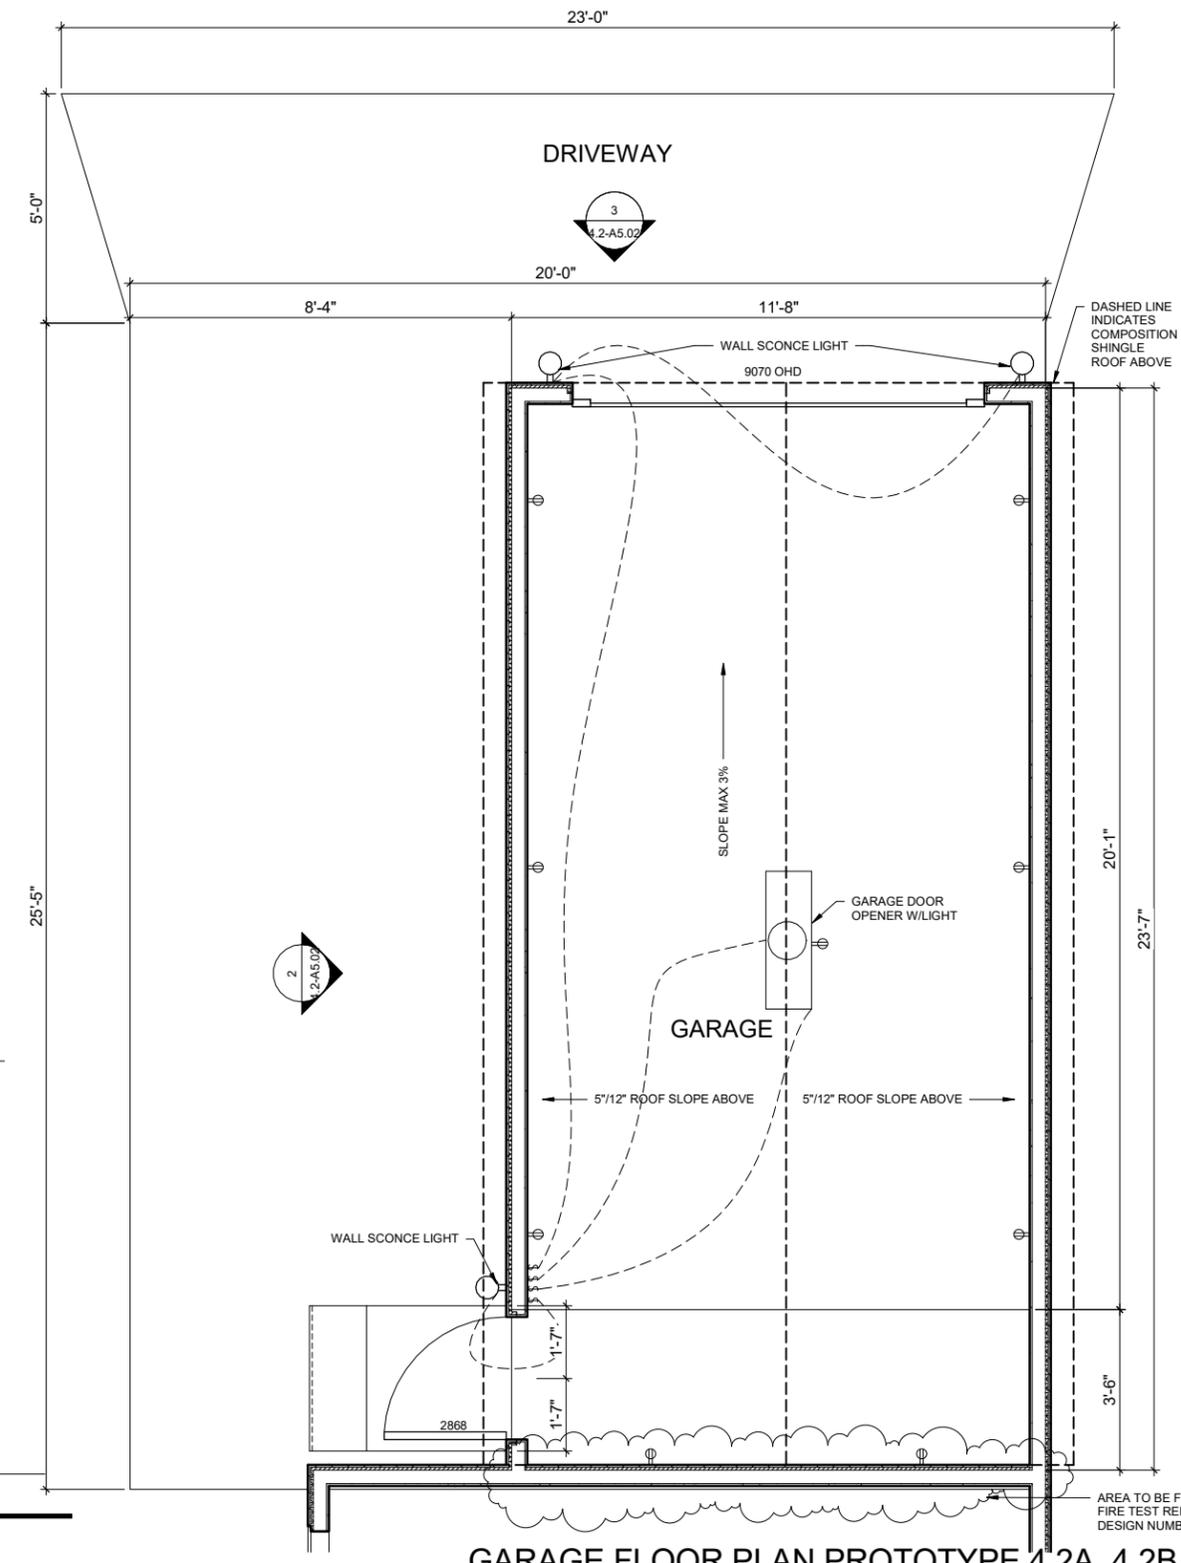

1 GARAGE FLOOR PLAN PROTOTYPE 4.2A, 4.2B, 4.2C, 4.2D
1/4" = 1'-0"

2/13/2017 4:15:02 PM

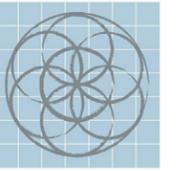

SEVENTH GENERATION DESIGN

ARCHITECTURE | SUSTAINABILITY | PRESERVATION

118 Broadway, Suite 519
San Antonio, Texas 78205
TEL (210) 262-6161 TEL (210) 241-7490

Urban at Olive

600 Block Burleson San Antonio, TX

No.	Date	Description
1	02/06/2017	Construction Set



OPTIONAL CARPORT

PROTOTYPE 4.2A OR 4.2B



February 6, 2017


Project number
Date February 6, 2017
Drawn by
Checked by

4.2-A5.03


Scale

GENERAL NOTES:


1. USE JOIST HANGERS AT EVERY 2X6 AND 2X8 FRAMING JOISTS.

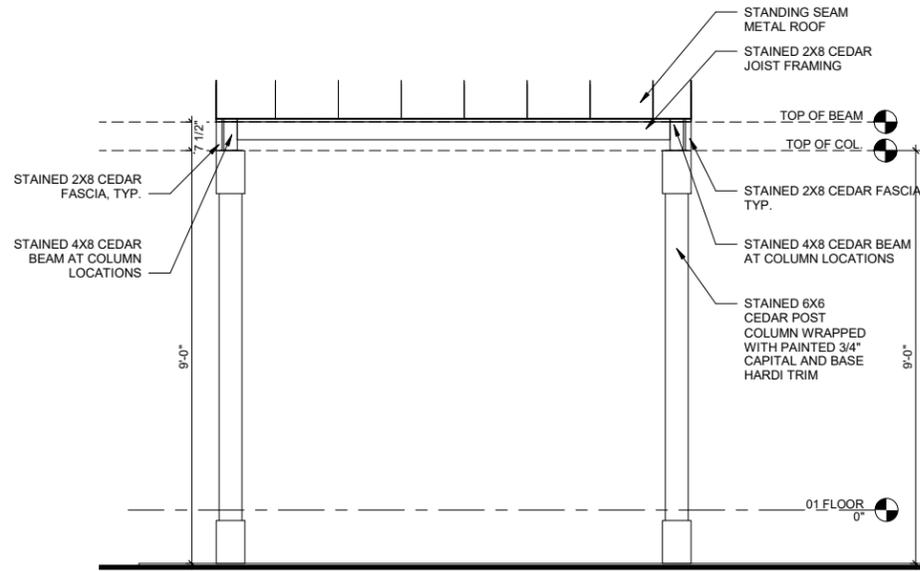

3 FRONT ELEVATION PROTOTYPE 4.2A OR 4.2B
1/4" = 1'-0"

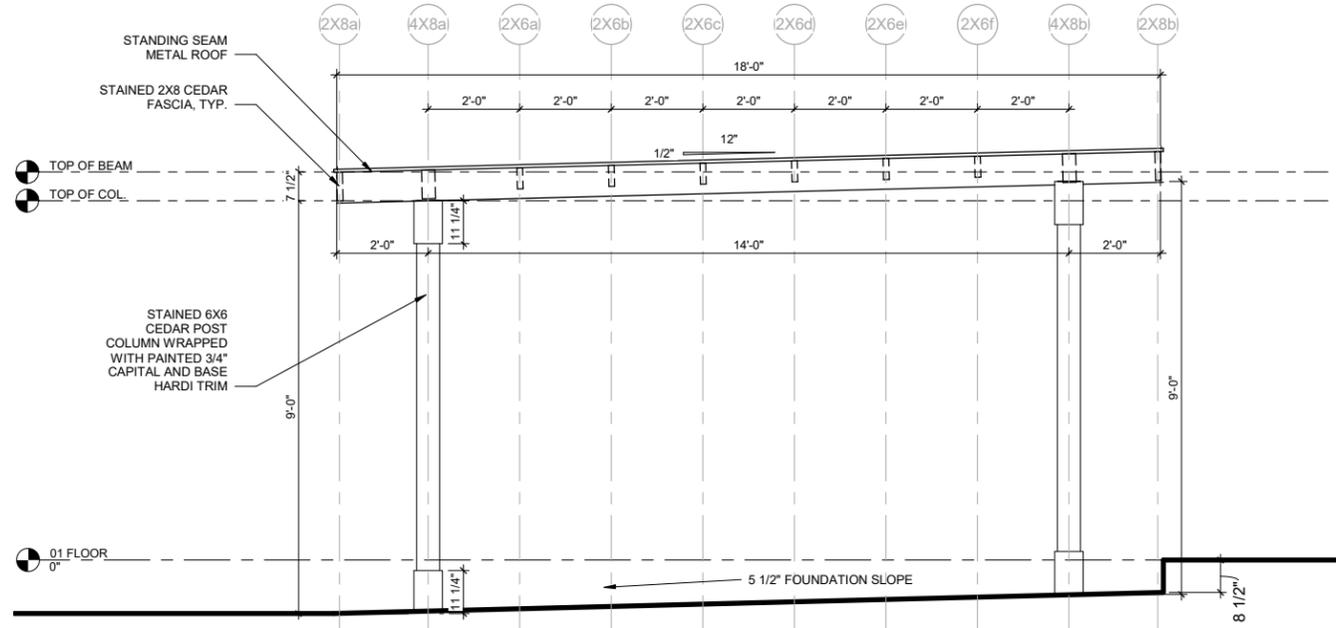

2 SIDE ELEVATION PROTOTYPE 4.2A OR 4.2B
1/4" = 1'-0"

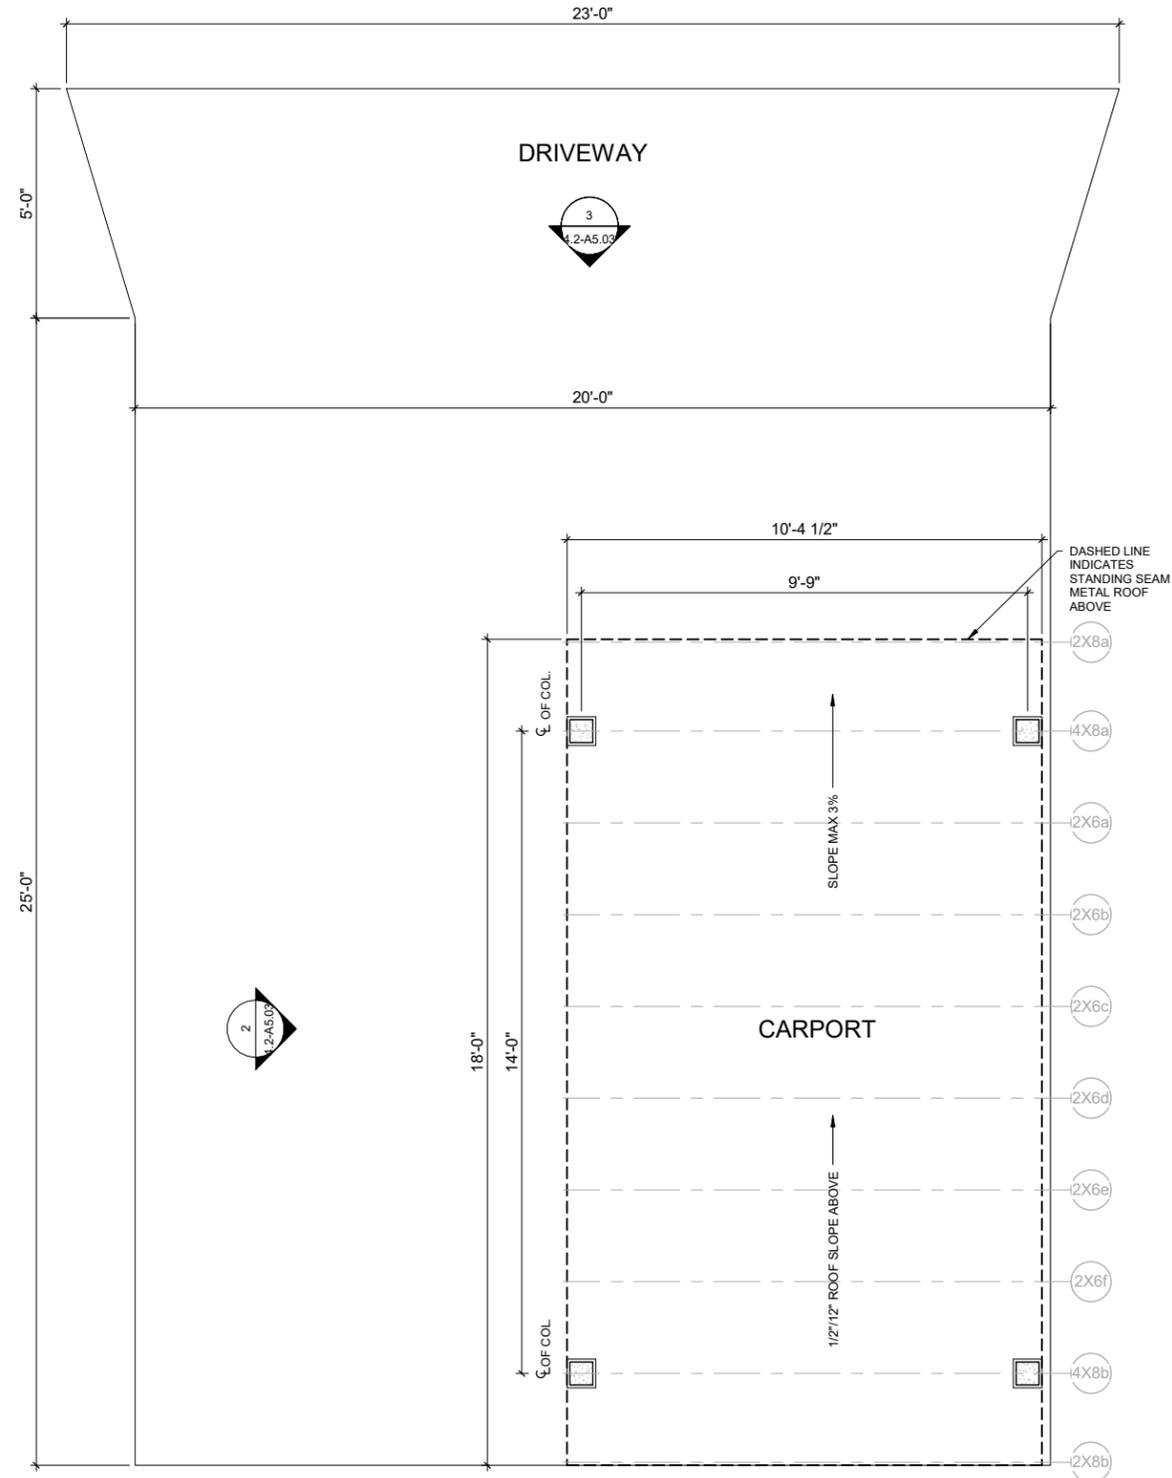

1 CARPORT FLOOR PLAN PROTOTYPE 4.2A OR 4.2B
1/4" = 1'-0"


Urban at Olive - PROTOTYPE 4.2B

TERRAMARK Urban Homes

CONSTRUCTION SET

600 Block Burleson San Antonio, TX


February 6, 2017

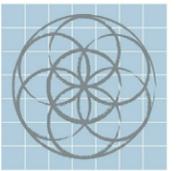

SEVENTH
GENERATION
DESIGN

ARCHITECTURE | SUSTAINABILITY | PRESERVATION

118 Broadway, Suite 519
San Antonio, Texas 78205
TEL (210) 262-6161 TEL (210) 241-7490

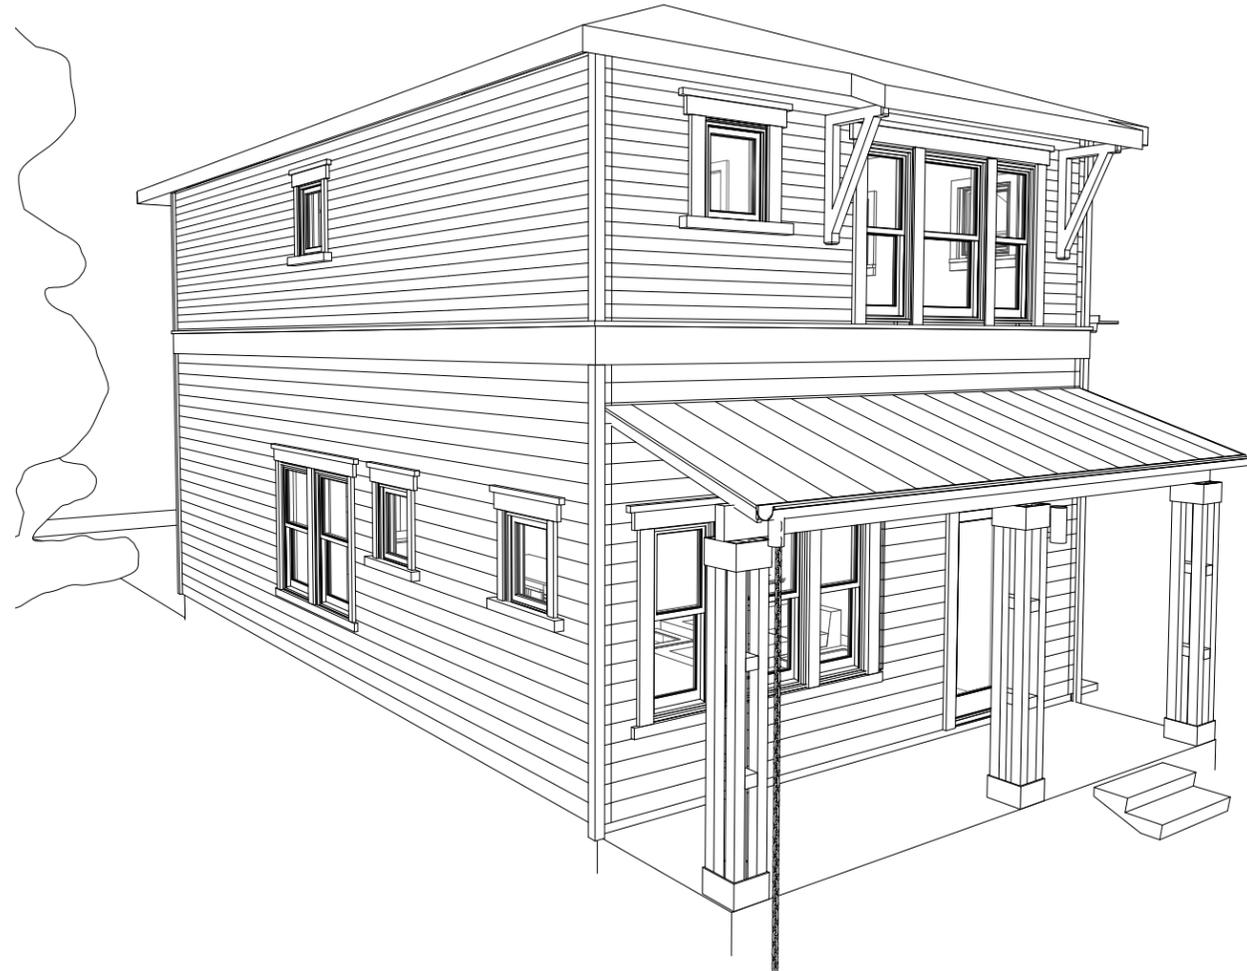

SKETCH IS CONCEPTUAL ONLY NOT FOR CONSTRUCTION

SHEET INDEX - PROTOTYPE 4.2B

NUMBER	NAME
4.2B-A0.00	COVER SHEET
4.2B-A2.03	01 FLOOR PLAN
4.2B-A2.04	02 FLOOR PLAN
4.2B-A2.05	ROOF PLAN
4.2B-A2.06	01 REFLECTED CEILING PLAN
4.2B-A2.07	02 REFLECTED CEILING PLAN
4.2B-A3.01	FRONT ELEVATION
4.2B-A3.02	BACK ELEVATION
4.2B-A3.03	SIDE ELEVATION
4.2B-A3.04	SIDE ELEVATION
4.2B-A4.01	EXTERIOR SECTIONS & DETAIL
4.2B-A4.02	STAIR PLANS SECTIONS & DETAILS
4.2-A5.01	INTERIOR ELEVATIONS & DETAILS
4.2-A5.02	OPTIONAL GARAGE
4.2-A5.03	OPTIONAL CARPORT

Urban at Olive

600 Block Burleson San
Antonio, TX


No.	Date	Description
1	02/06/2017	Construction Set

TERRAMARK
URBAN HOMES



William Carpenter

February 6, 2017

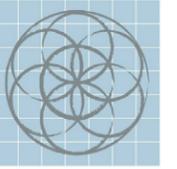

SEVENTH
GENERATION
DESIGN

ARCHITECTURE | SUSTAINABILITY | PRESERVATION

118 Broadway, Suite 519
San Antonio, Texas 78205
TEL (210) 262-6161 TEL (210) 241-7490

Urban at Olive

600 Block Burleson San
Antonio, TX

No.	Date	Description
1	02/06/2017	Construction Set



01 FLOOR PLAN

PROTOTYPE 4.2B




Scott William Carpenter
February 6, 2017

Project number
Date February 6, 2017
Drawn by
Checked by


4.2B-A2.03

Scale

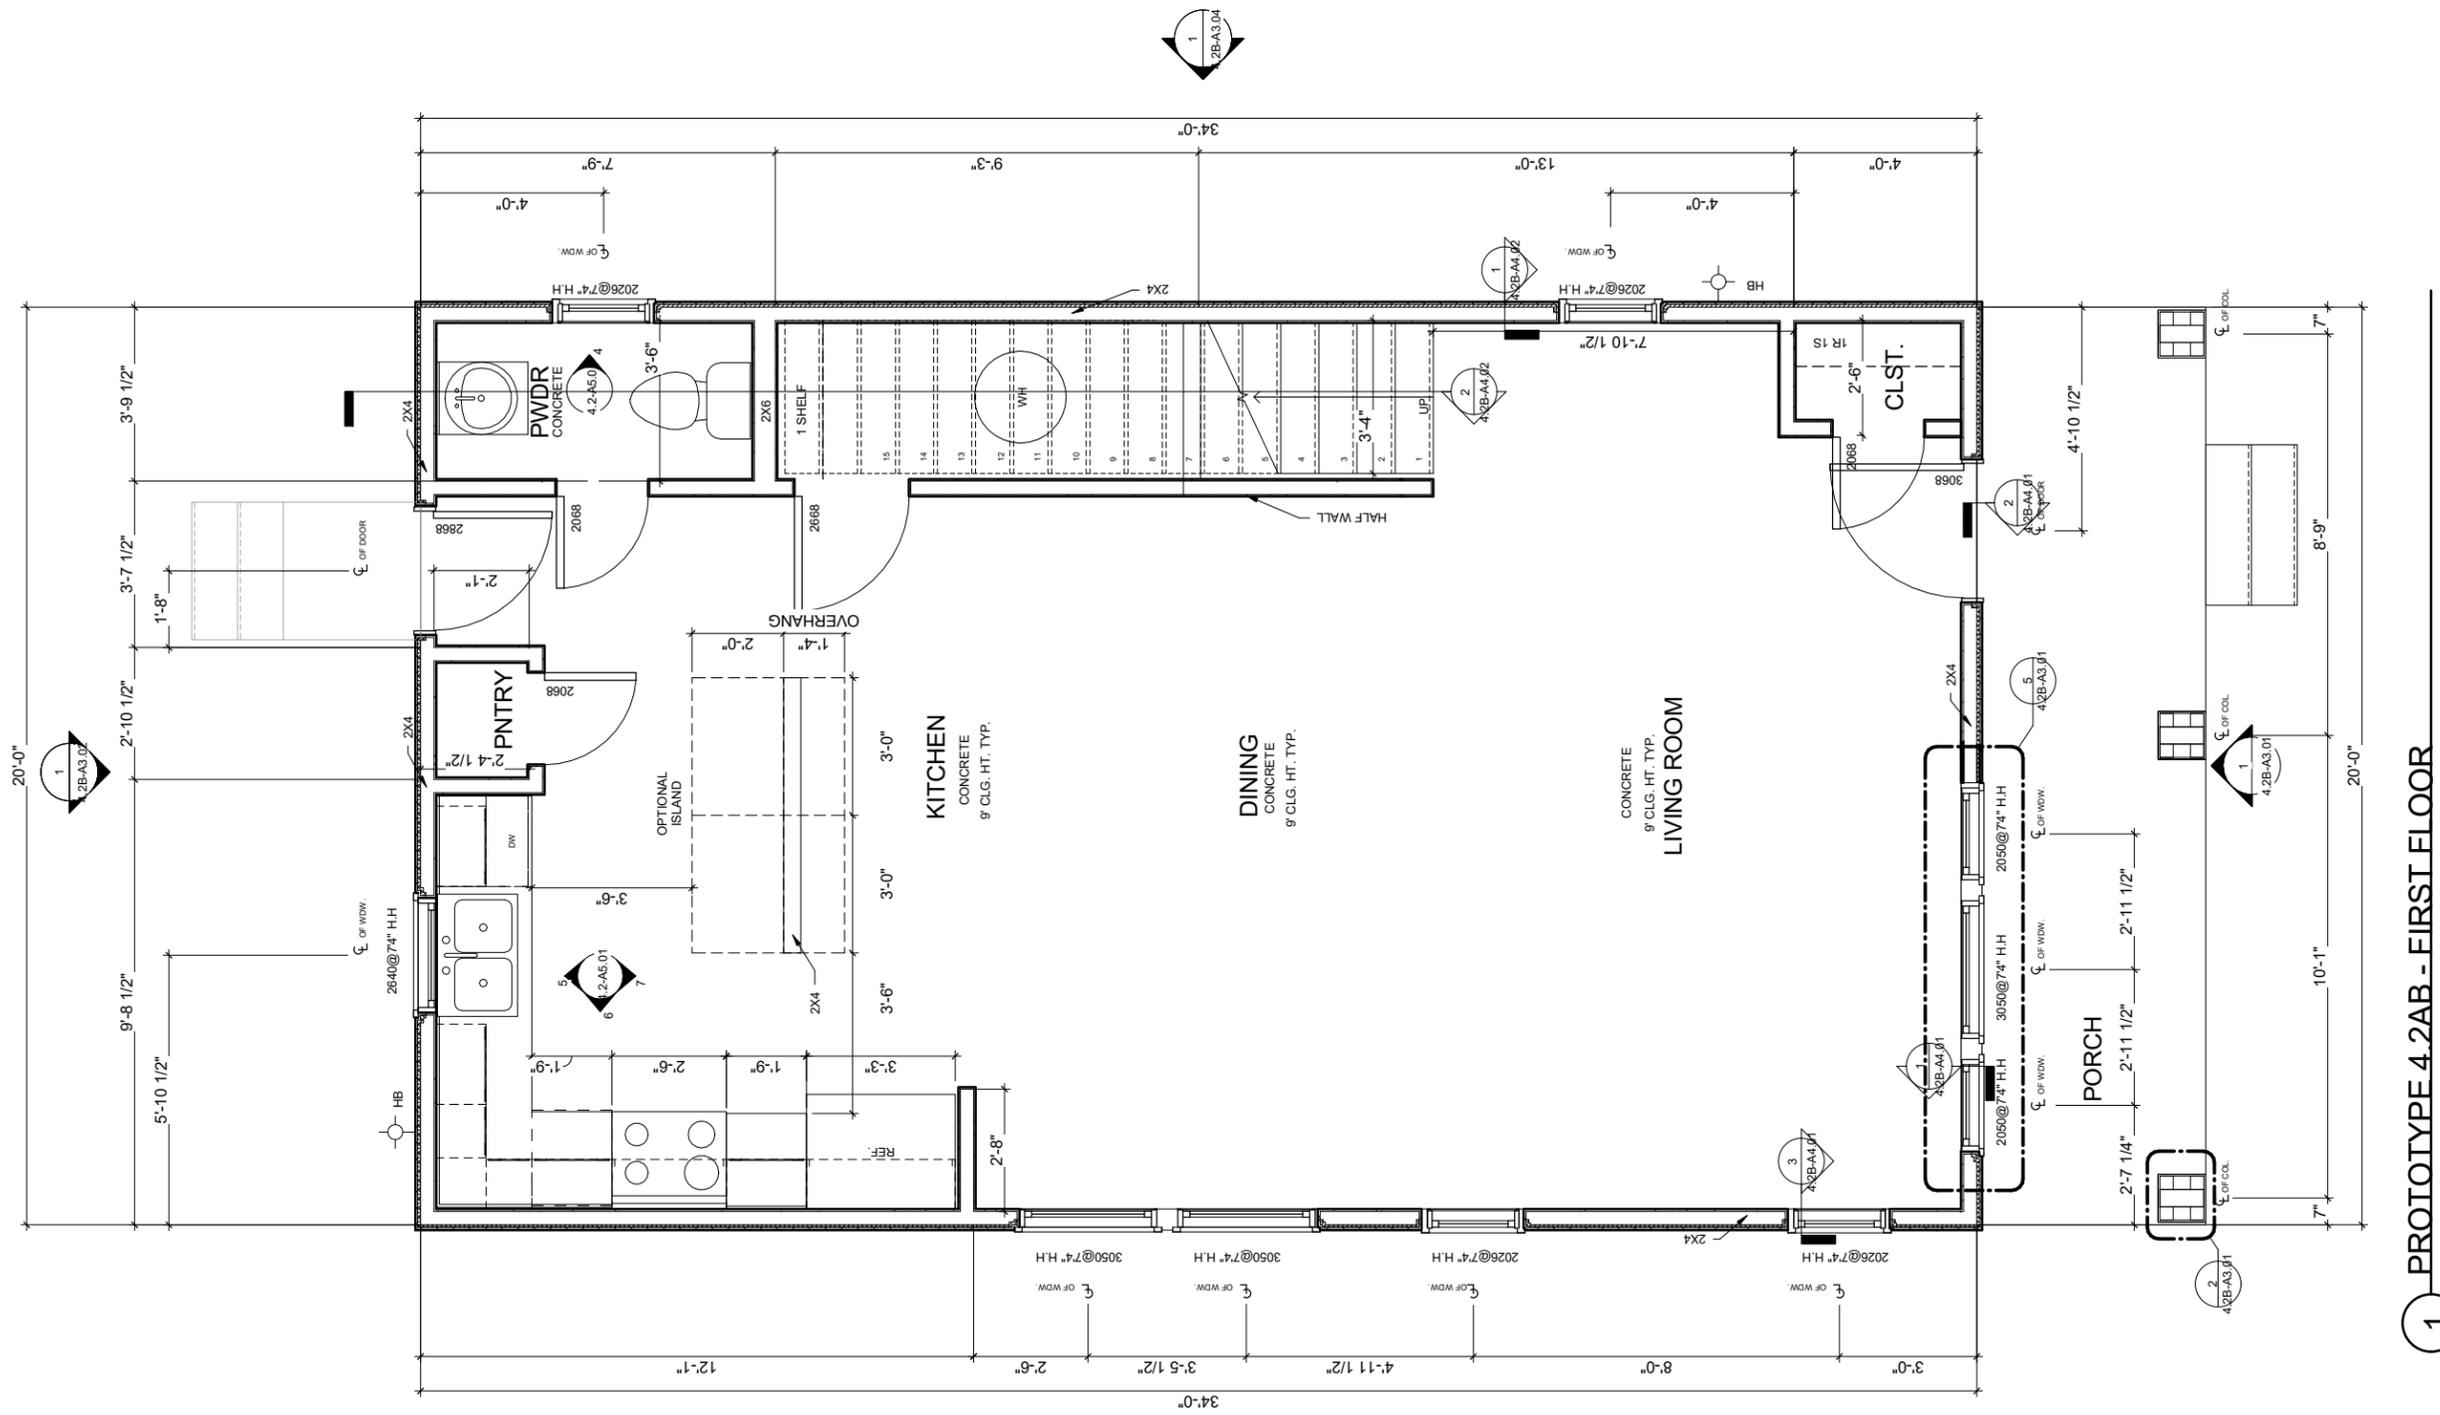

1 PROTOTYPE 4.2B - FIRST FLOOR
1/4" = 1'-0"

OVERALL LIVING + ROOF AREAS	
NAME	AREA
1ST FLOOR LIVING	680 S.F.
2ND FLOOR LIVING	632 S.F.
TOTAL LIVING	1312 S.F.
FRONT PORCH	100 S.F.
TOTAL STRUCTURE	1,412 S.F.
COMP. ROOF AREA	930 S.F.
METAL ROOF AREA	118 S.F.

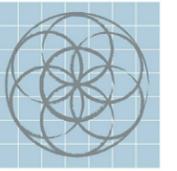

SEVENTH
GENERATION
DESIGN

ARCHITECTURE | SUSTAINABILITY | PRESERVATION

118 Broadway, Suite 519
San Antonio, Texas 78205
TEL (210) 262-6161 TEL (210) 241-7490

Urban at Olive

600 Block Burleson San
Antonio, TX

No.	Date	Description
1	02/06/2017	Construction Set



02 FLOOR PLAN

PROTOTYPE 4.2B




Scott William Carpenter
February 6, 2017

Project number
Date February 6, 2017

Drawn by
Checked by

4.2B-A2.04


Scale

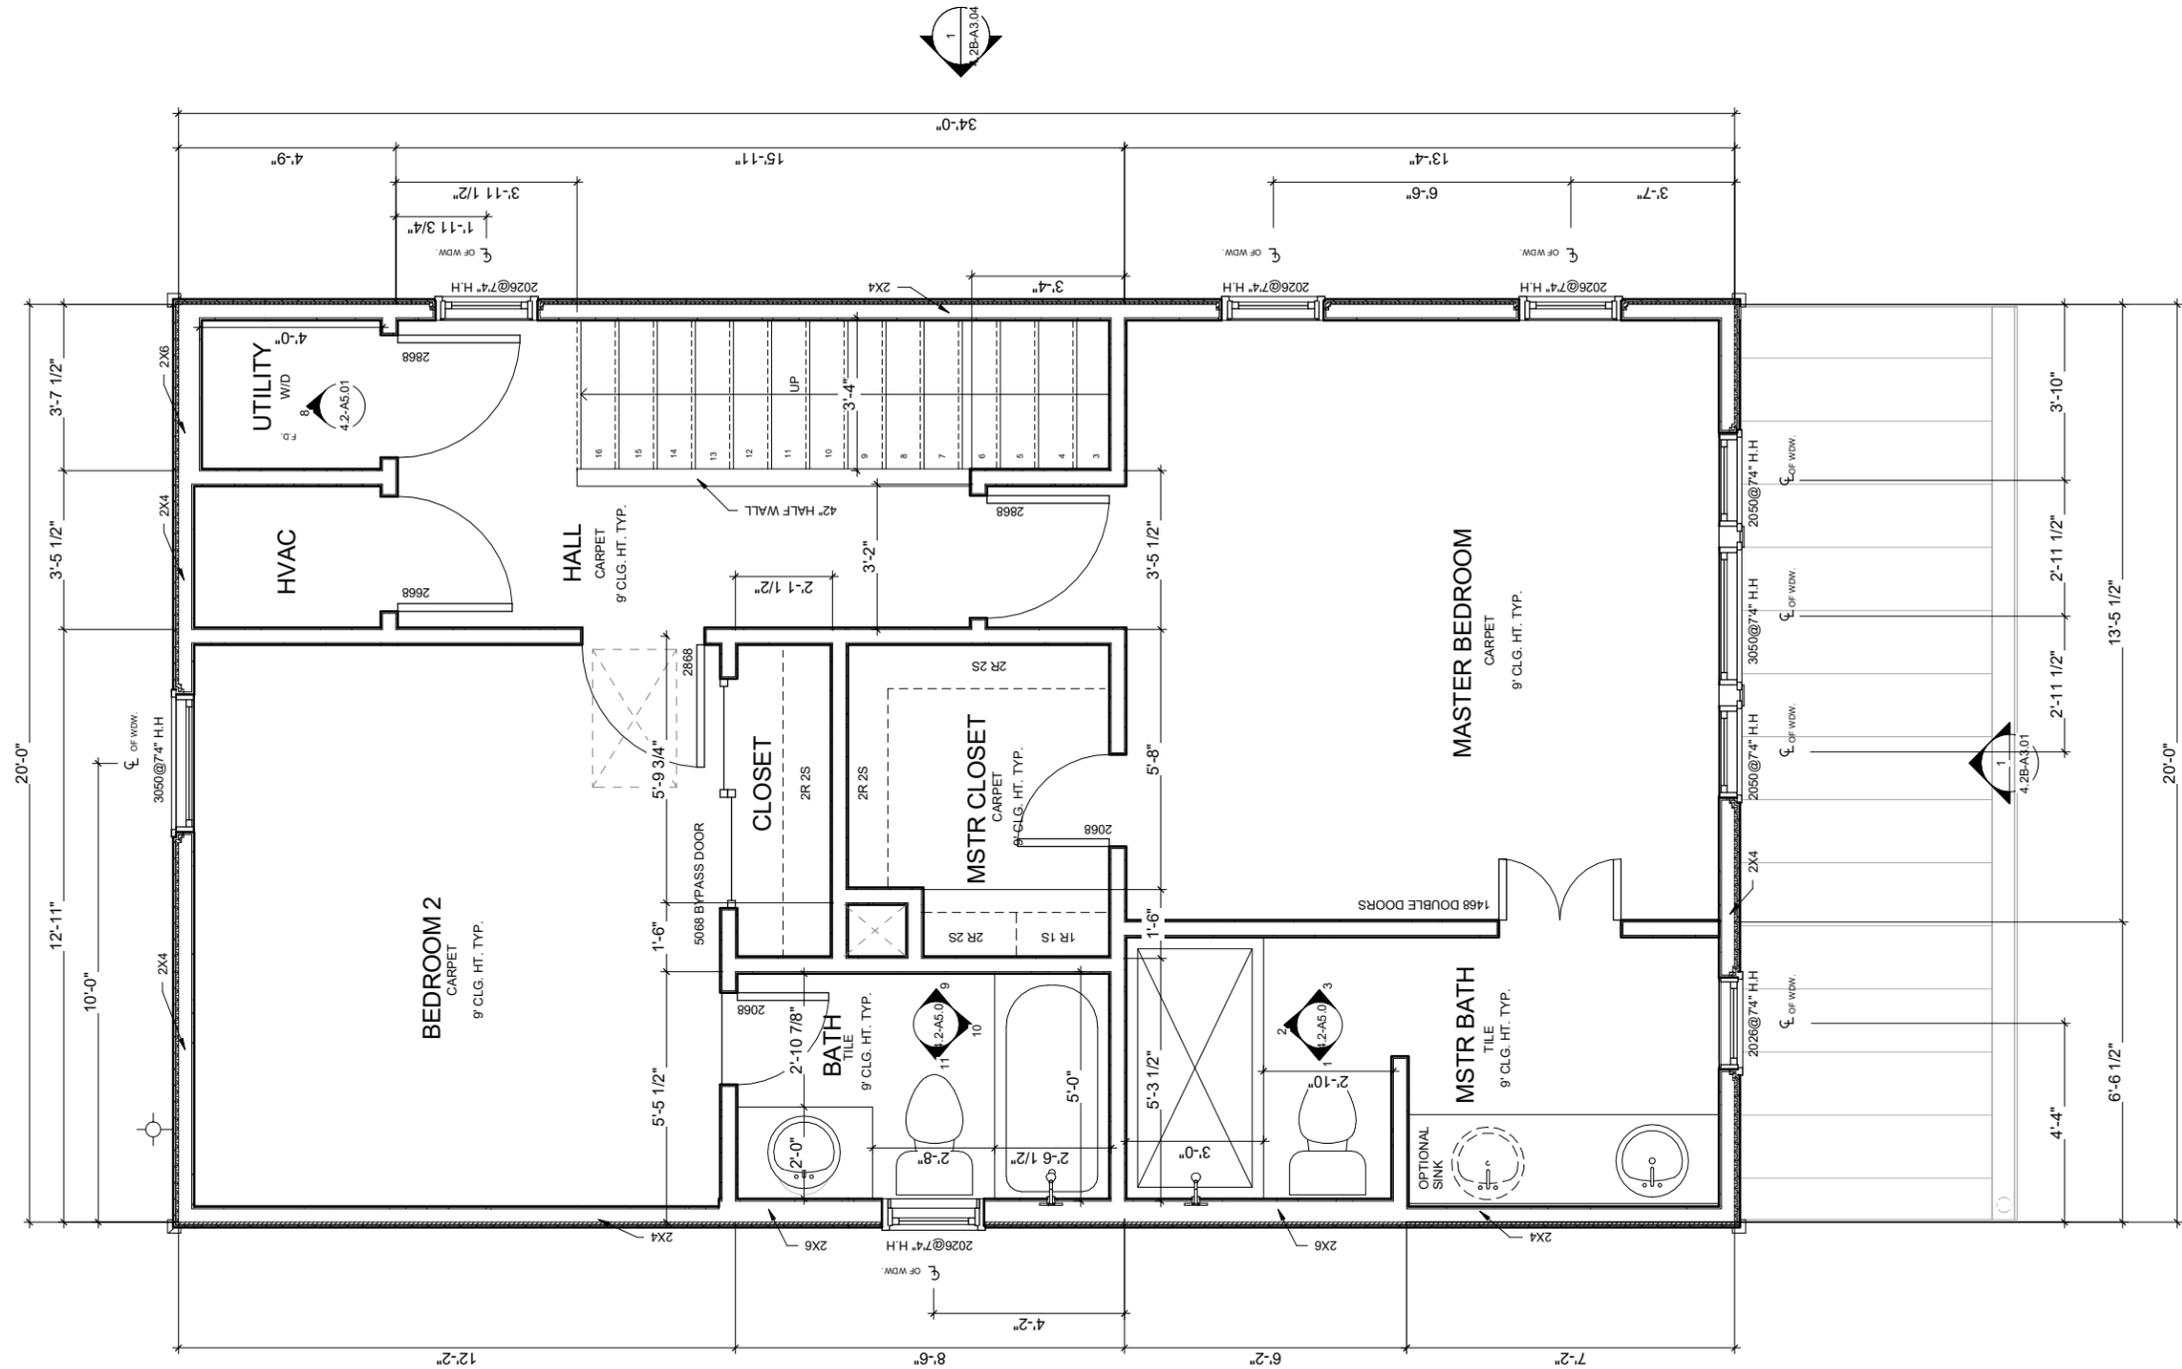


1 PROTOTYPE 4.2B - SECOND FLOOR
1/4" = 1'-0"

OVERALL LIVING + ROOF AREAS	
NAME	AREA
1ST FLOOR LIVING	680 S.F.
2ND FLOOR LIVING	632 S.F.
TOTAL LIVING	1312 S.F.
FRONT PORCH	100 S.F.
TOTAL STRUCTURE	1,412 S.F.
COMP. ROOF AREA	930 S.F.
METAL ROOF AREA	118 S.F.

2/6/2017 2:31:27 PM

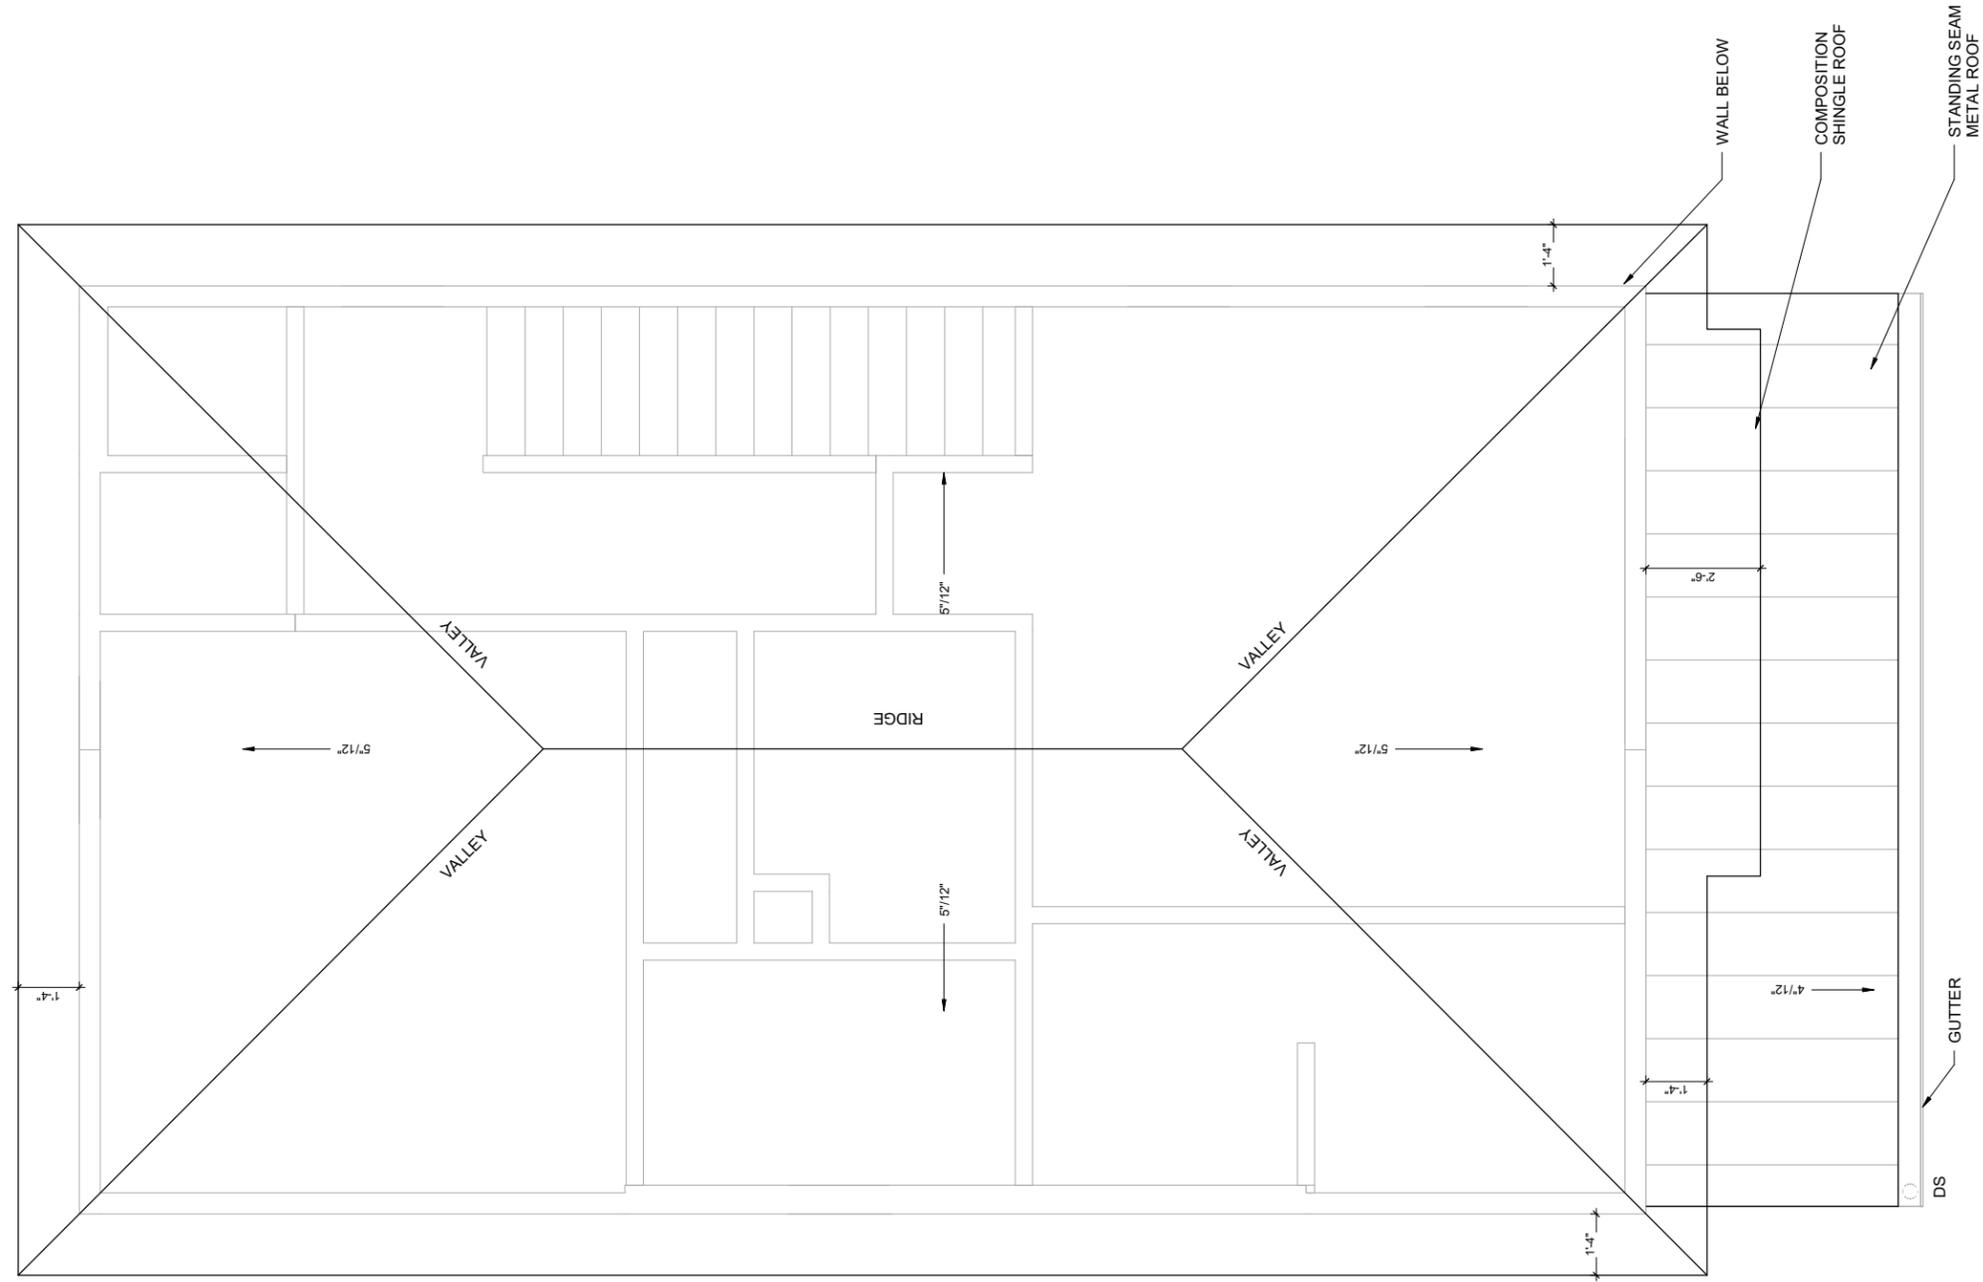

1 PROTOTYPE 4.2B - ROOF PLAN
1/4" = 1'-0"

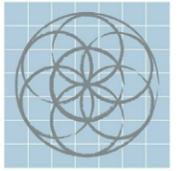

SEVENTH
GENERATION
DESIGN

ARCHITECTURE | SUSTAINABILITY | PRESERVATION
118 Broadway, Suite 519
San Antonio, Texas 78205
TEL (210) 262-6161 TEL (210) 241-7490

Urban at Olive

600 Block Burleson San
Antonio, TX

No.	Date	Description
1	02/06/2017	Construction Set



ROOF PLAN

PROTOTYPE 4.2B




Scott William Carpenter
February 6, 2017

Project number
Date February 6, 2017
Drawn by
Checked by

4.2B-A2.05

Scale

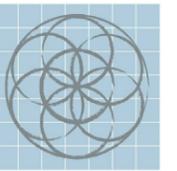

SEVENTH
GENERATION
DESIGN

ARCHITECTURE | SUSTAINABILITY | PRESERVATION

118 Broadway, Suite 519
San Antonio, Texas 78205
TEL (210) 262-6161 TEL (210) 241-7490

Urban at Olive

600 Block Burleson San
Antonio, TX

No.	Date	Description
1	02/06/2017	Construction Set



01 FLOOR REFLECTED
CEILING PLAN

PROTOTYPE 4.2B




February 6, 2017

Project number
Date February 6, 2017
Drawn by
Checked by

4.2B-A2.06


Scale

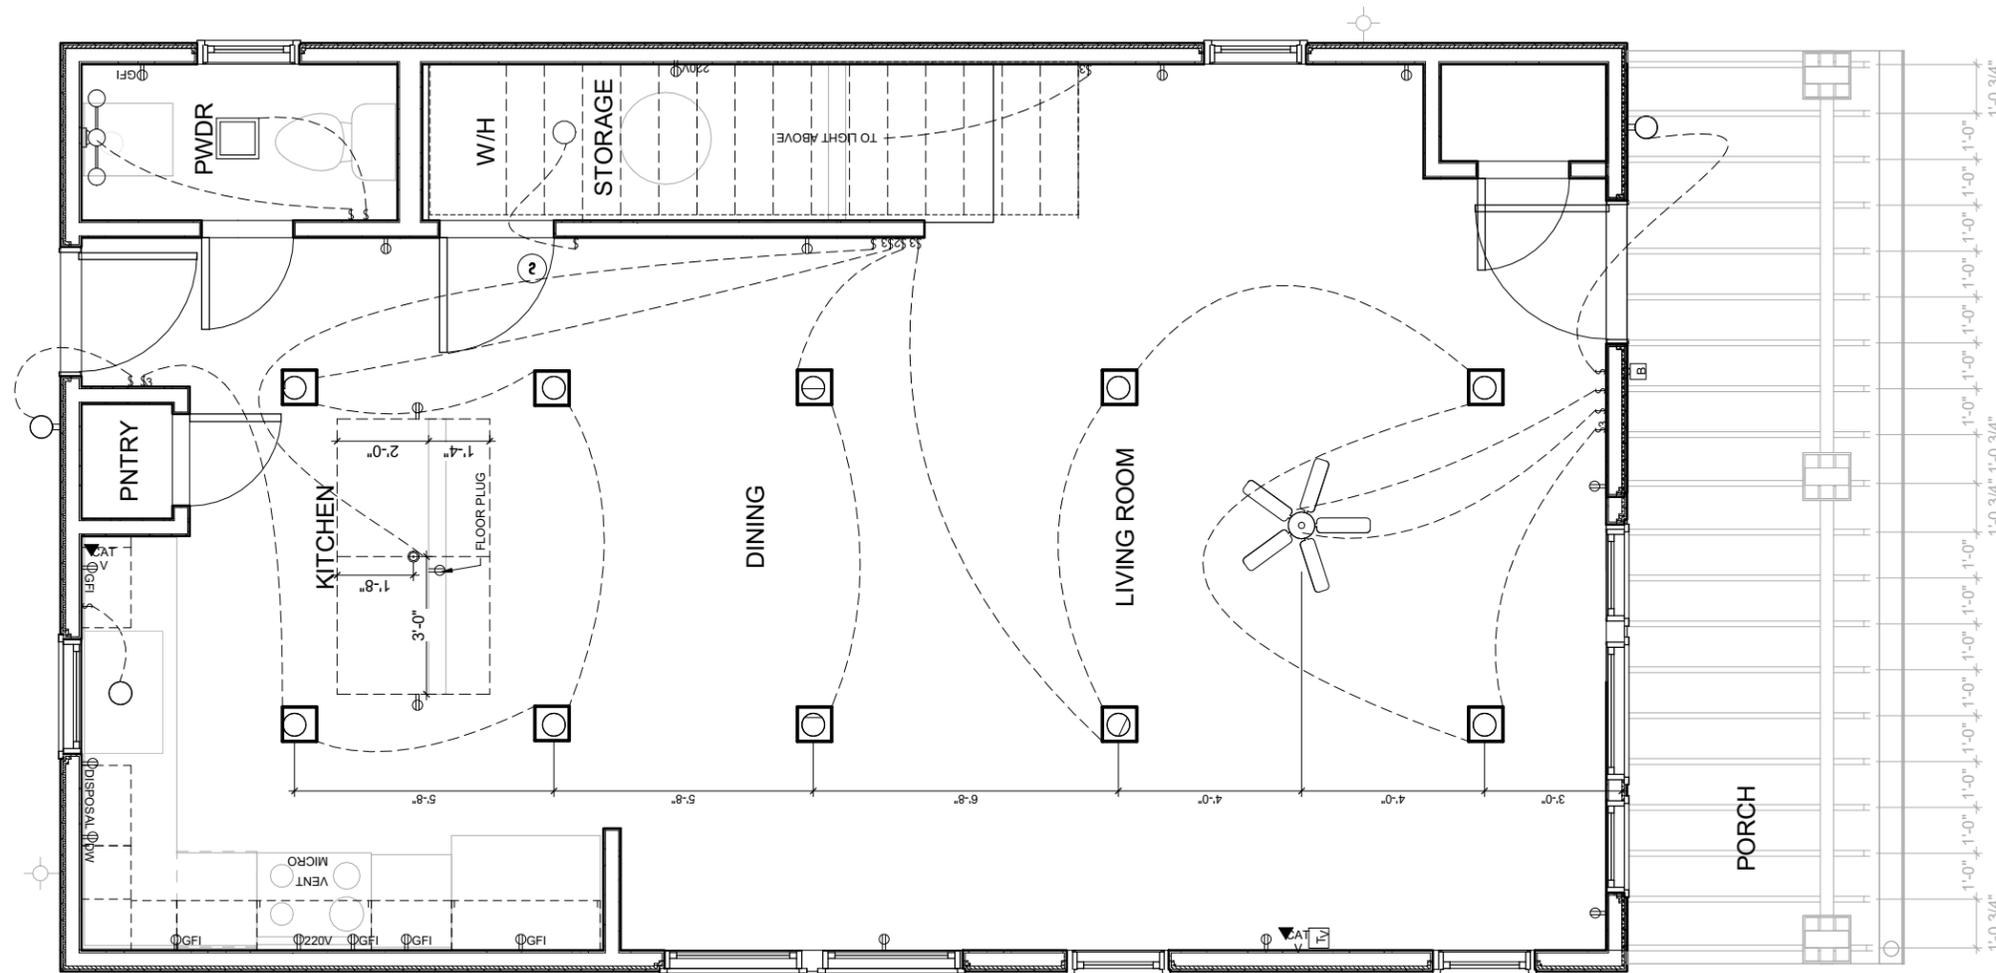

1 PROTOTYPE 4.2B - 01 REFLECTED CEILING PLAN
1/4" = 1'-0"

ELECTRICAL & CEILING PLAN LEGEND

	RECESSED LIGHT		110 VOLT DUPLEX OUTLET		THERMOSTAT
	WATERPROOF RECESSED LIGHT		220 VOLT DUPLEX OUTLET		DOORBELL
	PENDANT LIGHT		GROUND FAULT/WATERPROOF DUPLEX OUTLET		ELECTRICAL PANEL
	SURFACE MOUNTED LIGHT		DISHWASHER SWITCH		SMOKE & CARBON MONOXIDE DETECTOR
	WALL MOUNTED LIGHT		GARBAGE DISPOSAL SWITCH		TELEPHONE WALL OUTLET
	WALL MOUNTED VANITY LIGHT		ONE-WAY SWITCH		TELEVISION CABLE OUTLET
	EXHAUST FAN		TWO-WAY SWITCH		SCUTTLE ACCESS
	EXHAUST FAN W/ LIGHT COMBO				
	CEILING FAN WITH LIGHT KIT				

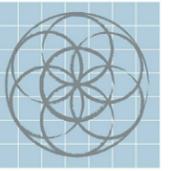

SEVENTH GENERATION DESIGN

ARCHITECTURE | SUSTAINABILITY | PRESERVATION

118 Broadway, Suite 519
San Antonio, Texas 78205
TEL (210) 262-6161 TEL (210) 241-7490

Urban at Olive

600 Block Burleson San Antonio, TX

No.	Date	Description
1	02/06/2017	Construction Set



02 FLOOR REFLECTED CEILING PLAN

PROTOTYPE 4.2B




February 6, 2017

Project number
Date February 6, 2017

Drawn by
Checked by

4.2B-A2.07


Scale

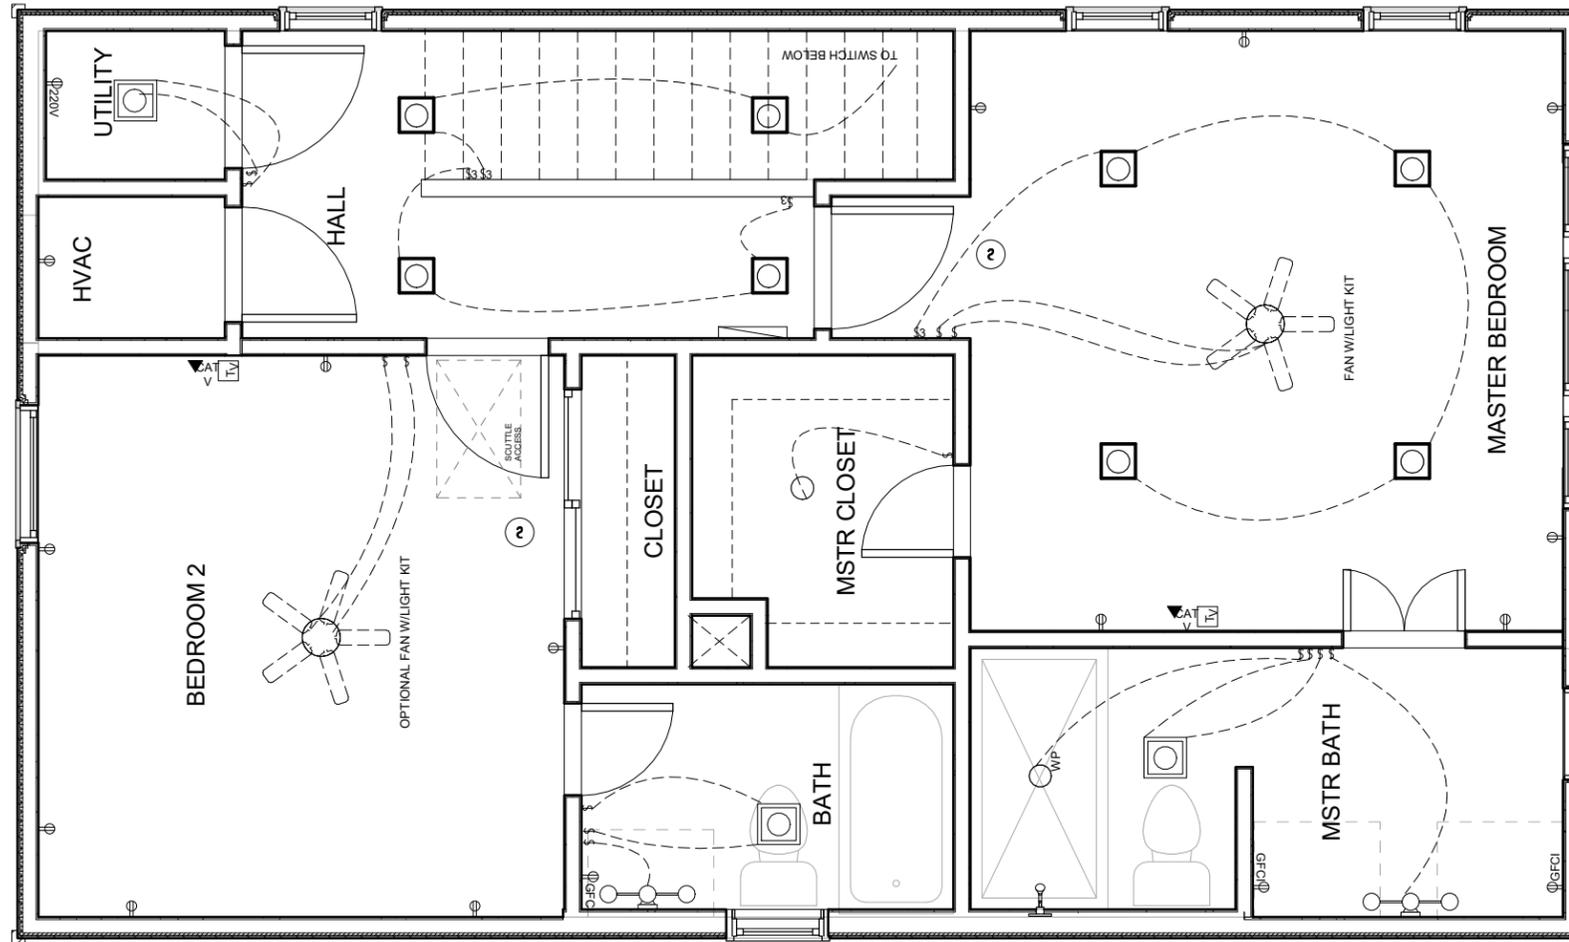

1 PROTOTYPE 4.2B - 02 REFLECTED CEILING PLAN
1/4" = 1'-0"

ELECTRICAL & CEILING PLAN LEGEND


	RECESSED LIGHT		110 VOLT DUPLEX OUTLET		THERMOSTAT
	WATERPROOF RECESSED LIGHT		220 VOLT DUPLEX OUTLET		DOORBELL
	PENDANT LIGHT		GROUND FAULT/WATERPROOF DUPLEX OUTLET		ELECTRICAL PANEL
	SURFACE MOUNTED LIGHT		DISHWASHER SWITCH		SMOKE & CARBON MONOXIDE DETECTOR
	WALL MOUNTED LIGHT		GARBAGE DISPOSAL SWITCH		TELEPHONE WALL OUTLET
	WALL MOUNTED VANITY LIGHT		ONE-WAY SWITCH		TELEVISION CABLE OUTLET
	EXHAUST FAN		TWO-WAY SWITCH		SCUTTLE ACCESS
	EXHAUST FAN W/ LIGHT COMBO				
	CEILING FAN WITH LIGHT KIT				

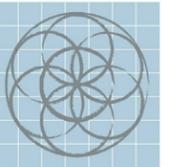


SEVENTH
GENERATION
DESIGN

ARCHITECTURE | SUSTAINABILITY | PRESERVATION

118 Broadway, Suite 519
San Antonio, Texas 78205
TEL (210) 262-6161 TEL (210) 241-7490

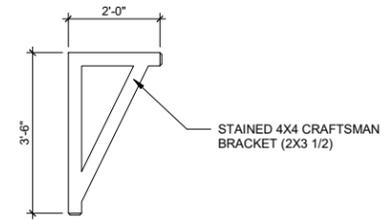

2 CRAFTSMAN BRACKET ELEVATION

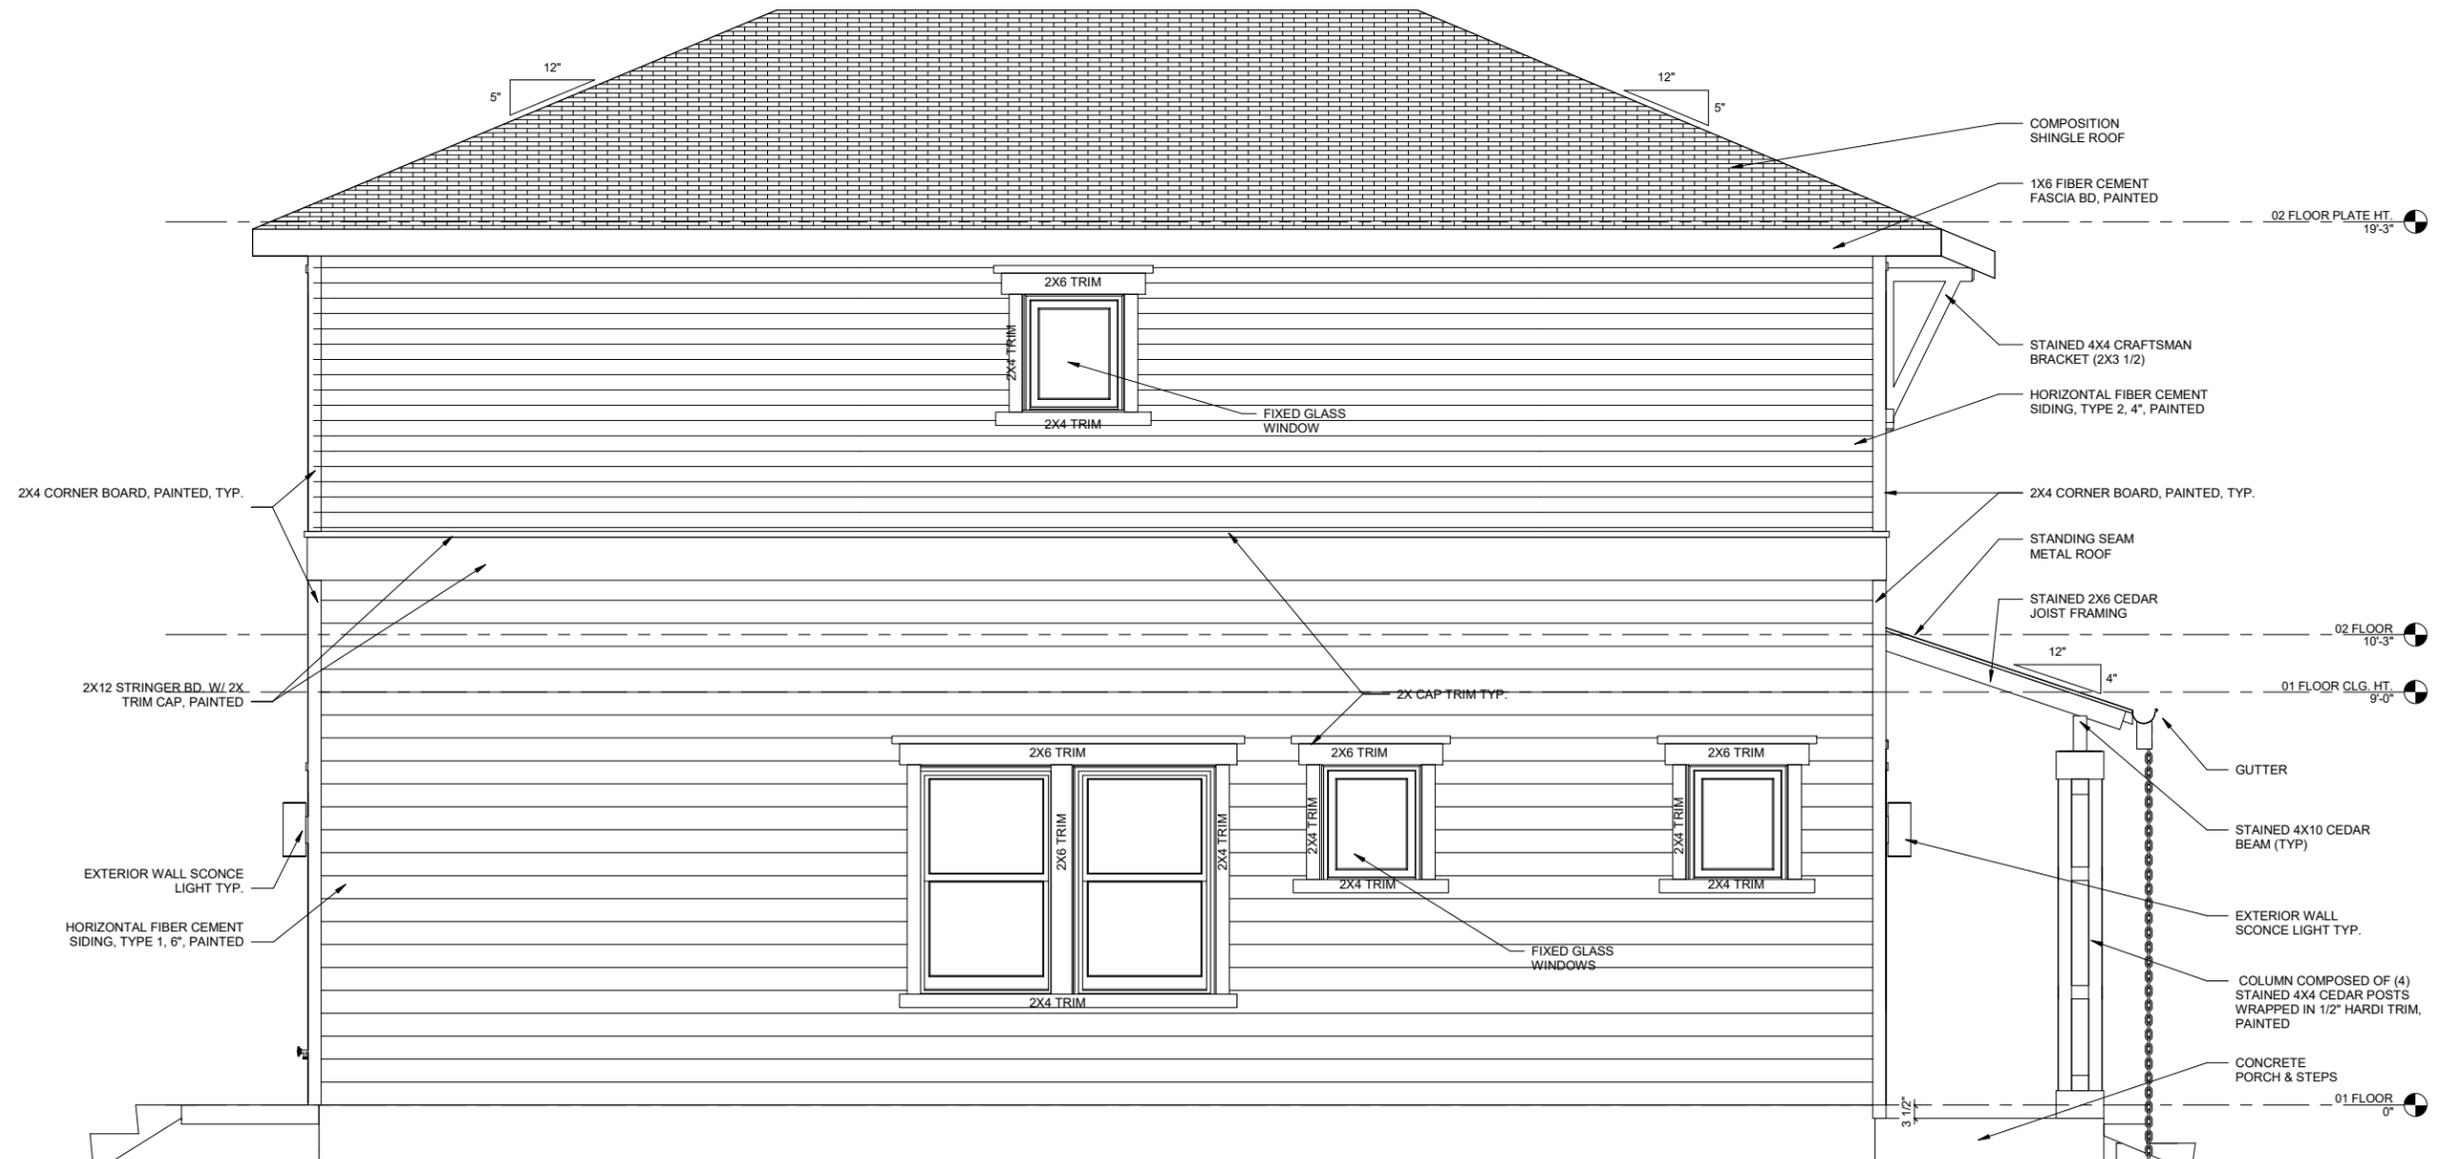

1 PROTOTYPE 4.2B - SIDE ELEVATION
1/4" = 1'-0"

Urban at Olive

600 Block Burleson San Antonio, TX

No.	Date	Description
1	02/06/2017	Construction Set



SIDE ELEVATION

PROTOTYPE 4.2B



William Cupron
February 6, 2017


Project number
Date February 6, 2017

Drawn by
Checked by

4.2B-A3.03

Scale

2/6/2017 5:21:43 PM

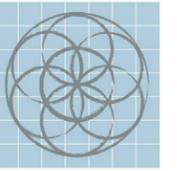

SEVENTH
GENERATION
DESIGN

ARCHITECTURE | SUSTAINABILITY | PRESERVATION

118 Broadway, Suite 519
San Antonio, Texas 78205
TEL (210) 262-6161 TEL (210) 241-7490

Urban at Olive

600 Block Burleson San
Antonio, TX

No.	Date	Description
1	02/06/2017	Construction Set



SIDE ELEVATION

PROTOTYPE 4.2B




February 6, 2017

Project number
Date February 6, 2017
Drawn by
Checked by


4.2B-A3.04

Scale

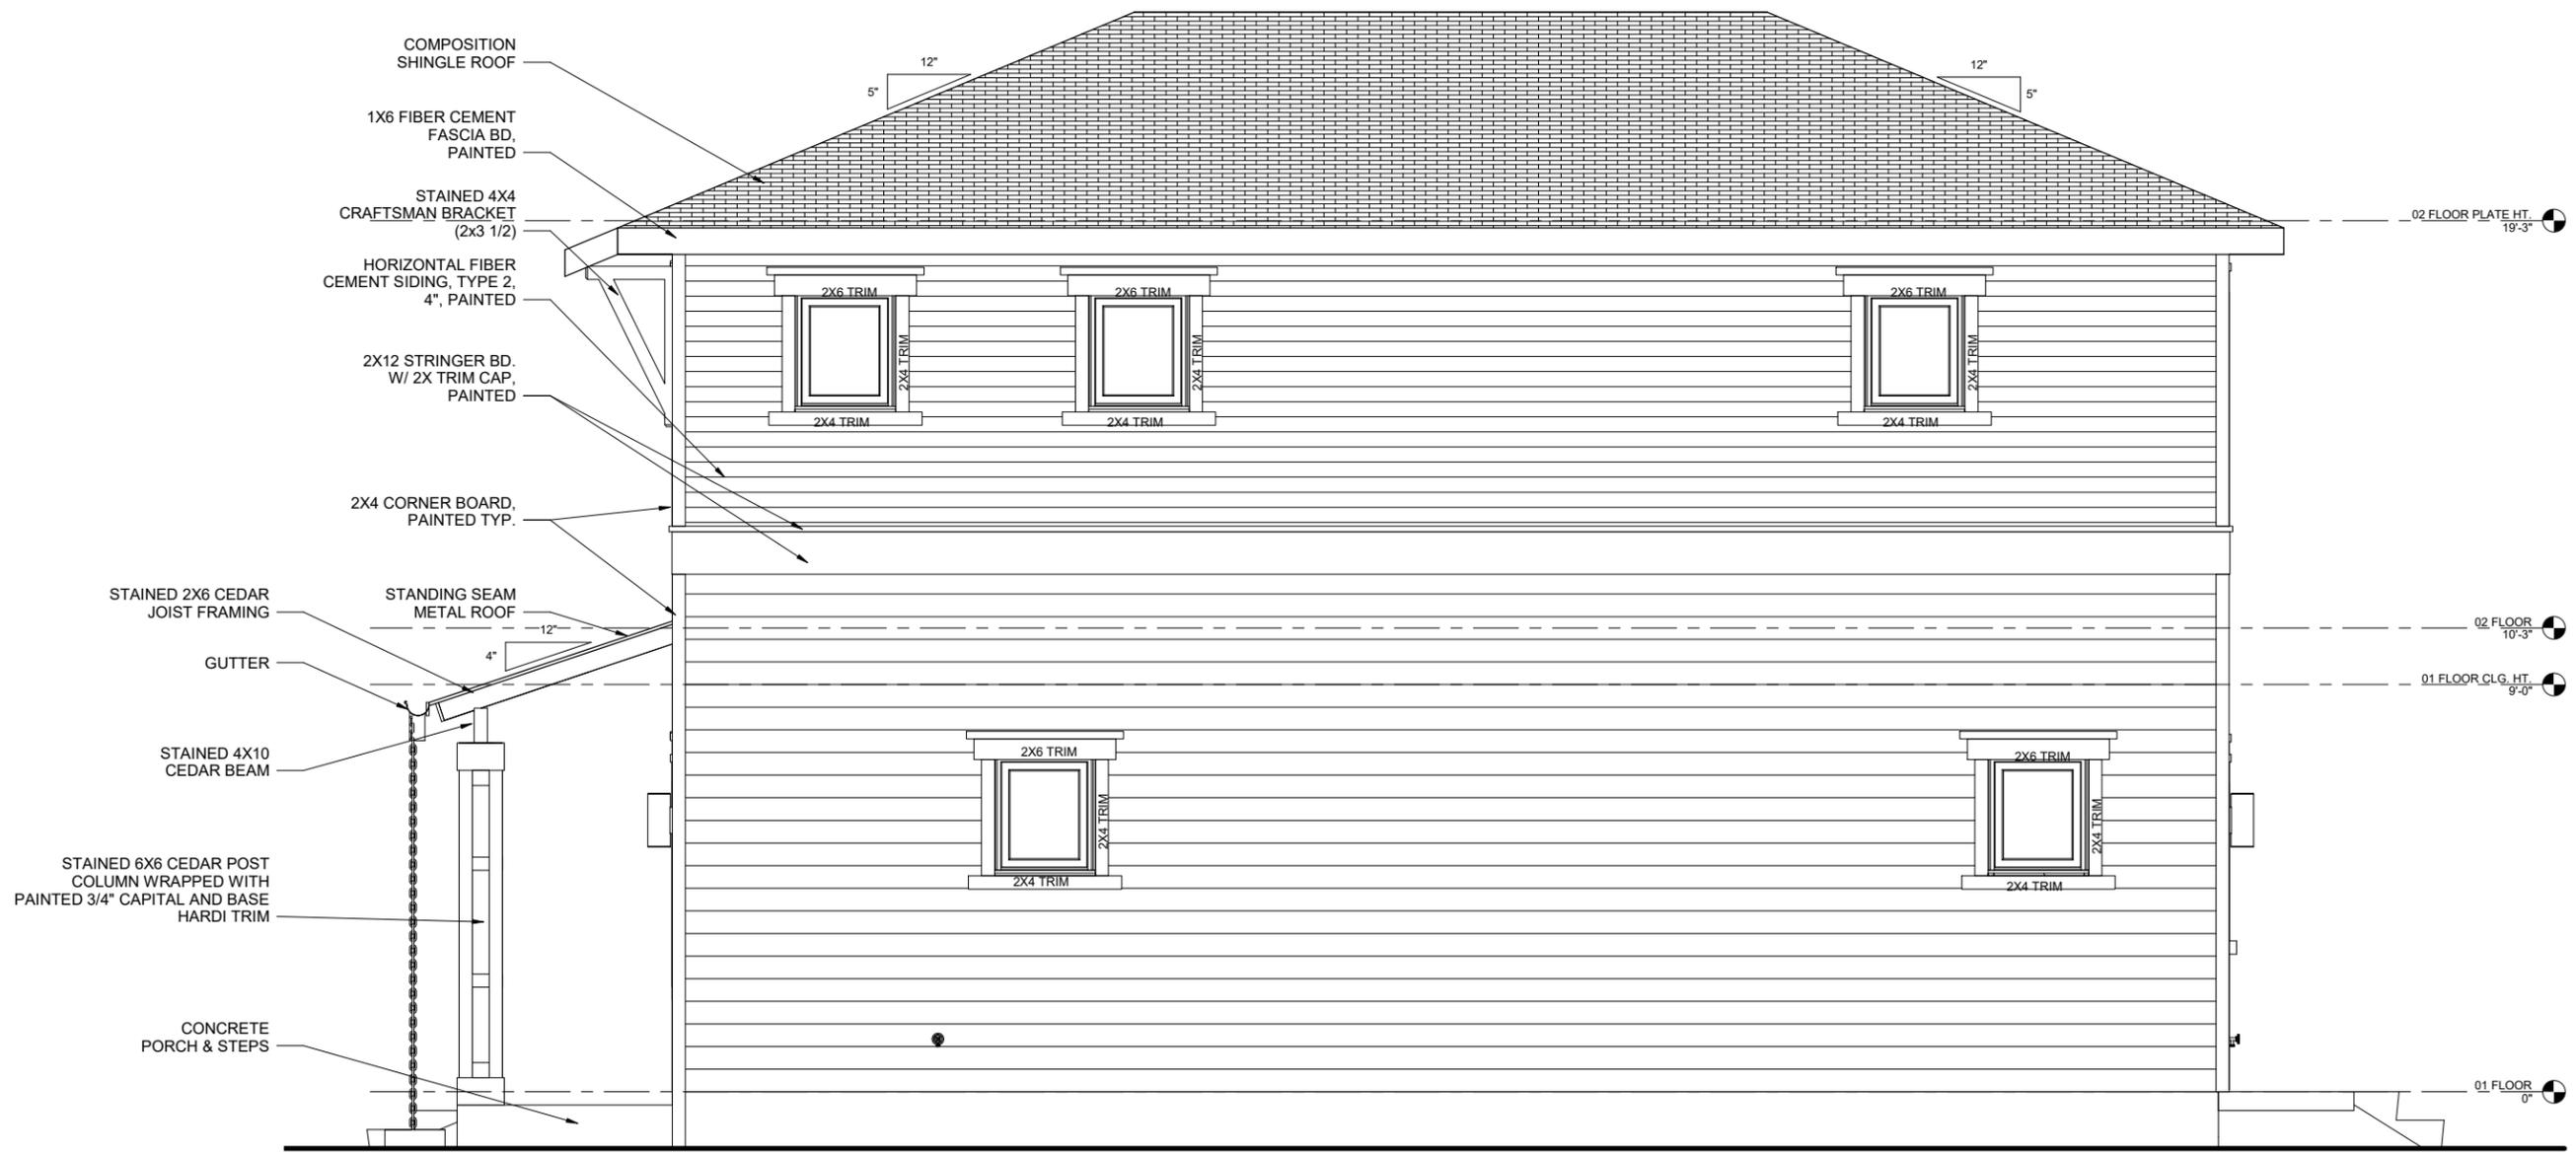

1 PROTOTYPE 4.2B - SIDE ELEVATION
1/4" = 1'-0"

2/6/2017 2:40:35 PM

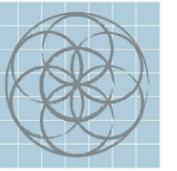


SEVENTH GENERATION DESIGN

ARCHITECTURE | SUSTAINABILITY | PRESERVATION
118 Broadway, Suite 519
San Antonio, Texas 78205
TEL (210) 262-6161 TEL (210) 241-7490

INSULATION LEGEND

- INDICATES WEATHER BARRIER
- XXXXXX THERMAL INSULATION (DENOTES THERMAL ENVELOPE)

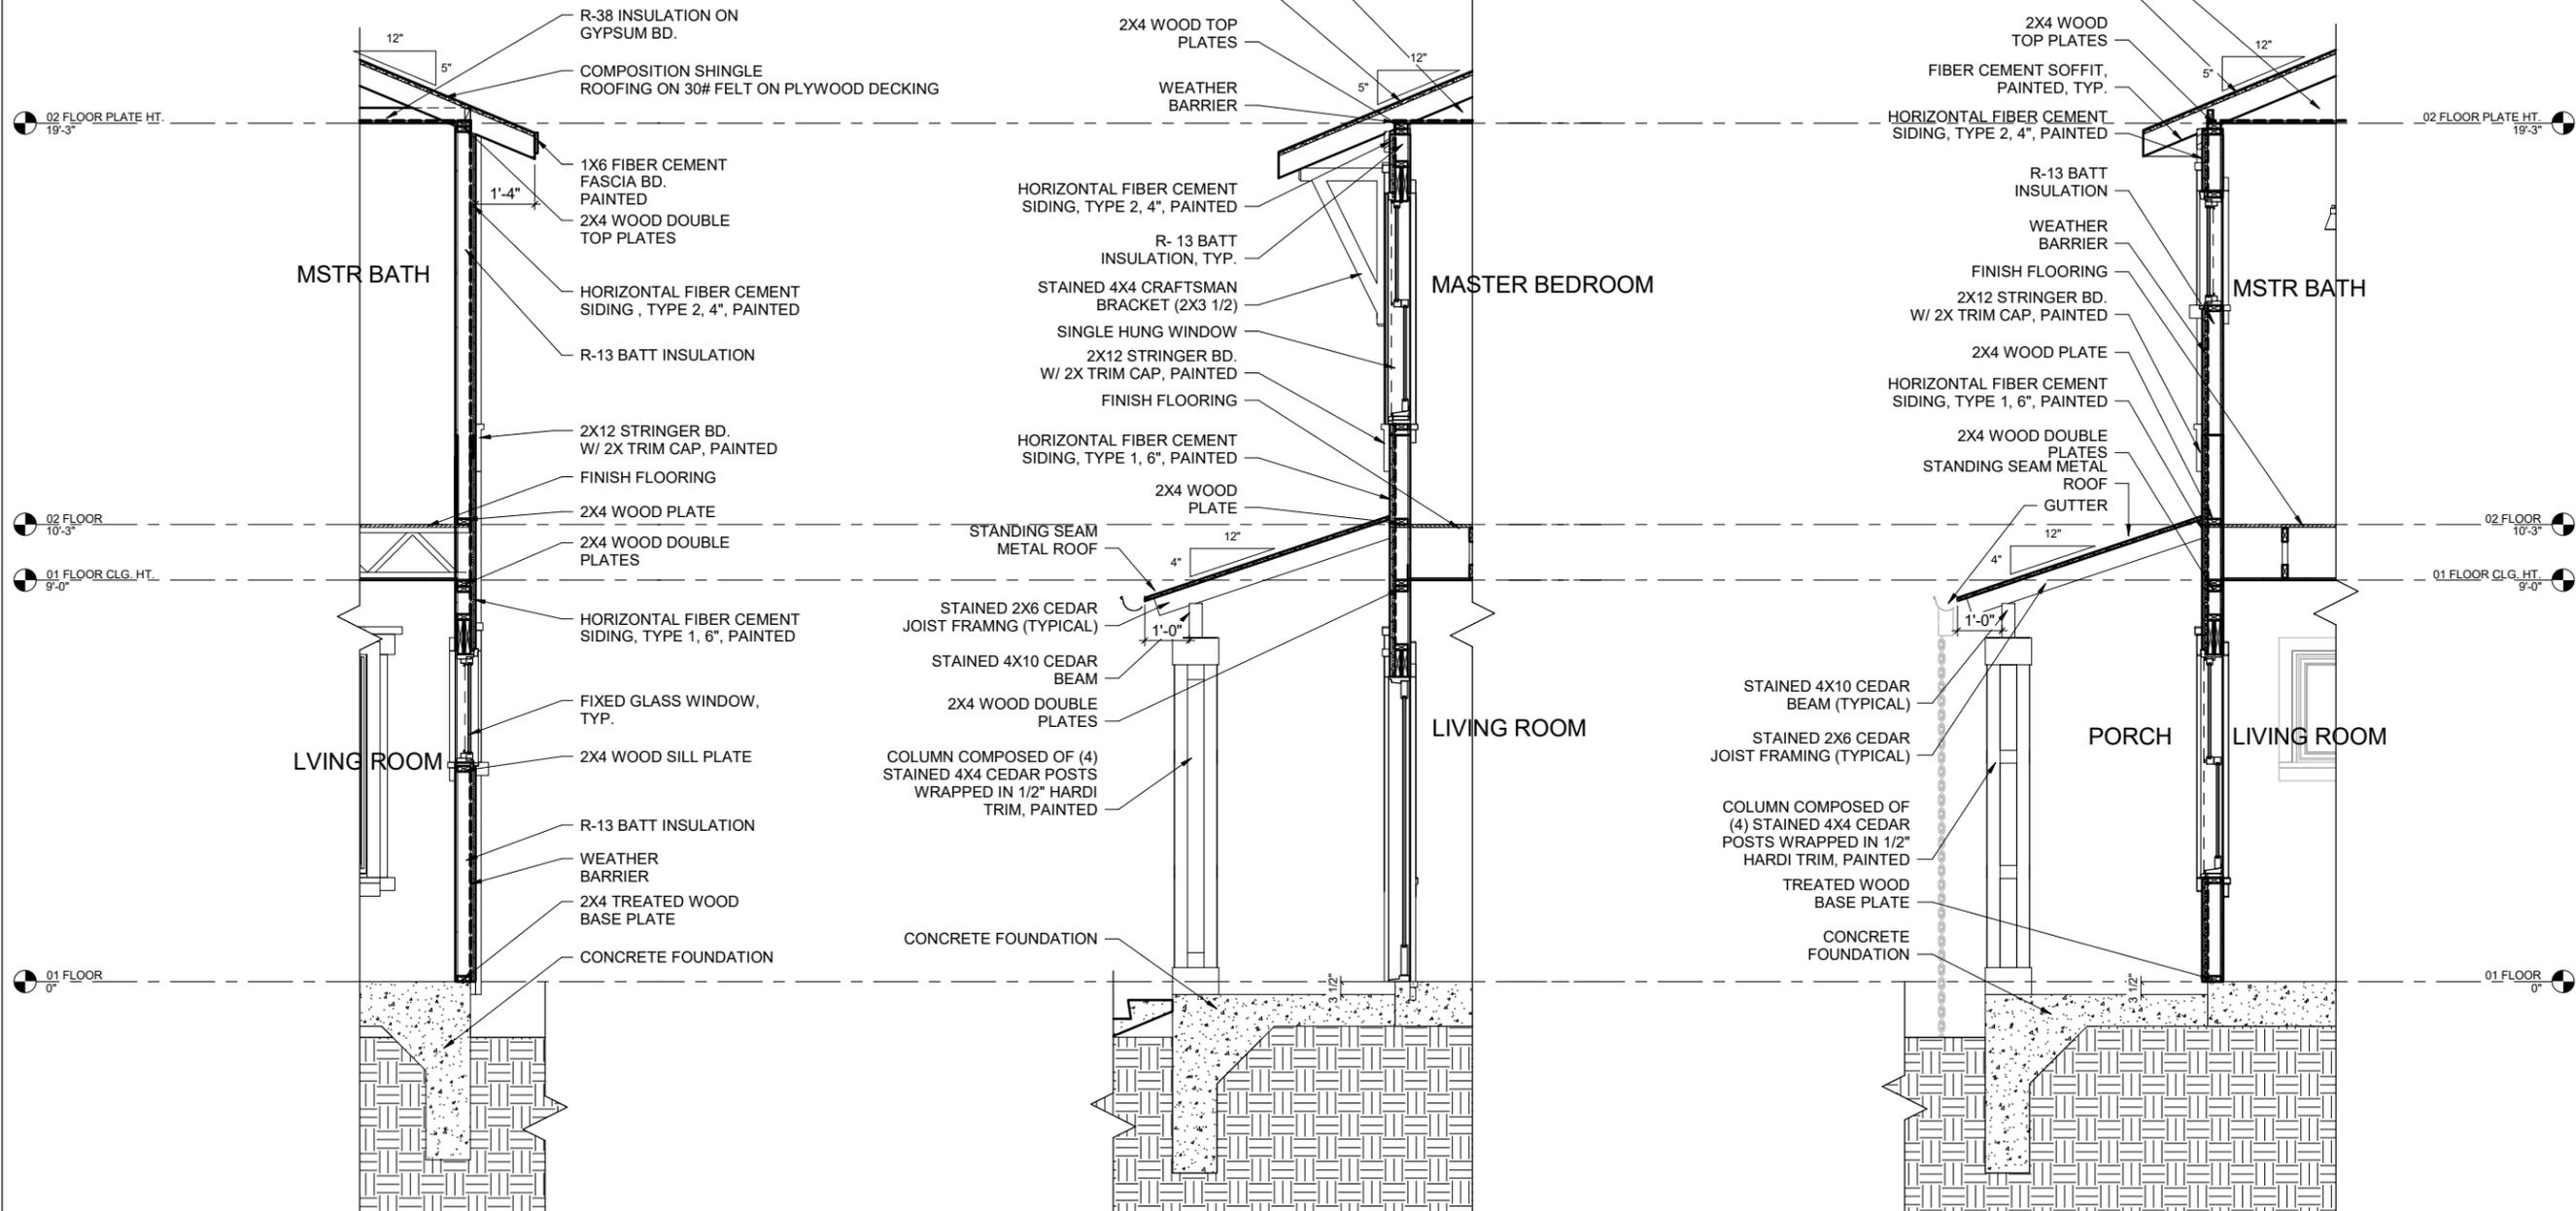

3 PROTOTYPE 4.2B - WALL SECTION AT LIVING RM. 1/4" = 1'-0"

2 PROTOTYPE 4.2B - SECTION AT FRONT WALL 1/4" = 1'-0"

1 PROTOTYPE 4.2B - PARTIAL SECTION AT PORCH 1/4" = 1'-0"

Urban at Olive

600 Block Burleson San Antonio, TX

No.	Date	Description
1	02/06/2017	Construction Set



EXTERIOR SECTIONS & DETAILS

PROTOTYPE 4.2B




February 6, 2017

Project number
Date February 6, 2017
Drawn by
Checked by

4.2B-A4.01

Scale

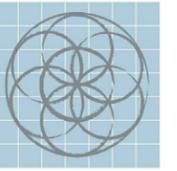


SEVENTH
GENERATION
DESIGN

ARCHITECTURE | SUSTAINABILITY | PRESERVATION


118 Broadway, Suite 519
San Antonio, Texas 78205
TEL (210) 262-6161 TEL (210) 241-7490

INSULATION LEGEND

- INDICATES WEATHER BARRIER
- THERMAL INSULATION (DENOTES THERMAL ENVELOPE)

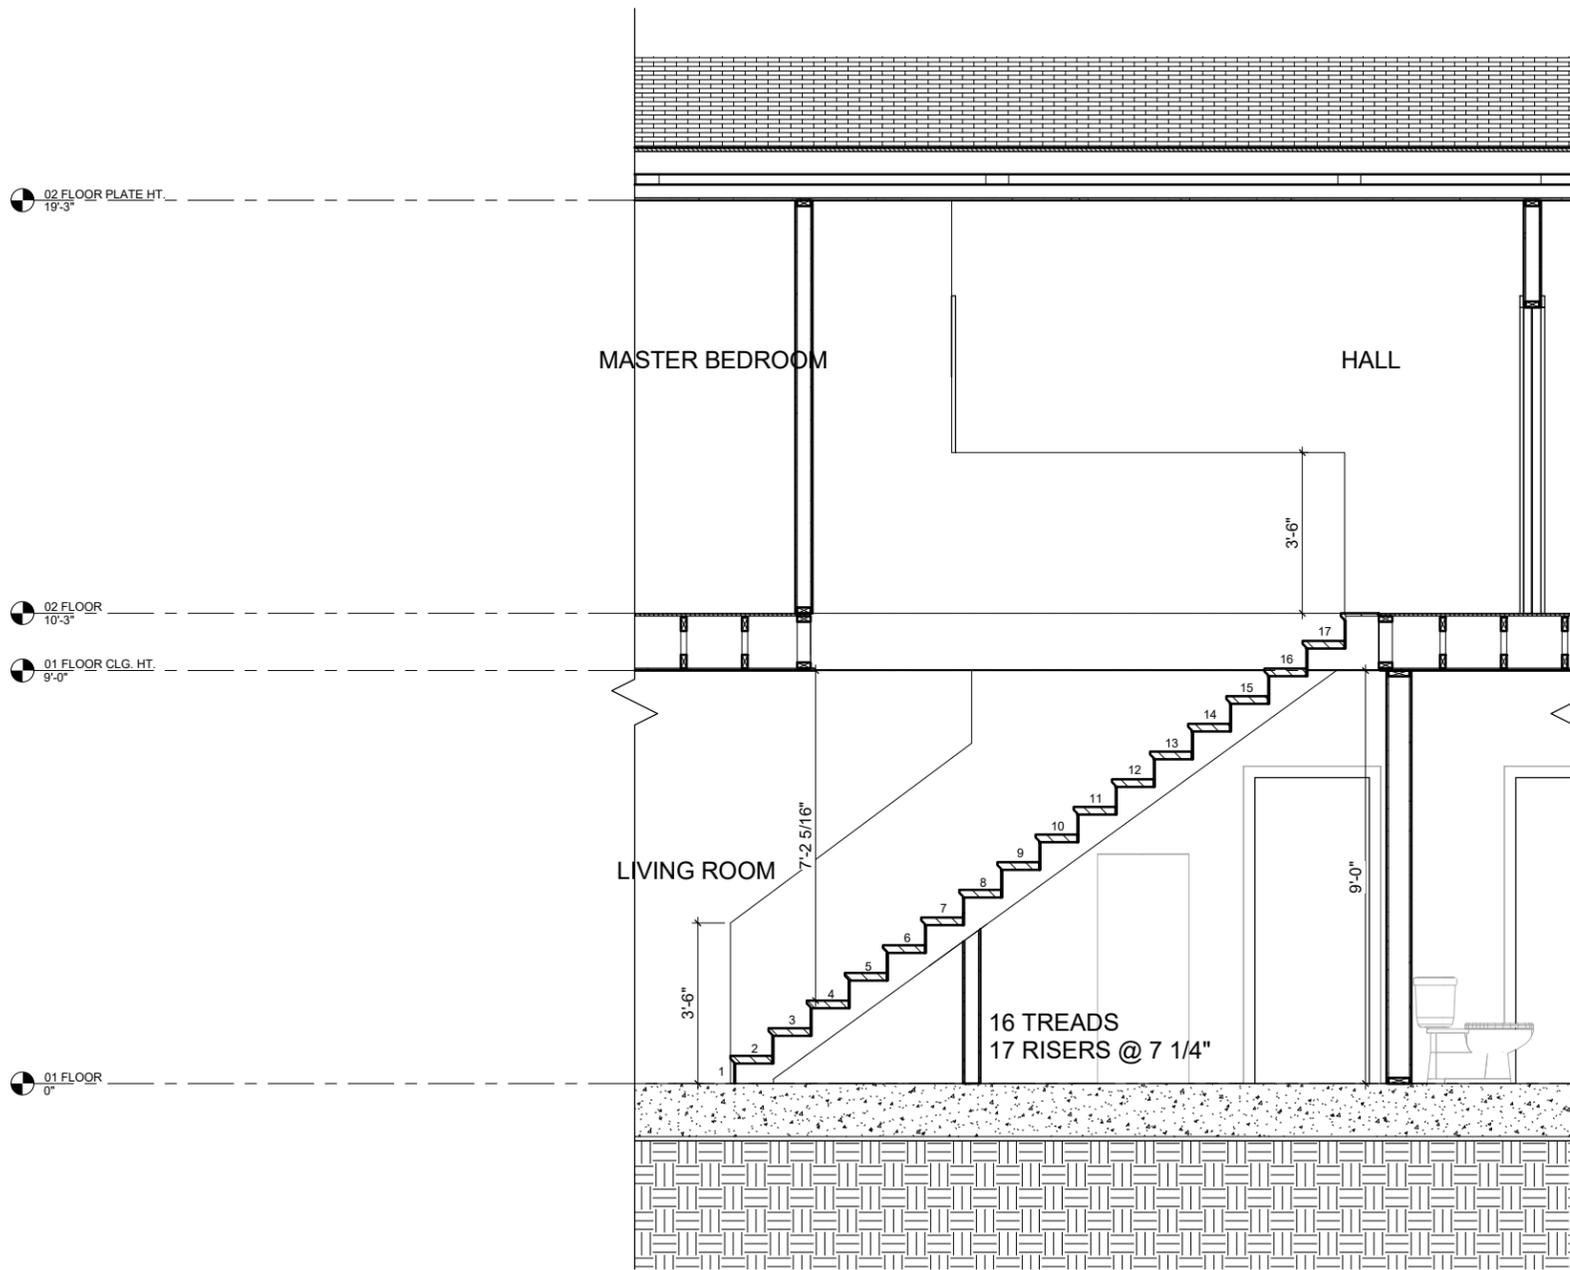

2 PR. 4.2B - STAIRS SECTION
1/4" = 1'-0"

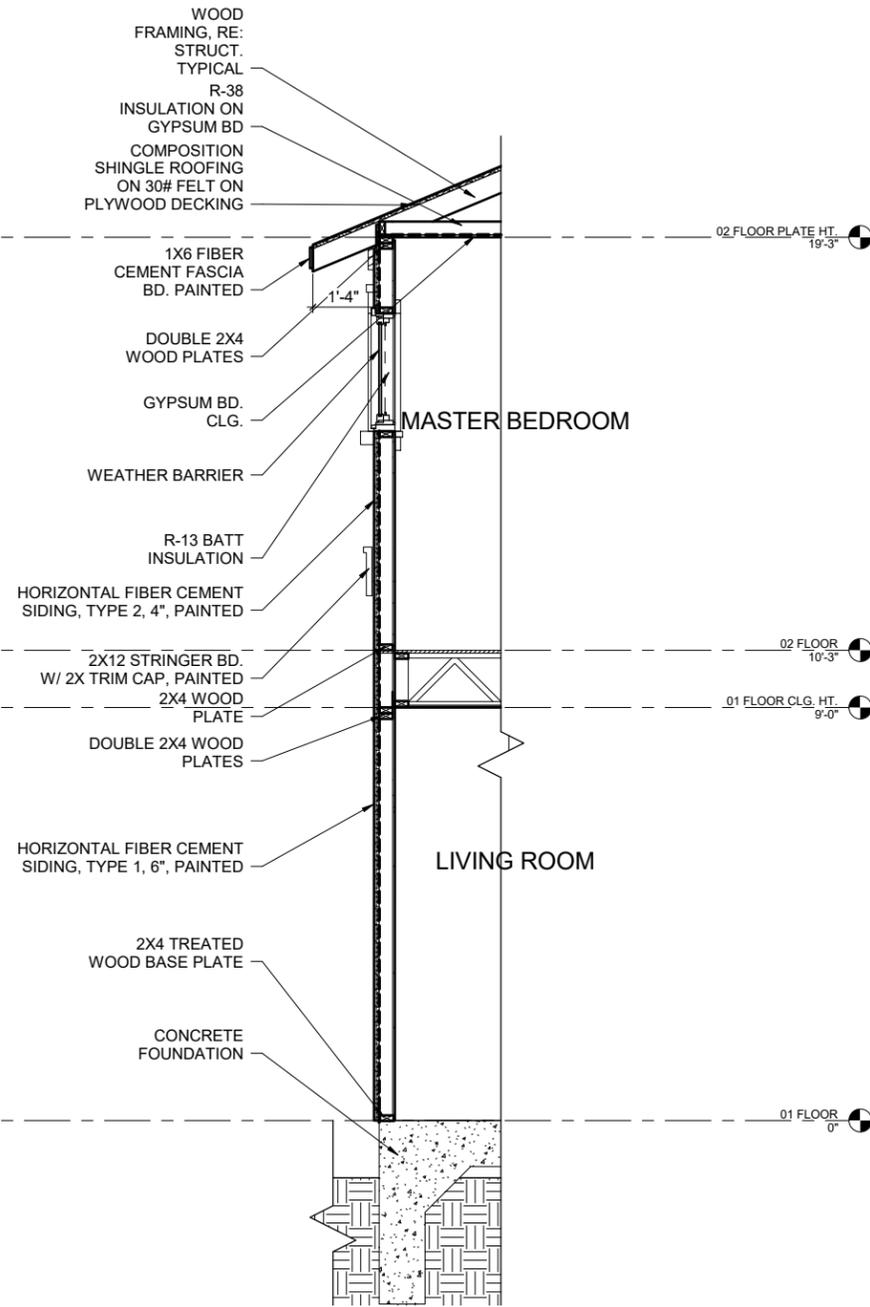

1 PR. 4.2B - WALL SECTION, TYP.
1/4" = 1'-0"

Urban at Olive

600 Block Burleson San Antonio, TX

No.	Date	Description
1	02/06/2017	Construction Set



STAIR PLANS,
SECTIONS & DETAILS

PROTOTYPE 4.2B




William Cuperton
February 6, 2017

Project number
Date February 6, 2017
Drawn by
Checked by

4.2B-A4.02

Scale

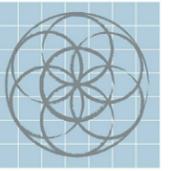

SEVENTH GENERATION DESIGN

ARCHITECTURE | SUSTAINABILITY | PRESERVATION
118 Broadway, Suite 519
San Antonio, Texas 78205
TEL (210) 262-6161 TEL (210) 241-7490

Urban at Olive

600 Block Burleson San Antonio, TX

No.	Date	Description
1	02/06/2017	Construction Set



INTERIOR ELEVATIONS & DETAILS
PROTOTYPE 4.2A OR 4.2B




February 6, 2017

Project number
Date February 6, 2017
Drawn by
Checked by


4.2-A5.01

Scale

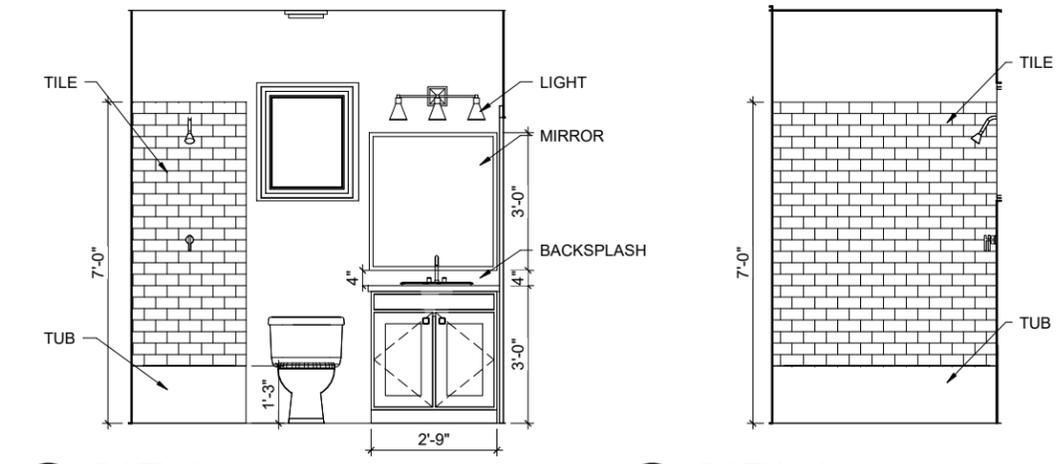


11 BATH 2 c
1/4" = 1'-0"


10 BATH 2 b
1/4" = 1'-0"

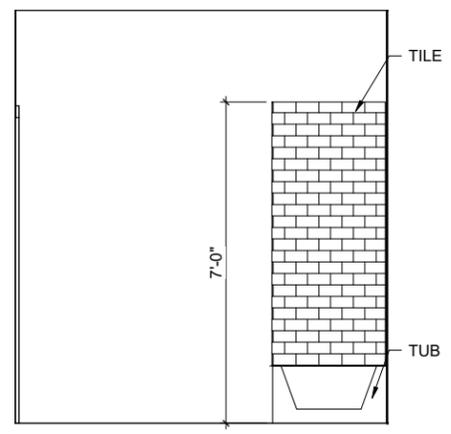

9 BATH 2 a
1/4" = 1'-0"

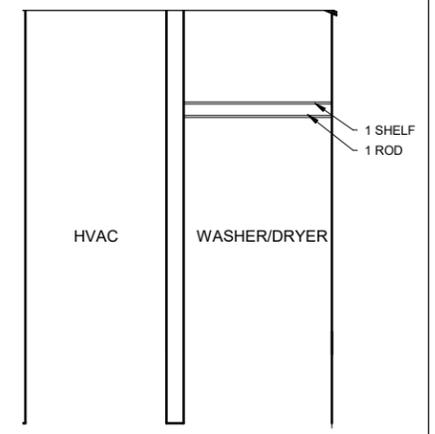


8 UTILITY
1/4" = 1'-0"

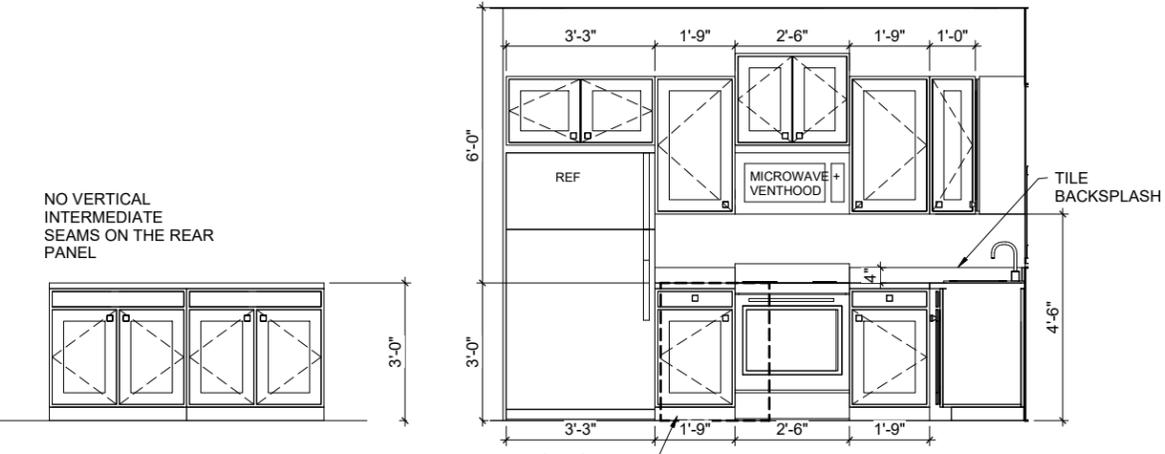


7 OPTIONAL ISLAND
1/4" = 1'-0"


6 KITCHEN b
1/4" = 1'-0"

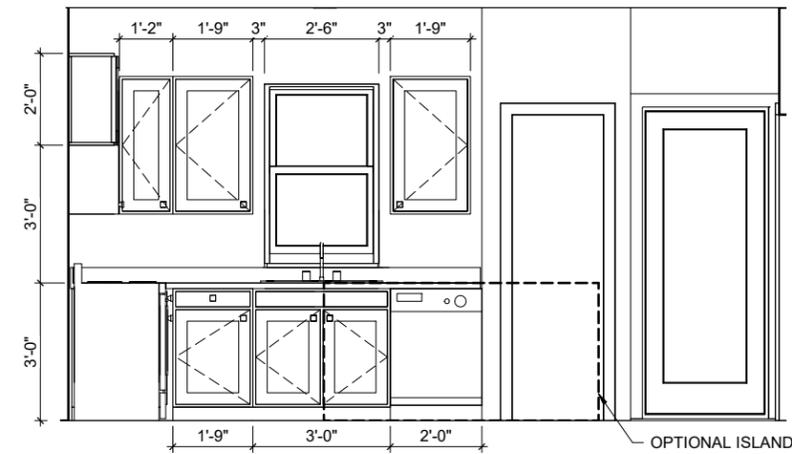


5 KITCHEN a
1/4" = 1'-0"

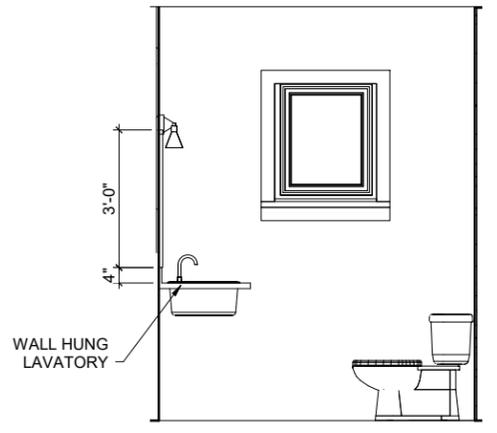


4 PWDR
1/4" = 1'-0"

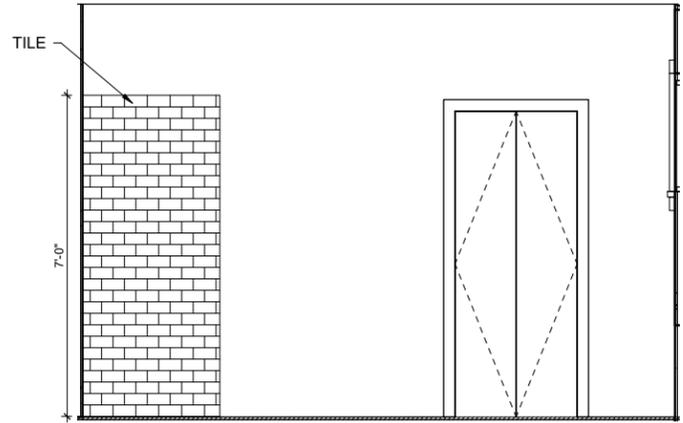


3 MSTR BATH c
1/4" = 1'-0"

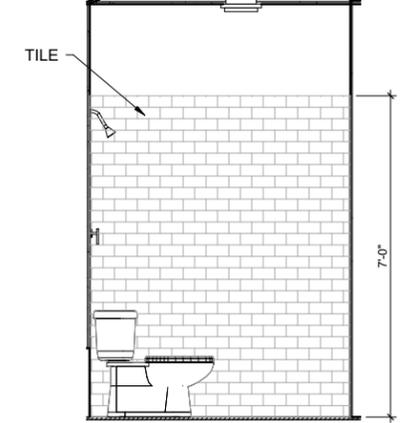

2 MSTR BATH b
1/4" = 1'-0"

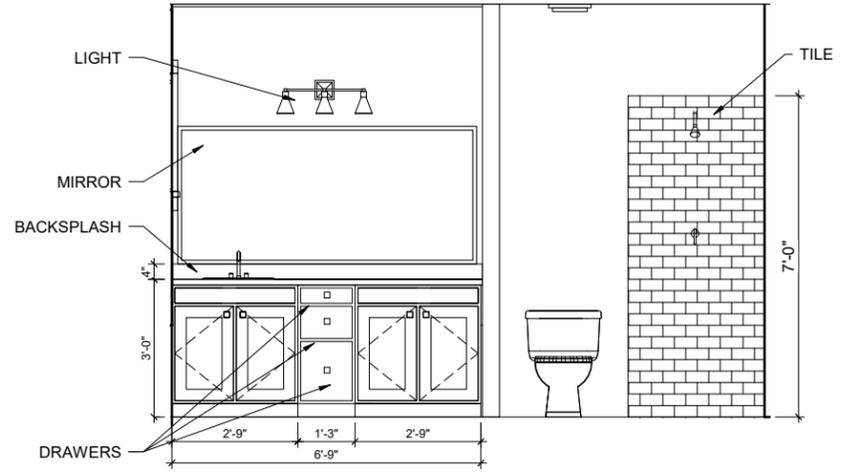

1 MSTR BATH a
1/4" = 1'-0"

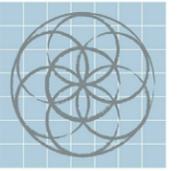

SEVENTH
GENERATION
DESIGN

ARCHITECTURE | SUSTAINABILITY | PRESERVATION

118 Broadway, Suite 519
San Antonio, Texas 78205
TEL (210) 262-6161 TEL (210) 241-7490

Urban at Olive

600 Block Burleson San
Antonio, TX

No.	Date	Description
1	02/06/2017	Construction Set



OPTIONAL GARAGE

**PROTOTYPE 4.2A,
4.2B, 4.2C, 4.2D**




February 6, 2017


Project number
Date February 6, 2017
Drawn by
Checked by

4.2-A5.02


Scale

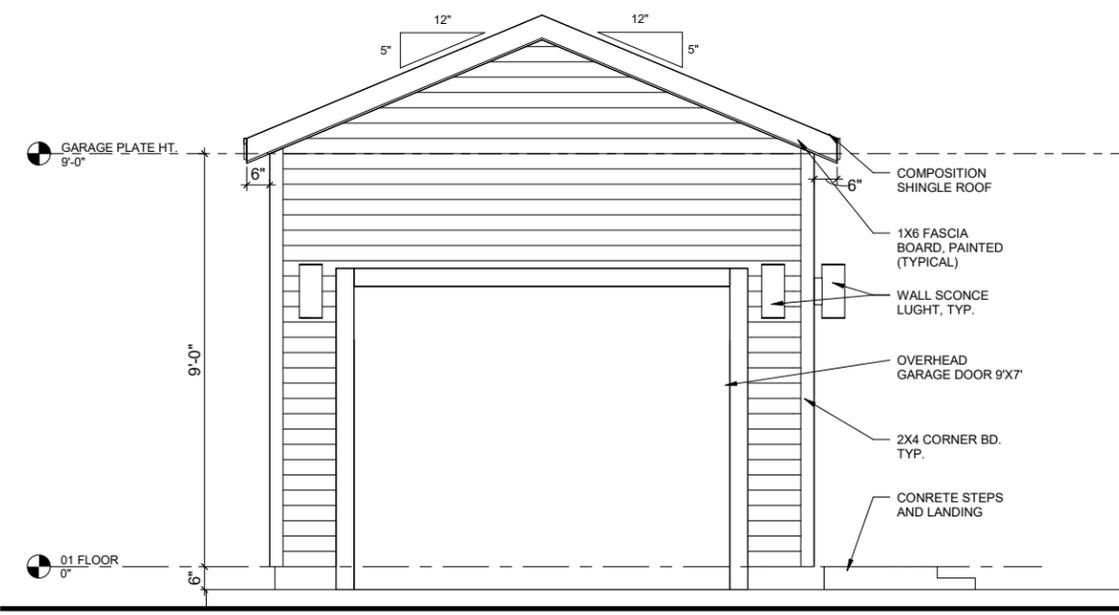

3 FRONT ELEVATION PROTOTYPE 4.2A, 4.2B, 4.2C, 4.2D
1/4" = 1'-0"

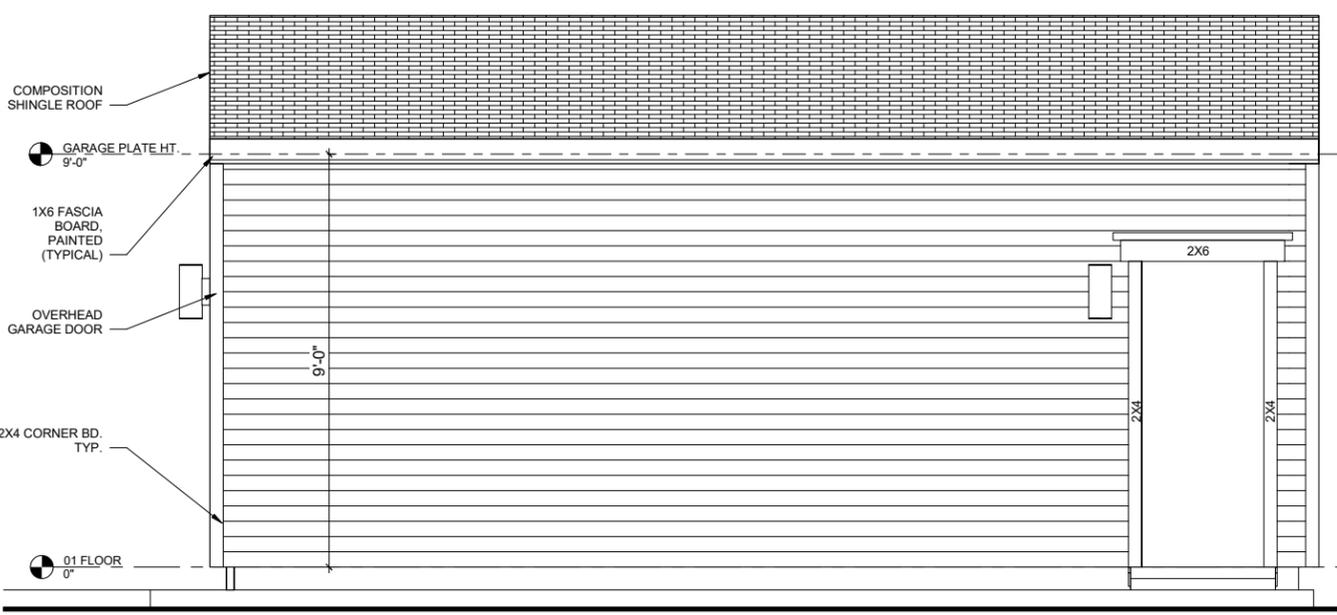


2 SIDE ELEVATION PROTOTYPE 4.2A, 4.2B, 4.2C, 4.2D
1/4" = 1'-0"

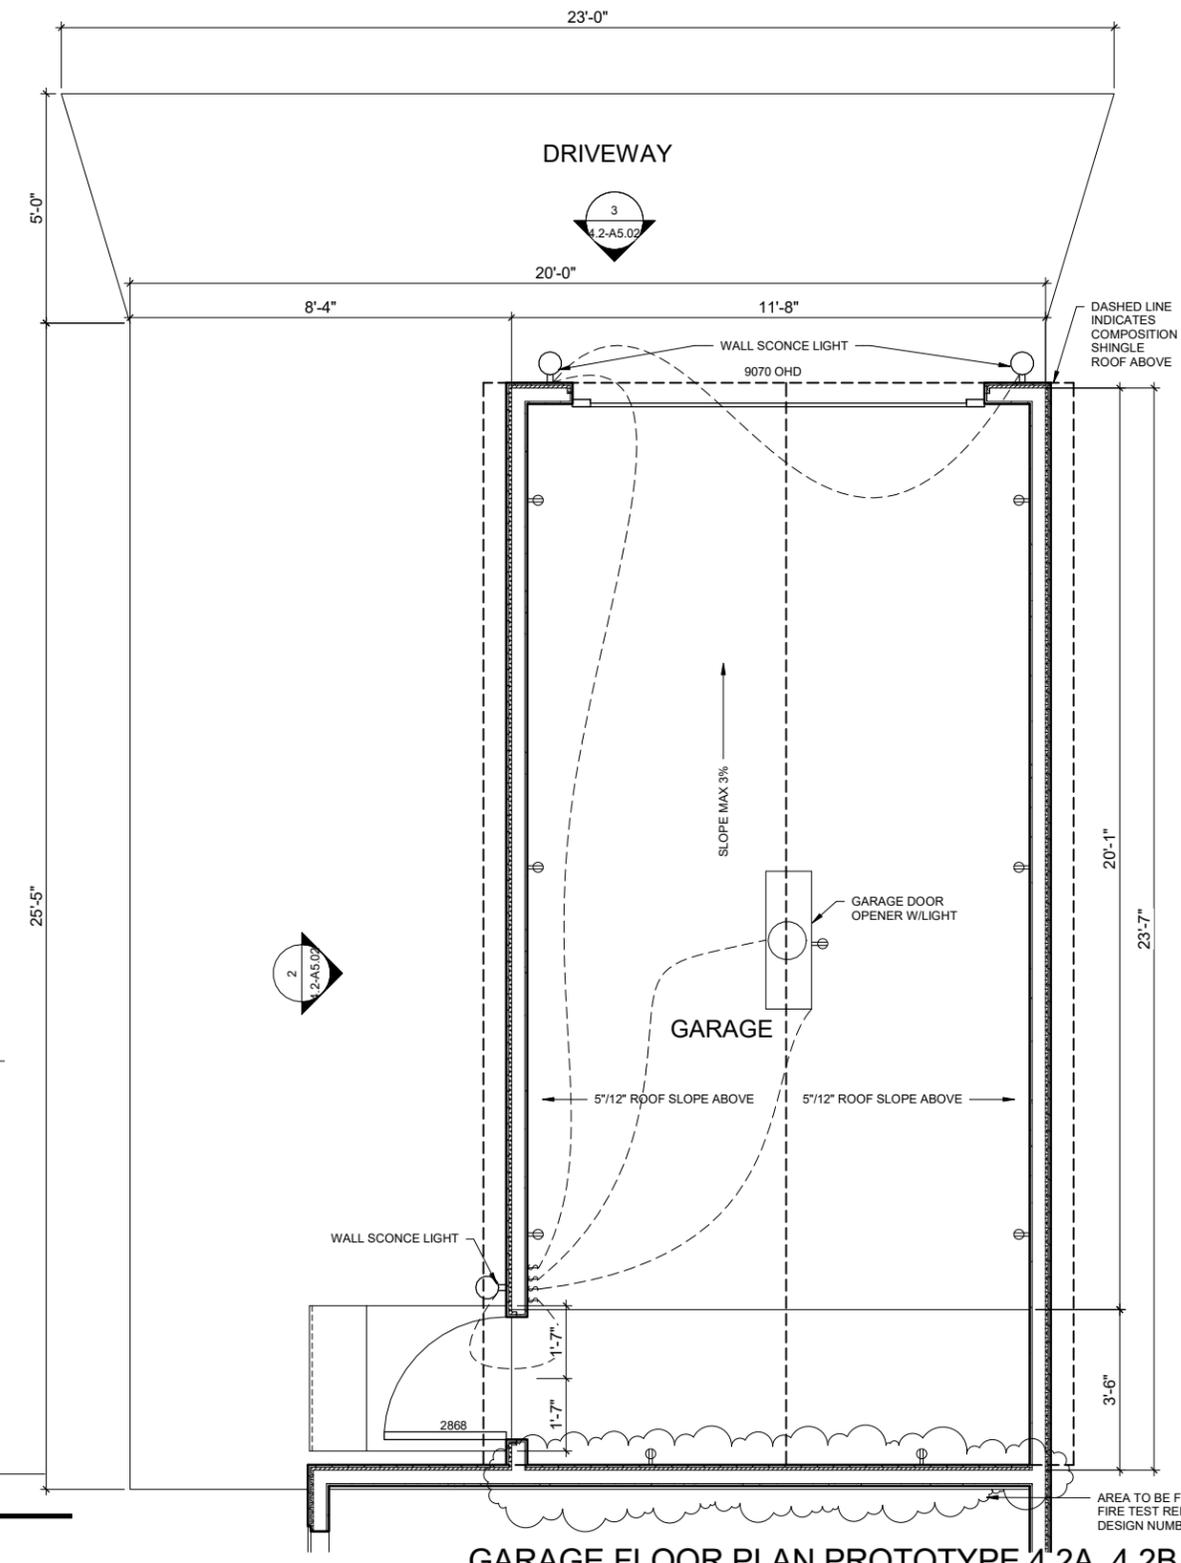

1 GARAGE FLOOR PLAN PROTOTYPE 4.2A, 4.2B, 4.2C, 4.2D
1/4" = 1'-0"

2/13/2017 4:15:02 PM

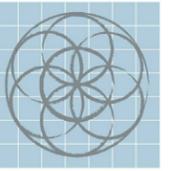

SEVENTH
GENERATION
DESIGN

ARCHITECTURE | SUSTAINABILITY | PRESERVATION

118 Broadway, Suite 519
San Antonio, Texas 78205
TEL (210) 262-6161 TEL (210) 241-7490

Urban at Olive

600 Block Burleson San
Antonio, TX

No.	Date	Description
1	02/06/2017	Construction Set



OPTIONAL CARPORT

PROTOTYPE 4.2A
OR 4.2B



February 6, 2017


Project number
Date February 6, 2017
Drawn by
Checked by

4.2-A5.03


Scale

GENERAL NOTES:


1. USE JOIST HANGERS AT EVERY 2X6 AND 2X8 FRAMING JOISTS.

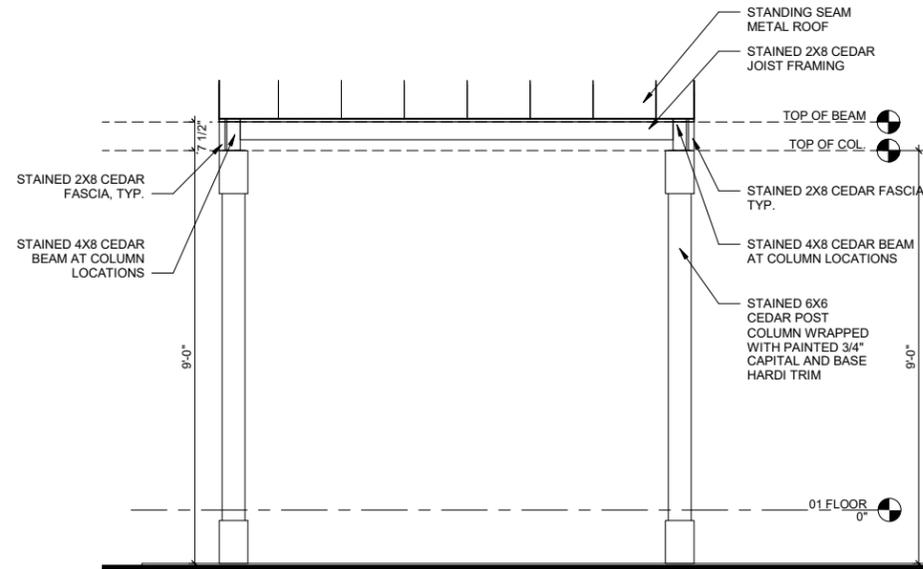

3 FRONT ELEVATION PROTOTYPE 4.2A OR 4.2B
1/4" = 1'-0"

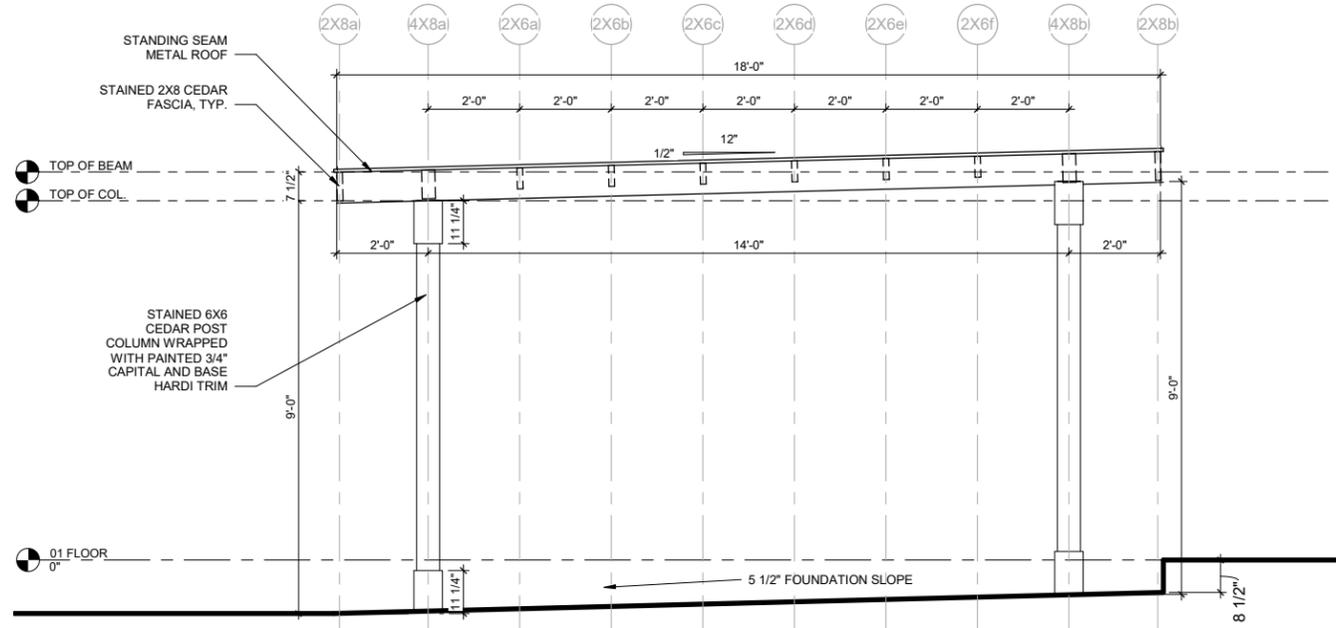

2 SIDE ELEVATION PROTOTYPE 4.2A OR 4.2B
1/4" = 1'-0"

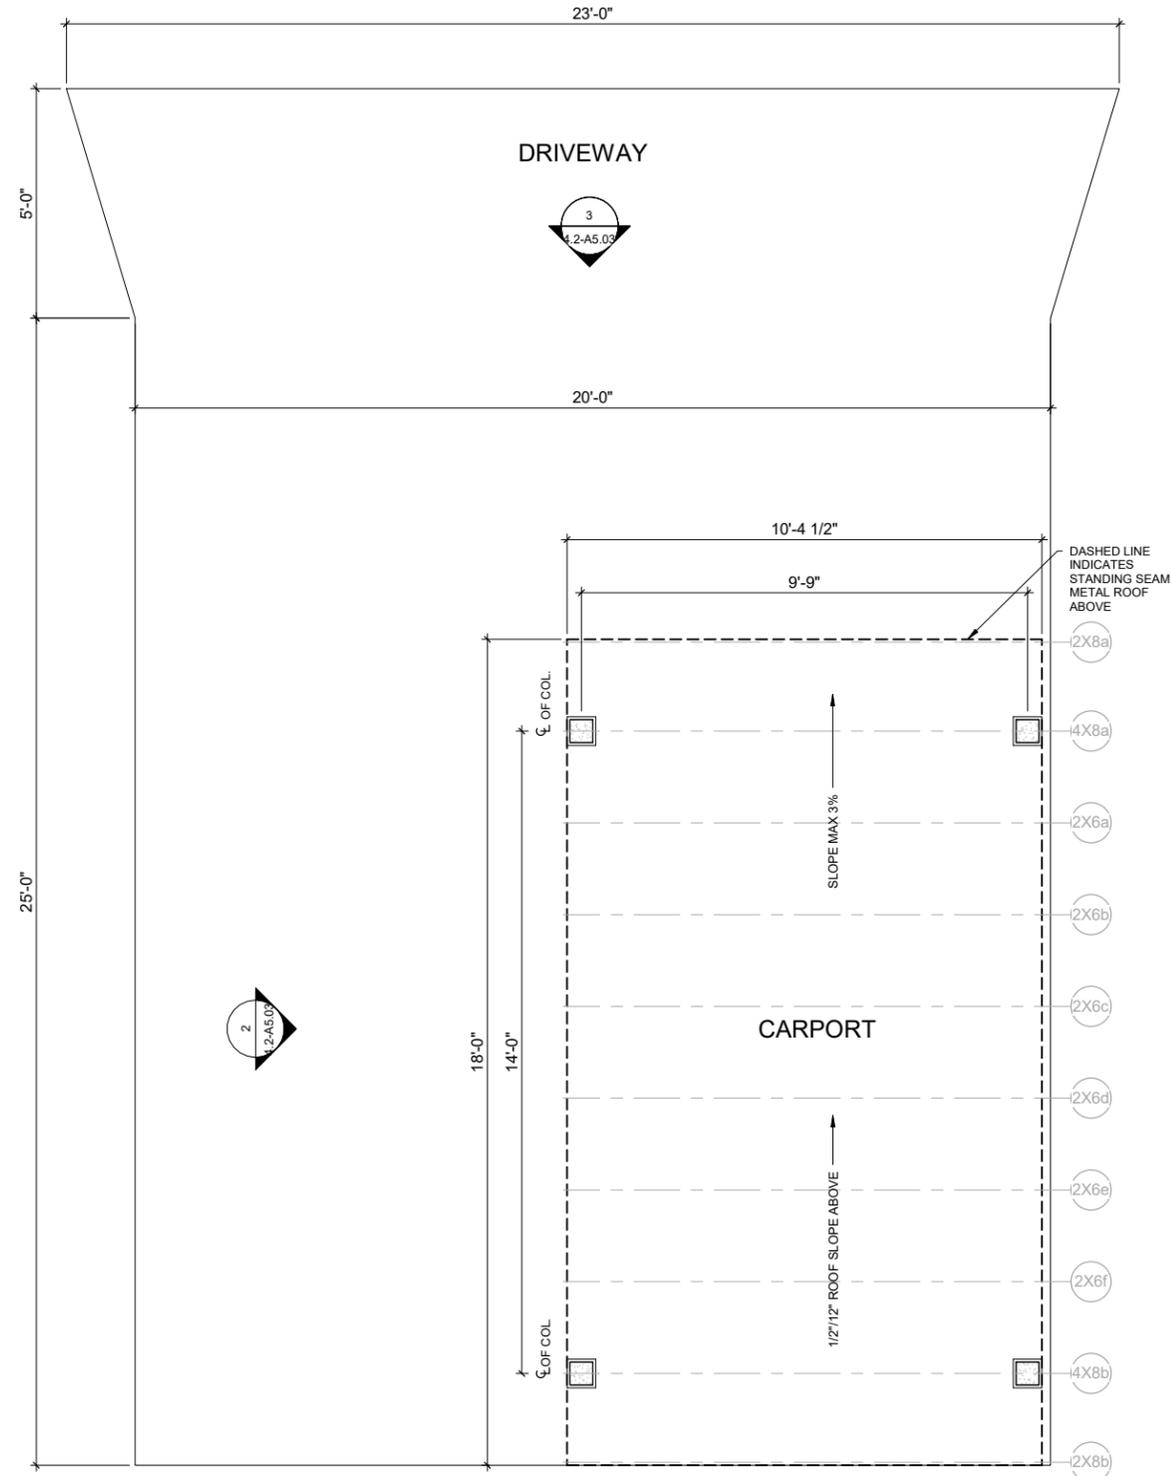

1 CARPORT FLOOR PLAN PROTOTYPE 4.2A OR 4.2B
1/4" = 1'-0"


Urban at Olive - PROTOTYPE 4.2A

TERRAMARK Urban Homes

CONSTRUCTION SET

600 Block Burleson San Antonio, TX

February 6, 2017

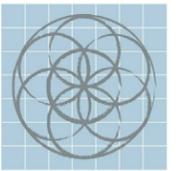

SEVENTH
GENERATION
DESIGN

ARCHITECTURE | SUSTAINABILITY | PRESERVATION

118 Broadway, Suite 519
San Antonio, Texas 78205
TEL (210) 262-6161 TEL (210) 241-7490



SKETCH IS CONCEPTUAL ONLY NOT FOR CONSTRUCTION

NUMBER	SHEET INDEX - PROTOTYPE 4.2A	NAME
4.2A-A0.00	COVER SHEET	
4.2A-A2.03	01 FLOOR PLAN	
4.2A-A2.04	02 FLOOR PLAN	
4.2A-A2.05	ROOF PLAN	
4.2A-A2.06	01 REFLECTED CEILING PLAN	
4.2A-A2.07	02 REFLECTED CEILING PLAN	
4.2A-A3.01	FRONT ELEVATION	
4.2A-A3.02	BACK ELEVATION	
4.2A-A3.03	SIDE ELEVATION	
4.2A-A3.04	SIDE ELEVATION	
4.2A-A4.01	EXTERIOR SECTIONS & DETAIL	
4.2A-A4.02	STAIR PLANS SECTIONS & DETAILS	
4.2-A5.01	INTERIOR ELEVATIONS & DETAILS	
4.2-A5.02	OPTIONAL GARAGE	
4.2-A5.03	OPTIONAL CARPORT	

Urban at Olive

600 Block Burleson San
Antonio, TX


No.	Date	Description
1	02/06/2017	Construction Set

TERRAMARK
URBAN HOMES



William Carpenter

February 6, 2017

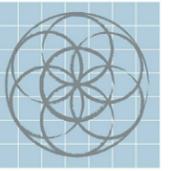

SEVENTH
GENERATION
DESIGN

ARCHITECTURE | SUSTAINABILITY | PRESERVATION
118 Broadway, Suite 519
San Antonio, Texas 78205
TEL (210) 262-6161 TEL (210) 241-7490

Urban at Olive

600 Block Burleson San
Antonio, TX

No.	Date	Description
1	02/06/2017	Construction Set



01 FLOOR PLAN

PROTOTYPE 4.2A




Scott William Carpenter
February 6, 2017

Project number
Date February 6, 2017
Drawn by
Checked by


4.2A-A2.03

Scale

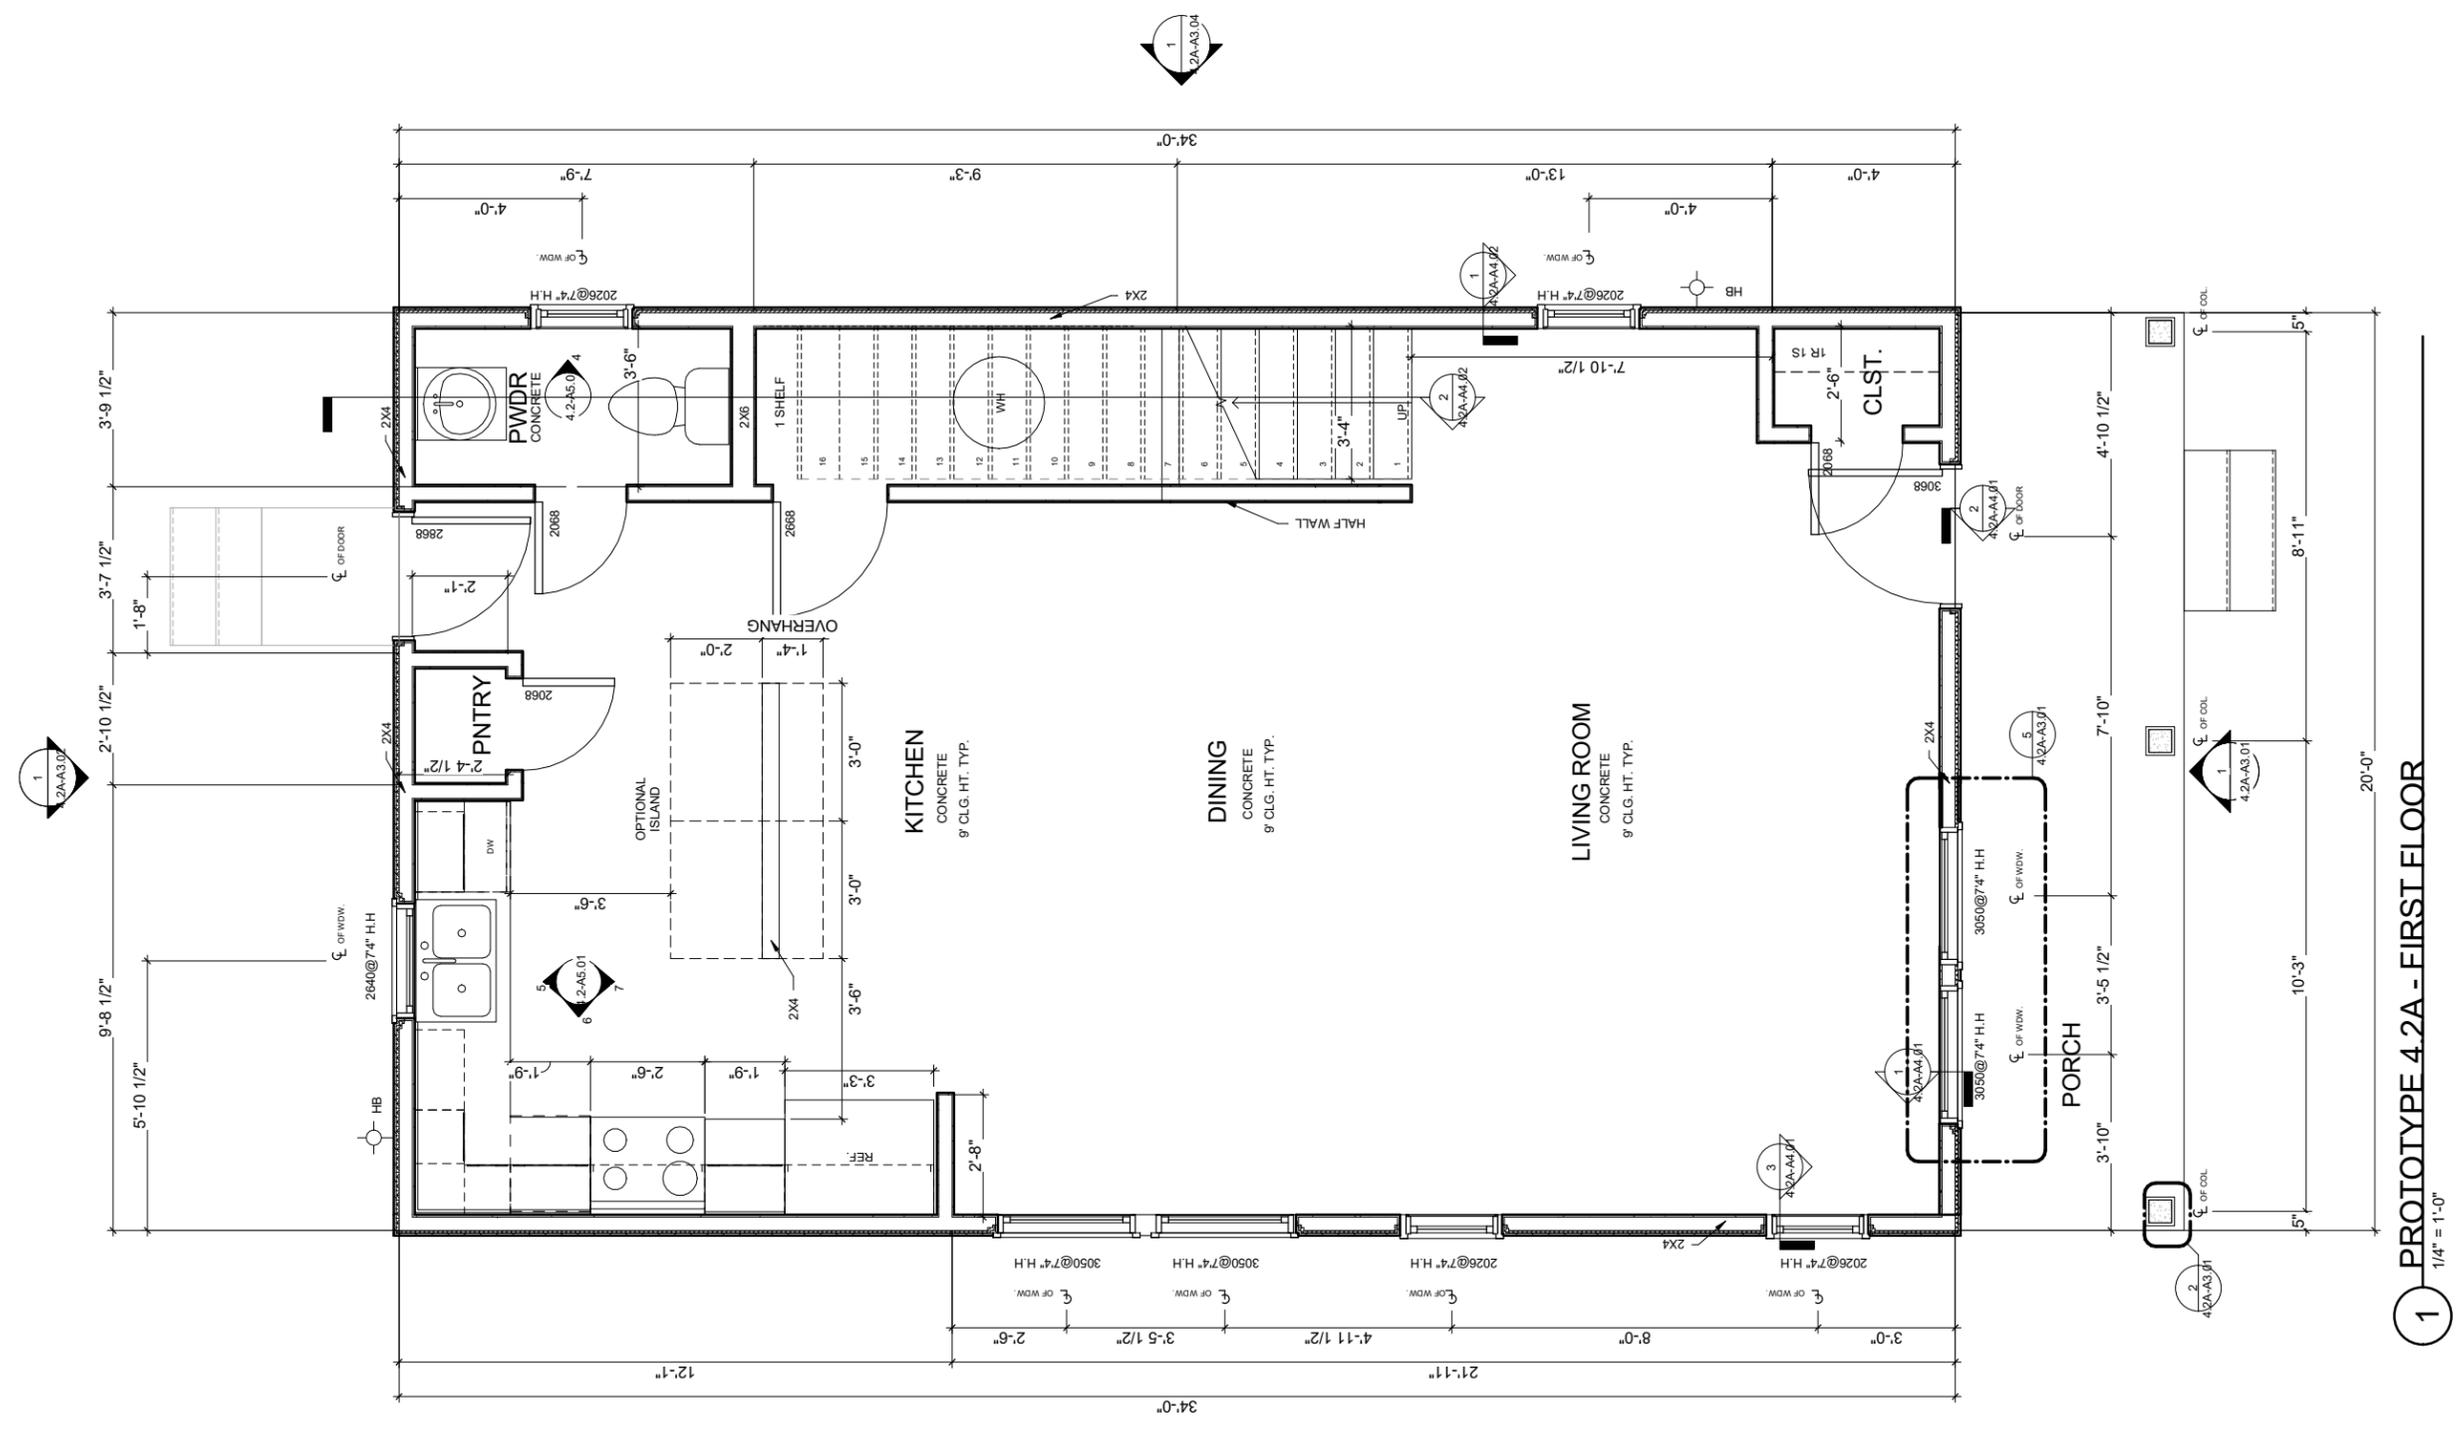

1 PROTOTYPE 4.2A - FIRST FLOOR
1/4" = 1'-0"

OVERALL LIVING + ROOF AREAS	
NAME	AREA
1ST FLOOR LIVING	680 S.F.
2ND FLOOR LIVING	632 S.F.
TOTAL LIVING	1312 S.F.
FRONT PORCH	100 S.F.
TOTAL STRUCTURE	1,412 S.F.
COMP. ROOF AREA	915 S.F.
METAL ROOF AREA	137 S.F.

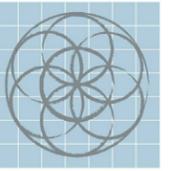

SEVENTH
GENERATION
DESIGN

ARCHITECTURE | SUSTAINABILITY | PRESERVATION

118 Broadway, Suite 519
San Antonio, Texas 78205
TEL (210) 262-6161 TEL (210) 241-7490

Urban at Olive

600 Block Burleson San
Antonio, TX

No.	Date	Description
1	02/06/2017	Construction Set



02 FLOOR PLAN

PROTOTYPE 4.2A




Scott William Carpenter
February 6, 2017


Project number
Date February 6, 2017
Drawn by
Checked by

4.2A-A2.04


Scale

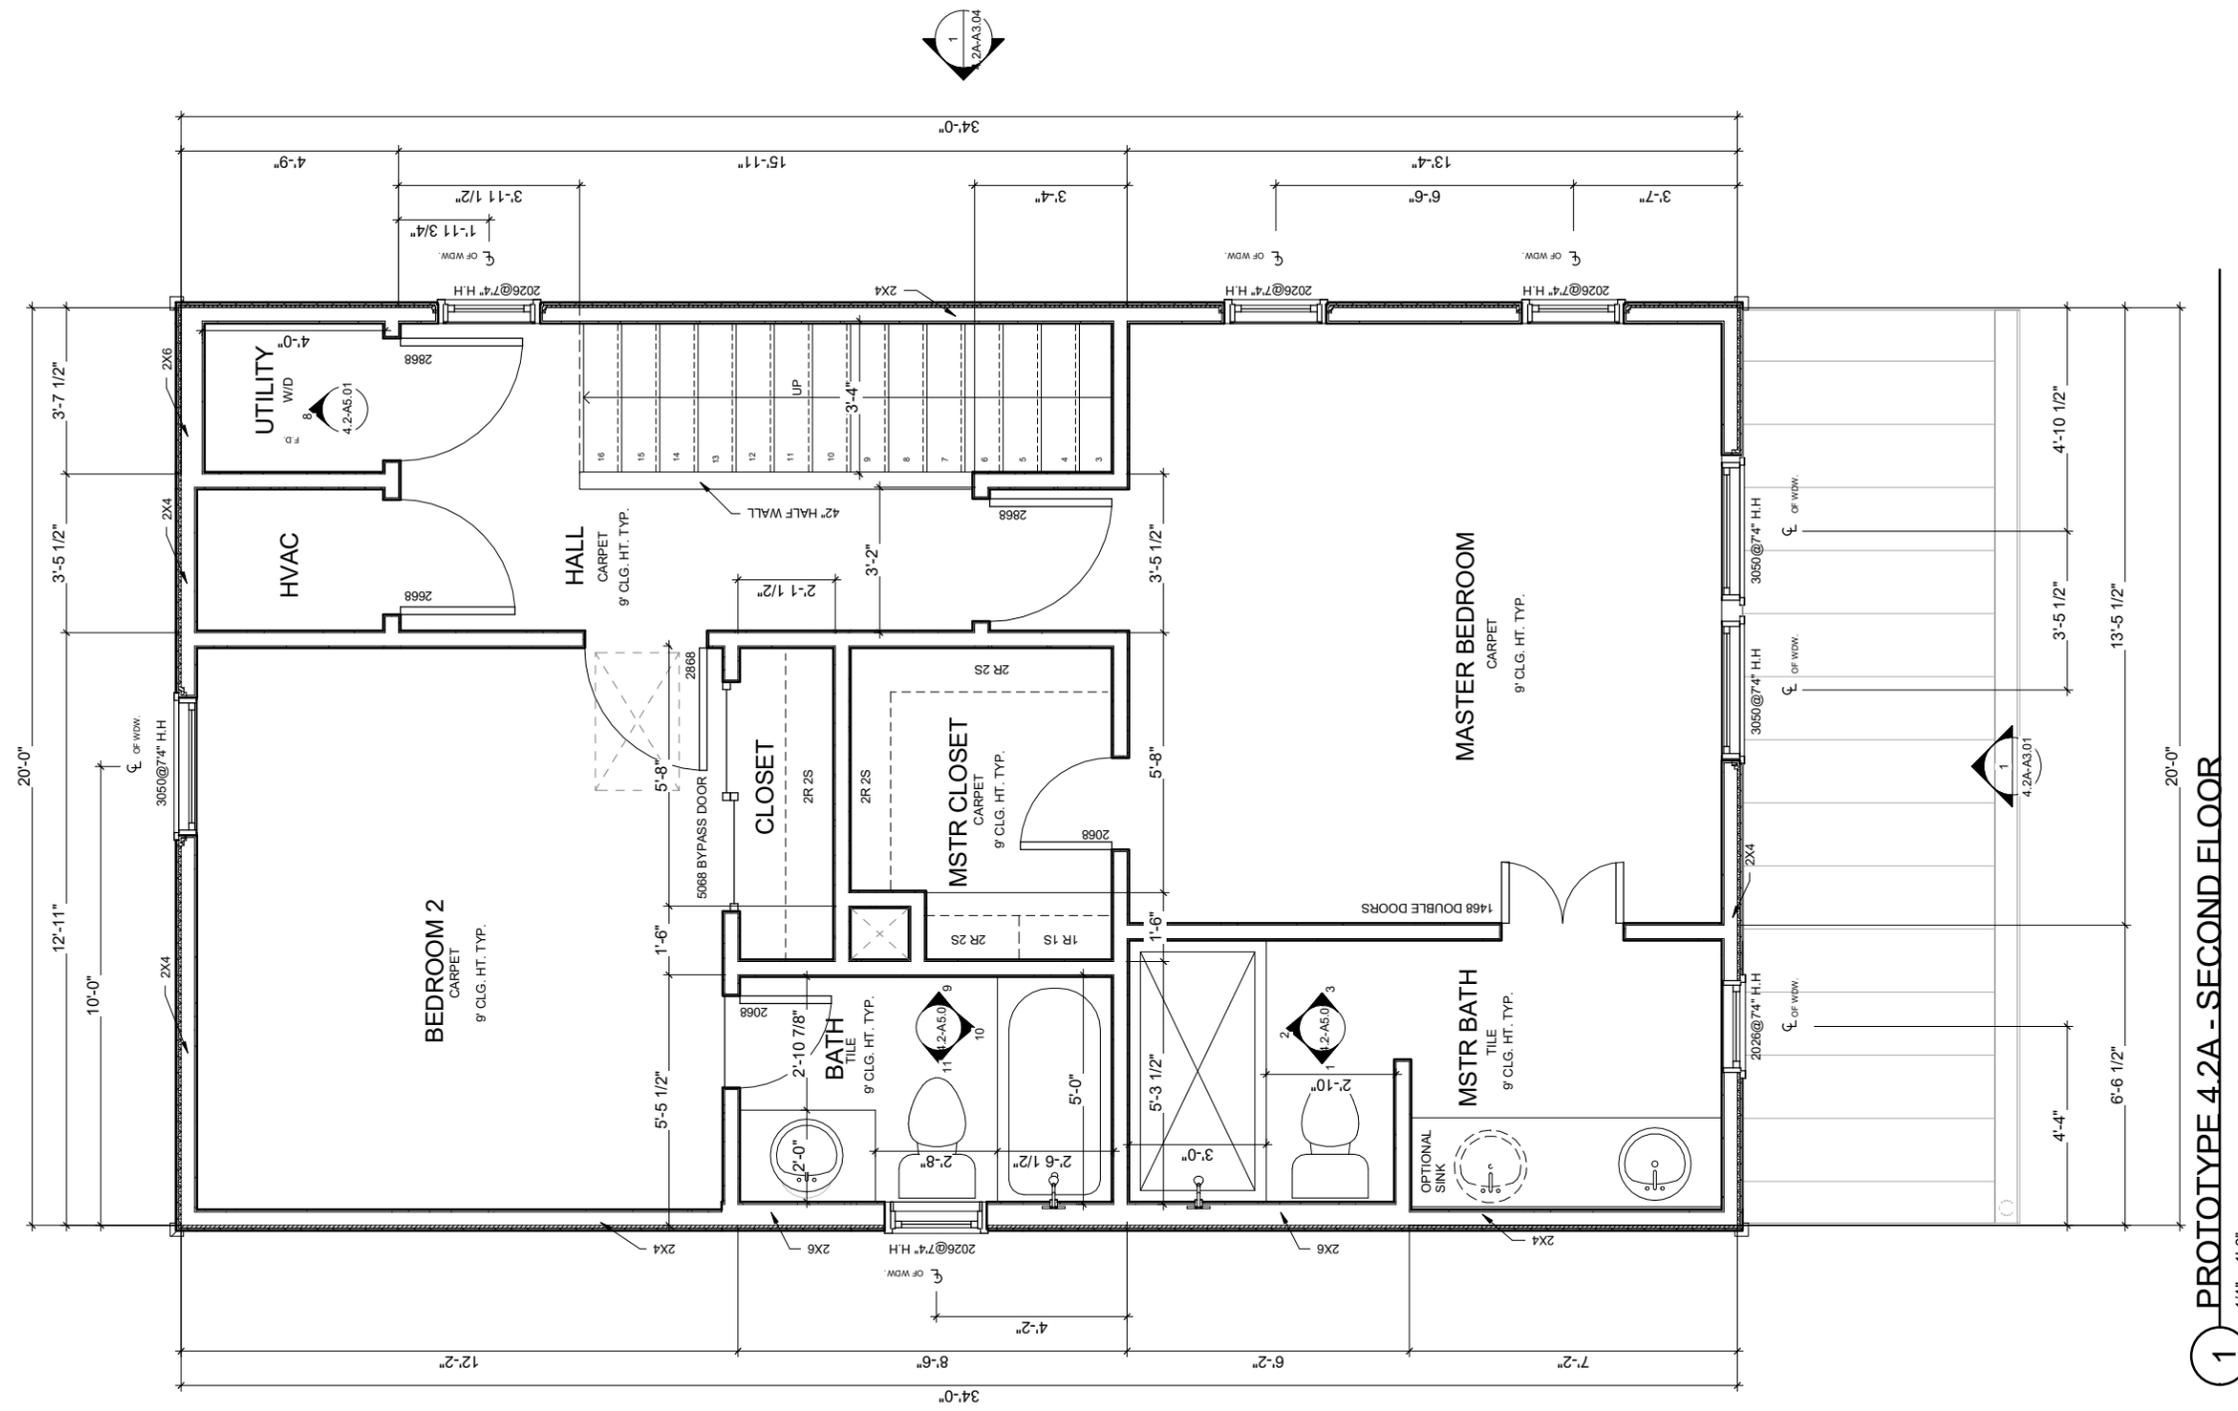

OVERALL LIVING + ROOF AREAS	
NAME	AREA
1ST FLOOR LIVING	680 S.F.
2ND FLOOR LIVING	632 S.F.
TOTAL LIVING	1312 S.F.
FRONT PORCH	100 S.F.
TOTAL STRUCTURE	1,412 S.F.
COMP. ROOF AREA	915 S.F.
METAL ROOF AREA	137 S.F.

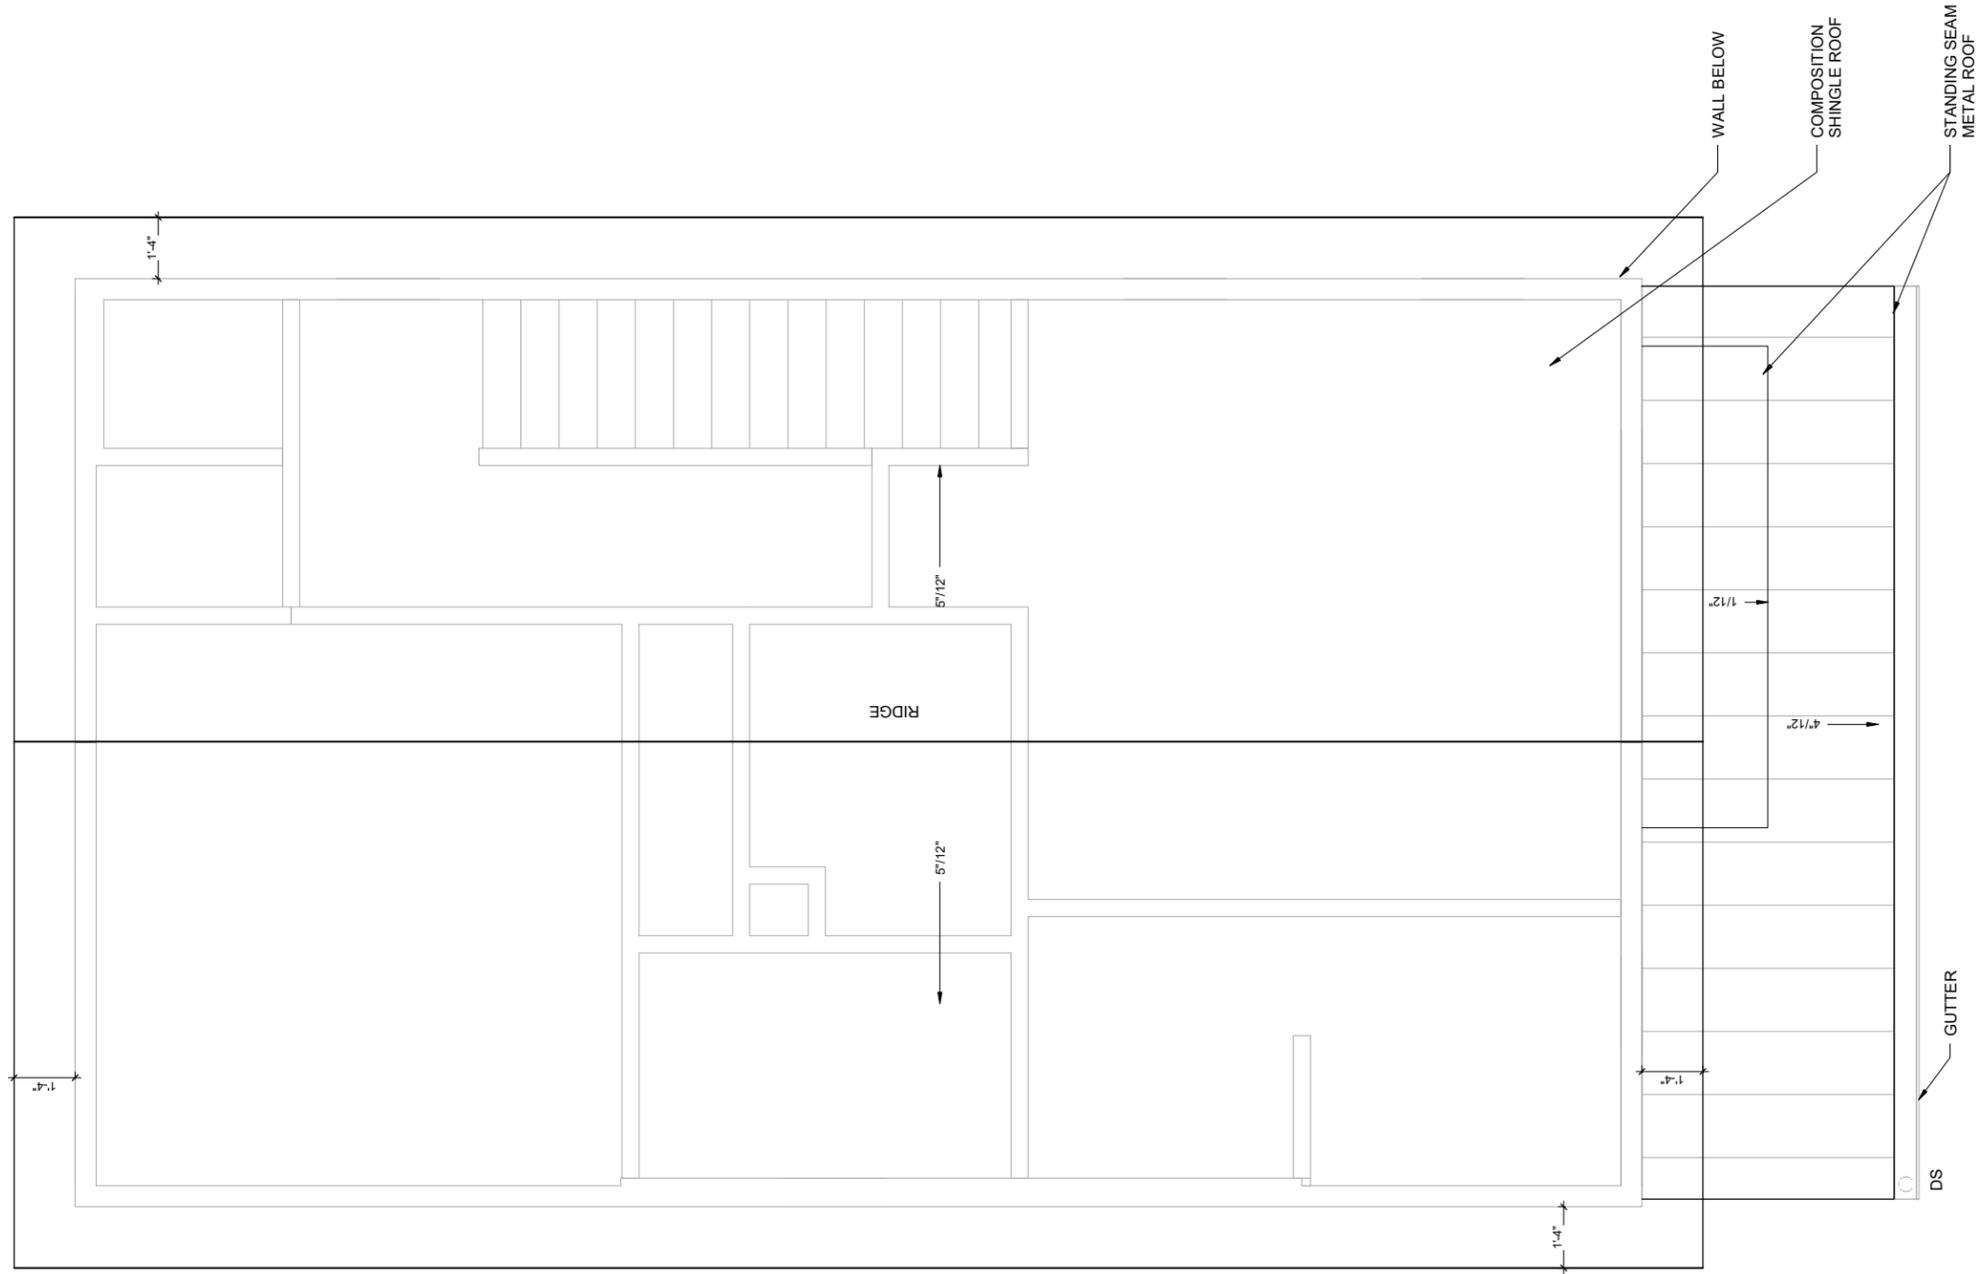

1 PROTOIYPE 4.2A - ROOF PLAN
1/4" = 1'-0"

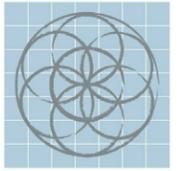

SEVENTH
GENERATION
DESIGN

ARCHITECTURE | SUSTAINABILITY | PRESERVATION
118 Broadway, Suite 519
San Antonio, Texas 78205
TEL (210) 262-6161 TEL (210) 241-7490

Urban at Olive

600 Block Burleson San
Antonio, TX

No.	Date	Description
1	02/06/2017	Construction Set



ROOF PLAN

PROTOTYPE 4.2A




Scott William Cuperton
February 6, 2017

Project number
Date February 6, 2017
Drawn by
Checked by

4.2A-A2.05

Scale

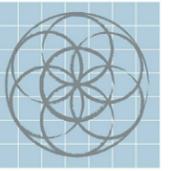

SEVENTH GENERATION DESIGN

ARCHITECTURE | SUSTAINABILITY | PRESERVATION

118 Broadway, Suite 519
San Antonio, Texas 78205
TEL (210) 262-6161 TEL (210) 241-7490

Urban at Olive

600 Block Burleson San Antonio, TX

No.	Date	Description
1	02/06/2017	Construction Set



01 FLOOR REFLECTED CEILING PLAN

PROTOTYPE 4.2A




February 6, 2017

Project number
Date February 6, 2017
Drawn by
Checked by

4.2A-A2.06

Scale

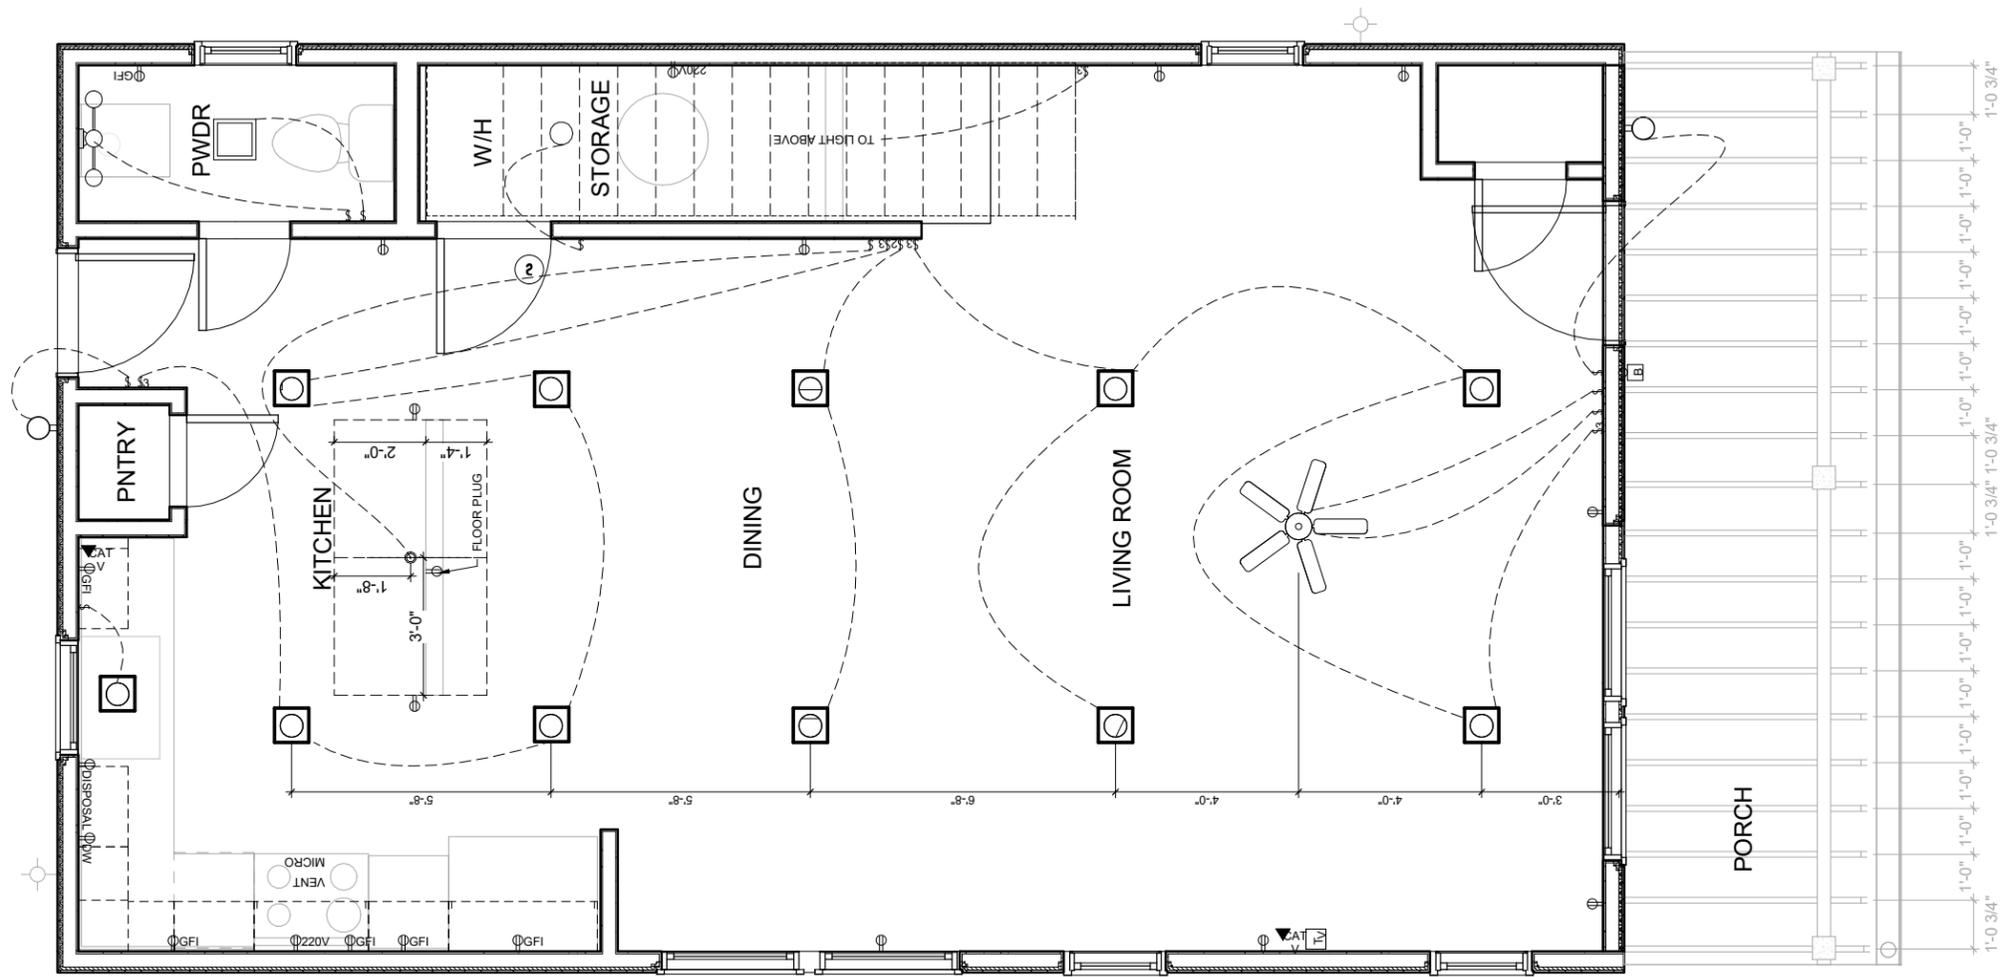


1 PROTOTYPE 4.2A - 01 REFLECTED CEILING PLAN
1/4" = 1'-0"

ELECTRICAL & CEILING PLAN LEGEND

- | | | | | | |
|--|----------------------------|--|---------------------------------------|--|----------------------------------|
| | RECESSED LIGHT | | 110 VOLT DUPLEX OUTLET | | THERMOSTAT |
| | WATERPROOF RECESSED LIGHT | | 220 VOLT DUPLEX OUTLET | | DOORBELL |
| | PENDANT LIGHT | | GROUND FAULT/WATERPROOF DUPLEX OUTLET | | ELECTRICAL PANEL |
| | SURFACE MOUNTED LIGHT | | DISHWASHER SWITCH | | SMOKE & CARBON MONOXIDE DETECTOR |
| | WALL MOUNTED LIGHT | | GARBAGE DISPOSAL SWITCH | | TELEPHONE WALL OUTLET |
| | WALL MOUNTED VANITY LIGHT | | ONE-WAY SWITCH | | TELEVISION CABLE OUTLET |
| | EXHAUST FAN | | TWO-WAY SWITCH | | SCUTTLE ACCESS |
| | EXHAUST FAN W/ LIGHT COMBO | | | | |
| | CEILING FAN WITH LIGHT KIT | | | | |

2/6/2017 1:38:55 PM

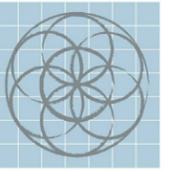

SEVENTH
GENERATION
DESIGN

ARCHITECTURE | SUSTAINABILITY | PRESERVATION

118 Broadway, Suite 519
San Antonio, Texas 78205
TEL (210) 262-6161 TEL (210) 241-7490

Urban at Olive

600 Block Burleson San
Antonio, TX

No.	Date	Description
-----	------	-------------



02 FLOOR REFLECTED
CEILING PLAN

PROTOTYPE 4.2A




Scott William Cuppen
February 6, 2017

Project number
Date February 6, 2017

Drawn by
Checked by

4.2A-A2.07

Scale

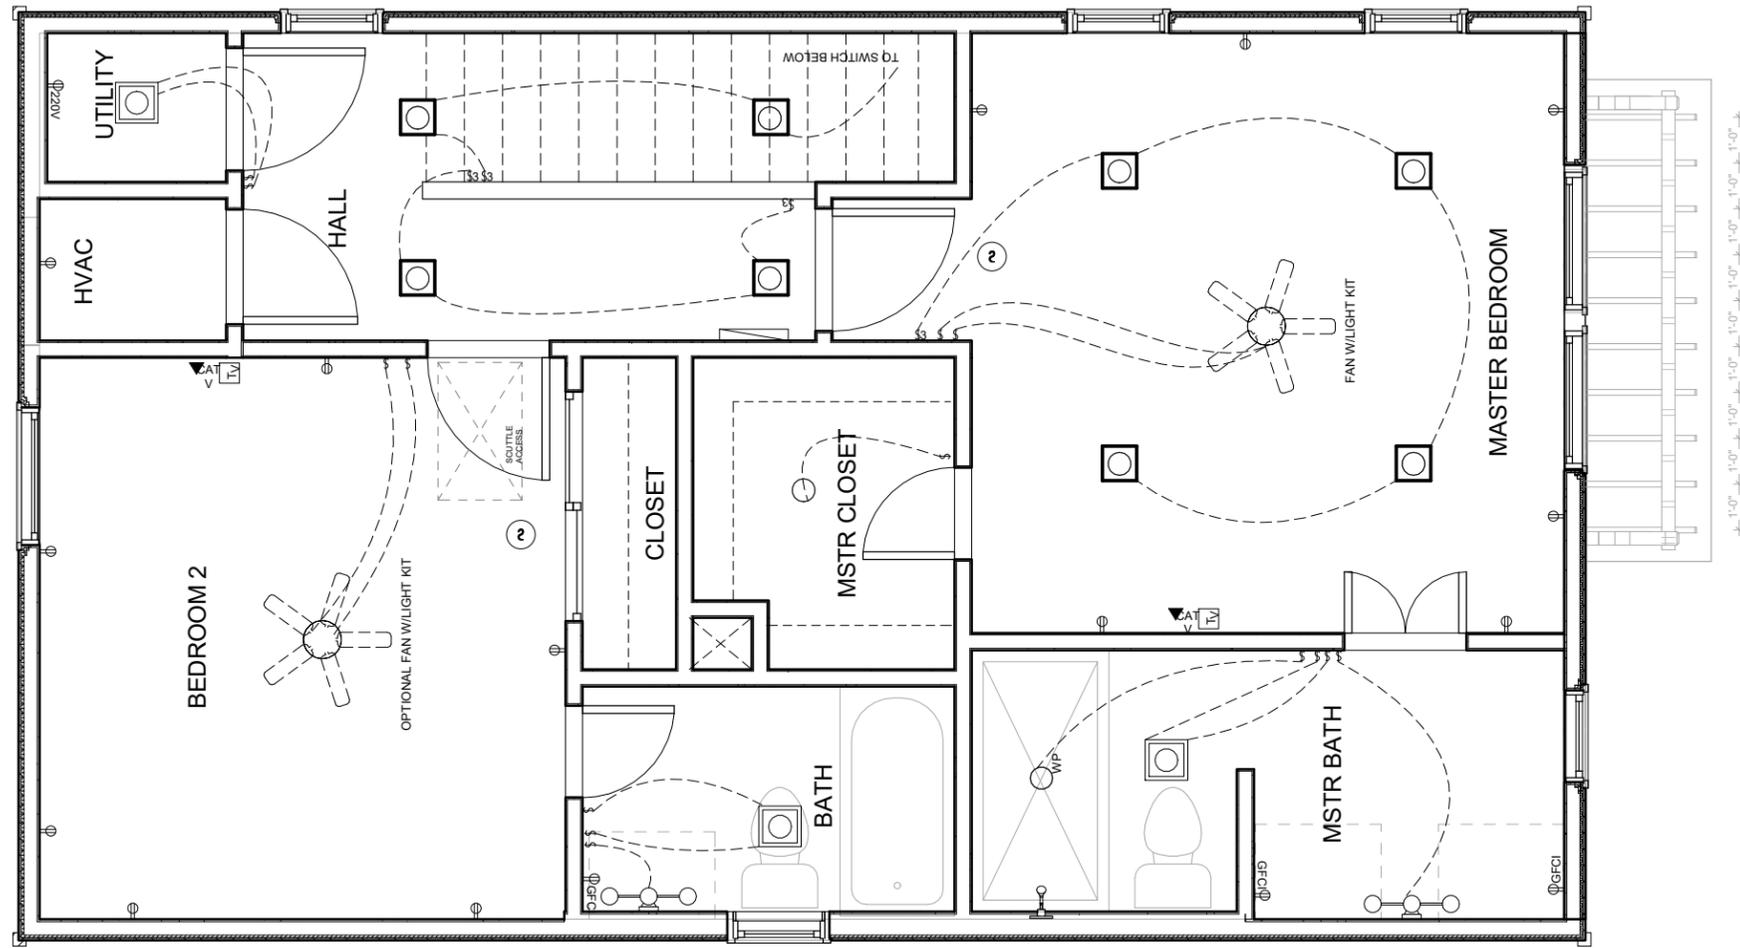


1 PROTOTYPE 4.2A - 02 REFLECTED CEILING PLAN
1/4" = 1'-0"

ELECTRICAL & CEILING PLAN LEGEND

- | | | | | | |
|--|----------------------------|--|---------------------------------------|--|----------------------------------|
| | RECESSED LIGHT | | 110 VOLT DUPLEX OUTLET | | THERMOSTAT |
| | WATERPROOF RECESSED LIGHT | | 220 VOLT DUPLEX OUTLET | | DOORBELL |
| | PENDANT LIGHT | | GROUND FAULT/WATERPROOF DUPLEX OUTLET | | ELECTRICAL PANEL |
| | SURFACE MOUNTED LIGHT | | DISHWASHER SWITCH | | SMOKE & CARBON MONOXIDE DETECTOR |
| | WALL MOUNTED LIGHT | | GARBAGE DISPOSAL SWITCH | | TELEPHONE WALL OUTLET |
| | WALL MOUNTED VANITY LIGHT | | ONE-WAY SWITCH | | TELEVISION CABLE OUTLET |
| | EXHAUST FAN | | TWO-WAY SWITCH | | SCUTTLE ACCESS |
| | EXHAUST FAN W/ LIGHT COMBO | | | | |
| | CEILING FAN WITH LIGHT KIT | | | | |

2/13/2017 4:15:03 PM

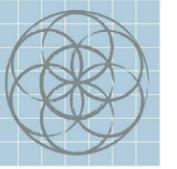

SEVENTH GENERATION DESIGN

ARCHITECTURE | SUSTAINABILITY | PRESERVATION

118 Broadway, Suite 519
San Antonio, Texas 78205
TEL (210) 262-6161 TEL (210) 241-7490

Urban at Olive

600 Block Burleson San Antonio, TX

No.	Date	Description
1	02/06/2017	Construction Set



FRONT ELEVATION

PROTOTYPE 4.2A




February 6, 2017

Project number
Date February 6, 2017


Drawn by
Checked by

4.2A-A3.01


Scale

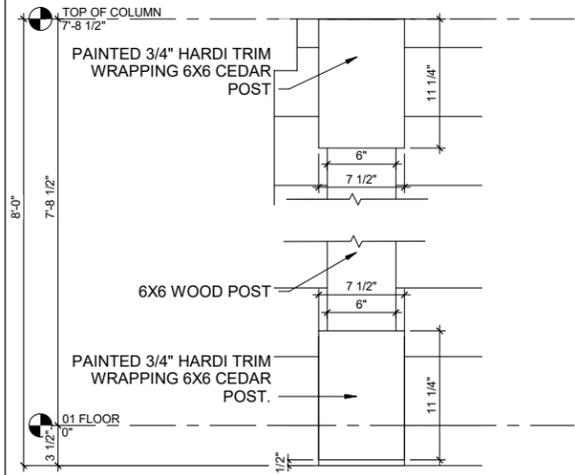


4 BUILT UP COLUMN ELEVATION
3/4" = 1'-0"

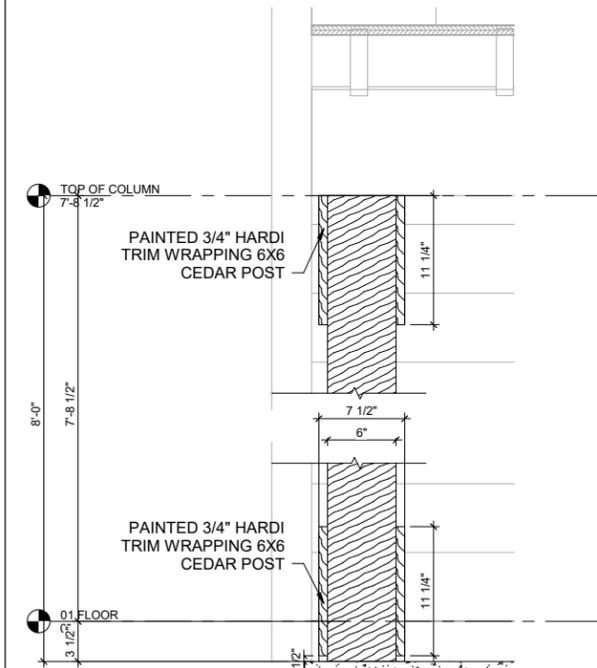


3 BUILT UP COLUMN SECTION
3/4" = 1'-0"

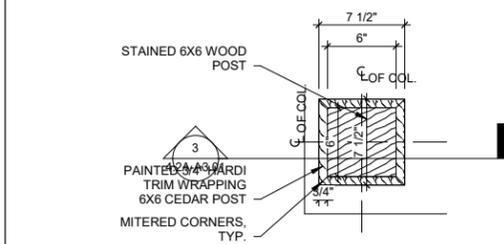

2 BUILT UP COLUMN DETAIL
3/4" = 1'-0"

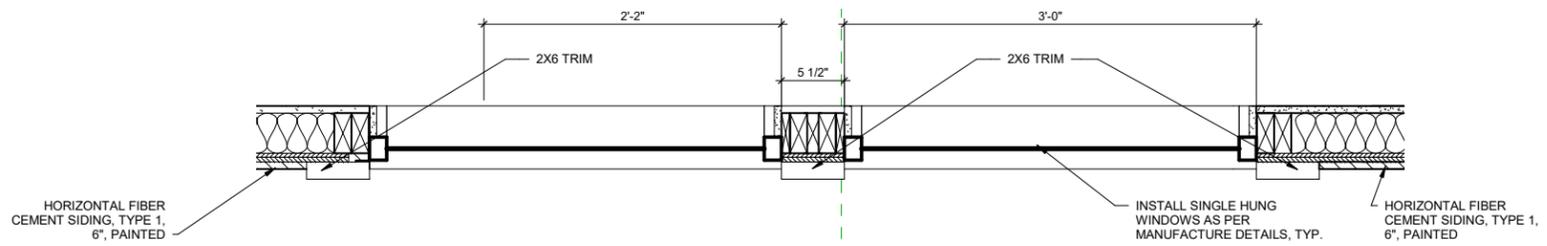


5 WINDOW DETAIL
3/4" = 1'-0"

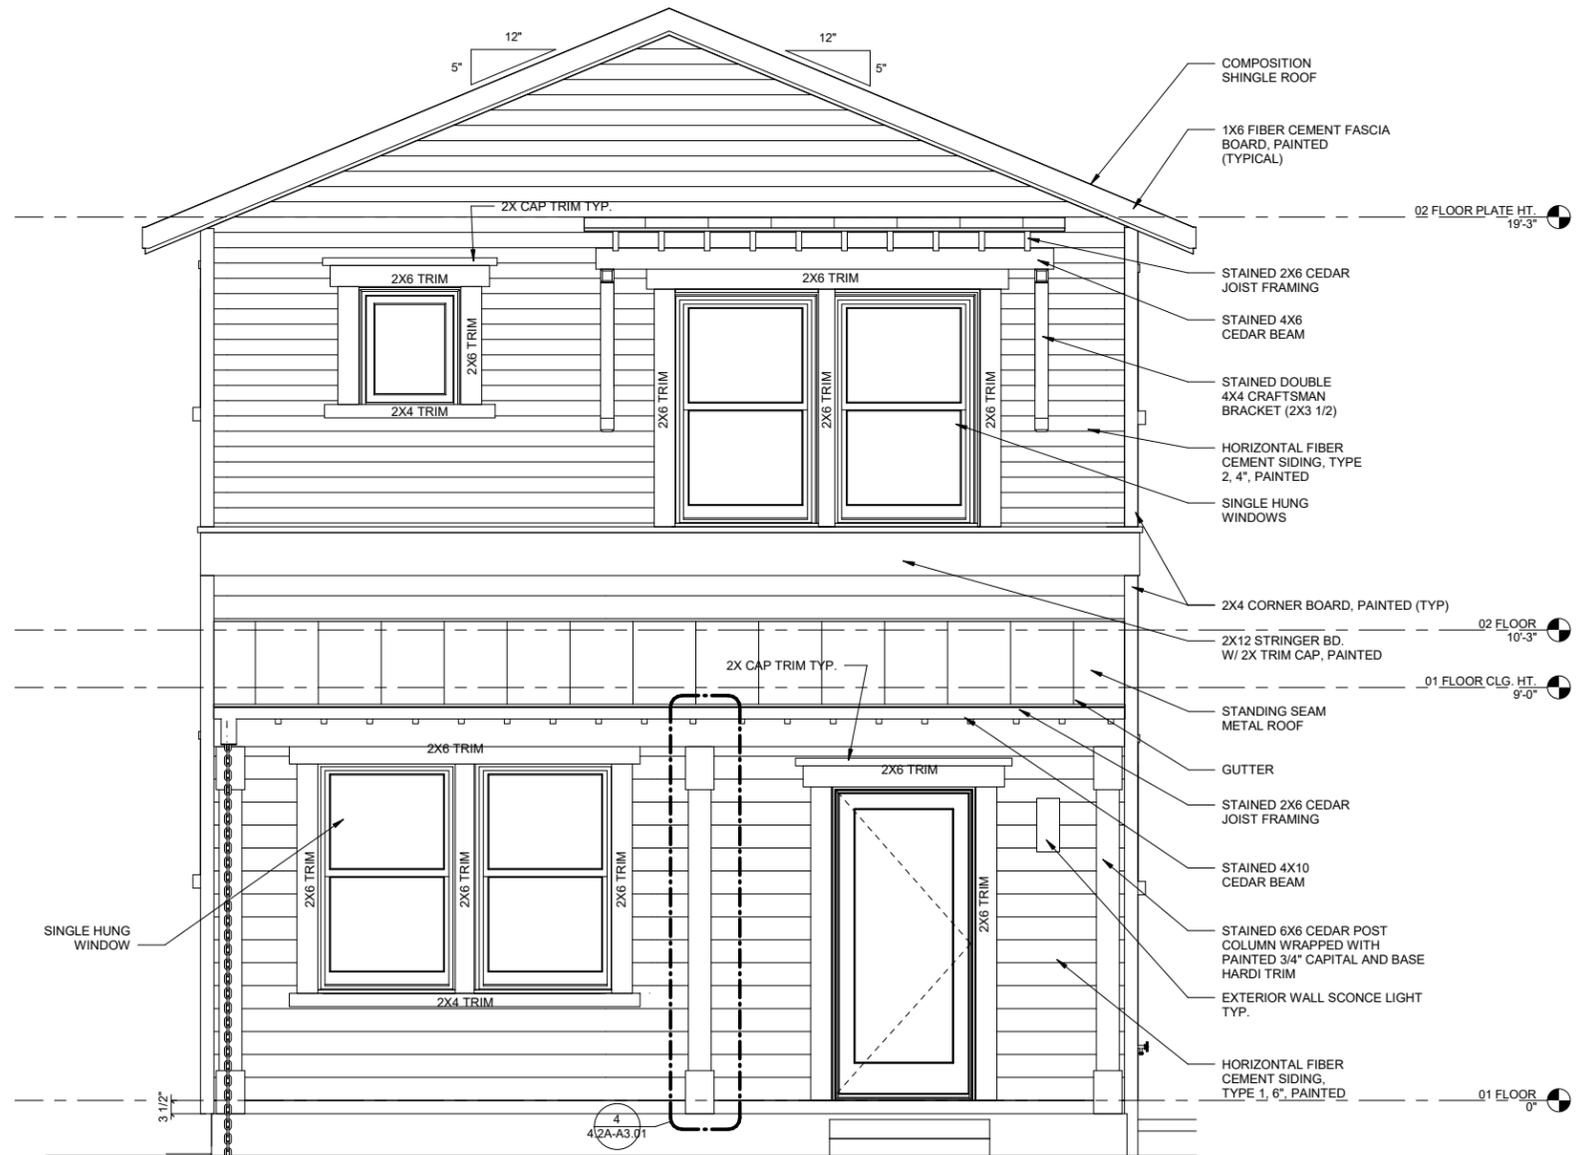

1 PROTOTYPE 4.2A - FRONT ELEVATION
1/4" = 1'-0"

2/6/2017 1:39:00 PM

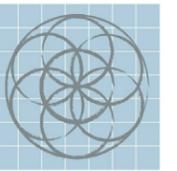

SEVENTH
GENERATION
DESIGN

ARCHITECTURE | SUSTAINABILITY | PRESERVATION

118 Broadway, Suite 519
San Antonio, Texas 78205
TEL (210) 262-6161 TEL (210) 241-7490

Urban at Olive

600 Block Burleson San
Antonio, TX

No.	Date	Description
1	02/06/2017	Construction Set



BACK ELEVATION

PROTOTYPE 4.2A




Scott William Carpenter
February 6, 2017

Project number
Date February 6, 2017


Drawn by
Checked by

4.2A-A3.02

Scale

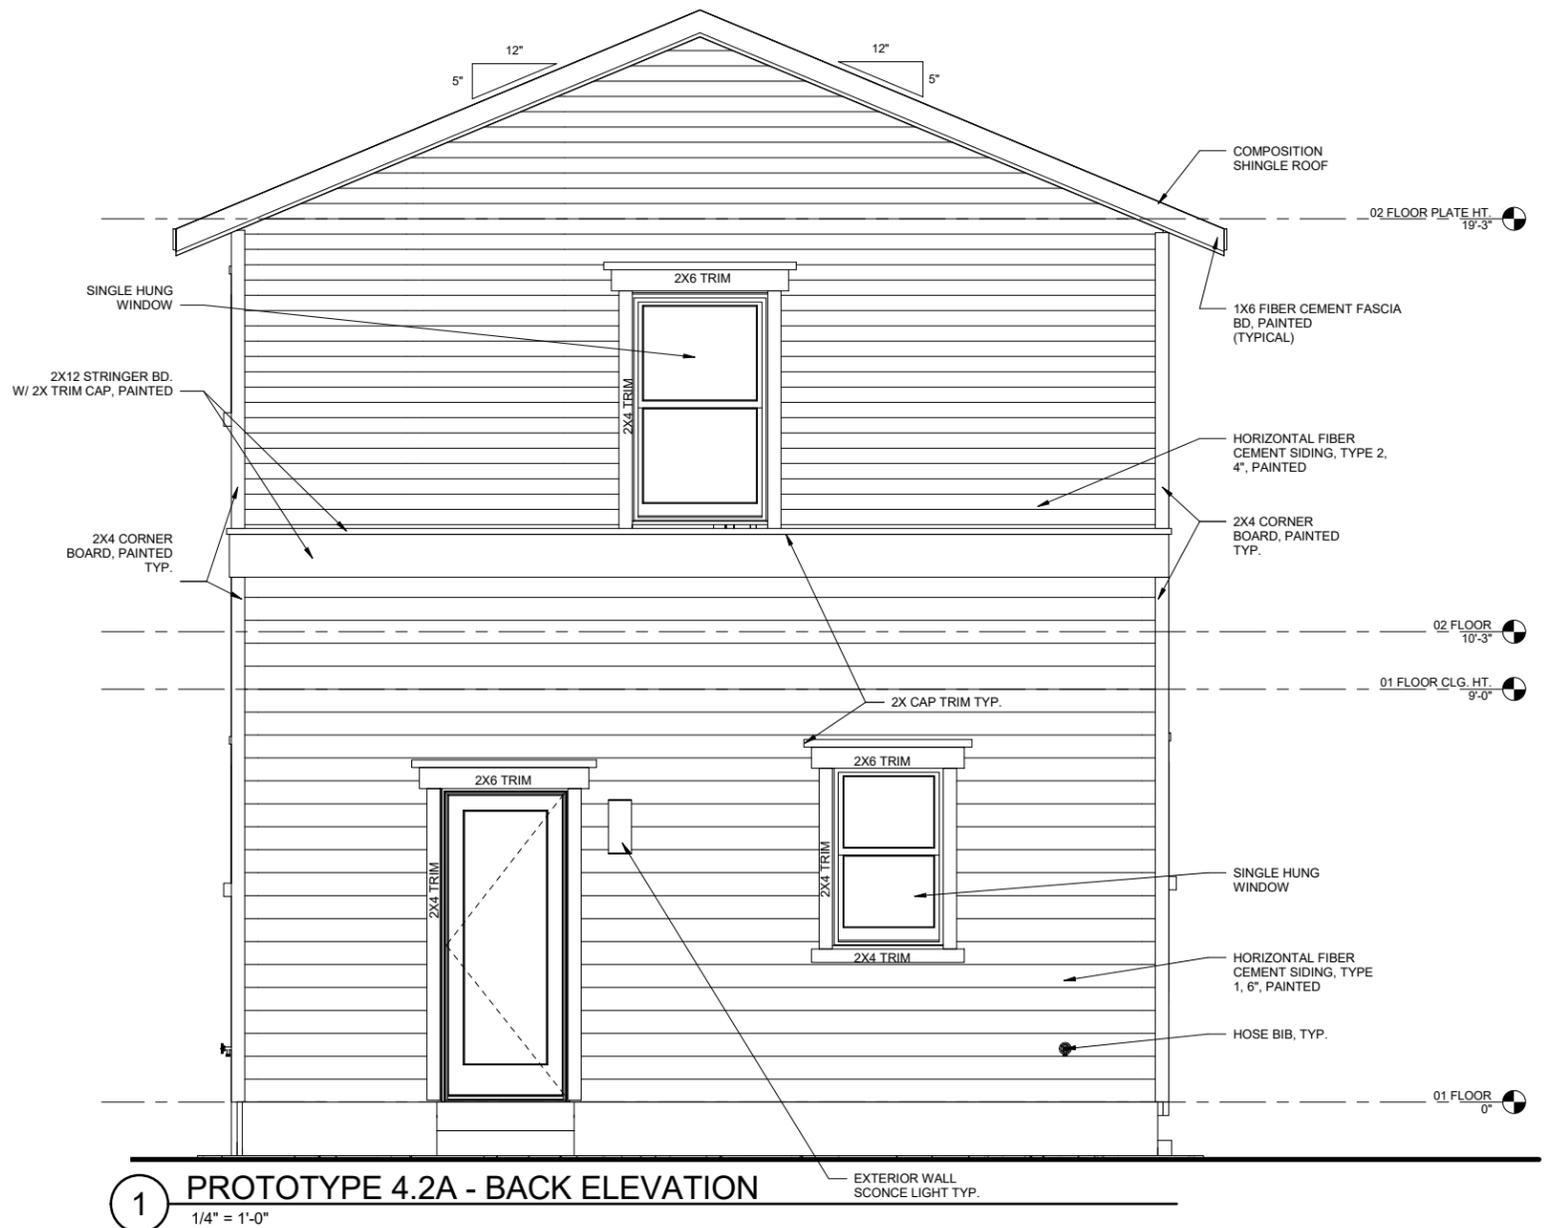

1 **PROTOTYPE 4.2A - BACK ELEVATION**
1/4" = 1'-0"

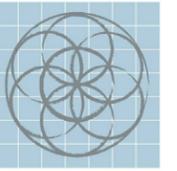

SEVENTH
GENERATION
DESIGN

ARCHITECTURE | SUSTAINABILITY | PRESERVATION

118 Broadway, Suite 519
San Antonio, Texas 78205
TEL (210) 262-6161 TEL (210) 241-7490

Urban at Olive

600 Block Burleson San
Antonio, TX

No.	Date	Description
1	02/06/2017	Construction Set



SIDE ELEVATION

PROTOTYPE 4.2A




Scott William Clifton
February 6, 2017

Project number
Date February 6, 2017

Drawn by
Checked by

4.2A-A3.04

Scale

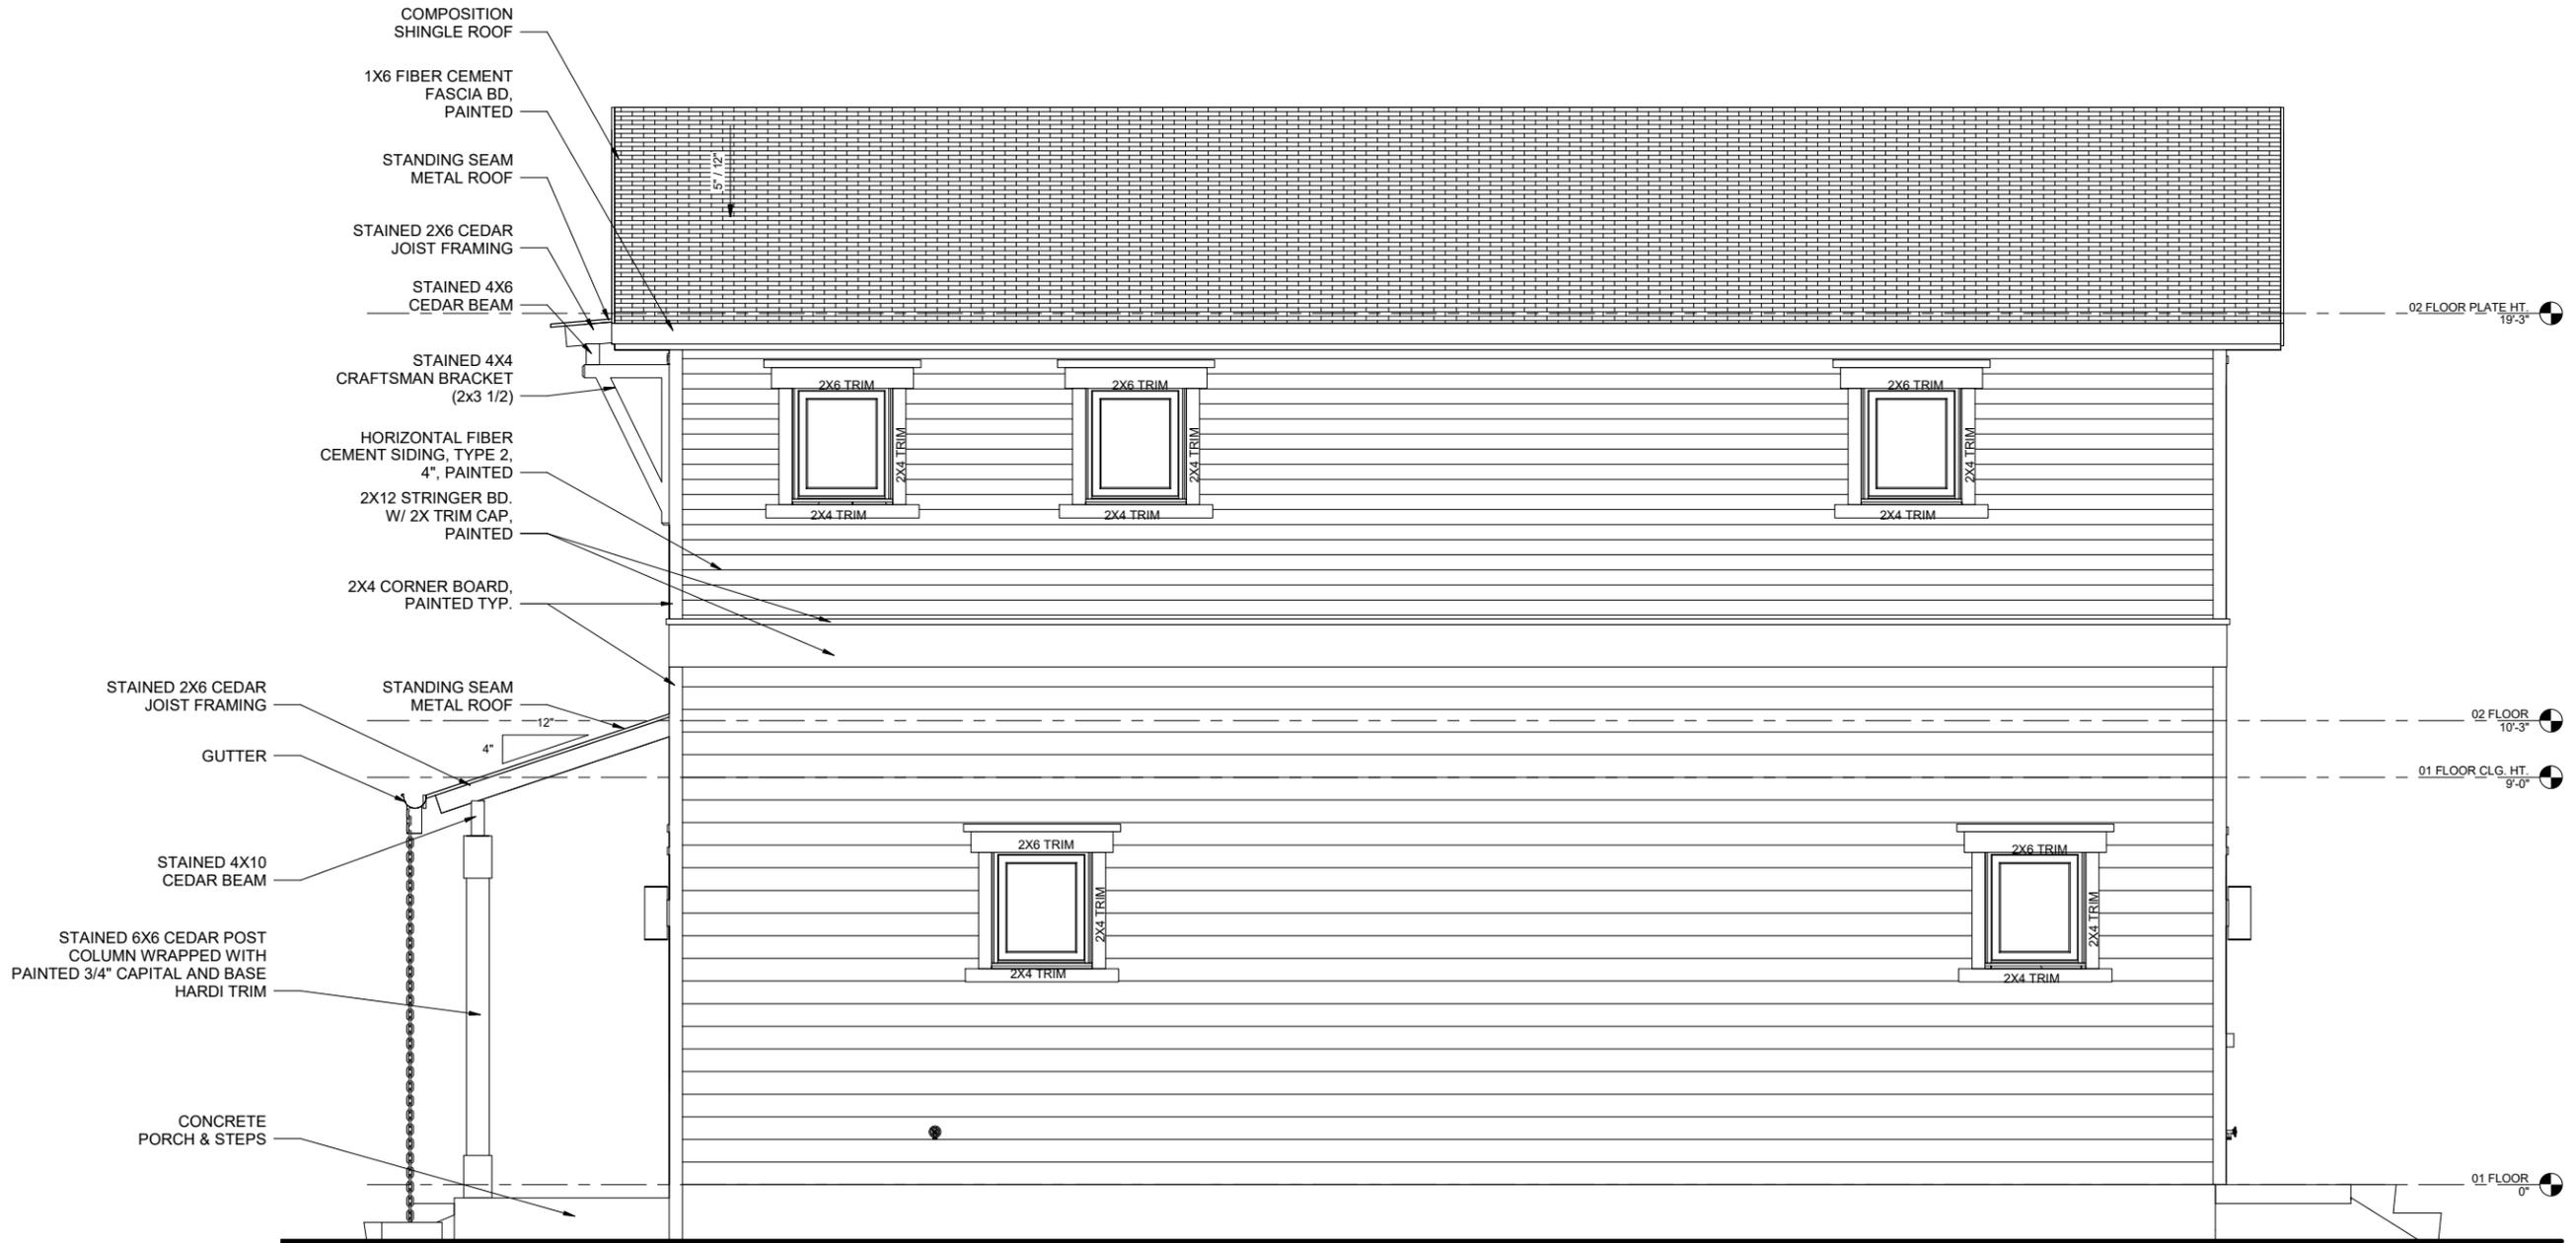


1 PROTOTYPE 4.2A - SIDE ELEVATION
1/4" = 1'-0"

2/6/2017 1:38:05 PM

INSULATION LEGEND


- INDICATES WEATHER BARRIER
- THERMAL INSULATION (DENOTES THERMAL ENVELOPE)

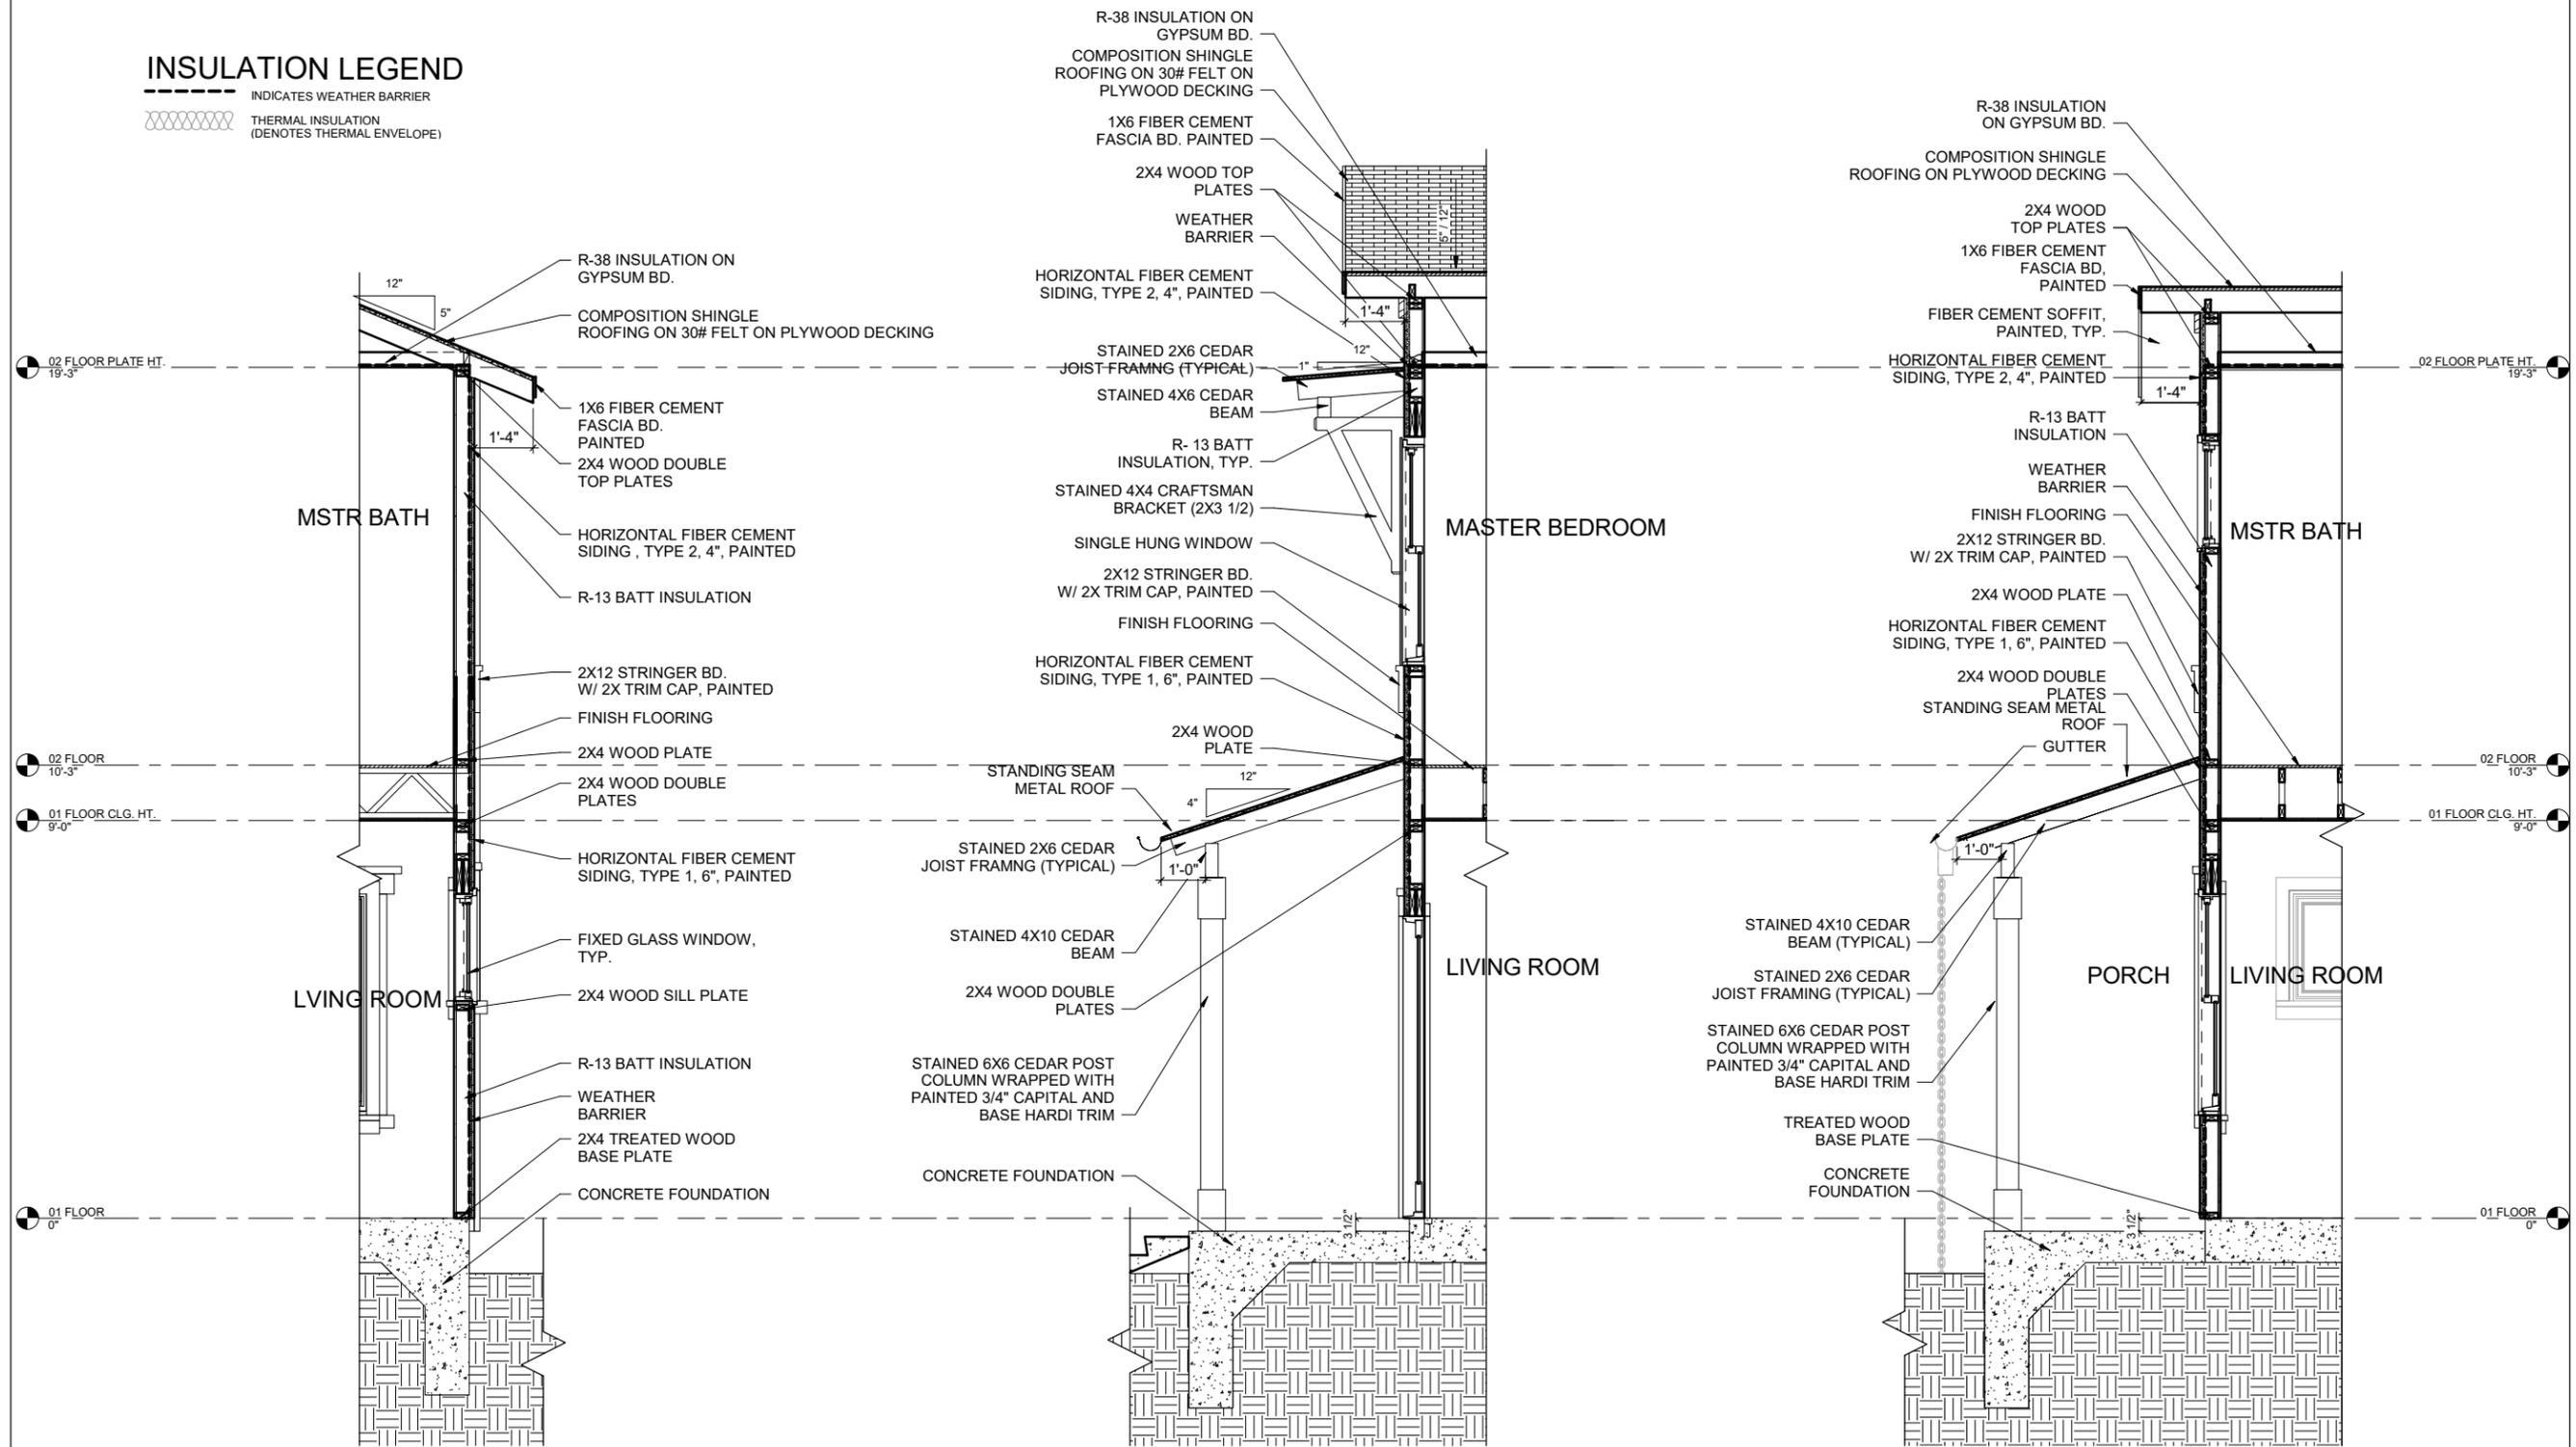

3 **PROTOTYPE 4.2A - WALL SECTION AT LIVING RM.**
1/4" = 1'-0"

2 **PROTOTYPE 4.2A - SECTION AT FRONT WALL**
1/4" = 1'-0"

1 **PROTOTYPE 4.2A - PARTIAL SECTION AT PORCH**
1/4" = 1'-0"

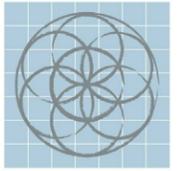

SEVENTH GENERATION DESIGN
ARCHITECTURE | SUSTAINABILITY | PRESERVATION
118 Broadway, Suite 519
San Antonio, Texas 78205
TEL (210) 262-6161 TEL (210) 241-7490

Urban at Olive

600 Block Burleson San Antonio, TX

No.	Date	Description
1	02/06/2017	Construction Set



EXTERIOR SECTIONS & DETAILS

PROTOTYPE 4.2A




February 6, 2017

Project number
Date February 6, 2017
Drawn by
Checked by

4.2A-A4.01

Scale

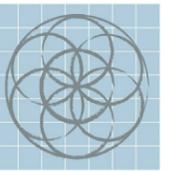


SEVENTH
GENERATION
DESIGN

ARCHITECTURE | SUSTAINABILITY | PRESERVATION


118 Broadway, Suite 519
San Antonio, Texas 78205
TEL (210) 262-6161 TEL (210) 241-7490

INSULATION LEGEND

-  INDICATES WEATHER BARRIER
-  THERMAL INSULATION (DENOTES THERMAL ENVELOPE)

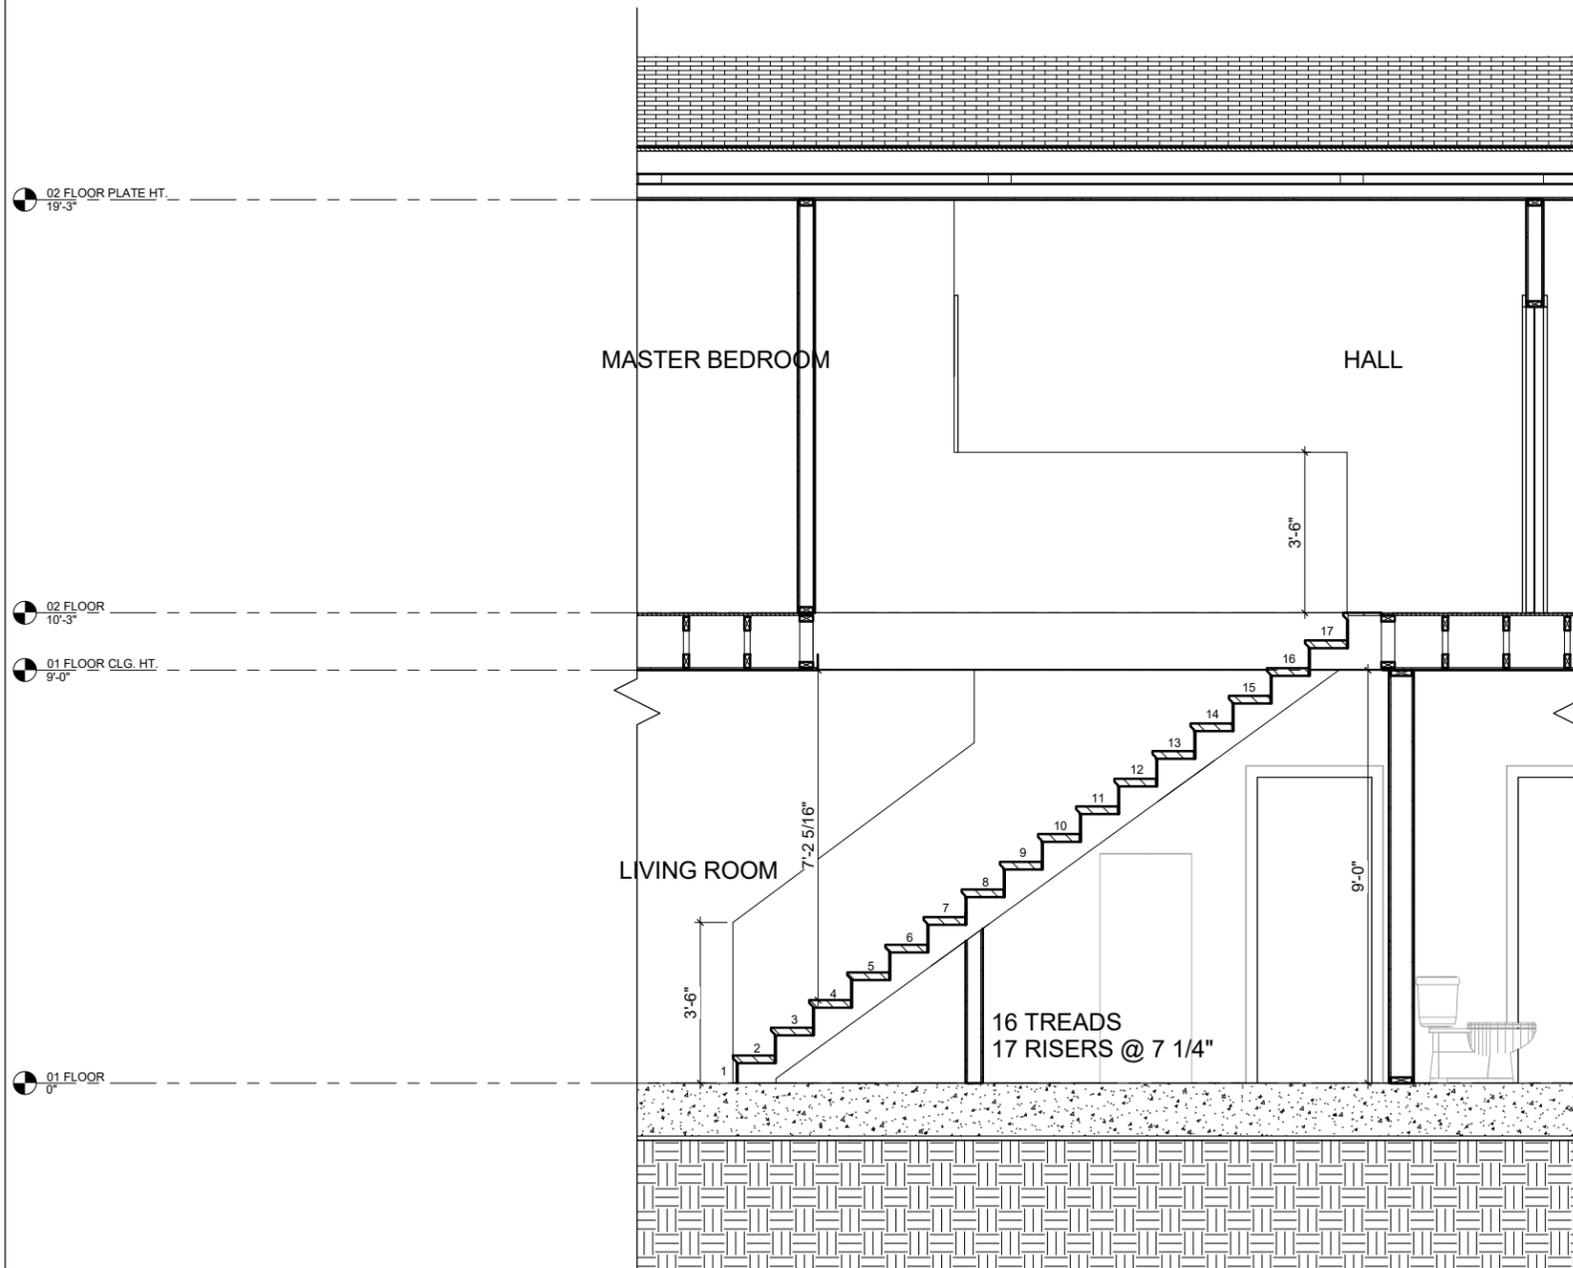

2 PR. 4.2A - STAIRS SECTION
1/4" = 1'-0"

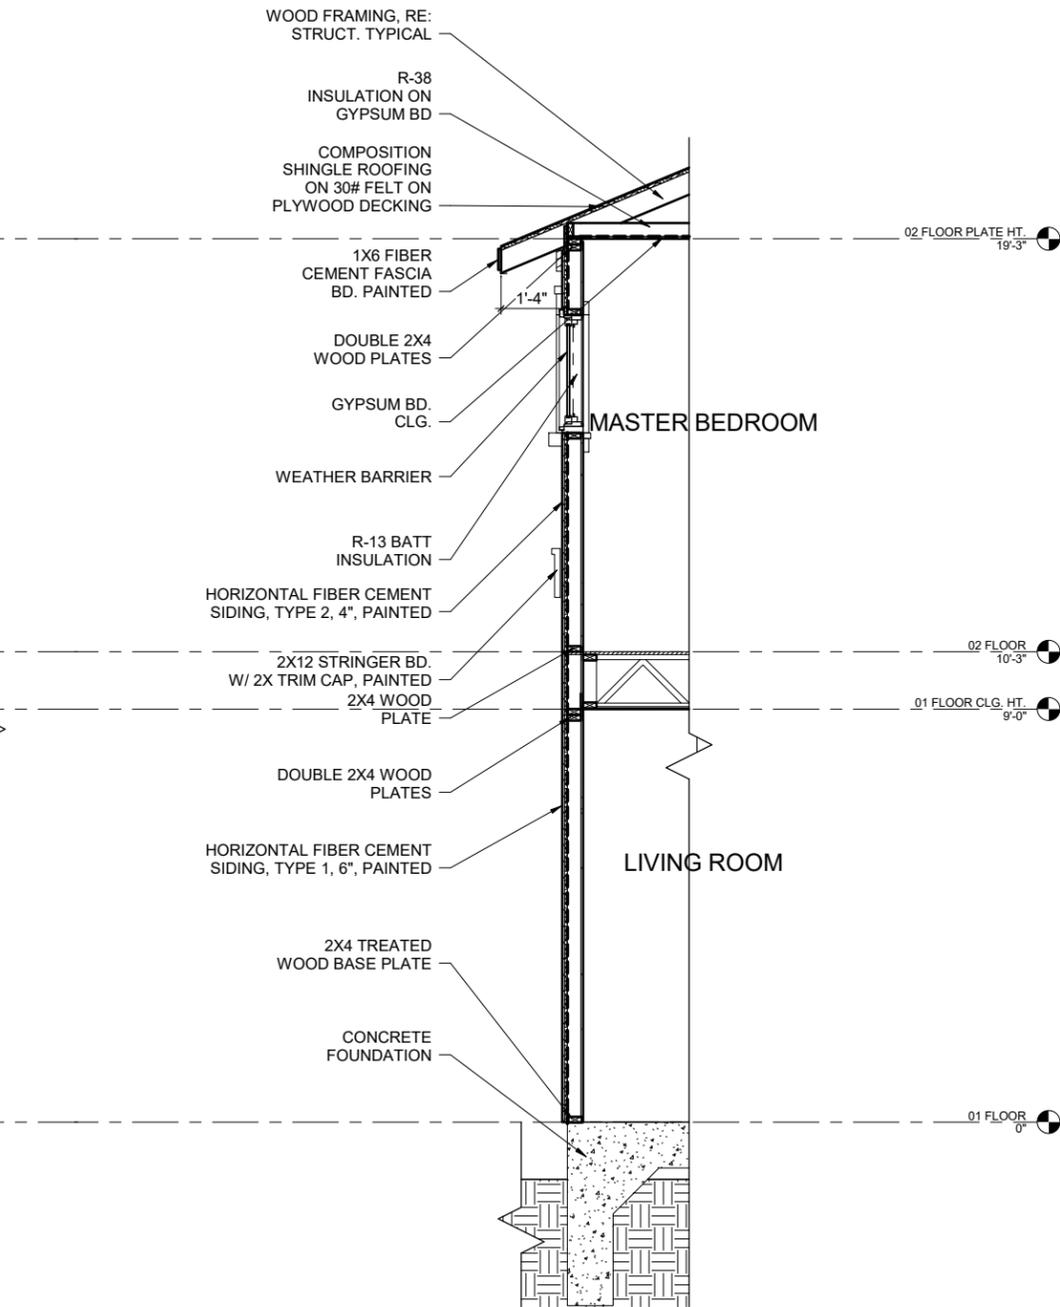

1 PR. 4.2A - WALL SECTION, TYP.
1/4" = 1'-0"

Urban at Olive

600 Block Burleson San Antonio, TX

No.	Date	Description
1	02/06/2017	Construction Set



STAIR PLANS,
SECTIONS & DETAILS

PROTOTYPE 4.2A




William Cupron
February 6, 2017

Project number
Date February 6, 2017
Drawn by Author
Checked by Checker

4.2A-A4.02

Scale

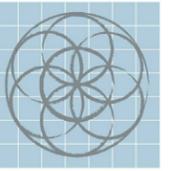

SEVENTH GENERATION DESIGN

ARCHITECTURE | SUSTAINABILITY | PRESERVATION
118 Broadway, Suite 519
San Antonio, Texas 78205
TEL (210) 262-6161 TEL (210) 241-7490

Urban at Olive

600 Block Burleson San Antonio, TX

No.	Date	Description
1	02/06/2017	Construction Set



INTERIOR ELEVATIONS & DETAILS
PROTOTYPE 4.2A OR 4.2B




February 6, 2017

Project number
Date February 6, 2017
Drawn by
Checked by


4.2-A5.01

Scale

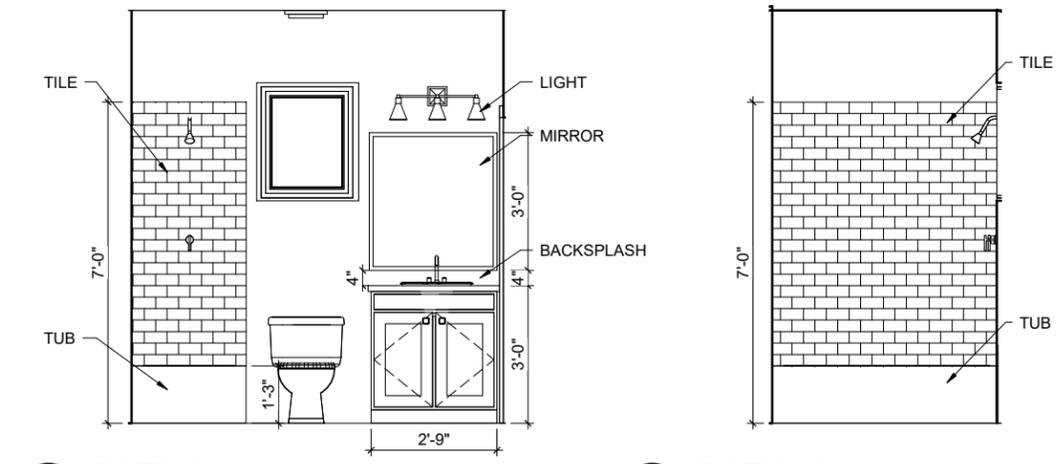


11 BATH 2 c
1/4" = 1'-0"


10 BATH 2 b
1/4" = 1'-0"

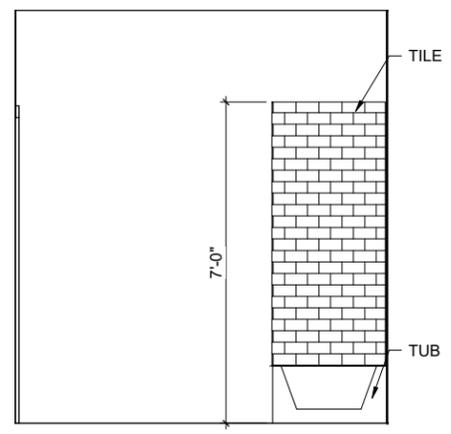

9 BATH 2 a
1/4" = 1'-0"

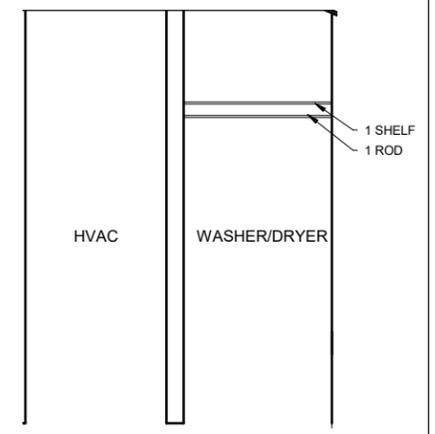


8 UTILITY
1/4" = 1'-0"

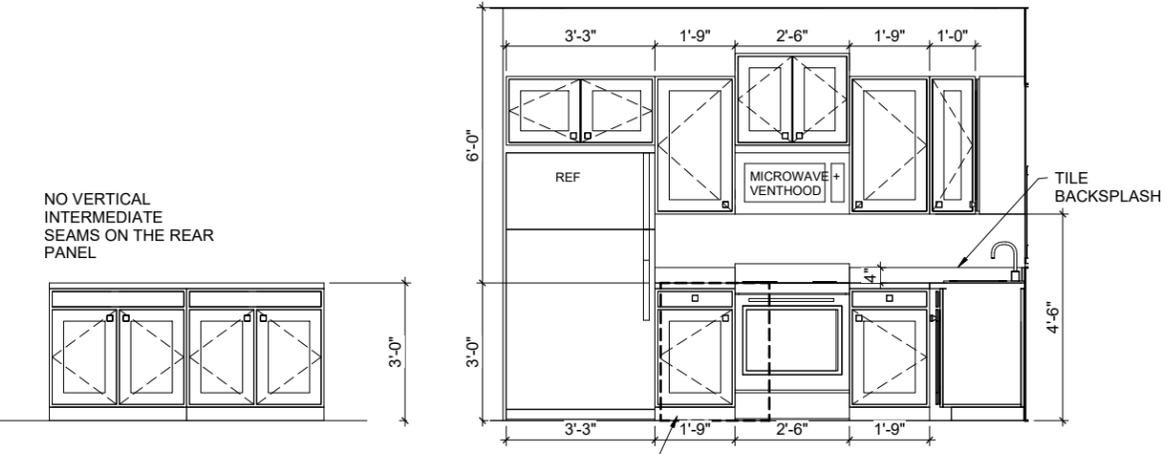


7 OPTIONAL ISLAND
1/4" = 1'-0"


6 KITCHEN b
1/4" = 1'-0"

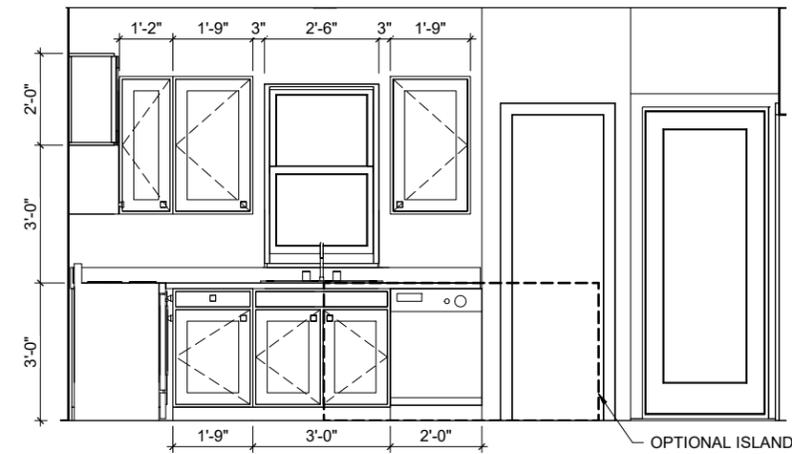


5 KITCHEN a
1/4" = 1'-0"

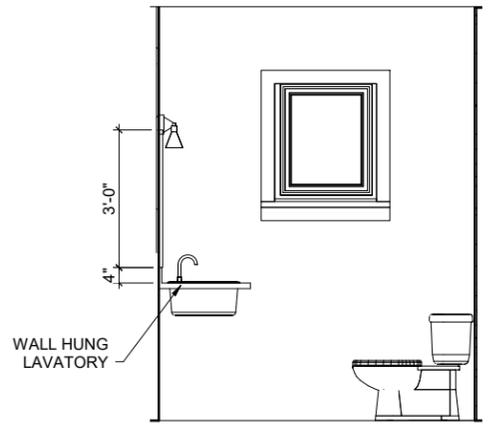


4 PWDR
1/4" = 1'-0"

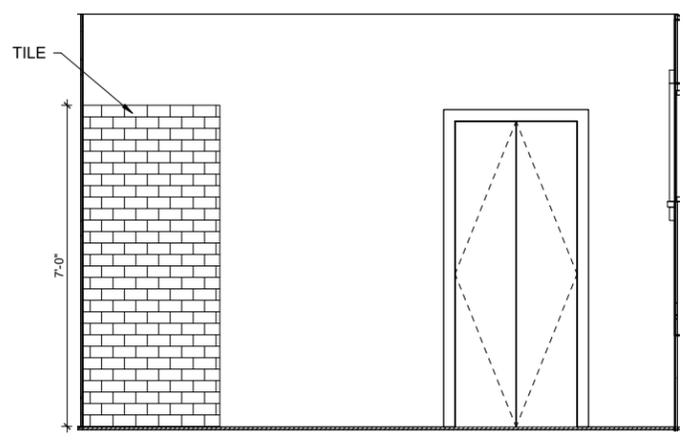


3 MSTR BATH c
1/4" = 1'-0"

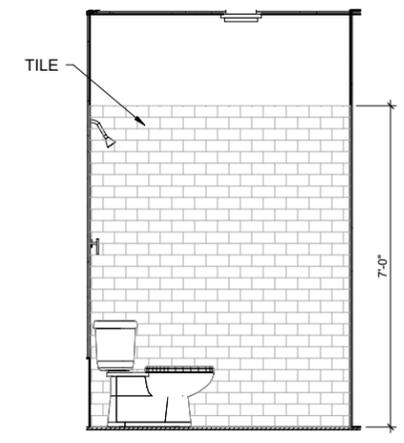

2 MSTR BATH b
1/4" = 1'-0"

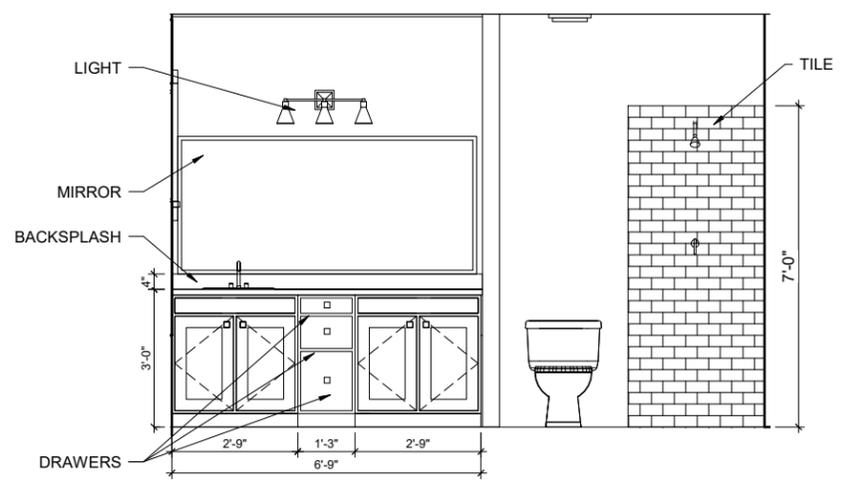

1 MSTR BATH a
1/4" = 1'-0"

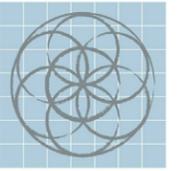

SEVENTH
GENERATION
DESIGN

ARCHITECTURE | SUSTAINABILITY | PRESERVATION

118 Broadway, Suite 519
San Antonio, Texas 78205
TEL (210) 262-6161 TEL (210) 241-7490

Urban at Olive

600 Block Burleson San
Antonio, TX

No.	Date	Description
1	02/06/2017	Construction Set



OPTIONAL GARAGE

**PROTOTYPE 4.2A,
4.2B, 4.2C, 4.2D**




February 6, 2017


Project number
Date February 6, 2017
Drawn by
Checked by

4.2-A5.02


Scale

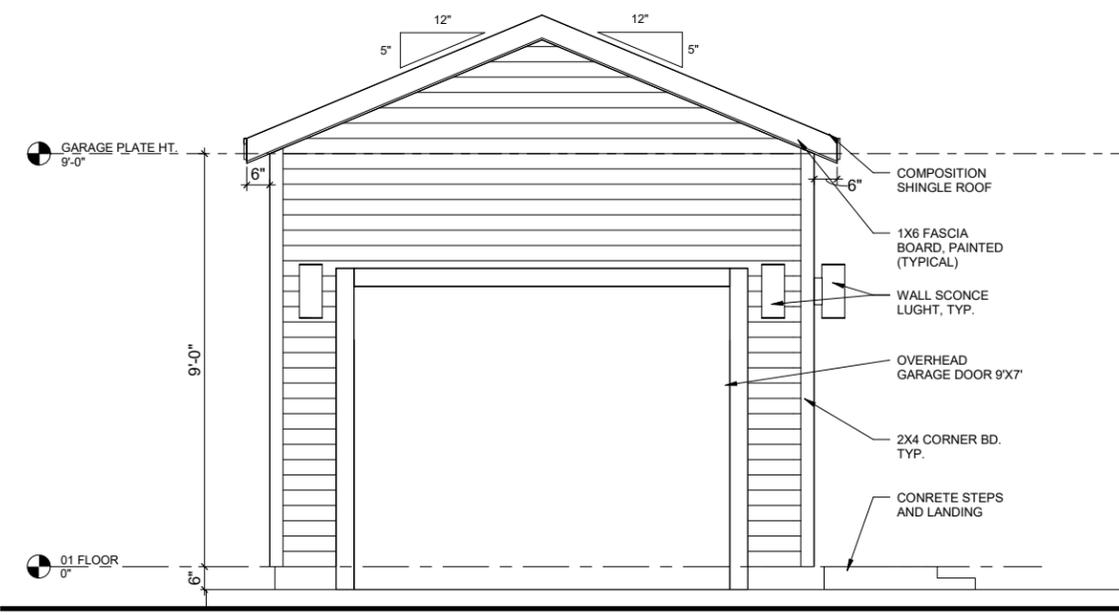

3 FRONT ELEVATION PROTOTYPE 4.2A, 4.2B, 4.2C, 4.2D
1/4" = 1'-0"

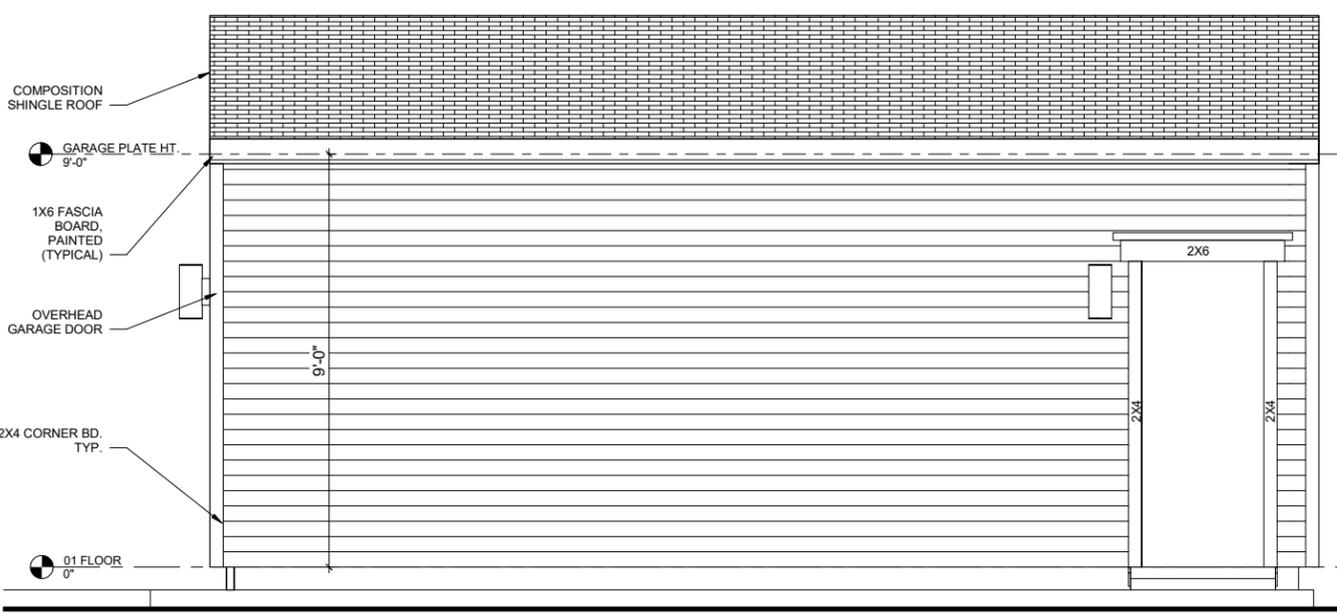


2 SIDE ELEVATION PROTOTYPE 4.2A, 4.2B, 4.2C, 4.2D
1/4" = 1'-0"

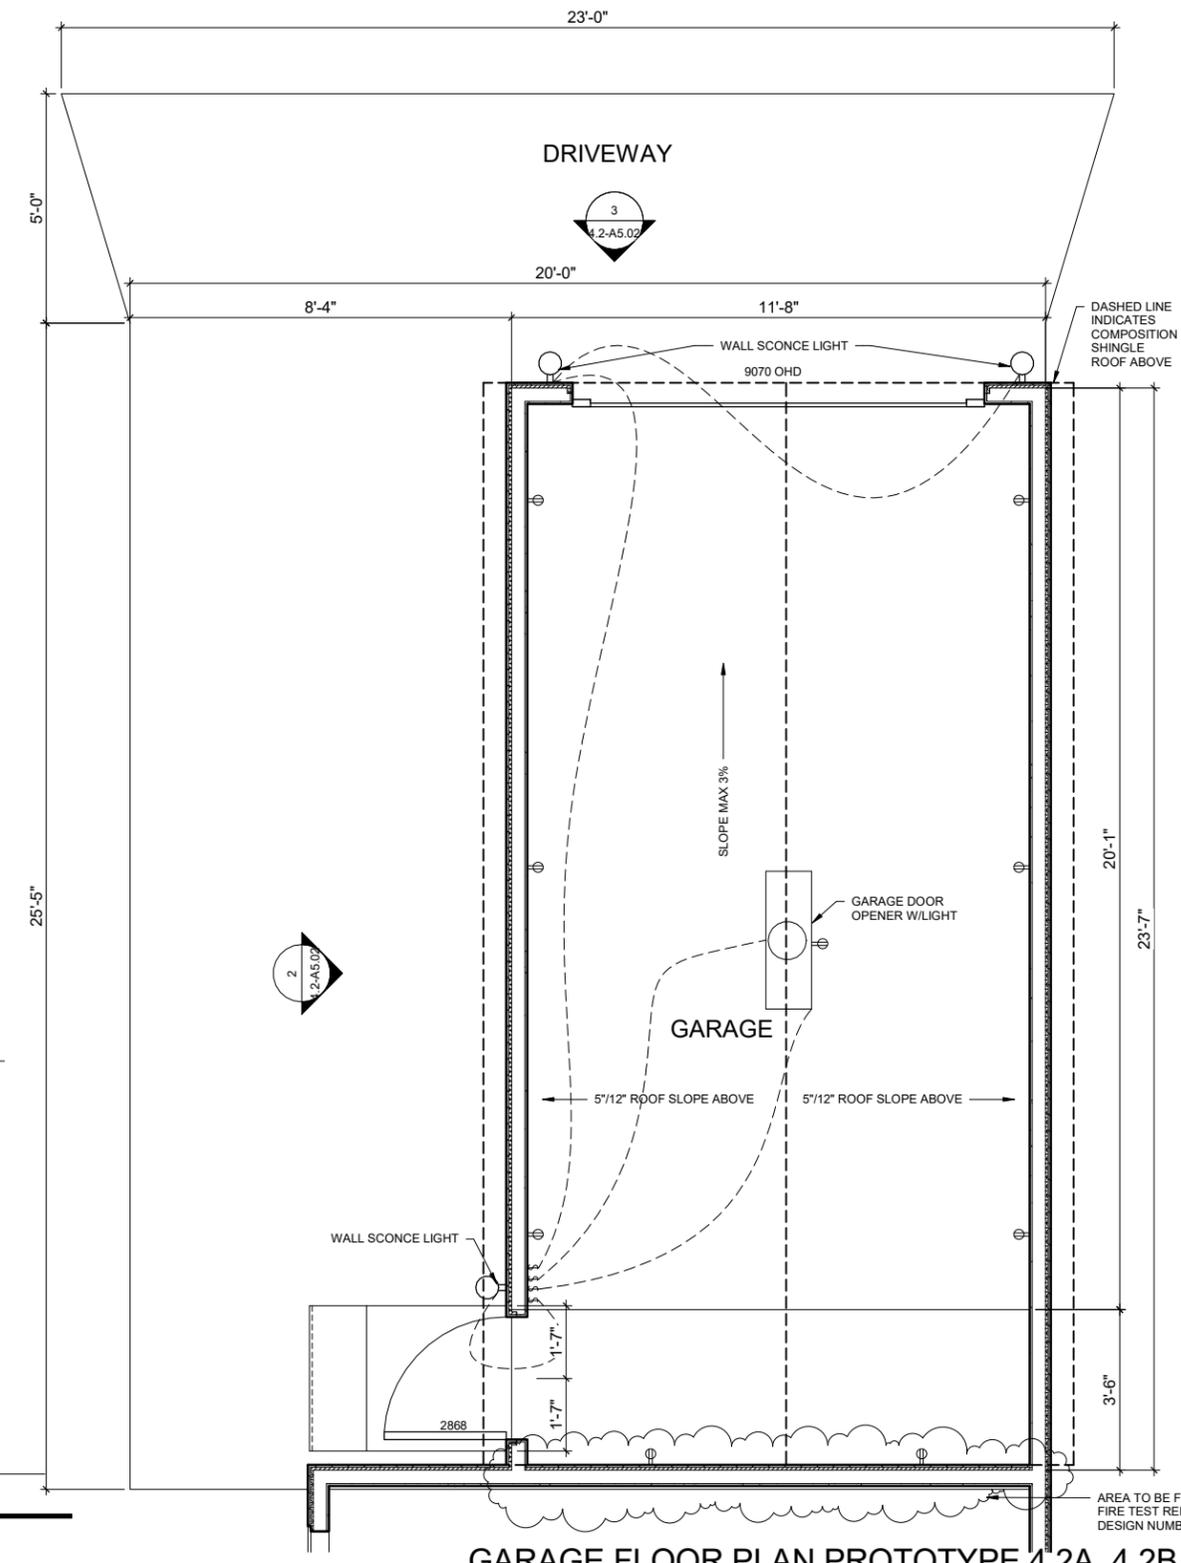

1 GARAGE FLOOR PLAN PROTOTYPE 4.2A, 4.2B, 4.2C, 4.2D
1/4" = 1'-0"

2/13/2017 4:15:02 PM

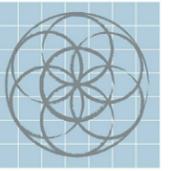

SEVENTH
GENERATION
DESIGN

ARCHITECTURE | SUSTAINABILITY | PRESERVATION

118 Broadway, Suite 519
San Antonio, Texas 78205
TEL (210) 262-6161 TEL (210) 241-7490

Urban at Olive

600 Block Burleson San
Antonio, TX

No.	Date	Description
1	02/06/2017	Construction Set



OPTIONAL CARPORT

PROTOTYPE 4.2A
OR 4.2B



February 6, 2017


Project number
Date February 6, 2017
Drawn by
Checked by

4.2-A5.03


Scale

GENERAL NOTES:


1. USE JOIST HANGERS AT EVERY 2X6 AND 2X8 FRAMING JOISTS.

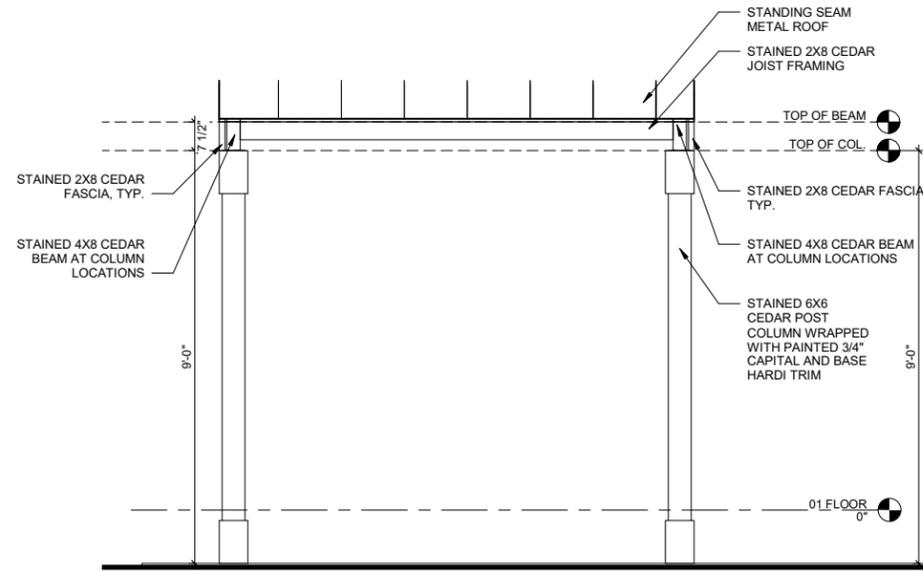

3 FRONT ELEVATION PROTOTYPE 4.2A OR 4.2B
1/4" = 1'-0"

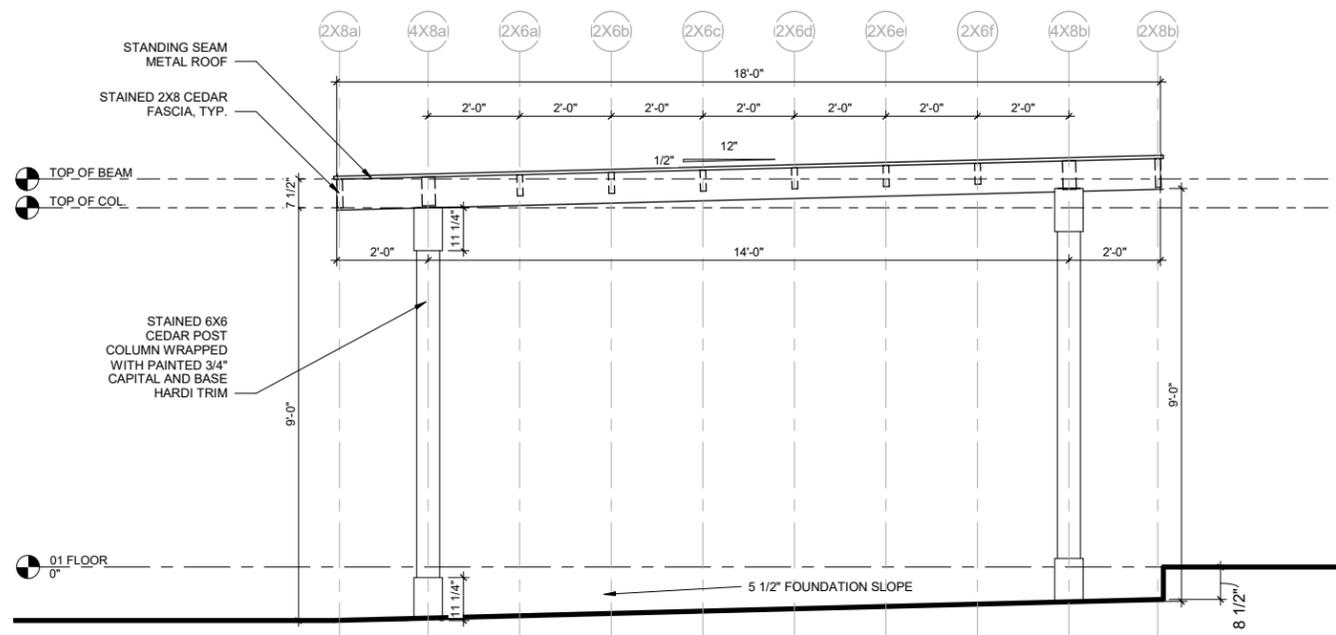

2 SIDE ELEVATION PROTOTYPE 4.2A OR 4.2B
1/4" = 1'-0"

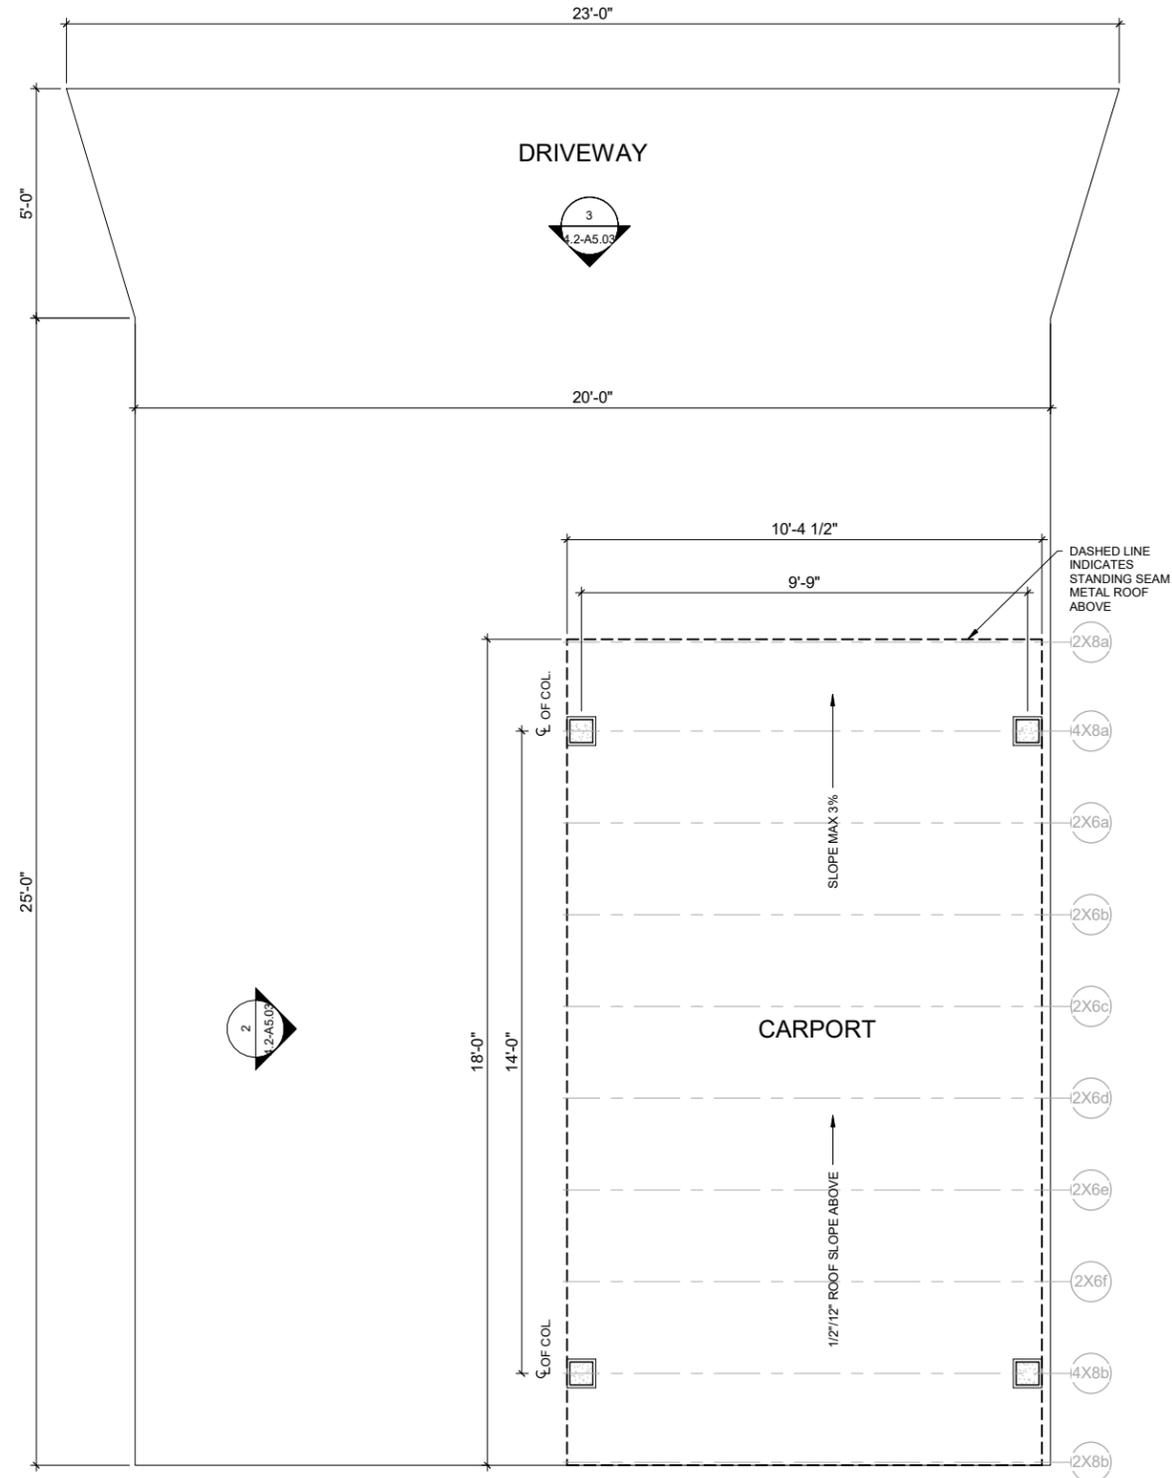

1 CARPORT FLOOR PLAN PROTOTYPE 4.2A OR 4.2B
1/4" = 1'-0"