HISTORIC AND DESIGN REVIEW COMMISSION

December 06, 2017

HDRC CASE NO: 2017-601

ADDRESS: 111 DALLAS ST

LEGAL DESCRIPTION: NCB 799 BLK 17 LOT 1 THRU 4

ZONING: D,HS CITY COUNCIL DIST.:

LANDMARK: Baptist Memorial Hospital, School of Nursing

APPLICANT: Jonathan Nee/Robins and Morton **OWNER:** VHS San Antonio Partners LP

TYPE OF WORK: Entry modifications, installation of new canopy structures

APPLICATION RECEIVED: November 8, 2017 **60-DAY REVIEW:** January 7, 2018

REQUEST:

The applicant is requesting a Certificate of Appropriateness for approval to:

- 1. Replace and extend a vestibule at the Dallas St entrance.
- 2. Modify the existing staircase and install a new accessible ramp at the Dallas St entrance.
- 3. Modify the existing staircase and install a new accessible ramp at the Seymour St entrance.
- 4. Install new canopy structures at the Seymour St entrance.
- 5. Modify the existing hardscaping and landscaping at the Seymour St entrance to accommodate entry modifications and new wheelchair ramps.

APPLICABLE CITATIONS:

Historic Design Guidelines, Chapter 2, Exterior Maintenance and Alterations

10. Commercial Facades

A. MAINTENANCE (PRESERVATION)

- i. *Character-defining features*—Preserve character-defining features such as cornice molding, upper-story windows, transoms, display windows, kickplates, entryways, tiled paving at entryways, parapet walls, bulkheads, and other features that contribute to the character of the building.
- ii. Windows and doors—Use clear glass in display windows. See Guidelines for Architectural Features: Doors, Windows, and Screens for additional guidance.
- iii. *Missing features*—Replace missing features in-kind based on evidence such as photographs, or match the style of the building and the period in which it was designed.
- iv. *Materials*—Use in-kind materials or materials appropriate to the time period of the original commercial facade when making repairs.

B. ALTERATIONS (REHABILITATION, RESTORATION, AND RECONSTRUCTION)

- i. *New features*—Do not introduce new facade elements that alter or destroy the historic building character, such as adding inappropriate materials; altering the size or shape of windows, doors, bulkheads, and transom openings; or altering the façade from commercial to residential. Alterations should not disrupt the rhythm of the commercial block.
- ii. *Historical commercial facades*—Return non-historic facades to the original design based on photographic evidence. Keep in mind that some non-original facades may have gained historic importance and should be retained. When evidence is not available, ensure the scale, design, materials, color, and texture is compatible with the historic building. Consider the features of the design holistically so as to not include elements from multiple buildings and styles.

11. Canopies and Awnings

A. MAINTENANCE (PRESERVATION)

- i. *Existing canopies and awnings*—Preserve existing historic awnings and canopies through regular cleaning and periodic inspections of the support system to ensure they are secure.
- B. ALTERATIONS (REHABILITATION, RESTORATION, AND RECONSTRUCTION)
- i. Replacement canopies and awnings—Replace canopies and awnings in-kind whenever possible.

- ii. *New canopies and awnings*—Add canopies and awnings based on accurate evidence of the original, such as photographs. If no such evidence exists, the design of new canopies and awnings should be based on the architectural style of the building and be proportionate in shape and size to the scale of the building façade to which they will be attached. See UDC Section 35-609(j).
- iii. *Lighting*—Do not internally illuminate awnings; however, lighting may be concealed in an awning to provide illumination to sidewalks or storefronts.
- iv. Awning materials—Use fire-resistant canvas awnings that are striped or solid in a color that is appropriate to the period of the building.
- v. *Building features*—Avoid obscuring building features such as arched transom windows with new canopies or awnings. vi. *Support structure*—Support awnings with metal or wood frames, matching the historic support system whenever possible. Minimize damage to historic materials when anchoring the support system. For example, anchors should be inserted into mortar rather than brick. Ensure that the support structure is integrated into the structure of the building as to avoid stress on the structural stability of the façade.

FINDINGS:

- a. The structure located at 111 Dallas St is a 6-story brick and cast stone commercial building constructed in phases from 1950 1986. The property is part of the Baptist Memorial Hospital complex, which is a local landmark, designated on October 27, 1988. The applicant is requesting approval to modify existing entrances at Dallas St and Seymour St
- b. SIGNIFICANCE This property the location of the original site of the Physicians' and Surgeons' Hospital, which housed one of the first nursing schools in the city, established in 1914. The hospital merged with an adjacent hospital and nursing school in the 1940s. The oldest remaining portion of the complex is at the southeast wing, which fronts Dallas St, constructed in 1950. This structure appears on the 1951 Sanborn Map in its current configuration. The complex was expanded several times in the 1960s and 1970s, and by 1986, all four existing wings were in place. This complex represents the growth and expansion of healthcare and education in San Antonio.
- c. DALLAS ST ALTERATIONS The applicant has proposed to replace an existing vestibule at the Dallas St entrance. The proposal will extend the vestibule canopy footprint to the northwest to accommodate a new accessible ramp. The canopy height will remain the same. Brick veneer columns to match the existing columns supporting the garage walkway will be installed near the entrance, along with new metal panel columns, new painted metal handrails, and a new aluminum curtain wall system. The primary pedestrian stair entrance will be relocated for access from the southeast versus directly off Dallas St. Aluminum storefront windows will infill the existing location of the stairway. In addition to the removal of the metal canopy and brick staircase, the existing cast stone columns and base will be removed to make these modifications. According to the Historic Design Guidelines, existing historic canopies should be preserved. This wing of the complex is the oldest remaining as noted in finding b. A newspaper article from 1952 shows the front façade of the structure with the existing canopy in its current configuration, which matches the footprint in the 1951 Sanborn Map. This canopy is a character defining feature of the historic structure. Staff does not find its removal consistent with the Guidelines.
- d. SEYMOUR ST ALTERATIONS The applicant has proposed to modify an ancillary entrance on Seymour St, located on the far northwest of the façade. The entrance currently features a staircase and handrail leading up to a metal double door with transom. The applicant has proposed to remove the stairs and install a new staircase and landing that extends towards Seymour St. The proposal also includes a new rubbed concrete accessible ramp to the southwest, new painted metal handrail, a prefabricated aluminum canopy, new composite metal columns, and a new composite metal canopy. A new aluminum curtain wall system will be installed on the existing façade to the southwest of the existing double doors. Part of an existing sidewalk will be removed to accommodate the new stairway location. Additional sidewalk modifications will be made to the south to integrate wheelchair ramps. According to the Historic Design Guidelines, new façade elements should not alter or destroy the historic building character. This entrance is secondary and the proposal does not affect character defining features of the façade. Staff finds the proposal acceptable.

RECOMMENDATION:

Items 1 and 2, Staff does not recommend approval at this time based on findings a through c. Staff finds that adding an

accessible ramp and entrance vestibule is appropriate, but finds that the existing canopy structure is a character defining feature of the oldest portion of the complex and should be preserved. Staff recommends that the applicant propose a solution that retains this element.

Items 3, 4, and 5, Staff recommends approval as submitted based on finding d.

CASE MANAGER:

Stephanie Phillips





Flex Viewer

Powered by ArcGIS Server

Printed:Nov 17, 2017

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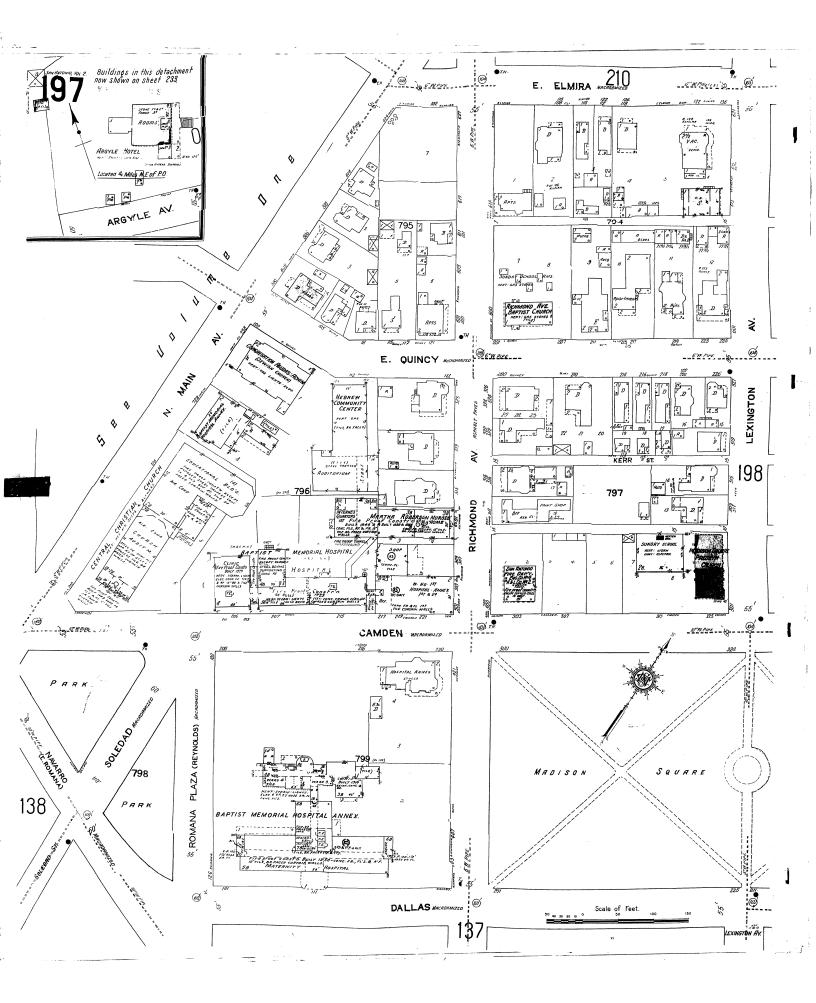












Baptist Memorial Hospital's Nursing School Graduates 477

For the past 25 years the Baptist Memorial Hospital tients. The hospital is approved by women of Christian character, in School of Nursing has contributed to the health needs of San Antonio and the surrounding community by its is an affiliated unit of the Gradu-professional nurse; to help them education program for nurses and doctors. Since 1927 the ate School of Baylor University, professional nurse; to help them school of nursing has offered a three-year diploma course versity, where the students receive preparing them to give the best

ganized as the Medical and Surgi-Board of Nurse Examiners for the twelve weeks affiliation in psycal Memorial Hospital School of State of Texas thereby becoming chiatry at the San Antonio State mum of self-realization. To direct the student toward a thorough unmerging with the Physicians and eligible to register in any state in A MODEST TUITION covers Baptist Denomination and is now social and recreational traditions, assistance Room, board, and laununder the sponsorship of Baptist There are museums, shrines, symdry are provided by the hospital in General Convention of Texas.

medical unit was completed in Septhat are of interest to everyone. newest and most modern hospital, the school is convenient to from the National Accrediting This completely air-conditioned churches, stores, bus stations, rail Assn. and is approved by the Board five-story building is equipped with roads, shopping centers and of Nurse Examiners for the State the latest designed equipment in schools. the nurseries, maternity unit and STUDENTS LIVE in a modern The Baptist Memorial Hospital service areas as well as patient residence, providing a gracious has a capacity of 300 beds. It is a of the mental, physical, spiritual,

their help is more truly wanted or The requirements for admission Dietetic and X-Ray Departments.

or in people's hearts and helping and 2 units of mathematics - alge-

Today many opportunities are open for graduate nurses in hospiling for people, calm judgment, health care have advanced, until tals, public health, schools, indus- poise, common sense, self reliance, nursing has today received real in the process. The knowledge airlines, private duty, re- and good health. search, teaching and other fields. all leading to rewarding careers standards are recognized by the

A new \$11/2 million maternity and al, religious and social activities a working scholarship

the opportunities more real than in to the school are; one must be be-The student nurse not only re- white. The education requirements has been a severe shortage of regceives the finest education, she are: Graduate of an accredited humanity, winning a place of hon- units of history, 2 units of science to ease suffering and replace sick- bra, geometry, or triginometry, experience and advanced training ness with health wherever she (general mathematics is not ac- in specialties like pediatrics or obcepted).

Personal qualifications are a lik-

The school reputation and high sion.

to high school graduates. More THE THREE-XEAR diploma college credit for their biological than 477 graduate nurses from the program, offered by the school enschool are serving the need of the utiles the student to take the example of the utiles the student to take the example of the utiles the student to take the utiles the student to take the utiles the country. The school was first or- amination that is given by the jects. Students also receive a hursing in an evolving democratic

Surgeons Hospital School of Nurs-the United States or a foreign such items as books, courses at ing. In 1948 the trustees of the country, by reciprocity.

Medical and Surgical Hospital The school is situated in the incidentals. Scholarships are avail-Trinity University, uniforms, and transferred all its properties to the heart of an area rich in historical, able for those who need financial phonies, parks, offering recreation- return for what might be termed

THE SCHOOL OF NURSING has tember, 1951. It is the Southwest's Located in downtown San Antonio, received temporary accreditation of Texas.

and homelike atmosphere. Most of general hospital with Medical, Sur-FEW AMONG the thousands of the rooms are double, there are gical, Pediatric, Obstetrical De-young women in search of "first kitchenettes, recreation rooms, a partments, as well as an Out-Pawill find a career in which laundry room and an auditorium. Hient Department, Pathological

The prospects for Graduate tween the ages of 17-35, single, and Nurses today are excellent. There also has the deep satisfaction of high school with 15 units of high United States since before World knowing that she will be serving school credit, 3 units of English, 2 War II.

Advancement in the nursing profession is rapid but depends on experience and advanced training steirics or surgery.

The standards of nursing and

professional nurse; to help them capable in the field of general derstanding of the basic principles underlying the art and science of good nursing, to give them a background of scientific knowledge and the clinical experience necessary to develop an understanding of both the mental and physical illness of man; to develop an appreciation of the student's responsibility to the individual, the family, and the community for the restoration and maintainence of health; to promote the fullest development moral, professional, and cultur

Boxing Taught At School Here

qualities of each student.

Scientific teaching in the art of self-defense is offered by an experienced feacher, Willard Brown, at his Physical Education School, 224 W. Craig Place. Because of the large, soft

boxing gloves that are used, the boys learn this science without acquiring bloody noses they gain here will be valuable to them both in defending The purpose of the School of themselves and as a healthful



SUMMER STUDENTS at Our Lady of Victory Boarding School, 202 S. Grimes St., are a happy lot, as anyone can see from this recent group picture. A much larger enrollment of boarding pupils is expected in the fall term, when a limited number of day students also will be accepted.

EXPRESS-NEWS WANT ADS, G-2211

Lady of Victory Plans Service To Day Pupils

School, 202 S. Grimes St., San Antonia, conducted by the Sisters of Our Lady of Charity, has announced that a limited number of day pupils will be admitted for the fall session.

Opening in September, 1951, in esponse to numerous urgent requests, the school has expanded to ccommodate an increased enrollment. The school building is a modern structure completed in 1951 and the residence hall has been remodeled.

The educational program comprises standard grade and high school courses with individual and class instructions in the fine arts, as well as in home and business raining. Physical well-being and health are promoted through organized recreation and leisure time activities. Boarding students are accepted at any time throughout he entire year. Mother Mary Eudes is the directress.



(MODERN FIREPROOF BUILDING)

CONDUCTED BY THE SISTERS OF OUR LADY OF CHARITY

BOARDING STUDENTS ACCEPTED AT ANY TIME THROUGHOUT THE ENTIRE YEAR Special Arrangement for Limited Number of Day Students

STANDARD COURSES

CERTIFIED FACULTY



Complete facilities for both liberal and fine arts Private or closs instruction in Voice, Piano, Strings, Art, Dancing
Spacious recreation grounds and equipment; health and physical education.
Weekly educational and feature motion pictures.

Open to girls of all Religious Denominations


Located on Forty Acres of Land in the East End, Four Miles From Business Section of San Antonio, One Block Off 2200 East Commerce Street, Highway 90.

STUDENTS ACCEPTED AT ANY TIME DURING YEAR

Phone, Write or Call THE DIRECTRESS for full detailed information

202 South Grimes Street, San Antonio, Texas

Telephone: Belmont 3-7246 -- G-3062

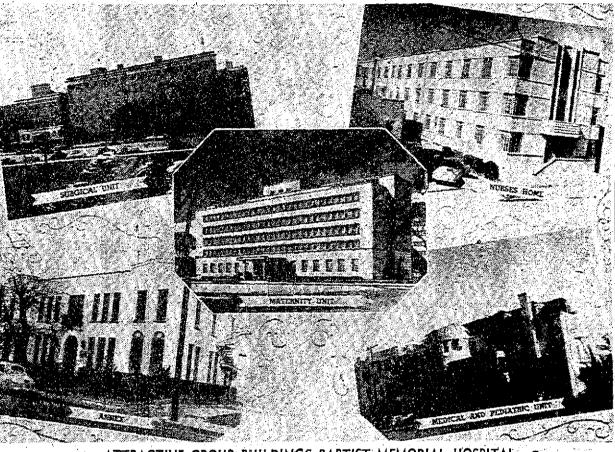

ATTRACTIVE GROUP BUILDINGS BAPTIST MEMORIAL HOSPITAL

BAPTIST MEMORIAL HOSPITAL SCHOOL OF NURSING

School of Nursing Receives National Approval for Temporary Accreditation by the National Nursing Accrediting Service

A THIRTY-SIX MONTHS' COURSE IN NURSING IS OFFERED TO GRADUATES OF ACCREDITED HIGH SCHOOLS WHO ARE BETWEEN THE AGE OF 17 AND 35 AND IN GOOD PHYSICAL HEALTH.

> Conveniently located in the heart of downtown San Antonio, this school offers unusual opportunities to those who wish to prepare for a nursing career. The Hospitol's aim is to provide an institution for research purposes and the training of doctors and nurses so that the health need of the community can be adequately

APPROVED BY Board of Nurse Examiners for the State of Texas American College of Surgeons American Medical Association

AFFILIATED WITH . Trinity University San Antonio State Hospital Graduate School of Baylor University

And a member of the American Hospital Association.

THE OPPORTUNITIES for nurses are greater than ever before in: institutional positions, public health, veterans administration, the army, navy, industrial nursing, private duty and in many other fields.

REGISTER NOW!!

Classes will begin September 3, 1952

For information write the NURSE ADMINISTRATOR, BAPTIST MEMORIAL HOSPITAL, 215 CAMDEN STREET, SAN ANTONIO, TEXAS, or call: B-34381, extension 210.

ADMINISTRATORS

ALFREDA P. HASSELL Assistant Hospital Administrator

ARTHUR MOEDE Hospital Administrator AMY BURROWS Nurse Administrator

111 DALLAS

SAN ANTONIO, TEXAS

The Baptist Medical Center Dallas Street Entrance include renovations to both the Dallas and Seymour Street entrances. Both entrances will receive a ramp and canopy in order to create a covered more accessible entrance for patients. Dallas Street will also be receiving a new vestibule on the outside of the building envelope.

richard I. miller, architect 1033 Demonbreun Street

Nashville Tennessee 37203

infringement will be subject to legal action.

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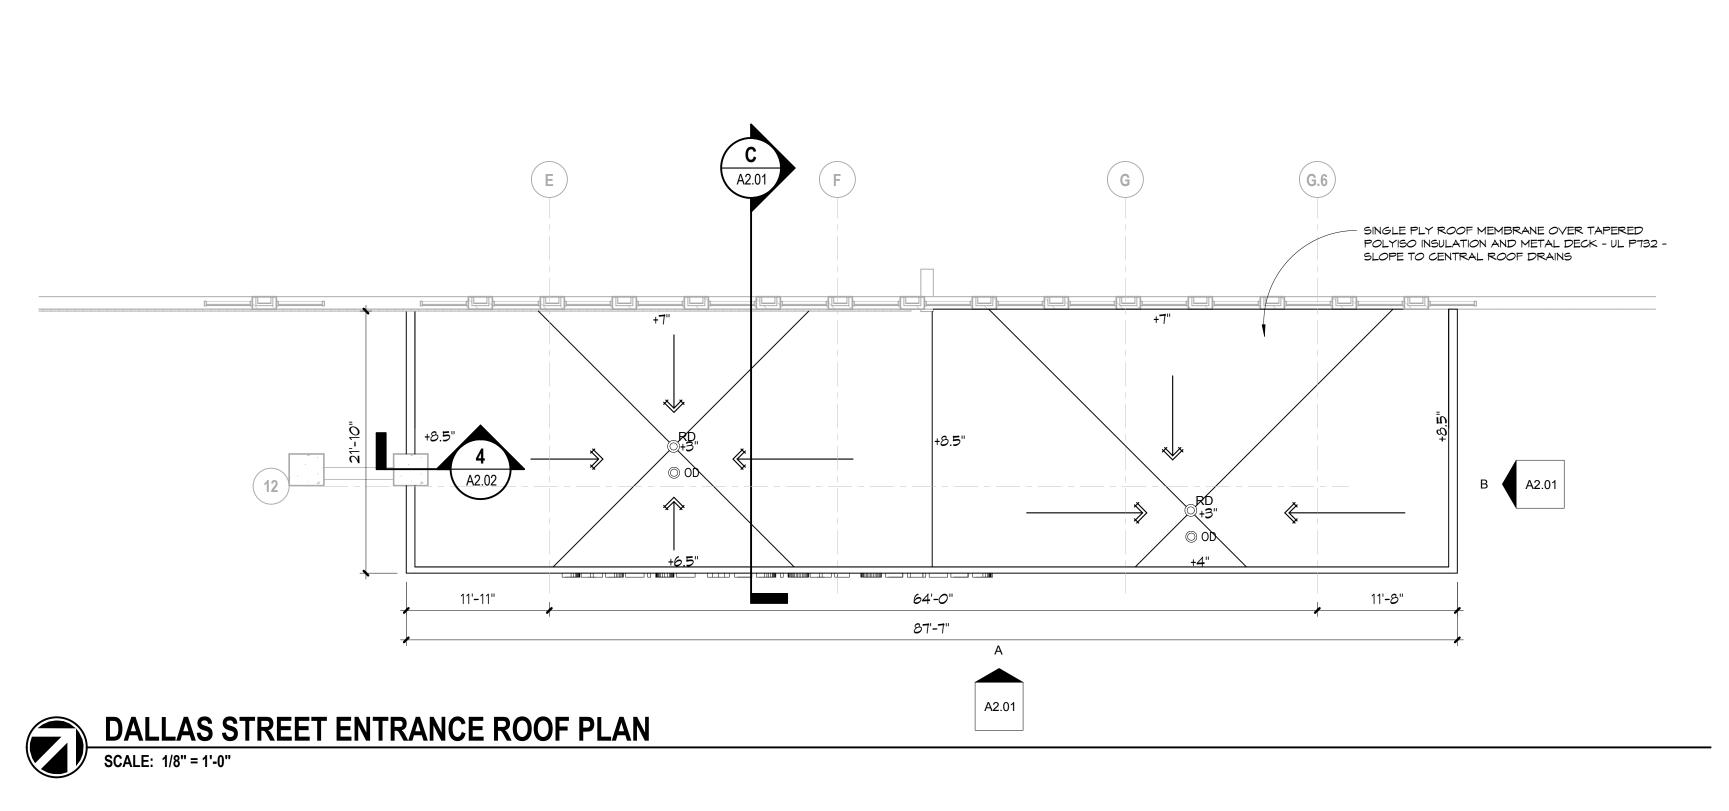
EMERGI DOCUMENT CHANGES

DALLAS ST. ERP Issue Description 09/20/17 Original Issue Date 16072.00 JF Checked By JMR

DEMOLITION AND NEW WORK PLANS -**DALLAS STREET**

ENTRANCE

A1.01A-EX



GYP GYPSUM BOARD/DRYWALL

60, SEE SPECIFICATIONS, PAINT CEILING DIFFUSERS PT-5

RECESSED CAN FIXTURE, SQUARE

FIRE ALARM DEVICE

RECESSED CAN FIXTURE, SQUARE

GYPSUM WALLBOARD


2 X 2 RECESSED LIGHT FIXTURE


ACCESS PANEL (INTEGRAL


EXHAUST/RETURN GRILLE

TO MOOD CEILING)

SUPPLY DIFFUSER

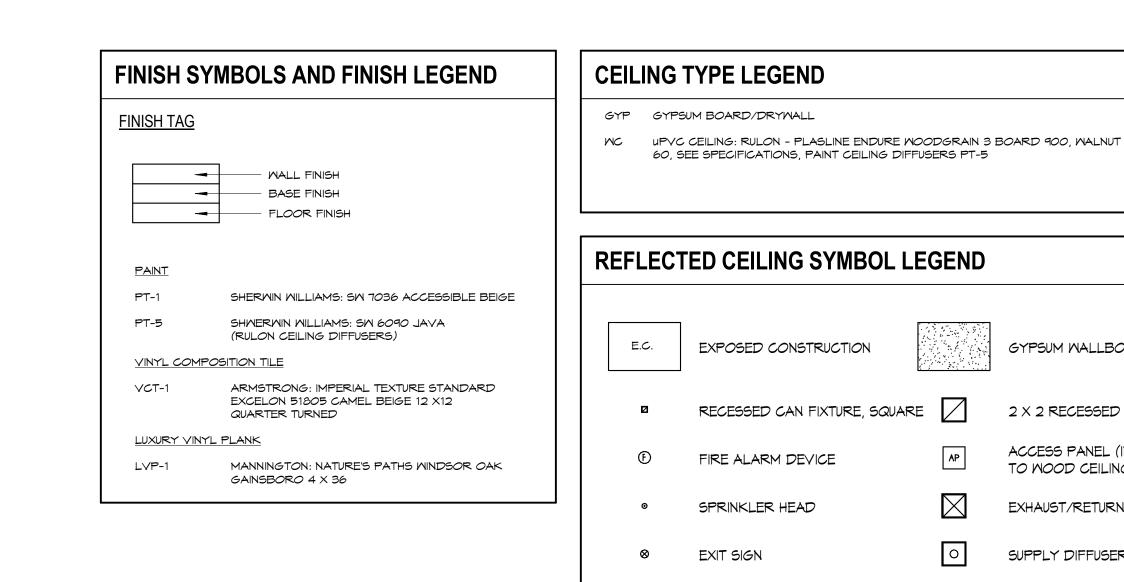

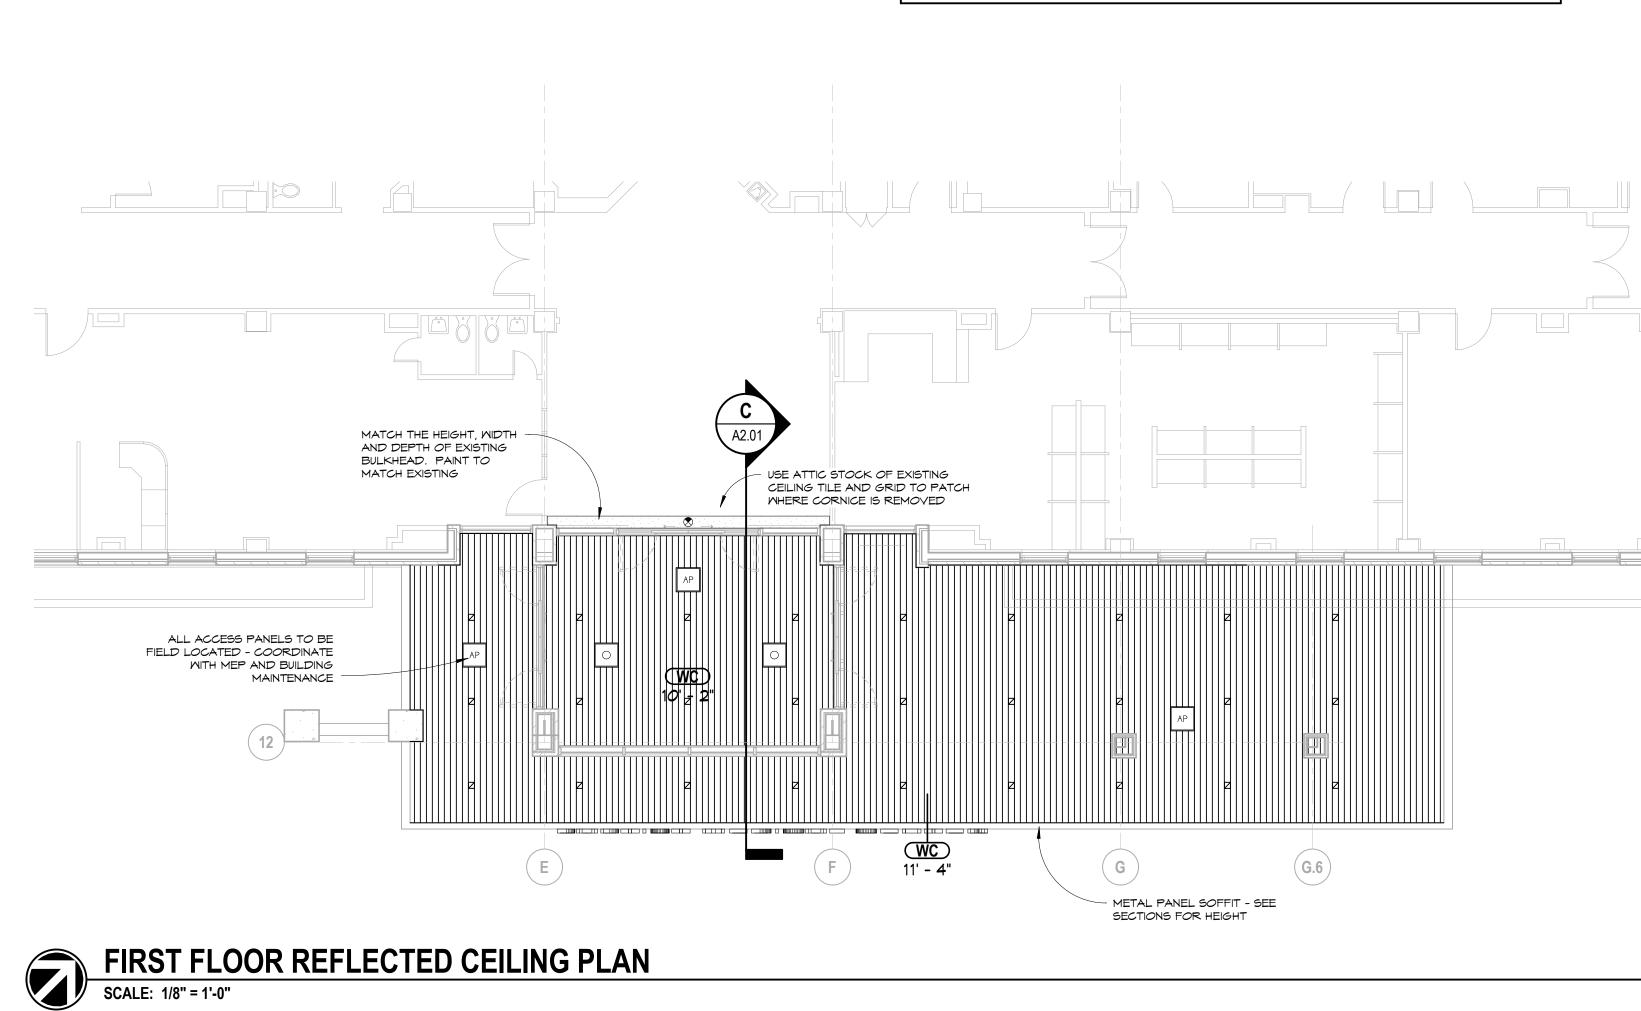

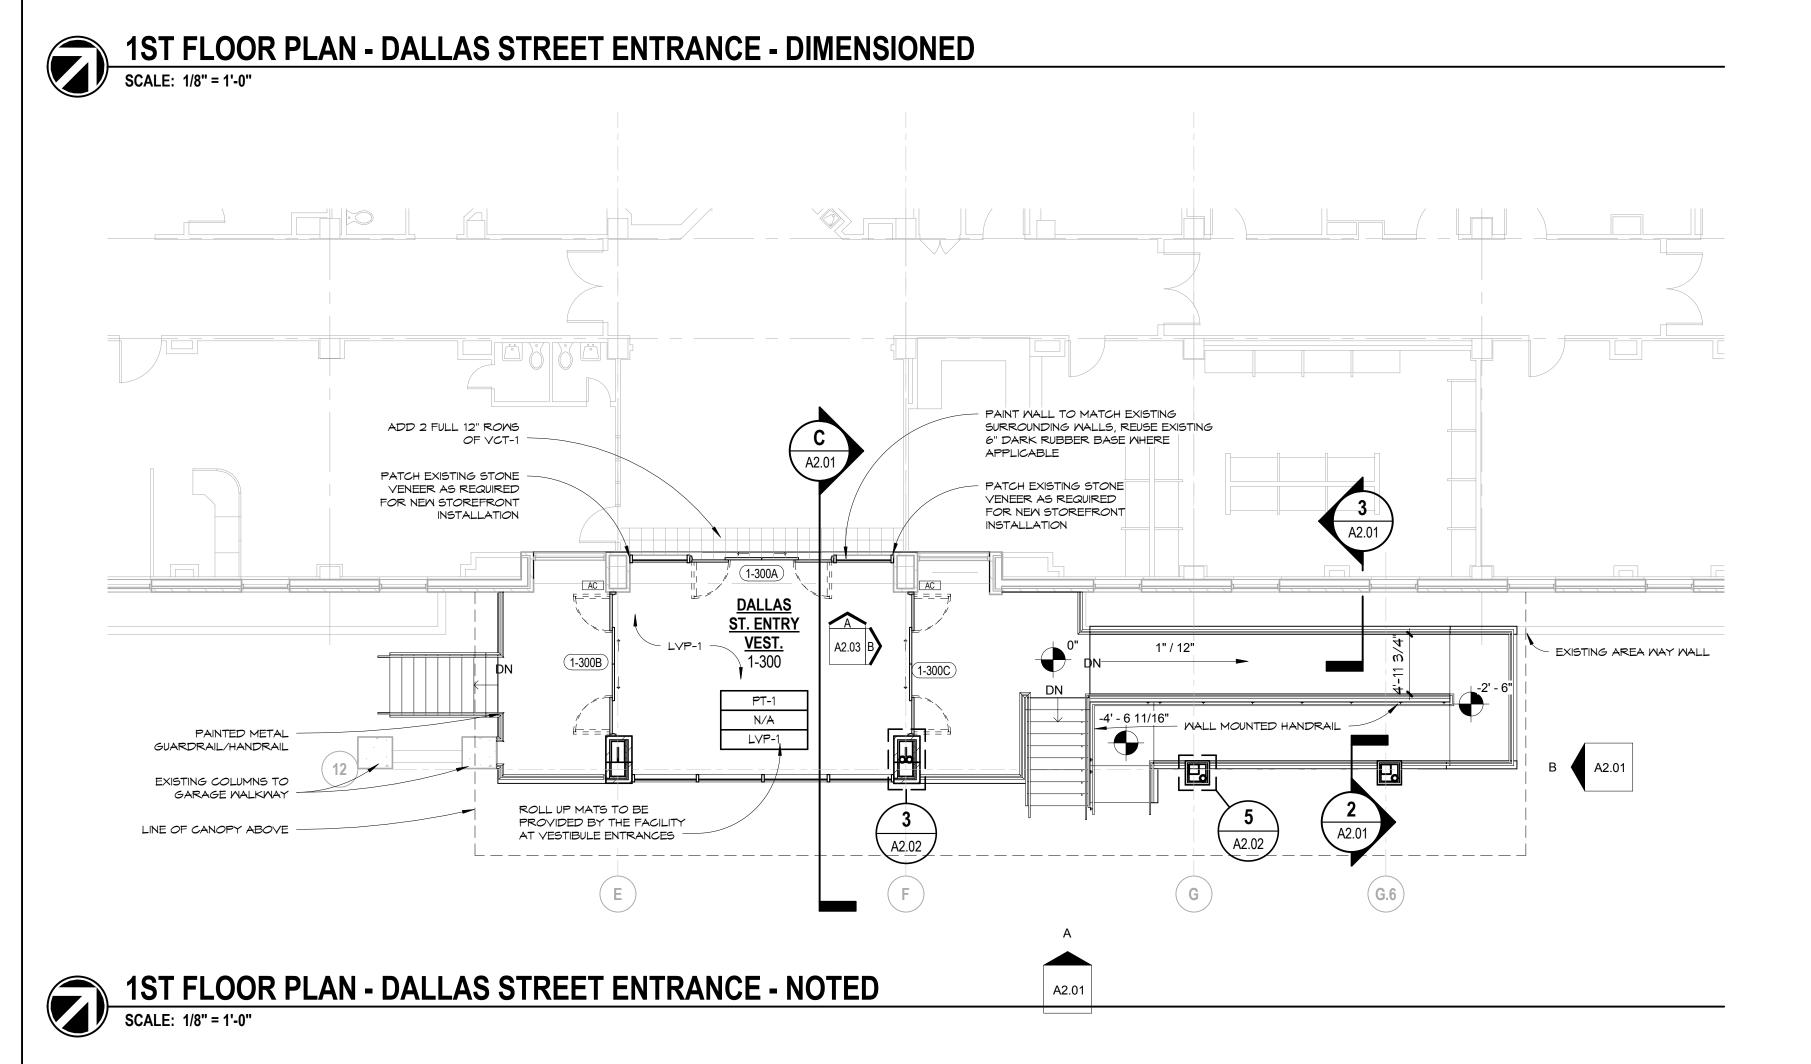

DEMO TWO FULL

EXISTING VCT TILE

SALVAGE RUBBER BASE FOR REUSE

EXISTING SLAB AND -

FOUNDATIONS TO REMAIN - NEW

REMOVE STAIRS TO EXTENT SHOW ON

1ST FLOOF
SCALE: 1/8" = 1'-0"

MORK OCCURS ON TOP OF EXISTING - SEE STRUCTURAL

STRUCTURAL DRAWINGS

9 R @ 6 3/4"

10'-0"

1ST FLOOR PLAN - DALLAS STREET ENTRANCE - DEMOLITION

12" ROWS OF

||------

ST. ENTRY


REMOVE EXISTING FLOORING, BASE

DEMO EXISTING COLUMN WRAPS AND PREPARE

1*0*'-11"

FOR NEW FINISHES - EXISTING COLUMNS TO

AND CEILING MATERIALS THROUGHOUT

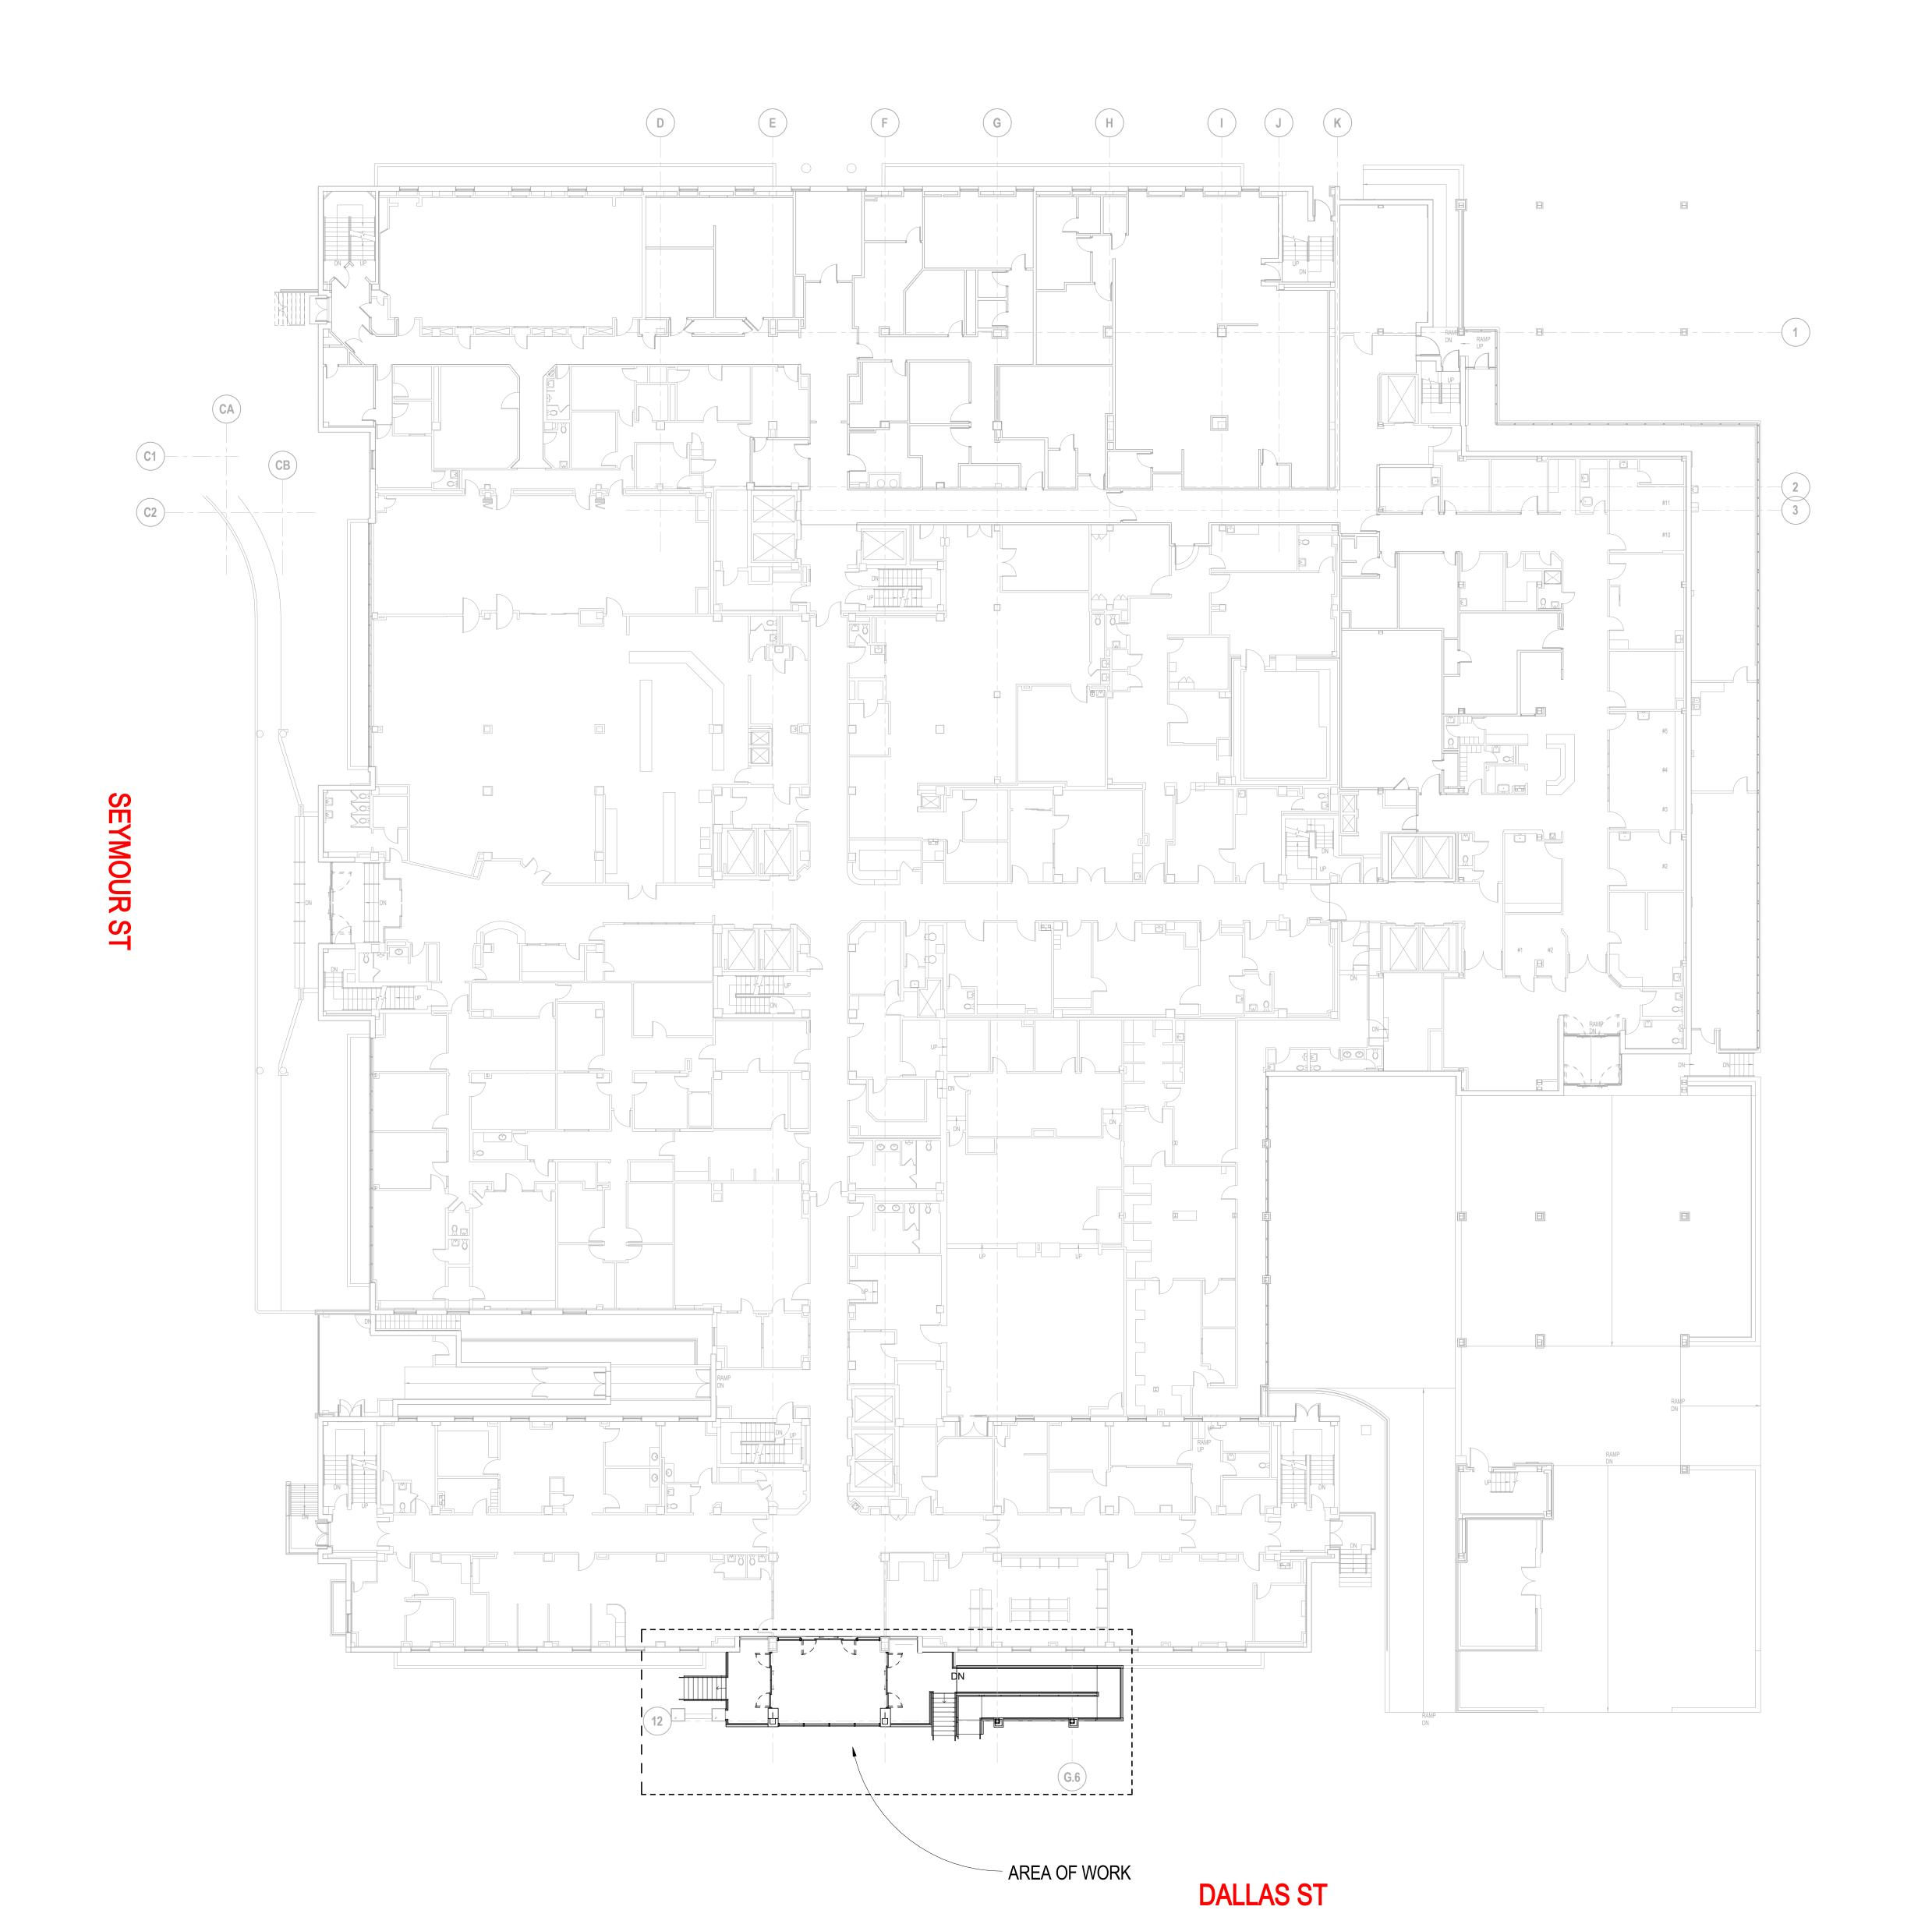

1ST FLOOR PLAN - OVERALL

SCALE: 1/16" = 1'-0"

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richard I. miller, architect
1033 Demonbreun Street
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DOCUMENT CHANGES

Description

Original Issue Date

Original Issue Date

O9/20/17

Project No

Drawn By

JF Checked By

Drawing Title

FIRST FLOOR
ORIENTATION PLAN DALLAS STREET
ENTRANCE

Sheet Number

A1.01-EX

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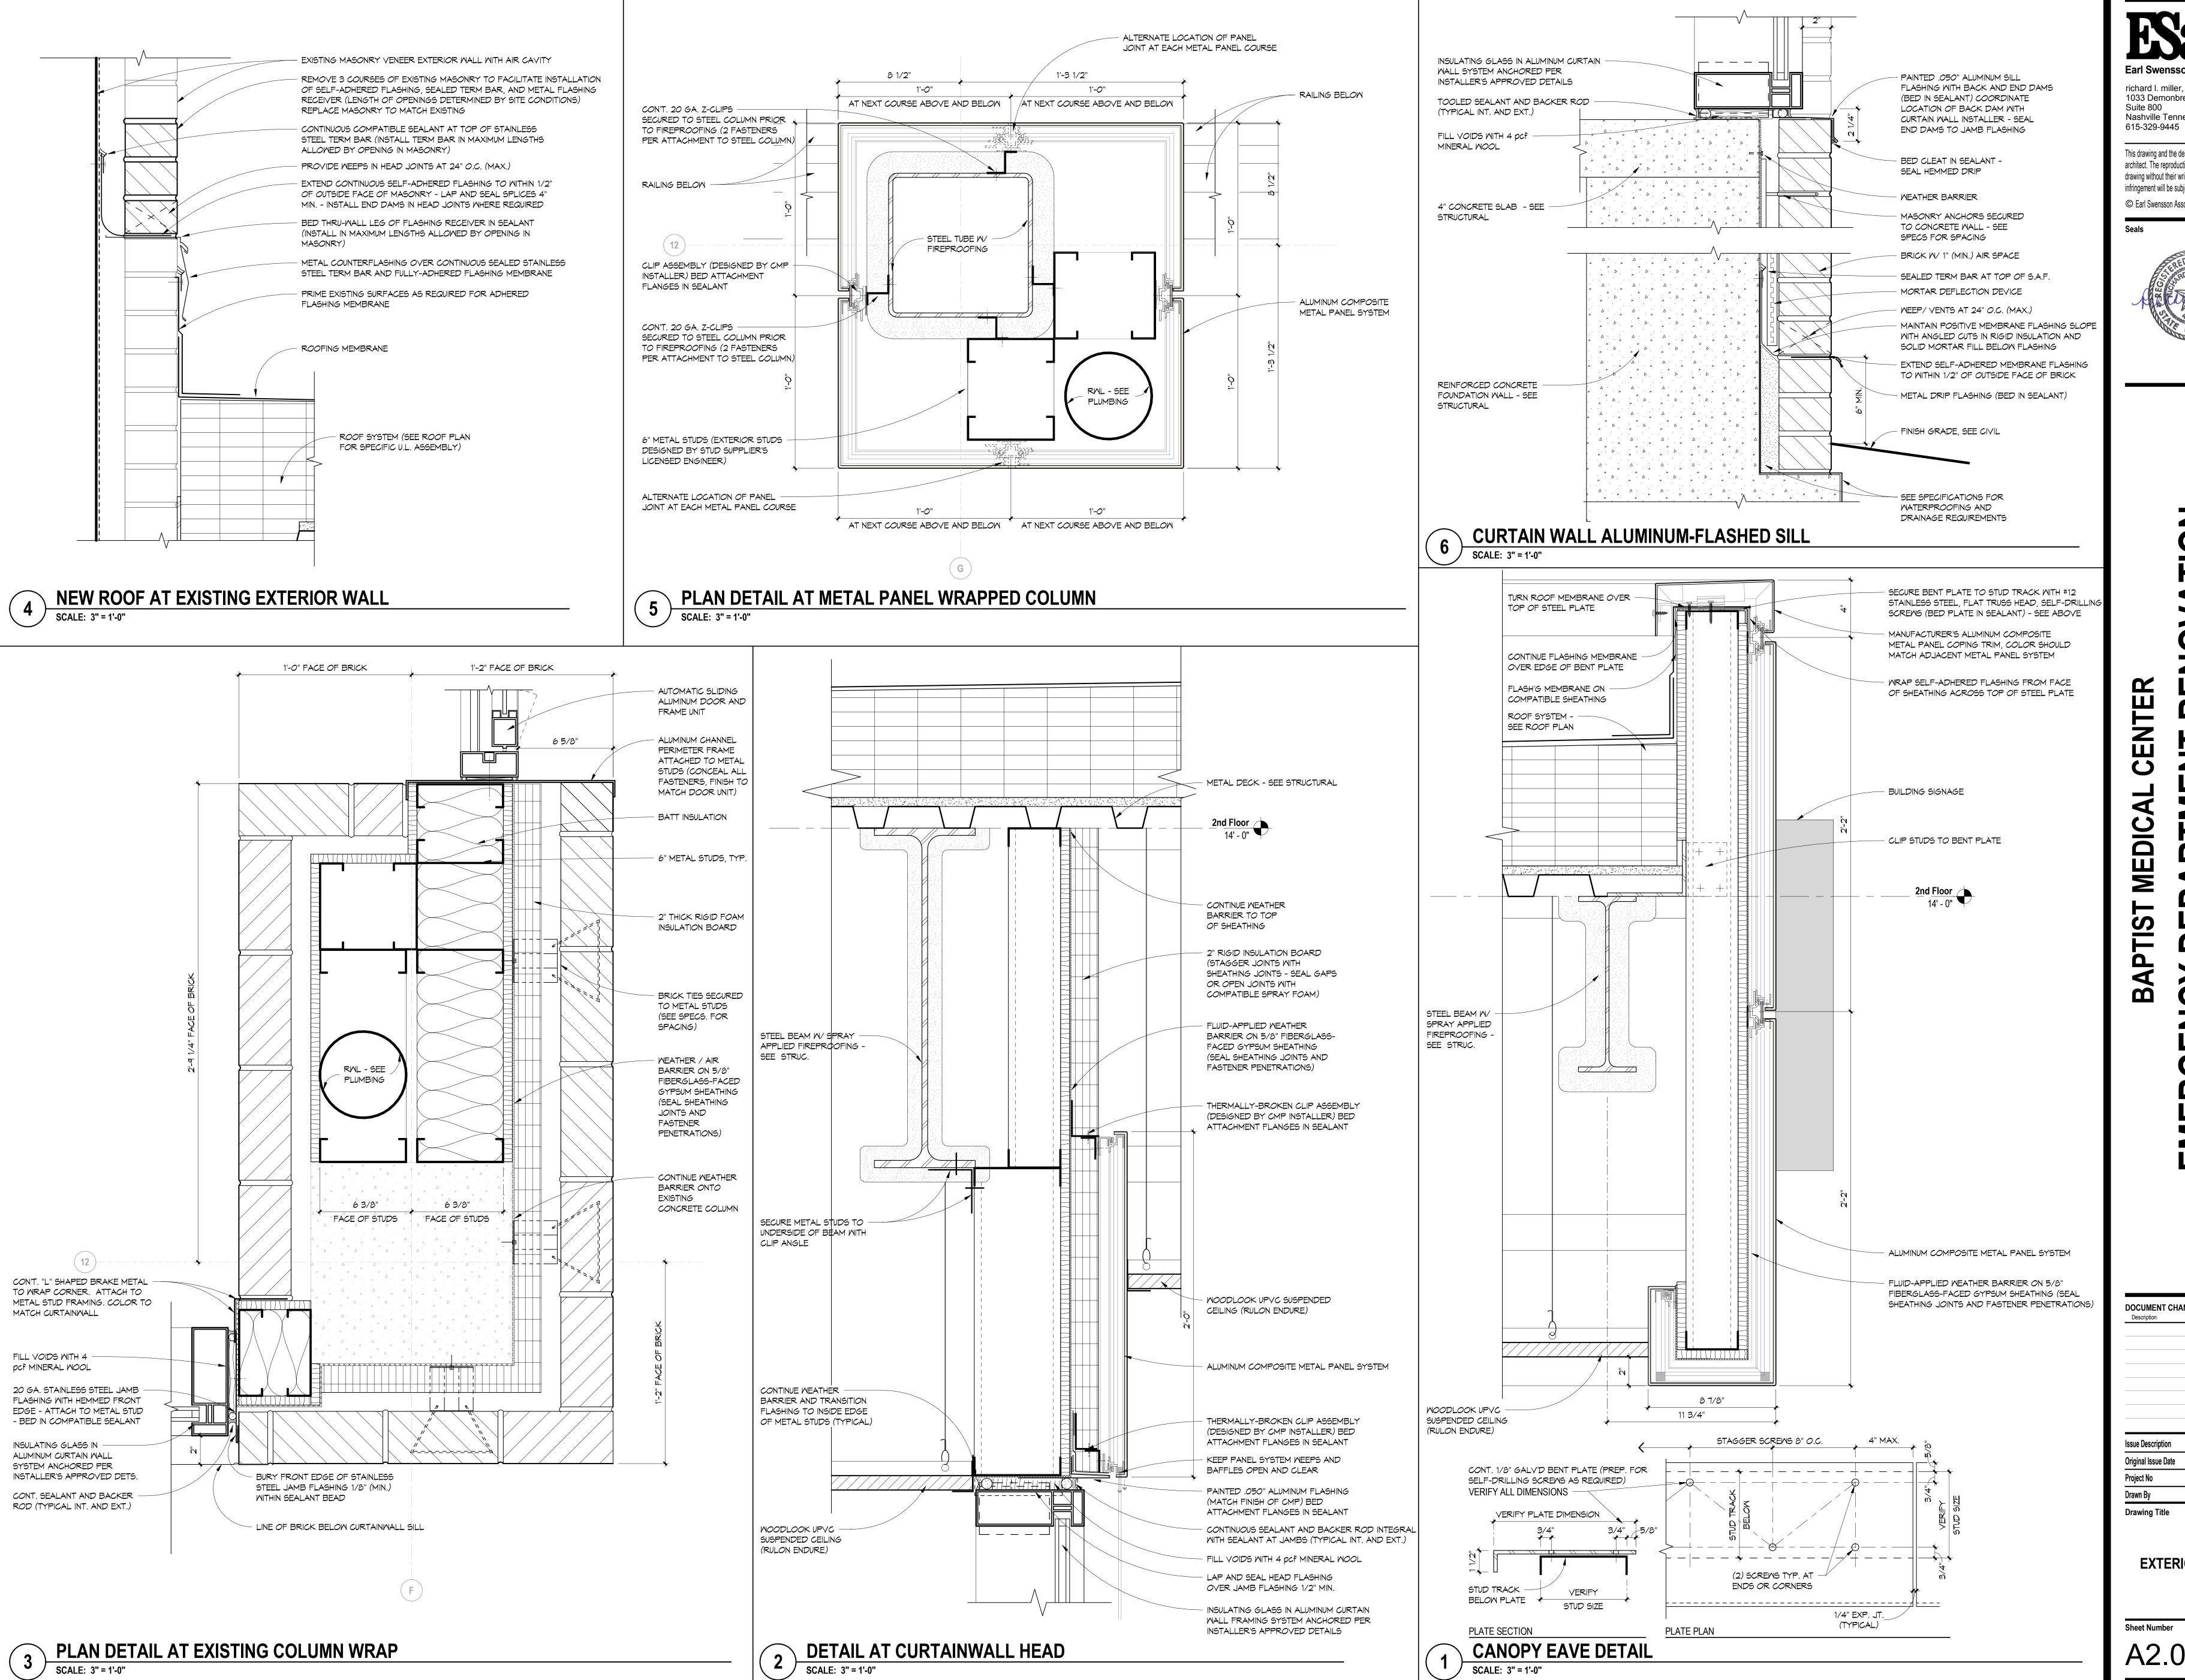
EXTERIOR ELEVATIONS, **SECTIONS &** STANDARD DETAILS

Sheet Number A2.01

EXTERIOR RAMP GUARDRAIL

SEE PDS AMERICA DRAWINGS FOR ADDITIONAL INFORMATION

SCALE: 1 1/2" = 1'-0"



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EXTERIOR DETAILS

A2.02

1-300 DALLAS ST. ENTRY VESTIBULE

AT DOOR 1-300B (OPH)

AT DOOR 1-300C

1-300 DALLAS ST. ENTRY VESTIBULE

AT DOOR 1-300A

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DOOR AND WINDOW DETAILS

A2.03


TRACKLESS - MOTION SENSOR ACTUATED


AUTOMATIC SLIDING DOOR THRESHOLD

SCALE: 6" = 1'-0"

JOHN W. KRAUSS

9/20/2017

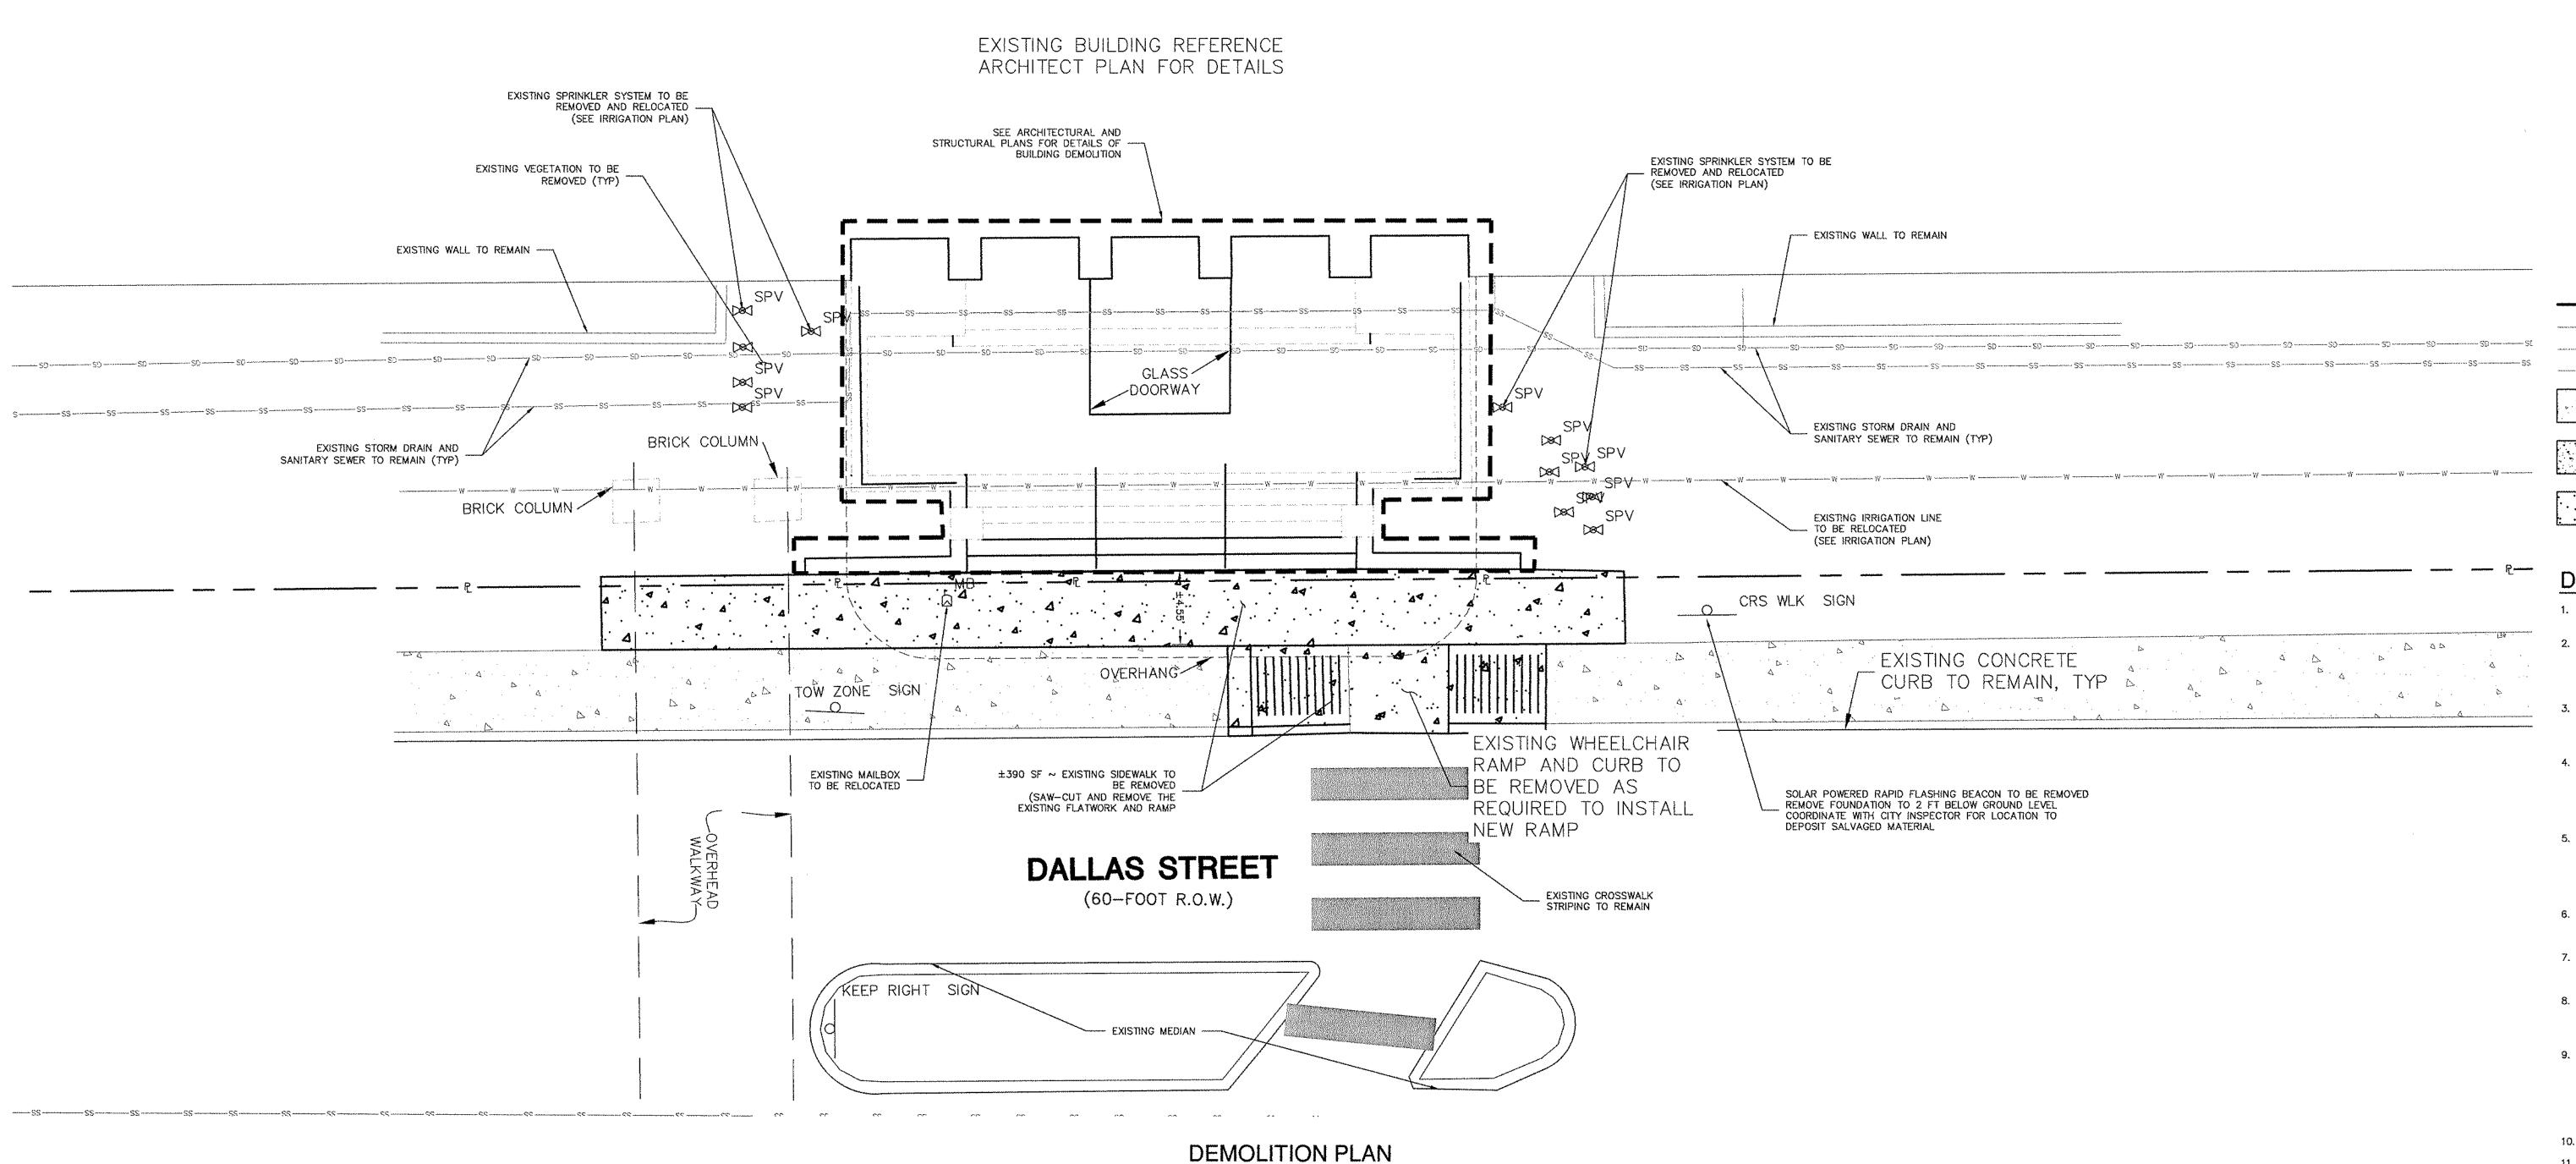

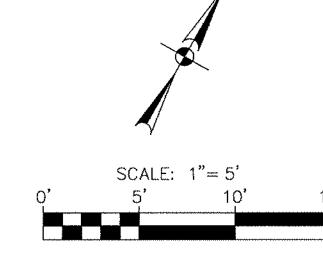

LEGEND

PROPERTY LINE

EXISTING WATER LINE

EXISTING SANITARY SEWER

EXISTING STORM SEWER

EXISTING SIDEWALK

PROPOSED SIDEWALK

SIDEWALK TO BE DEMOLISHED

DEMOLITION NOTES:

- THE CONTRACTOR SHALL BE RESPONSIBLE FOR ACQUIRING ALL NECESSARY PERMITS/APPROVALS BEFORE BEGINNING DEMOLITION.
 THE CONTRACTOR SHALL BE RESPONSIBLE FOR REMOVING FROM THE SITE ALL ITEMS SHOWN TO BE DEMOLISHED UNLESS OTHERWISE INDICATED. ALL MATERIALS SHALL BE DEMOLISHED AND REMOVED FROM SITE IN ACCORDANCE WITH ALL APPLICABLE, FEDERAL, STATE AND LOCAL REGULATIONS.
- 3. ALL EXISTING ITEMS NOT SPECIFICALLY NOTED TO BE DEMOLISHED SHALL REMAIN. CONTRACTOR IS RESPONSIBLE FOR REPLACING EXISTING ITEMS REMOVED DURING DEMOLITION THAT WERE TO REMAIN.
- 4. CONTRACTOR IS RESPONSIBLE FOR COORDINATION WITH ALL UTILITY COMPANIES REGARDING REMOVAL OF EXISTING SERVICES, POWER POLES TO BE REMOVED, VERIFYING UTILITIES ARE SHUT OFF OR DISCONNECTED, AND THAT ALL POSSIBLE SAFETY PRECAUTIONS HAVE BEEN ENACTED TO ENSURE THE SAFEST ENVIRONMENT FOR ALL PERSONNEL.
- 5. LOCATION AND DEPTH OF EXISTING UTILITIES SHOWN HEREON ARE APPROXIMATE ONLY. ACTUAL LOCATIONS AND DEPTHS MUST BE VERIFIED BY THE CONTRACTOR PRIOR TO THE CONSTRUCTION AND THE CONTRACTOR SHALL BE RESPONSIBLE FOR THE PROTECTION OF ALL UTILITIES, WHETHER SHOWN ON THE PLANS OR NOT, THROUGHOUT ALL PHASES OF CONSTRUCTION.
- ALL NECESSARY EROSION CONTROL MEASURES ARE TO BE IN PLACE PRIOR TO CONSTRUCTION. EROSION CONTROL MEASURES ARE TO BE MAINTAINED AND IN WORKING CONDITION AT ALL TIMES.
 THE CONTRACTOR SHALL SAW CUT EXISTING PAVEMENT, CURBS AND SIDEWALKS AT NEW PAVEMENT, CURB AND SIDEWALK JUNCTURES, NO JAGGED OR IRREGULAR CUTS WILL BE ACCEPTED.
- 8. THE CONTRACTOR SHALL PROTECT ALL PROPERTY PINS, BENCH MARKS, CONSTRUCTION STAKES, HUBS, OR OTHER KEY CONTROL POINTS. THE CONTRACTOR SHALL BE RESPONSIBLE TO RE—ESTABLISH ANY SUCH POINTS AT THEIR OWN EXPENSE.
- 9. CONTRACTOR SHALL NOT DEMOLISH ANY PUBLIC WATER OR SANITARY SEWER LINES WITHOUT APPROVAL. EXISTING WATER AND SANITARY SEWER SERVICES SHALL REMAIN OPERATIONAL UNTIL NEW SERVICE IS COMPLETE. CUT AND CAP ANY ABANDONED SANITARY SEWER AND WATER SERVICES AT THE EXISTING MAIN. NO ABANDONED SERVICES SHALL REMAIN CONNECTED TO THE PUBLIC MAIN.
- 10. THE USE OF EXPLOSIVES WILL NOT BE PERMITTED.
- 11. THE CONTRACTOR SHALL BE REQUIRED TO LOCATE ALL PUBLIC OR PRIVATE UTILITIES INCLUDING BUT NOT LIMITED TO: WATER, SEWER, TELEPHONE, FIBER OPTIC LINES, SITE LIGHTING ELECTRIC, SECONDARY ELECTRIC, PRIMARY ELECTRICAL DUCT BANKS, LANDSCAPE IRRIGATION FACILITIES, AND GAS LINES. ANY UTILITY CONFLICTS THAT ARISE SHOULD BE COMMUNICATED TO THE ENGINEER IMMEDIATELY AND PRIOR TO CONSTRUCTION. THE CONTRACTOR SHALL CONTACT 1-800-DIG-TESS A MINIMUM OF 48 HOURS PRIOR TO THE START OF CONSTRUCTION. ANY DAMAGE TO EXISTING UTILITIES SHALL BE THE SOLE RESPONSIBILITY OF THE CONTRACTOR AND THE REPAIR SHALL BE AT THE CONTRACTORS SOLE EXPENSE WHETHER THE UTILITY IS SHOWN ON THESE PLANS OR NOT.
- 12. THE CONTRACTOR SHALL MAINTAIN THE SITE IN A CLEAN AND ORDERLY MANNER.
- 13. THE CONTRACTOR SHALL MEET ALL LOCAL, STATE, AND FEDERAL REGULATIONS FOR DUST CONTROL. THE CONTRACTOR SHALL BE RESPONSIBLE AT THEIR OWN EXPENSE FOR ANY FUGITIVE DUST ON ADJOINING PROPERTIES.

NOTES:

- 1. THE CONTRACTOR SHALL PROVIDE ALL
 TRAFFIC CONTROL REQUIRED BY THE CITY
 FOR THE CONSTRUCTION OF THIS PROJECT.
 THE CONTRACTOR SHALL PREPARE TRAFFIC
 CONTROL PLANS TO BE SUBMITTED TO THE
- 2. THE CONTRACTOR SHALL OBTAIN RIGHT-OF-WAY PERMITS AND SIDEWALK PERMITS AS REQUIRED FOR THE CONSTRUCTION.



SAN ANTONIO I AUSTIN I HOUSTON I FORT WORTH I DALLAS
2000 NW LOOP 410 I SAN ANTONIO, TX 78213 I 210.375.9000
TBPE FIRM REGISTRATION #470 I TBPLS FIRM REGISTRATION #10028800

Description Date

Issue Description DALLAS ST. ERP

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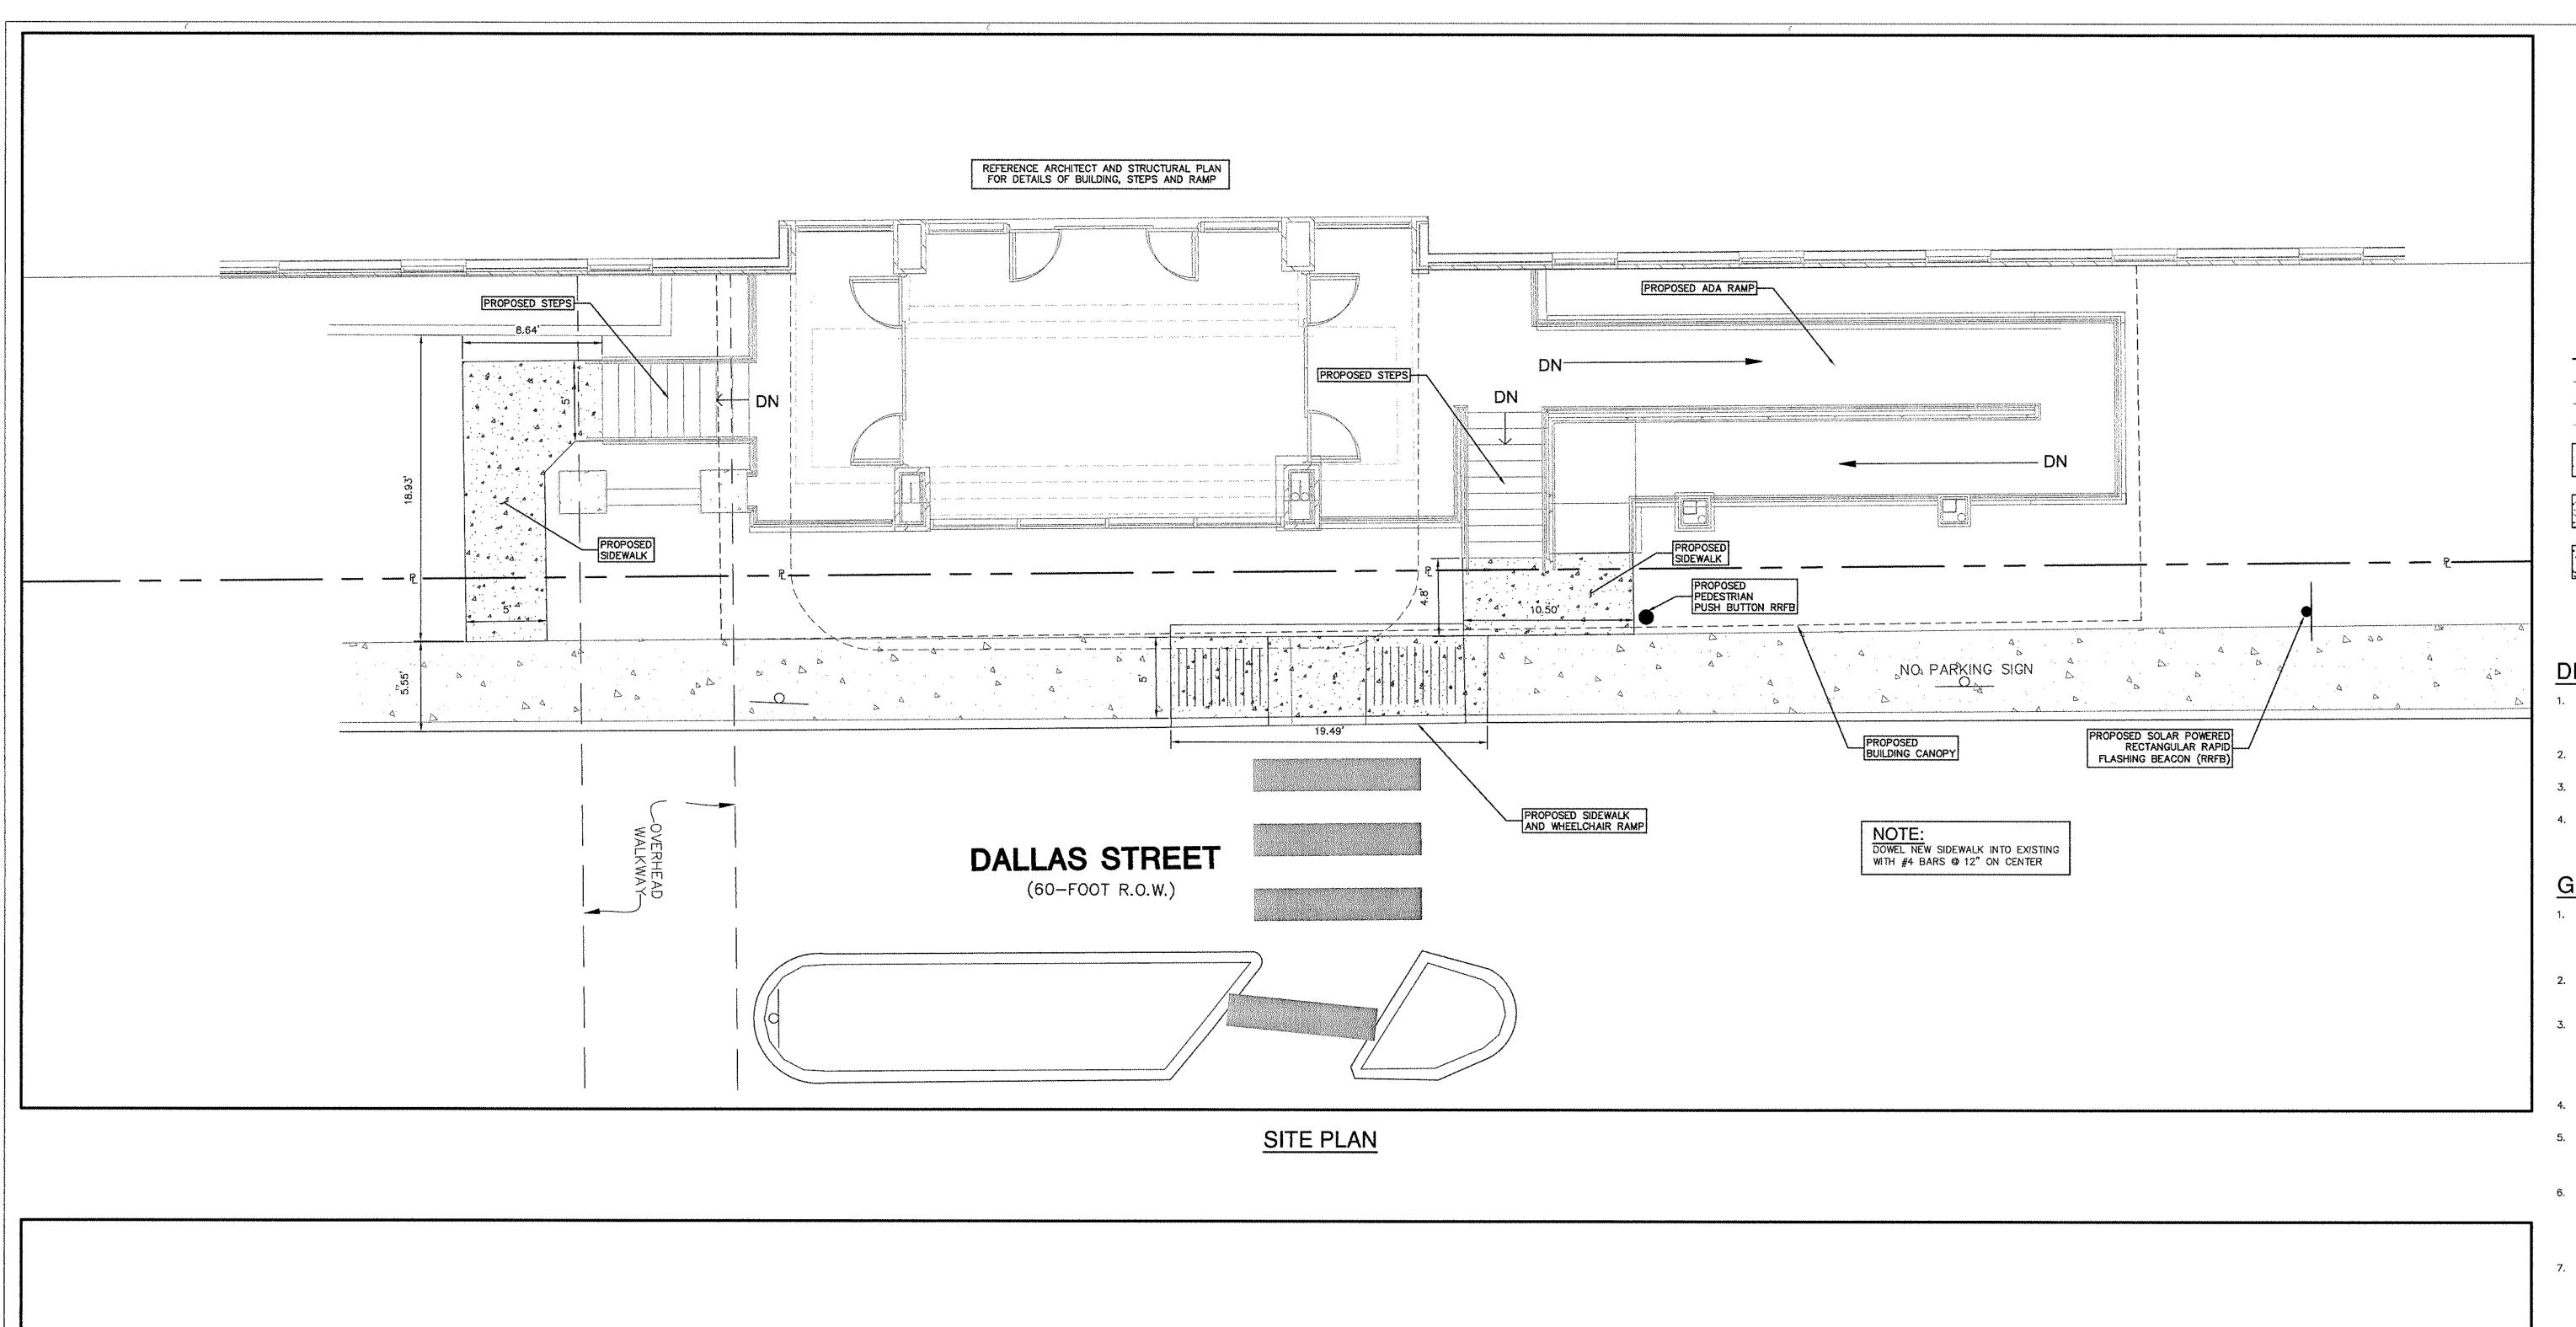
Project No 11404-00


Drawing Title

DEMOLITION PLAN


Sheet Number
C1.0

JOHN W. KRAUSS



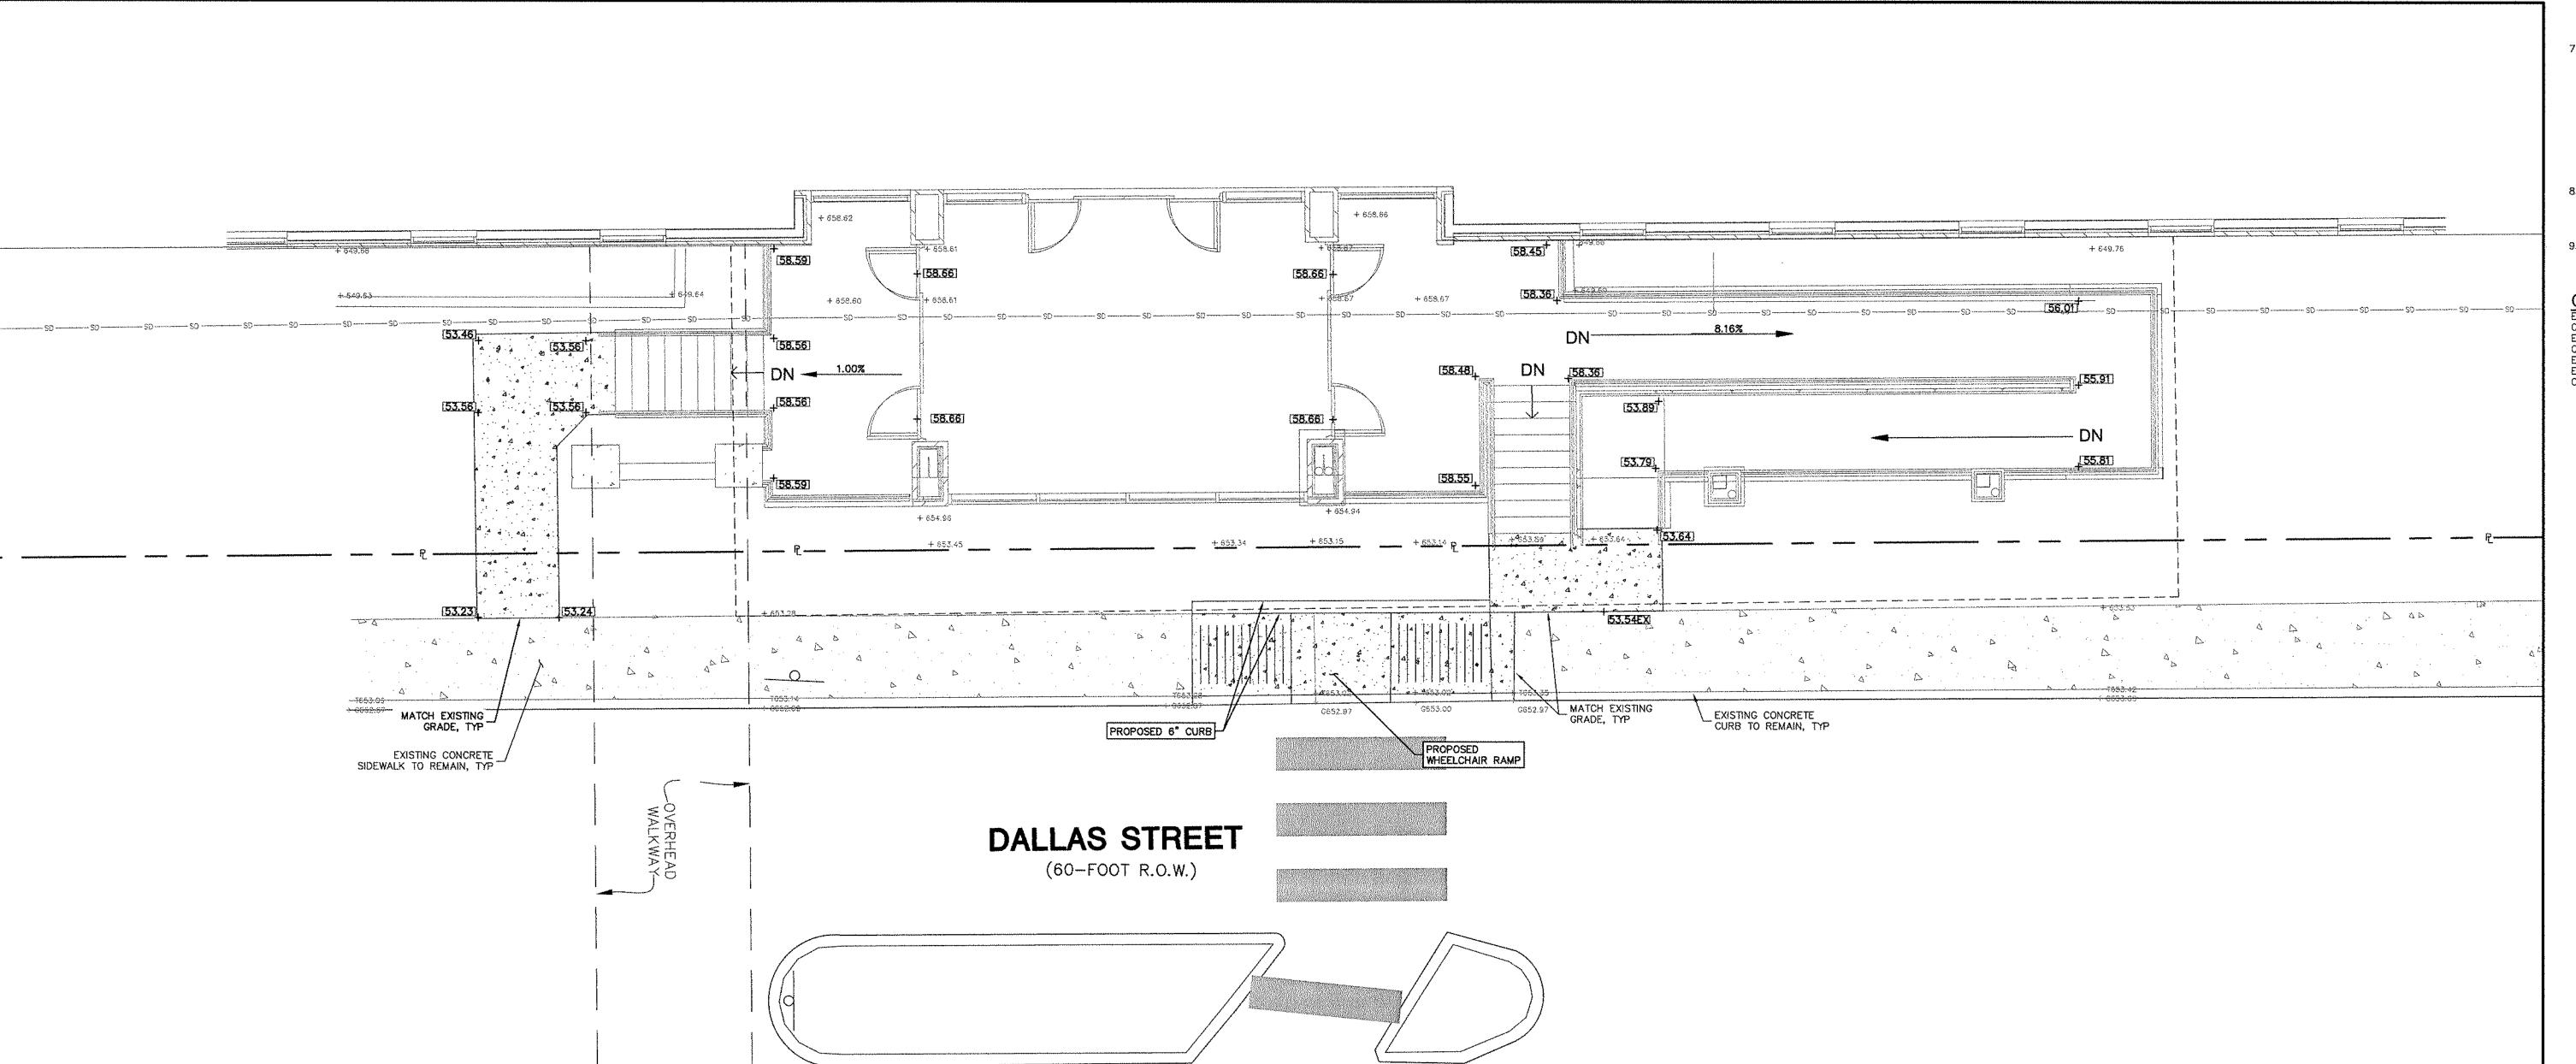

GRADING PLAN

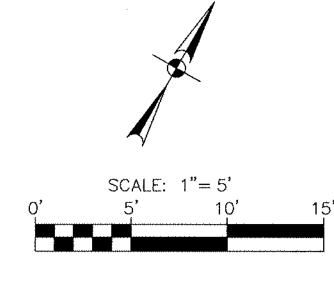

LEGEND

EXISTING WATER LINE EXISTING SANITARY SEWER EXISTING STORM SEWER EXISTING SIDEWALK

PROPOSED SIDEWALK

SIDEWALK TO BE DEMOLISHED

DIMENSIONAL CONTROL NOTES:

THE CONTRACTOR SHALL IMMEDIATELY NOTIFY THE ENGINEER OF ANY QUESTIONS THAT MAY ARISE CONCERNING THE INTENT, PLACEMENT OR LIMITS OF DIMENSIONS NECESSARY FOR CONSTRUCTION OF THE

- THE LAYOUT OF THE NEW BUILDING SHALL BE BASED ON THE ARCHITECTURAL AND STRUCTURAL PLANS.
- 3. THE CONTRACTOR SHALL VERIFY ALL DIMENSIONS PRIOR TO THE START OF CONSTRUCTION AND NOTIFY THE ENGINEER OF ANY DISCREPANCIES. 4. THE CONTRACTOR SHALL BE RESPONSIBLE FOR ESTABLISHING ALL
- HORIZONTAL AND VERTICAL CONTROL PER THE CONSTRUCTION

GRADING NOTES

HIS OWN EXPENSE.

ALL MATERIALS AND CONSTRUCTION PROCEDURES WITHIN THIS SCOPE OF WORK WHERE NOT SPECIFICALLY COVERED IN THE SPECIFICATIONS OR GEOTECHNICAL REPORT SHALL CONFORM TO ALL APPLICABLE CITY, COUNTY AND TXDOT STANDARD SPECIFICATIONS FOR PUBLIC WORKS CONSTRUCTION (LATEST EDITION).

- 2. SITE PREPARATION, GRADING, EXCAVATION AND FILL SHALL BE PERFORMED IN ACCORDANCE WITH THE PROJECT GEOTECHNICAL REPORT AND SPECIFICATIONS.
- 3. THE CONTRACTOR SHALL TAKE ALL NECESSARY PRECAUTIONS (USE OF SILT FENCES, ETC.) TO KEEP DRAINAGE AND SILT FROM WASHING ONTO ADJACENT PROPERTY, STREETS, OR DRAINAGE WAYS. CONTRACTOR SHALL IMMEDIATELY REMOVE SILT/DEBRIS WHICH WASHES OFFSITE OR INTO EXISTING STORM DRAIN SYSTEMS. (SEE SWPPP PLANS & TPDES
- 4. THE CONTRACTOR SHALL PROVIDE A SMOOTH TRANSITION BETWEEN EXISTING SITE AND PROPOSED IMPROVEMENTS.
- 5. THE CONTRACTOR SHALL BE RESPONSIBLE FOR RESTORING TO ITS ORIGINAL, OR BETTER, CONDITION ANY DAMAGE DONE TO EXISTING TREES, BUILDINGS, UTILITIES, FENCES, PAVEMENT, CURBS, OR DRIVEWAYS (NO SEPARATE PAY ITEMS). 6. THE CONTRACTOR SHALL EXERCISE EXTREME CAUTION IN WORKING NEAR UTILITIES, GAS LINES, SEWER, OR EXISTING APPURTENANCES. PRIOR TO PERFORMING ANY EXCAVATION, CONTRACTOR SHALL CONTACT ALL UTILITY COMPANIES AND ASSURE HIMSELF THAT ALL UTILITIES HAVE BEEN ADEQUATELY LOCATED AND IDENTIFIED. THE ENGINEER SHALL BE
- NOTIFIED IF ANY UTILITY CONFLICTS ARE DISCOVERED. 7. UTILITIES SHOWN ON THE PLANS ARE FROM INFORMATION SOURCES AVAILABLE AT THE TIME OF DESIGN BUT MAY NOT REPRESENT ALL EXISTING UTILITIES ON SITE. THE CONTRACTOR WILL BE RESPONSIBLE FOR DETERMINING EXACT LOCATION OF ALL UTILITIES WHETHER SHOWN ON THE PLANS OR NOT. THE CONTRACTOR SHALL UNCOVER EXISTING UTILITIES PRIOR TO CONSTRUCTION AND VERIFY SIZE, GRADE AND LOCATION. THE CONTRACTOR SHALL NOTIFY THE ENGINEER IMMEDIATELY OF ANY DEVIATIONS FROM PLANS PRIOR TO BEGINNING CONSTRUCTION. ANY DAMAGE TO EXISTING UTILITIES, WHETHER SHOWN ON THE PLANS OR NOT, SHALL BE THE CONTRACTORS RESPONSIBILITY TO REPAIR, AT
- 8. POSITIVE DRAINAGE SHALL BE MAINTAINED THROUGHOUT THE SCOPE OF THE PROJECT. DRAINAGE SHALL BE DIRECTED AWAY FROM ALL BUILDING FOUNDATIONS. CONTRACTOR SHOULD TAKE PRECAUTIONS NOT TO ALLOW ANY PONDING OF WATER.
- 9. NO WORK SHALL BE PERFORMED IN A PUBLIC RIGHT-OF-WAY WITHOUT

EXISTING UTILITIES ARE LOCATED WITHIN THE LIMITS OF THE CONSTRUCTION OF THIS PROJECT. THE CONTRACTOR SHALL EXERCISE EXTRA CARE IN DIGGING ANY TRENCH FOR PROPOSED UTILITIES. THE CONTRACTOR SHALL BE RESPONSIBLE FOR COORDINATING, VERIFYING THE EXACT LOCATION AND IDENTIFYING ANY AREAS OF CONFLICTS WITH EXISTING UTILITIES AND WILL NOTIFY THE ENGINEER IMMEDIATELY IF CONFLICTS ARE FOUND.

PAPE-DAWSON ENGINEERS

2000 NW LOOP 410 | SAN ANTONIO, TX 78213 | 210.375.9800 TBPE FIRM REGISTRATION #470 1 TBPLS FIRM REGISTRATION #10028800

DALLAS ST. ERF Issue Description 09/20/17 Original Issue Date MC | Checked By JK Drawing Title

DOCUMENT CHANGES

SITE PLAN **GRADING PLAN**

C1.1

USE DETAIL TY A FOR INSTALLATION OF NEW POLE.

JOHN W. KRAUSS 52852 9/20/2017

DOCUMENT CHANGES DALLAS ST. ERP Issue Description 09/20/17 Original Issue Date 11404-00 MC Checked By JK **Drawing Title**

UTILITY PLAN

Sheet Number


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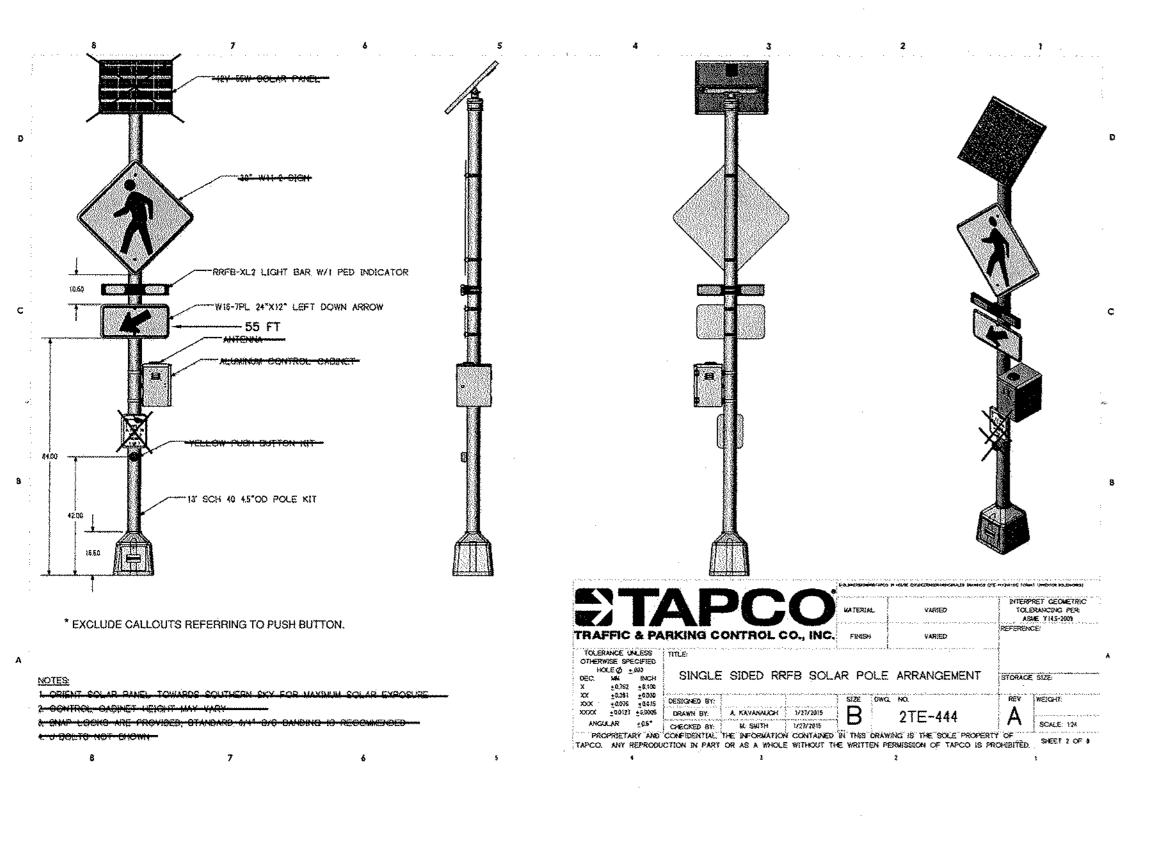
TBPE FIRM REGISTRATION #470 | TBPLS FIRM REGISTRATION #10028800



JOHN W. KRAUSS

9/20/2017



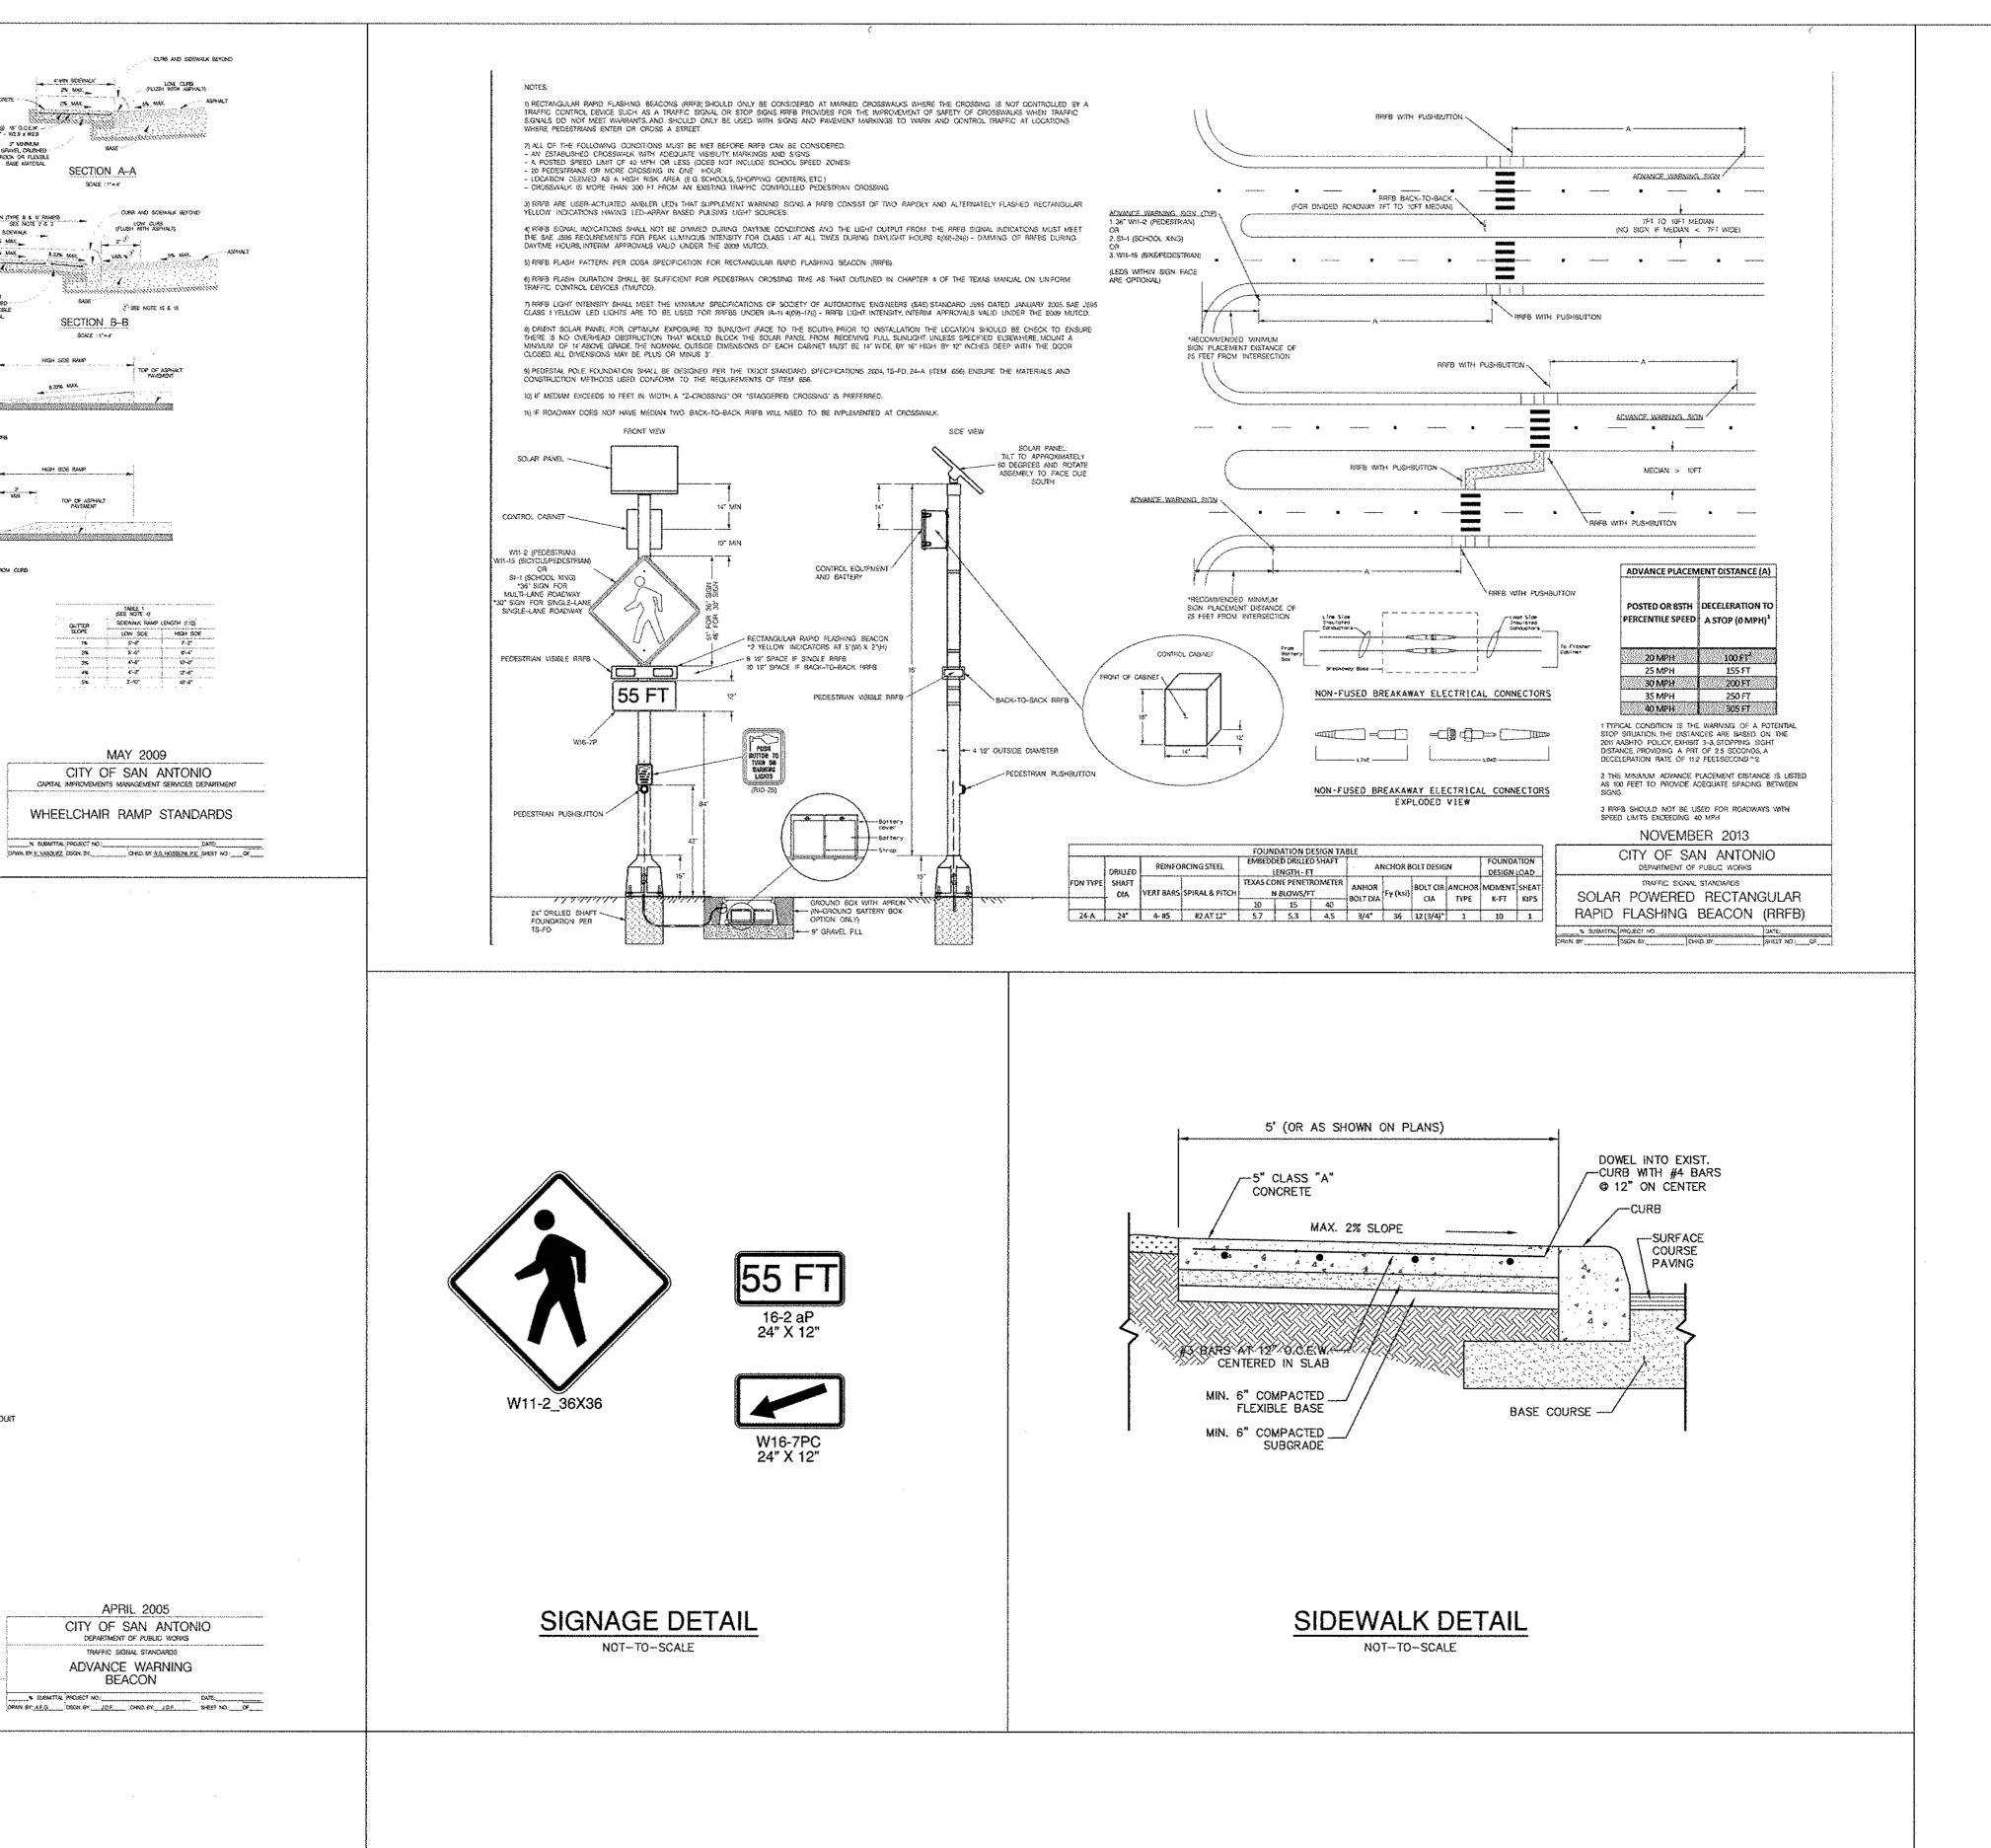

EN MAX

BASE SECTION A-A

SCALE : 17 = 47

SECTION B-B

TOP OF ASPHALT PAYEMENT

61 648 @ 6.00EM ~ ...

....

#3 6483 @ 3" O.C.EW. ... OR 6" 1 € - 4028 x 4029

5 DEN LANCONS

SECTION C-C

CUTS MOFILE WHOTE SCEWALK ABUTS CUTS
SCHIE : ("+4"

LOW SOE RAMP 5 IXIN LANDING HIGH SIDE RAMP

CLAB PROPLE WHERE SIDEWALK IS SEPARATED FROM CLAB SCALE : F = 4

SOLAR PANEL & BRACKET

2º CONDUIT

SIDEWALK FAMO

z man detectable Warning, see note s

2

BEODANNG OF OURS RETURN

TYPICAL SIDEWALK RAMP - TYPE I THE TYPE

SOEWALK 5' SDEWALK

TYPICAL SIDEWALK RAMP - TYPE II

USED AT THE INTERSECTIONS WHERE SOSWALK ABUTS OUTS

GENERAL NOTES

2 FOR LOCAL TIPE "A" STREETS, SDEWLAS SHALL HAVE A MARALAN LINGSSTRUCTED MIDTH OF K"AND IS SEPARATED PROM THE CUPELTHE SOCKWAR SHALL SE LOCATED A MARALAN OF 2 FROM THE BACK OF CUPE.

3. FOR OTHER THAN LOCAL TYPE "A" STREETS, SORWALKS SHALL HAVE A ANABLIAL KNOBSTRACTED WOTH OF FAND SEPARATED A MARKAN OF 2 FROM THE BACK OF CURB OR AS AN OFFICIAL THE SUBMARK SHALL HAVE A ANABAN WOTH OF 6 WHICH LOCATED AT THE BACK OF CURB.

4. SDEWALK RAWP LENGTHS PRESENTED IN TABLE LAPE CLIDELINES ONLY, SDEWALK HAMP LENGTHS SHALL BE OF SUPPORM LENGTH TO MANTARY 800H (178) MANDARY \$0.0PE.

6. DETECTABLE VARIONOS SHALL COMMAST VISIZULY WITH ADJOINING SURVACES, ETHER USET-ON-CHAK OR CURK-CO-USENT THE MAISTEN, USED TO PROVIDE CONTRAST SHALL BE AN INTEGRAL PART OF THE WALVING SURFACE.

4. THESE DETAILS ARE FOR REFERENCE DNLY, ACTUAL, LOCADONS OF WHEELCHAR RAMPS TO BE SHOWN ON CONSTRUCTION PLANS. CITY CONSTRUCTION INSPECTOR CAN AQUIET LOCATIONS FOR SAFETY OR MINERY DEBBASES.

10. SIDEWALKS LESS THAN IS FREET WE WROTH SPALL BE PROVIDED WITH A PASSING SPACE AT A MADIMUM SPACES OF BOD FREET.

II. WARTICHAR RAMP SAKL SE CONSTRUCTED WITH 4" CLASS "A" CONCRETE AND 2" MADIAUM GRAVEL. CRUSHED ROCK ON FLEXICE SASS MATURAL.

TO PREMITORICANG STEER, SHIVLE BE AS BARD AT 18" O C.E.W. OR 10" x 10" - WOOD x WOOD WRIE MIRSH

8. CONSTRUCTION OF ALL WREELCHAR HAWFS TO BE INCLUDED UNDER SHAS '500 - CONCRETE CURB CUTTER, AND CONCRETE CURB AND GUTTER AND FOR '50" -- CONCRETE SUBWRUST, RAWP SURFACE SHALL SE BRUSH

12. SOCIANIA GRADES CHAIL NOT EXCEED THE GRACE ESTABLISHED FOR THE ADJACENT ROLFSAN, ANY SOCIANIA CONSTRUCTION THAT DEVIATES FROM THE MARIAN GRADE OF THE ROJCHWY TO CREATE A GRACE STEEPER THAN THE DISTRICT ROJCHWAY YOLD ROUSE RAMPS, HANDHALL MIC RESTING PLATFORMS TO BE CONSTRUCTED IN ACCORDANCE WITH ACA AND TAS STANDARDS.

M SCENNIX CROSS GRADE SHALL FREE A MADMARK SLEPFE OF 2%, LANDINGS SHALL HAVE A MADRICIAL SLOPE OF 2% OF MY DESCRIPT.

THE FITHE CHANGE OF GRADE BETWEEN ADJACENT SUPFACES IS GREATER THAN OR EQUAL TO THE A LEVELING STRP. 2 FEET IN LENGTH, SHALL RE PROVIDED TO TRANSITION THE ADJACENT SUBFACES.

TI. ADA COMPLIANCE IN ALTERATIONS INCLUDE CALLY THAT WORK WITHIN THE LEATS, SOURCEARES OR SCOPE OF A PLANNED PROJECT.

2° PVC CONDUIT (2-EA.; USUAL)

BOLT SHANK SHALL PROJECT ABOVE CONCRETE

VERTICAL BARS

24" FOUNDATION

NOTE (1): 3" UNLESS OTHERWISE

DIRECTED BY THE ENGINEER

BUCKNAUK RAMP TYPE V SHALL BE USED ONLY WHERE THERE IS SEMERCANT RESTRUCTION WITHOUTHE PARKMAY TO CONSTRUCT TYPE I ON TYPE II RAMPS.

1. WHEN POSSIBLE SIDEWALKS SHOULD BE PLUCED NEXT TO THE PROPERTY LINE, ALLOWING A MINIMALAN OF 1 FOOT BURFAR ORNANDIN OF THE PARKNIN PROM A STRANGHT LINE IS INDOORMADED TO AND/O TREES ON OTHER DOSTRICATIONS.

SDEMALK ABUTS THE CURS SCALE : 1"=10"

I. MAER SCENAUK RAMPS MUST STAYT AT THE SOCK OF THE 31 MID LANDING THE SDOS OF THE STREET ACCESS LANDING MAY NOT INCOSSISTLY COOLSE AT THE BESONING OF THE CURB RETURN.

7 MAN DETECTABLE -WANTENING, SEE MOTE S.

TYPICAL SIDEWALK RAMP - TYPE III

100 mm 100 mm

TYPICAL SIDEWALK RAMP - TYPE IV LIGED AT THE INTERSECTIONS WHERE SIDEWALK IS SEPARATED FROM CLIRB

LANSING OR RAWP WOTH

DETECTABLE WARNING SURFACE

2 FLAT
WASHERS &
1 LOCK
WASHER PER
ANCHOR BOLT

3/4

C 160

23 VA

DOME SECTION

STREET ACCESS CURB PAVENENT

23\$TMAX 4

PLAN DETAIL

CIRCULAR STEEL
TEMPLATE
(TEMPORARY)

A≖D— h

1 1/2" MIN.

HOOKED ANCHOR

4 - 3 / 4" x 18" ANCHOR BOLTS -- (ASTM A36)

BC=12 3 /4", TOP THREAD=3"

5 /8" x 8"-0" COPPER CLAD GROUND ROD

SOCIALK S SOCIALK CONCRETE
RAW SOCIALK

SECUMENC OF TOTAL

SECRNING OF CLASS RETURN (NY NEW PAC);

2. TOPE V RAWPS MUST HAVE UT MON HADRUS.

TYPICAL SIDEWALK RAMP - TYPE V

LOW SIDE RAMP

والمعاودة والمنافذة والمعاودة والمنافذة والمنافذة والمنافذة والمنافذة والمنافذة والمنافذة والمنافذة

5" NOT TO EXCEED 300" TYPICAL CONCRETE

SIDEWALK PASSING SPACE

ASSEMBLY (12")

4" ALUM, PIPE POST -

SIGN AS SPECIFIED ----

'ASTRO' BRACKET

REINFORCEMENT COLLAR

ALUM STANDARD BASE --

18"x 34" ANCHOR BOLTS --

2" CONDUIT

FLASHER ASSEMBLY - TYPE S

24* FOUNDATION (SEE DETAIL)

THE ORIGINAL OF THE CHANNE WAS SCIEDE AND SEALED BY SOME OF PROBERT PS. HESSA ON 64/8/05 AND IS ON PLE WITH THE THATTE ON ORIGINATION OF THE PLOCING WORSE DEFINITION OF THE PLOCING WORSE DEFINITION OF SAN ANTONIO.



SAN ANTONIO I AUSTIN I HOUSTON I FORT WORTH I DALLAS 2000 NW LOOP 410 | SAN ANTONIO, TX 78213 | 210.375.9000 TBPE FIRM REGISTRATION #470 | TBPLS FIRM REGISTRATION #10028800

DALLAS ST. ERP Issue Description 09/20/17 Original Issue Date 11404-00 Drawn By MC Checked By JK Drawing Title **CIVIL DETAILS**

C1.3

Sheet Number

engineering

214 Centerview Drive, Suite 200

Brentwood, Tennessee 37027

Phone: 615.377.0093 Enfinity Project # 16077

TX Engineering Certificate

of Registration No. F-9801

DERON L. MCINTOSH

'L1E' 'L1W' **G**.6 1ST FLOOR PLAN - DALLAS STREET ENTRANCE - DEMOLITION SCALE: 1/8" = 1'-0"

GENERAL NOTES (THIS SHEET ONLY):

THE ENTIRETY OF CIRCUIT.

- EXISTING CIRCUIT BREAKERS FEEDING EXISTING LIGHTING RECEPTACLES, OR EQUIPMENT, ARE TO BE REUSED WHERE INDICATED ON DRAWINGS. CIRCUITS TO REMAIN ARE TO BE EXTENDED FOR RELOCATED PANELBOARDS. (PROVIDE NEW ACCURATE TYPED DIRECTORIES FOR ALL
- AFFECTED PANELBOARDS.) EXISTING CIRCUIT BREAKERS FEEDING EXISTING LIGHTING, RECEPTACLES OR EQUIPMENT, WHERE ENTIRE CIRCUIT HAS BEEN REMOVED, SHALL BE LABELED "SPARE". REUSE SPARES WHERE NOTED ON DRAWINGS.
- CONTRACTOR SHALL REMOVE ALL ELECTRICAL DEVICES FROM EXISTING WALLS AND CEILINGS BEING REMOVED OR MODIFIED UNDER THIS CONTRACT. ALL EXISTING CONDUIT AND WIRING FEEDING THESE DEVICES SHALL BE REMOVED, TERMINATED OR REUSED ASDESCRIBED
- 1. CONDUIT FEEDING DEVICES FROM SLAB SHALL BE CUT OFF BELOW SLAB AND ABANDONED WITH HOLE IN SLAB BEING PATCHED BACK TO MATCH EXISTING. CONDUIT MAY ALSO BE EXTENDED IF NECESSARY, WITH NEW WIRING PULLED
- CONDUIT FEEDING DEVICES FROM ABOVE DROPPED CEILING SHALL BE DISCONNECTED AND REMOVED BACK TO SOURCE OR RECONNECTED AS DESCRIBED IN NEW CONSTRUCTION NOTES. DAMAGE TO CEILINGS SHALL BE REPLACED OR
- REPAIRED TO MATCH EXISTING. ELECTRICAL CONTRACTOR SHALL MAINTAIN THE INTEGRITY OF ALL EXISTING FEED-THROUGH CIRCUITS. WHERE ELECTRICAL DEVICE HAS BEEN REMOVED FROM MIDPOINT OF CIRCUIT, NEW WIRE SHALL BE PULLED AS REQUIRED.
- ALL EXISTING WALLS, CEILINGS, FLOOR SLABS, ETC., BEING CUT OR DAMAGED UNDER THIS CONTRACT SHALL BE PATCHED BACK TO MATCH EXISTING BY GENERAL CONTRACTOR. ALL EXISTING LIGHTING FIXTURES REMAINING OR BEING RELOCATED SHALL BE TAKEN DOWN

AND CLEANED. BALLASTS, LENSES AND LAMPS ARE TO BE REPLACED AS REQUIRED AND

- RELOCATED WHERE SHOWN ON LIGHTING PLANS. ALL EXISTING LIGHTING FIXTURES, RECEPTACLES, SPEAKER CONTROL EQUIPMENT, SWITCHES, PAGING EQUIPMENT, FIRE ALARM EQUIPMENT, ETC., BEING REMOVED AND NOT BEING RELOCATED. SHALL BE OFFERED TO OWNER OR DISPOSED OF AS DIRECTED. (SEE SPECIFIC NOTES ON DEMOLITION SHEET REGARDING LIGHTING FIXTURES).
- ELECTRICAL CONTRACTOR SHALL MAINTAIN THE INTEGRITY OF ALL CIRCUITS TO REMAIN. EXISTING DEVICES TO REMAIN ARE SHOWN DASHED. EXISTING DEVICES OR AREAS RECEIVING DEMOLITION TO BE REMOVED ARE SHOWN HASHED THROUGH ON DEMOLITION SHEETS. ALL ELECTRICAL INFORMATION SHOWN IS FROM EXISTING DRAWINGS AND IS TO BE USED AS A
- GUIDE FOR EQUIPMENT LOCATIONS. CONTRACTOR SHALL VISIT SITE BEFORE BIDDING AND FIELD VERIFY EXISTING CONDITIONS. ALL ELECTRICAL PANELBOARDS BEING REUSED SHALL BE THOROUGHLY INSPECTED, BREAKER OPERATION CHECKED. ALL TERMINATIONS TIGHTENED, FILLER PANELS PLACED IN
- ALL BLANK BREAKER SPACES, DOOR AND HARDWARE CLEANED AND REPAIRED AS NECESSARY. CONTRACTOR SHALL REMOVE ALL VOICE/DATA, NURSE CALL, SECURITY AND SPEAKER DEVICES FROM EXISTING WALLS AND CEILINGS BEING REMOVED OR MODIFIED UNDER THIS CONTRACT. ALL EXISTING CONDUIT AND WIRING FEEDING THESE DEVICES SHALL BEREMOVED,
- TERMINATED OR REUSED AS DESCRIBED BELOW. ALL EXISTING VOICE DATA OUTLETS, NURSE CALL DEVICES, SPEAKER CONTROL EQUIPMENT, PAGING EQUIPMENT, ETC., BEING REMOVED AND NOT BEING RELOCATED, SHALL BE OFFERED
- TO OWNER OR DISPOSED OF AS DIRECTED. CONTRACTOR SHALL MAINTAIN THE INTEGRITY OF ALL SYSTEMS DEVICES TO REMAIN.

X KEYED NOTES (DEMOLITION ONLY):

- EXISTING KNOX BOX TO BE RELOCATED.
- EXISTING PANEL TO REMAIN
- RETAIN EXISTING AUTO DOOR CIRCUIT FOR CONNECTION OF NEW AUTO DOORS.

		LIG	HTING F	IXTURE	SCHED	ULE	
TYPE	MANUFACTURER	CAT NUMBER	VOLTAGE	LAMPS	INPUT WATTS	MOUNTING	REMARKS
D6		MXG20STR-NC-L3 MXTG2-STRD300-B-SF-L3-35-36	120	LED	26	RECESSED	INTERIOR SQUARE RECESSED CAN WITH BLACK FLANGE
DS	INTENSE	SS4G3DSL4358 / ICS430HZ	UNV	LED	26		EXTERIOR SQUARE RECESSED CAN WITH BLACK FLANGE; WET LOCATION
_	PRISMA ARCHITECTURAL	ALU TECH RO	UNV	LED	11	RECESSED IN RISER	STEP LIGHT; 3000K
	V2 LIGHTING GROUP	C2LU-RN1W-13983520-13983540-M5	UNV	LED	16	SURFACE	DECORATIVE UP/DOWN SCONCE; WET LOCATION; SEE ARCH ELEVATIONS FOR MOUNTING HEIGHT
EX	HE WILLIAMS	FME-HT-LG-XU	UNV	LED	LED	UNV	STANDARD EXIT SIGN - BRUSHED ALUMINUM FACE


EQUIPMENT CONNECTION SCHEDULE NOTES DISC **FEEDER EQUIP. TAG** CIRCUIT LOAD VOLTAGE 208/1 30/2 15(2N) INDOOR UNIT FED FROM OUTDOOR UNIT. INDOOR UNIT FED FROM OUTDOOR UNIT. 208/1 30/2 P1A-33 60/2/3R REMOVE EXISTING 70A/2P BREAKER AND INSTALL 45A/2P BREAKER. MATCH AIC RATING. MOUNT DISC ON UNISTRUT. 6.45 kVA 208/1 CU-1

EQUIPMENT CONNECTION NOTES:

[1] SERVICE DISCONNECT SWITCHES SHALL BE MOUNTED AND SUPPORTED INDEPENDENTLY [2] REFER TO MECHANICAL AND PLUMBING DRAWINGS FOR FINAL EQUIPMENT LOCATIONS

[1] PRIOR TO ORDERING OR ROUGH-IN, VERIFY ALL NECESSARY CLEARANCES FOR FIXTURES HOUSING.

[2] VERIFY PAINT AND/OR PLATED FINISHES WITH ARCHITECT AND OWNER PRIOR TO ORDERING. [3] SEE LIGHTING PLAN(S) FOR PROPER ROTATION OF FIELD-ROTATABLE OPTICS.

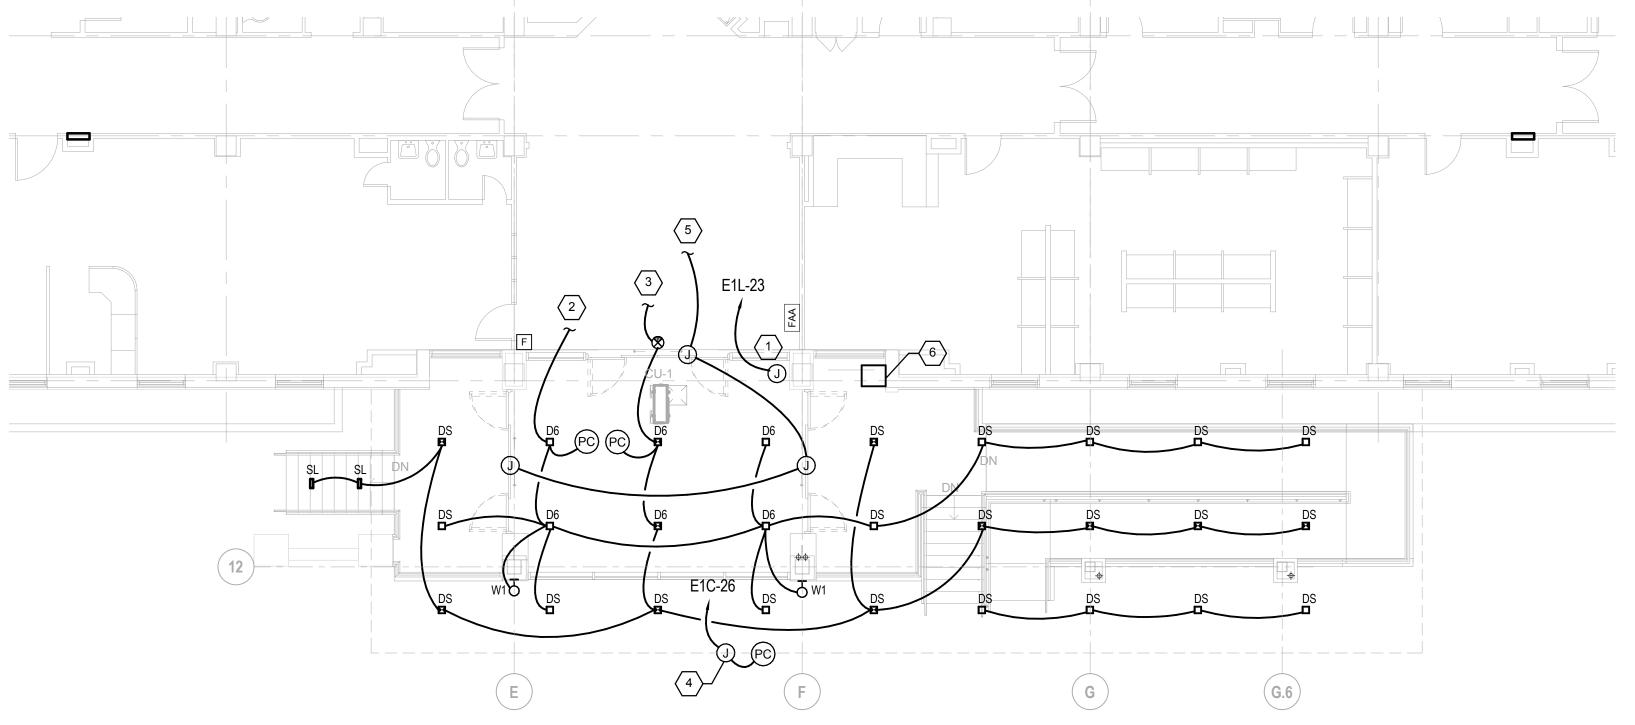



FURNISHED AND OR INSTALLED. VERIFY CEILING COMPATIBILITY.

GENERAL NOTES (THIS SHEET ONLY):

INSTALL NEW 20A/1P BREAKER IN EXISTING LIFE SAFETY BRANCH PANEL 'E1L' CKT 2 (CURRENTLY A SPACE). PROVIDE 120V CONNECTION TO DRY PIPE SYSTEM. COORDINATE LOCATION WITH PLUMBING SHEETS.


FOR EXACT FIXTURE PLACEMENT, REVIEW AND COORDINATE WITH HOSPITAL STAFF AND

REFERENCE INSTALLER DRAWINGS AND PROVIDE ALL ITEMS NOTED THEREIN AS CONTRACTOR

CONNECT TO NEAREST EXISTING NORMAL BRANCH LIGHTING CIRCUIT.

ORIENT ALL PHOTOCELLS DUE NORTH. MOUNT ABOVE CANOPY.

- CONNECT TO NEAREST EXISTING LIFE SAFETY BRANCH LIGHTING CIRCUIT.
- PROVIDE 120V CONNECTION TO CANOPY SIGNAGE. COORDINATE REQUIREMENTS WITH LIGHTING SIGNAGE VENDOR. INSTALL NEW 20A/1P BREAKER IN EXISTING SPACE, IN CRITICAL BRANCH PANEL INDICATED.
- CONNECT AUTO DOORS TO EXISTING AUTO DOOR CIRCUIT.
- RELOCATED KNOX BOX.

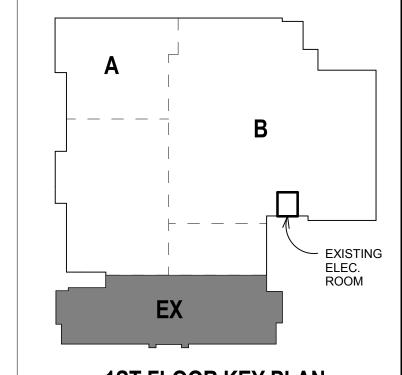

DOCUMENT CHANGES

Issue Description

Original Issue Date

DALLAS ST. ERP

PNH | Checked By DLM

ELECTRICAL DEMO

AND NEW WORK

PLANS - DALLAS

STREET ENTRANCE

09/20/17

16072.00

E1.01A-EX 1ST FLOOR KEY PLAN




1ST FLOOR PLAN - DALLAS STREET ENTRANCE - NEW WORK
SCALE: 1/8" = 1'-0"


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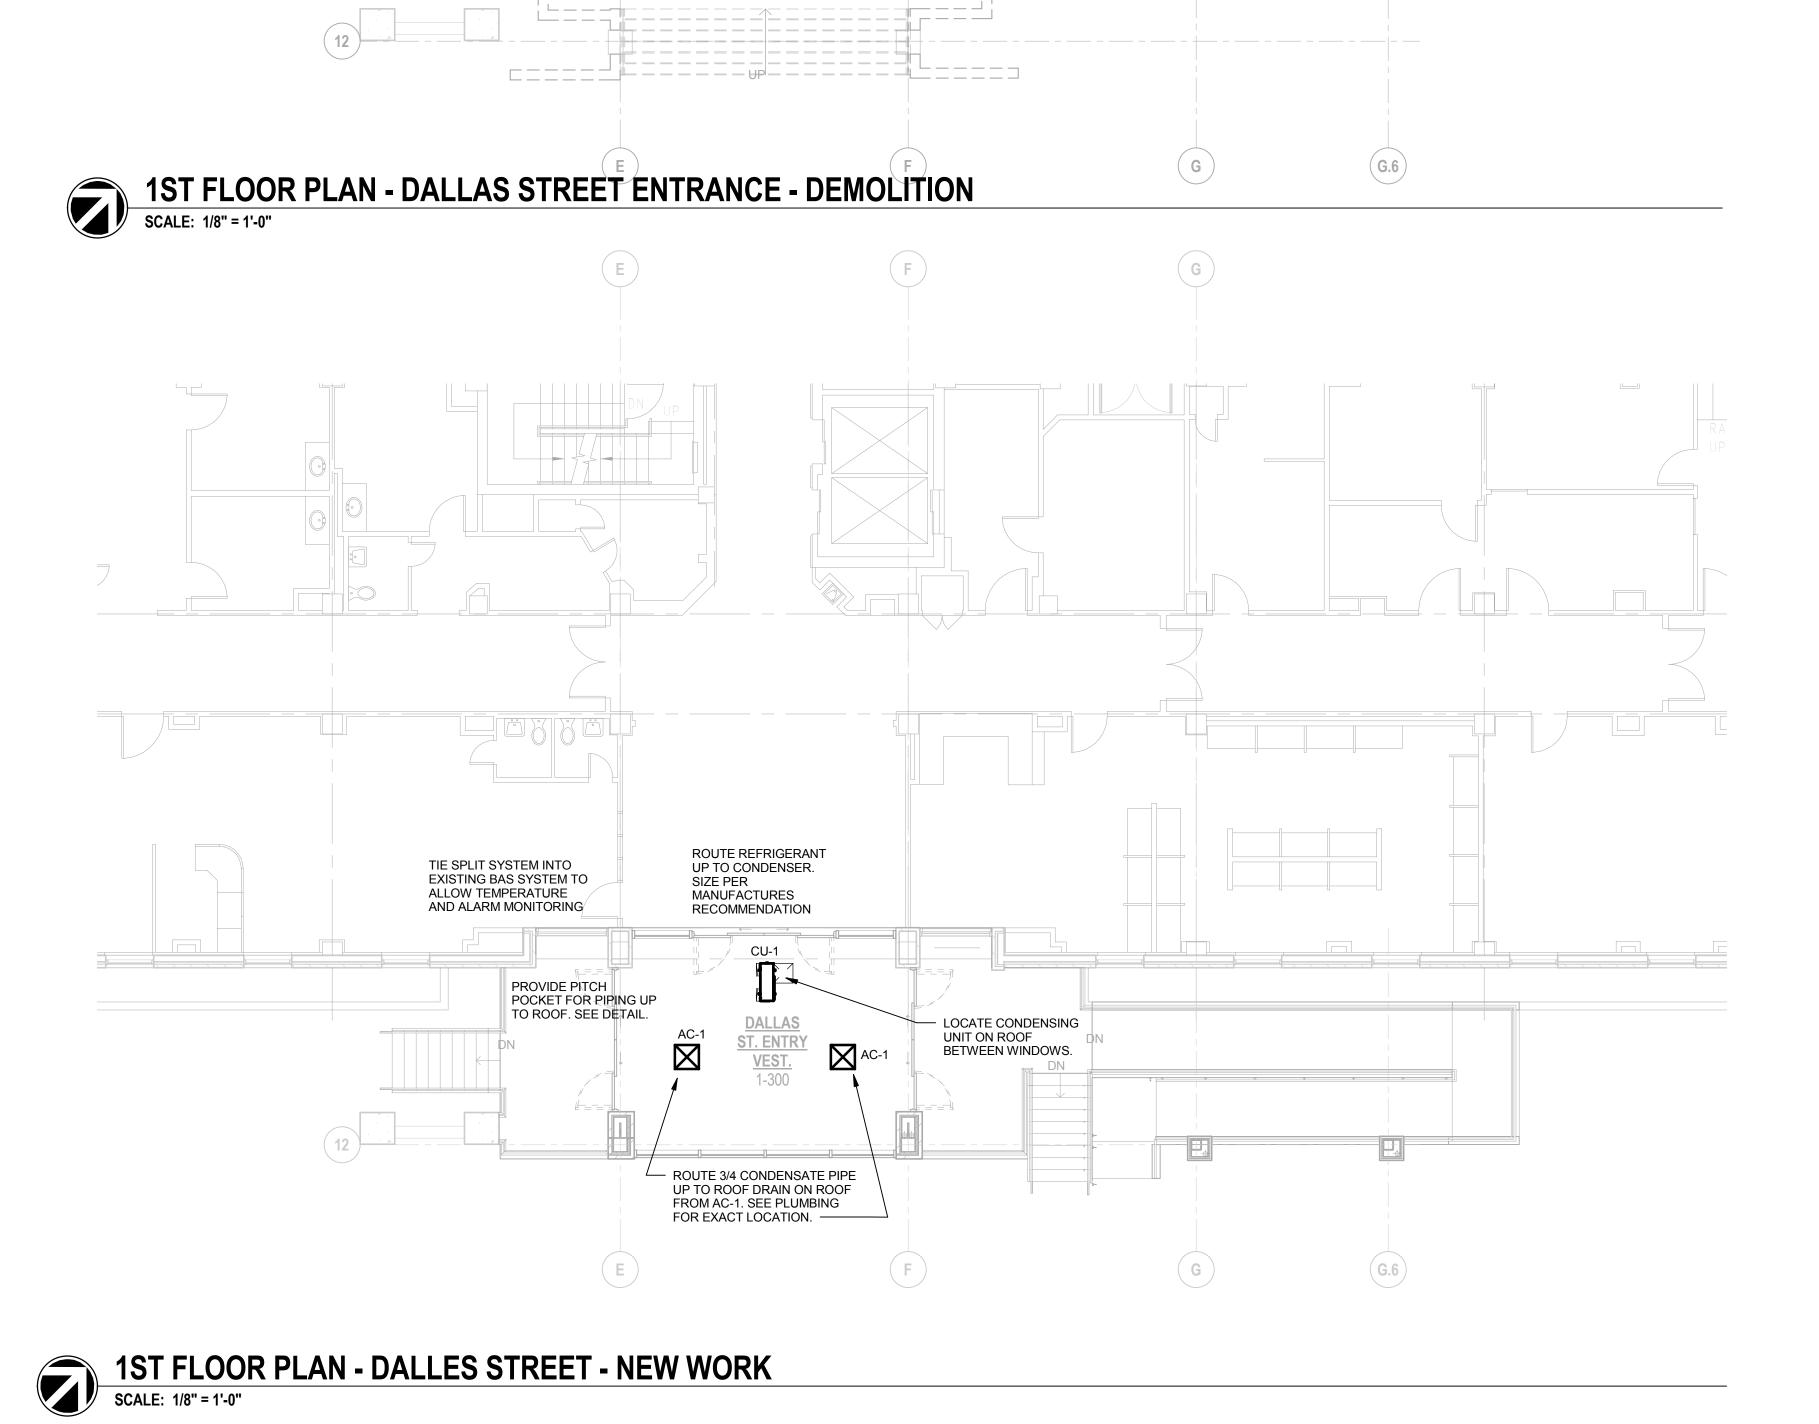
CityPark Building 6 214 Centerview Drive, Suite 200 Brentwood, Tennessee 37027

> Phone: 615.377.0093 Enfinity Project # 16077


TX Engineering Certificate of Registration No. F-9801



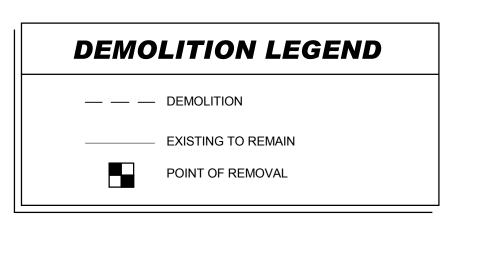

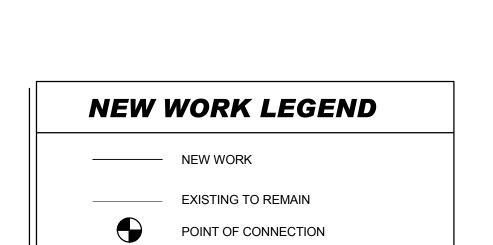

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DOCUMENT CHANGES

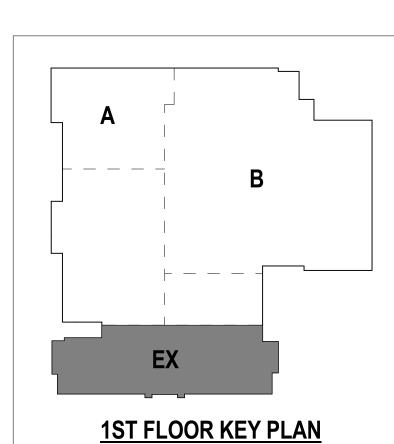Description

Date

Issue Description

Original Issue Date

Original Issue Date

Op/20/17

Project No

Drawn By

JF

Checked By

HD

Drawing Title

MECHANICAL

DEMOLITION AND

NEW WORK PLANS -

DALLAS STREET ENTRANCE

EMERGENC

M1.01A-EX

DALLAS ST. ERP 09/20/17 16072.00

NOTES AND SCHEDULES -**DALLAS STREET ENTRANCE**

P2.01-EX

CityPark Building 6 214 Centerview Drive, Suite 200 Brentwood, Tennessee 37027 Phone: 615.377.0093

Enfinity Project # 16077



DOCUMENT CHANGES

Issue Description Original Issue Date Project No JGH | Checked By Drawn By

PLUMBING PLANS,

1ST FLOOR KEY PLAN

THE RESPONSIBILITY OF THE CONTRACTOR TO MAKE HIS OWN WORKING LAYOUT TO ELIMINATE ALL STRUCTURAL AND ARCHITECTURAL CONFLICTS IN THE BUILDING

2. VERIFY ALL MEASUREMENTS AT THE SITE AND COORDINATE ALL WORK SO THAT IT DOES NOT INTERFERE WITH THE WORK OF OTHER TRADES. 3. ALL PIPE, FITTINGS, VALVES AND OTHER COMPONENTS OF THE PIPING SYSTEM SHALL BE OF DOMESTIC MANUFACTURE. FOREIGN MANUFACTURED PIPE, FITTINGS, VALVES AND OTHER COMPONENTS SHALL NOT BE PERMITTED IN THE PLUMBING, MEDICAL GAS OR FIRE PROTECTION SYSTEMS.

<u>SUBMITTALS</u>

PLUMBING LEGEND

COLD WATER PIPING

HOT WATER PIPING

VENT PIPING

ROOF DRAIN

FLOOR DRAIN

FLOOR SINK

HUB DRAIN

PIPE CAP

PIPE UP

TEE DN

P-TRAP

PIPE DOWN

BALL VALVE

GATE VALVE

GAS VALVE

CHECK VALVE

UNION IN PIPE

BALANCING VALVE

PRESSURE REDUCING VALVE

POINT OF CONNECTION

POINT OF DISCONNECTION

SERVICE WEIGHT, HUB AND SPIGOT CAST IRON WITH

SERVICE WEIGHT, NO-HUB CAST IRON WITH HEAVY

DUTY NO-HUB COUPLINGS; ASTM C1540, ASTM C 564 SCHEDULE 40 PVC PIPE; ASTM D 2665. (REQUIRES

MAKE AND MODEL

COMPRESSION JOINTS; ASTM A-74.

ZURN Z100-DP

ZURN ZAB199

ZURN Z100-DP-89

OWNER APPROVAL)

STORM WATER (UNDERGROUND)

PLUMBING FIXTURE SCHEDULE

DESCRIPTION

HOT WATER RECIRCULATION PIPING

WASTE PIPING ABOVE FLOOR

WASTE PIPING BELOW FLOOR

SANITARY PIPING ABOVE FLOOR

SANITARY PIPING BELOW FLOOR

STORM OVERFLOW PIPING

OVERFLOW ROOF DRAIN

STORM WATER PIPING ABOVE GRADE

STORM WATER PIPING (BELOW GRADE)

ABBREVIATION

FS

HD

1. SUBMIT FOR REVIEW, A LIST OF MAJOR EQUIPMENT WITHIN 25 DAYS AFTER AWARD OF CONTRACT. 2. SUBMITTALS SHALL INCLUDE BUT NOT BE LIMITED TO THE FOLLOWING: ALL EQUIPMENT AND FIXTURES SHOWN OR INDICATED ON THE HVAC MECHANICAL AND PLUMBING DRAWINGS AND SPECIFICATIONS.

PLUMBING SPECIFICATIONS

SECTION 22 00 00 - GENERAL PLUMBING REQUIREMENTS

1. THE LOCATION OF PIPE, AND EQUIPMENT SHOWN ON THE DRAWINGS ARE DIAGRAMMATIC AND SCHEMATIC AND IT IS THE RESPONSIBILITY OF THE CONTRACTOR TO MAKE HIS OWN WORKING LAYOUT TO ELIMINATE ALL STRUCTURAL AND ARCHITECTURAL CONFLICTS IN THE BUILDING 2. VERIFY ALL MEASUREMENTS AT THE SITE AND COORDINATE ALL WORK SO THAT IT DOES NOT INTERFERE WITH THE WORK OF OTHER TRADES.

3. ALL PIPE, FITTINGS, VALVES AND OTHER COMPONENTS OF THE PIPING SYSTEM SHALL BE OF DOMESTIC MANUFACTURE. FOREIGN MANUFACTURED PIPE, FITTINGS, VALVES AND OTHER COMPONENTS SHALL NOT BE PERMITTED IN THE PLUMBING, MEDICAL GAS OR FIRE PROTECTION SYSTEMS.

<u>SUBMITTALS</u>

1. SUBMIT FOR REVIEW, A LIST OF MAJOR EQUIPMENT WITHIN 25 DAYS AFTER AWARD OF CONTRACT. 2. SUBMITTALS SHALL INCLUDE BUT NOT BE LIMITED TO THE FOLLOWING: ALL EQUIPMENT. FIXTURES. AND MEDICAL GAS PIPING SHOWN OR INDICATED ON THE HVAC MECHANICAL, PLUMBING AND MEDICAL GAS DRAWINGS AND SPECIFICATIONS. 3. SUBMIT MEDICAL GAS INSTALLER QUALIFICATION CERTIFICATES FOR REVIEW.

EXECUTION

1. WORK INCLUDED: THE EXTENT OF THE PLUMBING SCOPE OF THIS PROJECT SHALL INCLUDE THE STORM WATER SYSTEM SYSTEM. 2. THE PROJECT INCLUDE MATERIALS AND INSTALLATION REQUIRED TO COMPLY WITH APPLICABLE FEDERAL, STATE AND LOCAL CODES AND REQUIREMENTS. 3. PROVIDE EXCAVATION AND BACKFILLING FOR PLUMBING, AND MEDICAL GAS WORK. 4. INSTALL COUNTERFLASHING FOR PIPES WHERE THEY PENETRATE ROOFS AND OUTSIDE WALLS WHERE REQUIRED.

5. INSTALL PLUMBING FIXTURES AND EQUIPMENT, WHICH REQUIRE PLUMBING CONNECTIONS INTO PIPING SYSTEMS AS CALLED OUT UNDER SEPARATE DIVISIONS OF THIS SPECIFICATION. 6. WORKMEN SHALL BE EXPERIENCED IN THEIR RESPECTIVE TRADES. THE WORKMANSHIP OF THE INSTALLED WORK SHALL BE FIRST CLASS AND SHALL BE JUDGED BY THE ARCHITECT.

SECTION 22 14 13 - STORM DRAINAGE PIPING

MINIMUM BRANCH SIZES IN INCHES

SIZE INDICATED ON DRAWING

SIZE INDICATED ON DRAWING

SIZE INDICATED ON DRAWING

WASTE VENT

COLD HOT WATER WATER

1. THIS SECTION APPLIES TO ALL WASTE, VENT, AND RAINWATER/STORM WATER PIPING FOR ALL PLUMBING WORK. 2. STANDARDS: ALL PIPE AND FITTINGS SHALL CONFORM TO ANSI AND APPROPRIATE ASTM STANDARDS. 3. PIPING SHOWN ON DRAWINGS SHALL BE INSTALLED COMPLETE AND OF THE SIZE SHOWN ON THE DRAWINGS. PIPE SIZES ARE NORMAL SIZE (INCHES) UNLESS OTHERWISE NOTED. 4. PVC PIPE: SCHEDULE 40 PVC PIPE, ASTM D-1785 TYPE 1, GRADE 1, 200-PSI TEST: UNDERGROUND WASTE AND DRAINAGE LINES 2" AND LARGER. SOLVENT CEMENT JOINTS.

5. CAST IRON PIPE: STANDARD WEIGHT NO HUB SOIL PIPE. SERVICE: DRAIN, WASTE AND VENT PIPING 2" AND LARGER ABOVE OR BELOW GROUND. ABOVE GROUND DWV SYSTEMS SHALL USE STANDARD NO-HUB COUPLINGS. ALL STORM PIPING AND DWV BELOW GROUND SHALL USE HEAVY DUTY NO-HUB COUPLINGS. 6. PIPING SHALL BE ROUTED APPROXIMATELY AS SHOWN ON DRAWINGS, OR AS CONDITIONS WILL PERMIT, AND SHALL BE SO INSTALLED AS NOT TO INTERFERE WITH DOORS AND ACCESS TO EQUIPMENT. ALL PIPING SHALL BE INSTALLED SO AS TO RUN PARALLEL OR PERPENDICULAR TO BUILDING LINES. PIPING SHALL BE INSTALLED TO ALLOW FOR

7. INSTALL ISOLATION VALVES IN EACH PIPE CONNECTION TO EQUIPMENT. 8. PIPE DEPENDENT ON GRAVITY DRAINAGE SHALL BE SLOPED MINIMUM 1/8 INCH PER FOOT OF HORIZONTAL RUN OR AS CALLED FOR ON DRAWINGS. 9. FURNISH AND INSTALL DIELECTRIC COUPLINGS FOR PIPING CONNECTIONS OF DISSIMILAR METALS.

10. PLASTIC AND CAST IRON PIPING AND FITTINGS SHALL NOT BE PRESSURE TESTED WITH COMPRESSED AIR. OBTAIN AND FOLLOW THE MANUFACTURER'S RECOMMENDATIONS FOR TESTING. 11. CLEANOUTS SHALL BE PROVIDED AT THE UPSTREAM END OF ALL HORIZONTAL DRAINAGE PIPING AND AT INTERVALS NOT TO EXCEED 50 FEET. USE WALL CLEANOUTS WHERE POSSIBLE.

PLUMBING SHEET INDEX
CULTET TITLE

SHEET NUMBER	SHEET TITLE
P2.1-EX	PLUMBING PLANS, NOTES AND SCHEDULES - DALLAS STREET ENTRANCE

	LOWDING ADDITE VIA HONS	
SYMBOL	DESCRIPTION	SYMBOL
AFF	ABOVE FINISHED FLOOR	
AFG	ABOVE FINISHED GRADE	
AP	ACCESS PANEL	
AW	ACID WASTE	
AV	ACID VENT	W ————————————————————————————————
AVTR	ACID VENT THRU ROOF	
BFF	BELOW FINISHED FLOOR	s
BFP	BACKFLOW PREVENTER	
СО	CLEANOUT	s
CW	COLD WATER	
DN	DOWN	ST
DI	DEIONIZED	OD
ES	EMERGENCY SHOWER	
ETP	ELECTRONIC TRAP PRIMER	ST
ETR	EXISTING TO REMAIN	© RD
EW	EMERGENCY EYE WASH	
EWH	ELECTRIC WATER HEATER	
F	FIRE	₩ FD
FDC	FIRE DEPARTMENT VALVE CABINET	☐ FS
FE	FIRE EXTINGUISHER	O HD
FEC	FIRE EXTINGUISHER CABINET	
FHC	FIRE HOSE CABINET	
FCO	FLOOR CLEANOUT	
FD	FLOOR DRAIN	<u> </u>
FS	FLOOR SINK	-
G	GAS (NATURAL GAS)	
GCO	GRADE CLEANOUT	
GN	GOOSENECK	
GW	GREASE WASTE	
GWH	GAS WATER HEATER	I ▽ I
HD	HUB DRAIN	
HW	HOT WATER	
HWR	HOT WATER RECIRC	
IE	INVERT ELEVATION	
OD	OVERFLOW ROOF DRAIN	——————————————————————————————————————
P-1, WC-1, ETC.	FIXTURE DESIGNATION	
PG	PROPANE GAS	
PRV	PRESSURE REDUCING VALVE	
RD	ROOF DRAIN	TP
RO	REVERSE OSMOSIS	P-1, WC-1, ETC
RPZ	REDUCED PRESSURE ZONE BACKFLOW PREVENTER	
S	SANITARY OR SOIL	
ST	STORM DRAIN	<u> </u>
SP	SPRINKLER	I
SW	SOFTENED WATER	
TMV	THERMOSTATIC MIXING VALVE	PLUI
TP	TRAP PRIMER	
TW	TEMPERED WATER	SYSTEM
V	SANITARY VENT	DOMESTIC WATER (A
VB	VACUUM BREAKER	DOMESTIC WATER
VTR	VENT THRU ROOF	(UNDERGROUND BE
W	WASTE	
WB	WRIST BLADES	
W.C.	WATER COLUMN	DRAINAGE (UNDERG
WCO	WALL CLEANOUT	
WHA	WATER HAMMER ARRESTOR	
V V I I/~\		DRAINAGE (ABOVE C

PLUMBING ABBREVIATIONS

1 1 1 1 1	TREGOORE REDOGING VALVE				
RD	ROOF DRAIN	TP	TP		TRAP PRIMER PIPING (BELOW FLOOR)
RO	REVERSE OSMOSIS	P-1, WC-1, ETC			FIXTURE IDENTIFICATION
RPZ	REDUCED PRESSURE ZONE BACKFLOW PREVENTER		BFP		BACKFLOW PREVENTER
S	SANITARY OR SOIL				
ST	STORM DRAIN	<u> </u>	FCO/GC	0	FLOOR CLEANOUT/GRADE CLEANOUT
SP	SPRINKLER	II	СО		END OF LINE CLEANOUT ABOVE GRADE
SW	SOFTENED WATER				
TMV	THERMOSTATIC MIXING VALVE	PLUM	IBING N	ЛАТЕ	RIALS SCHEDULE
TP	TRAP PRIMER			· · · · · ·	
TW	TEMPERED WATER	SYSTEM			PIPING MATERIAL
V	SANITARY VENT	DOMESTIC WATER (AB GROUND)	BOVE	ASTM B8	88 TYPE 'L' HARD COPPER
VB	VACUUM BREAKER	DOMESTIC WATER		ASTM B8	88 TYPE 'K' SOFT COPPER. NO JOINTS BELOW
VTR	VENT THRU ROOF	(UNDERGROUND BELC	OW SLAB)	SLAB ON	N GRADE.
W	WASTE				E WEIGHT, HUB AND SPIGOT CAST IRON WITH ESSION JOINTS; ASTM A-74.
WB	WRIST BLADES	DRAINAGE (UNDERGR	OLIND)	SERVICE	E WEIGHT, NO-HUB CAST IRON WITH HEAVY
W.C.	WATER COLUMN	DIVAINAGE (UNDERGIV	OUND)		D-HUB COUPLINGS; ASTM C1540, ASTM C 564. ILE 40 PVC PIPE; ASTM D 2665 (REQUIRES
WCO	WALL CLEANOUT				APPROVAL)
WHA	WATER HAMMER ARRESTOR	DRAINAGE (ABOVE GR	ROUND)	NO-HUB	CAST IRON ASTM A 888 OR CISPI 301
		VENT (ABOVE GROUNI	D)	NO-HUB	CAST IRON ASTM A 888 OR CISPI 301
		DRAINAGE (CONDENS	ATE)	COPPER	R DWV TUBE: ASTM B 88, TYPE 'K' OR 'L'
		STORM WATER (ABOV	E GROUND)		CAST IRON ASTM A 888 OR CISPI 301 WITH DUTY COUPLINGS.

DESCRIPTION

RD-1 ROOF DRAIN

OD-1 OVERFLOW ROOF DRAIN

DS-1 DOWNSPOUT NOZZLE

DALLAS STREET CANOPY ROOF - PLUMBING NEW WORK PLAN


(G.6)

EXISTING 3"ST FROM EXISTING CANOPY

REMOVE EXISTING ROOF

DRAIN AND ASSOCIATED

ROOF DRAINS. CAP INSIDE ABOVE CEILING.

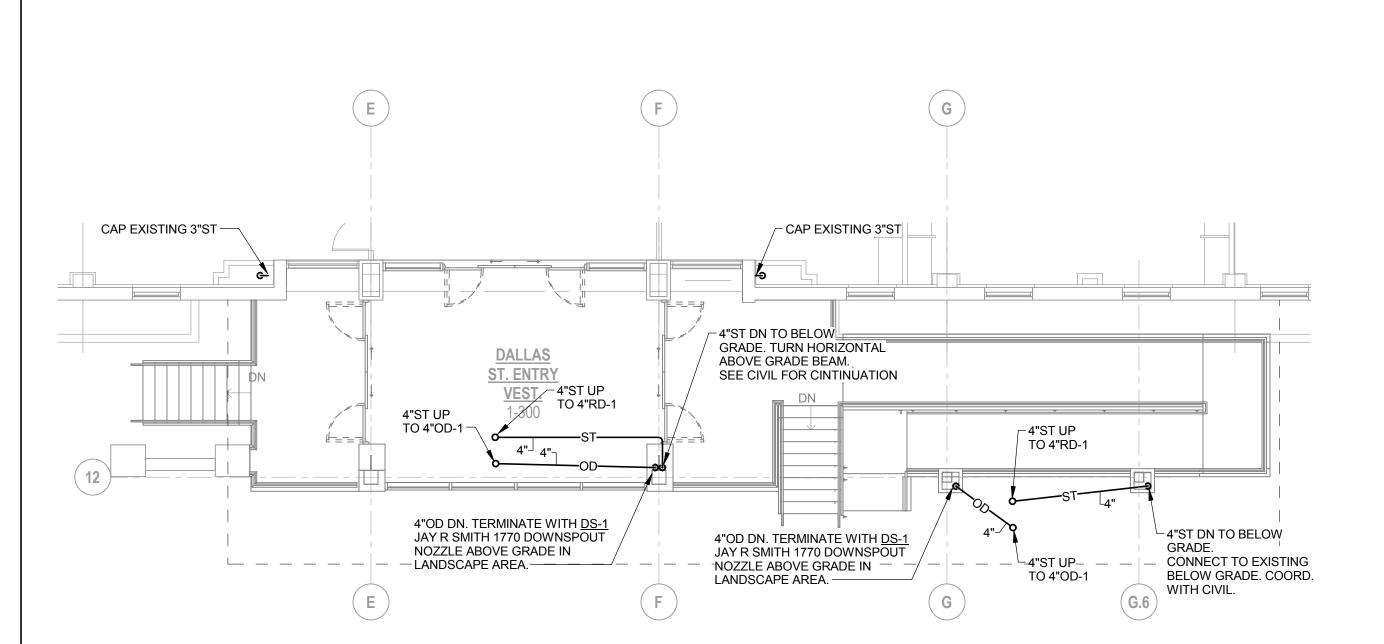

DALLAS STREET VESTIBULE - PLUMBING NEW WORK PLAN SCALE: 1/8" = 1'-0"
SCALE: 1/8" = 1'-0"

EXISTING 2"ST FROM EXISTING CANOPY


ROOF DRAINS. CAP INSIDE ABOVE CEILING.

REMOVE EXISTING ROOF


DRAIN AND ASSOCIATED


DALLAS STREET CANOPY ROOF - PLUMBING DEMOLION PLAN


SCALE: 1/8" = 1'-0"

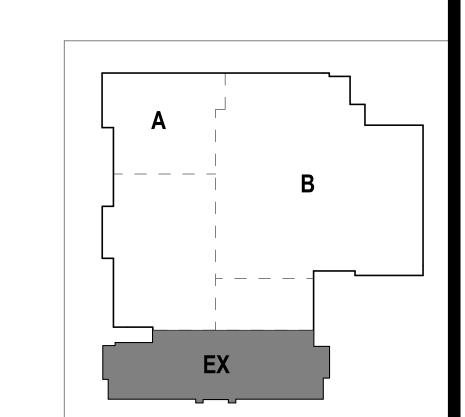



ACCESSIBILITY CONSULTANTS 1510 Lethia Dr. Nashville, TN 37206

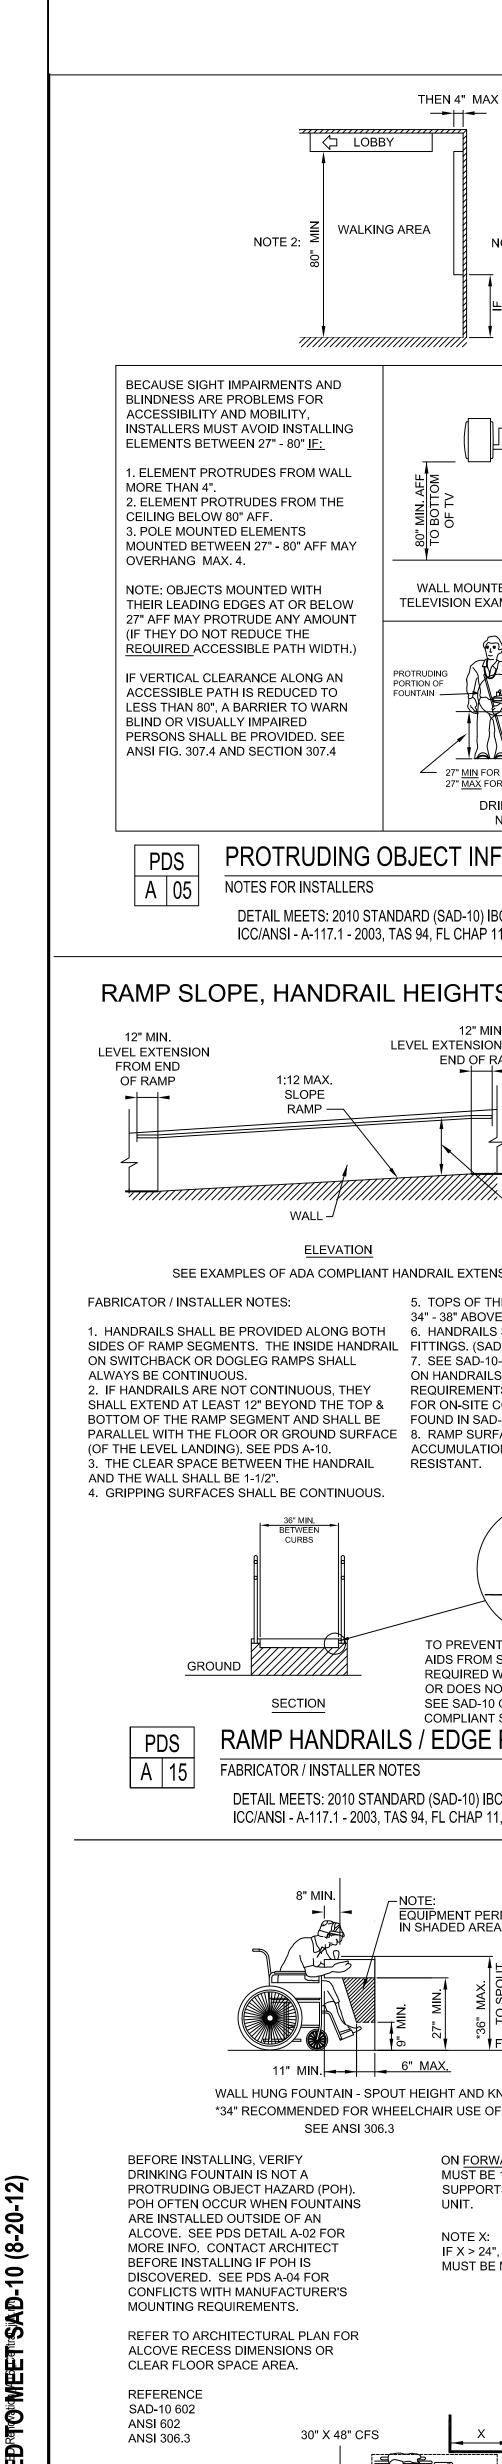


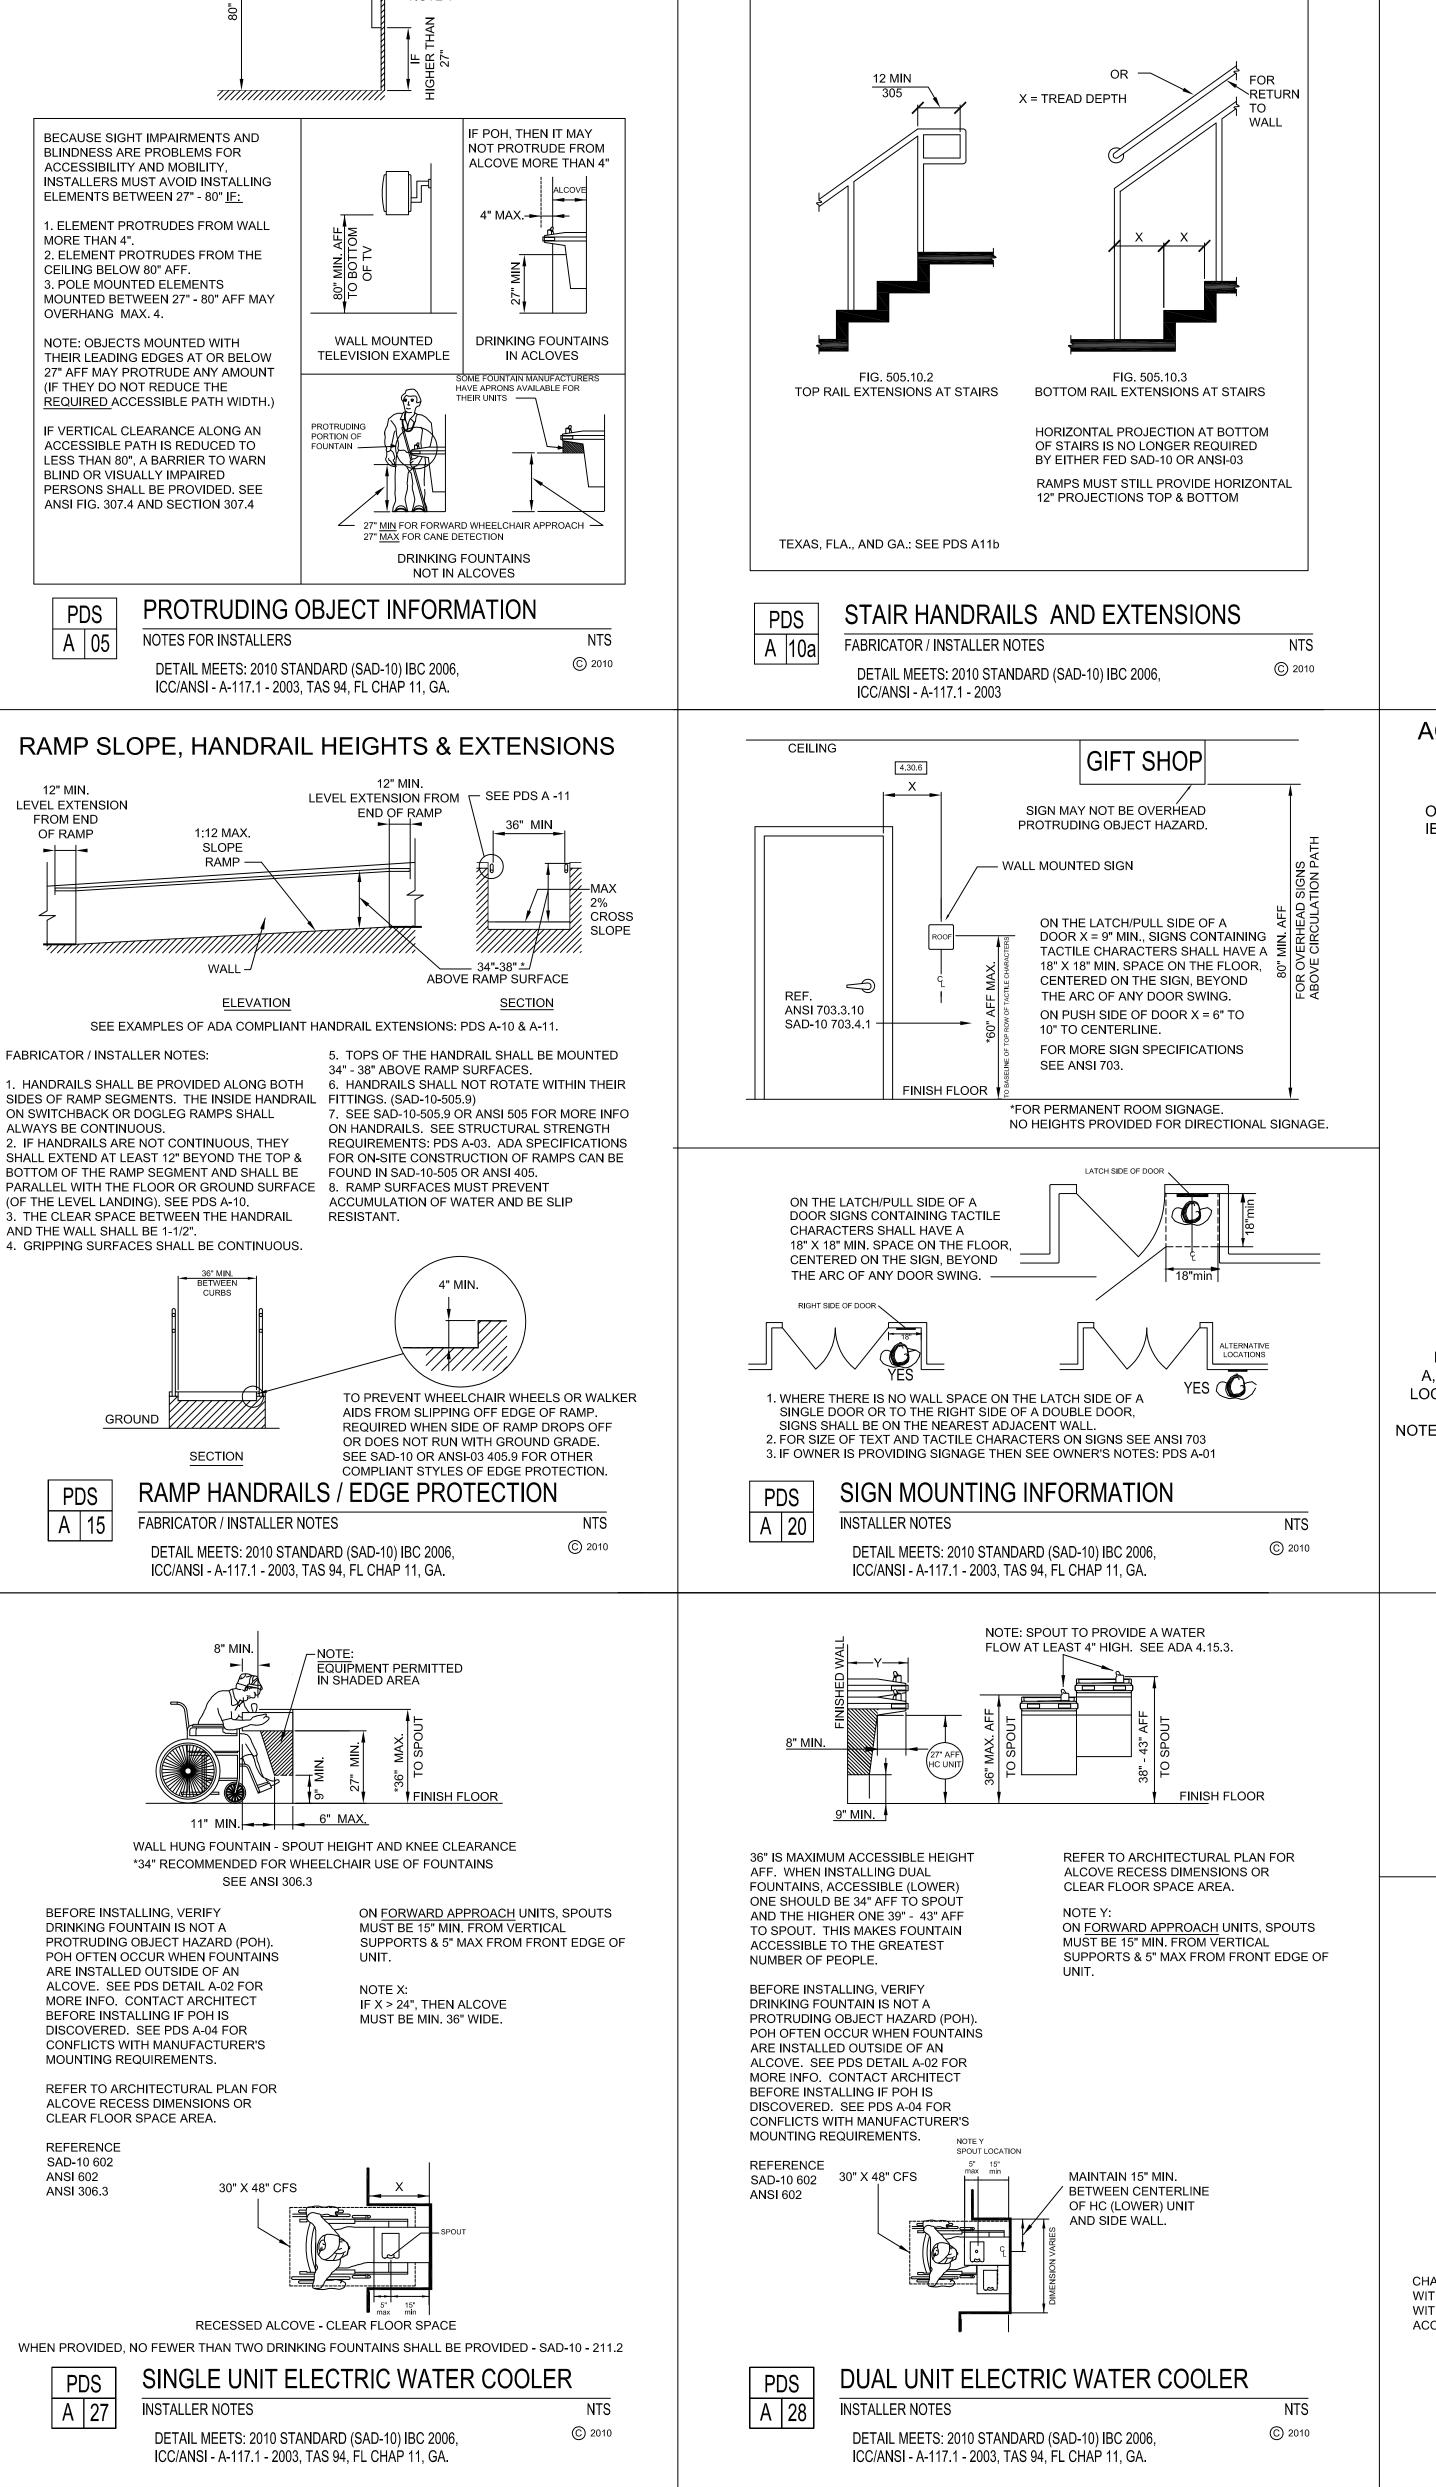

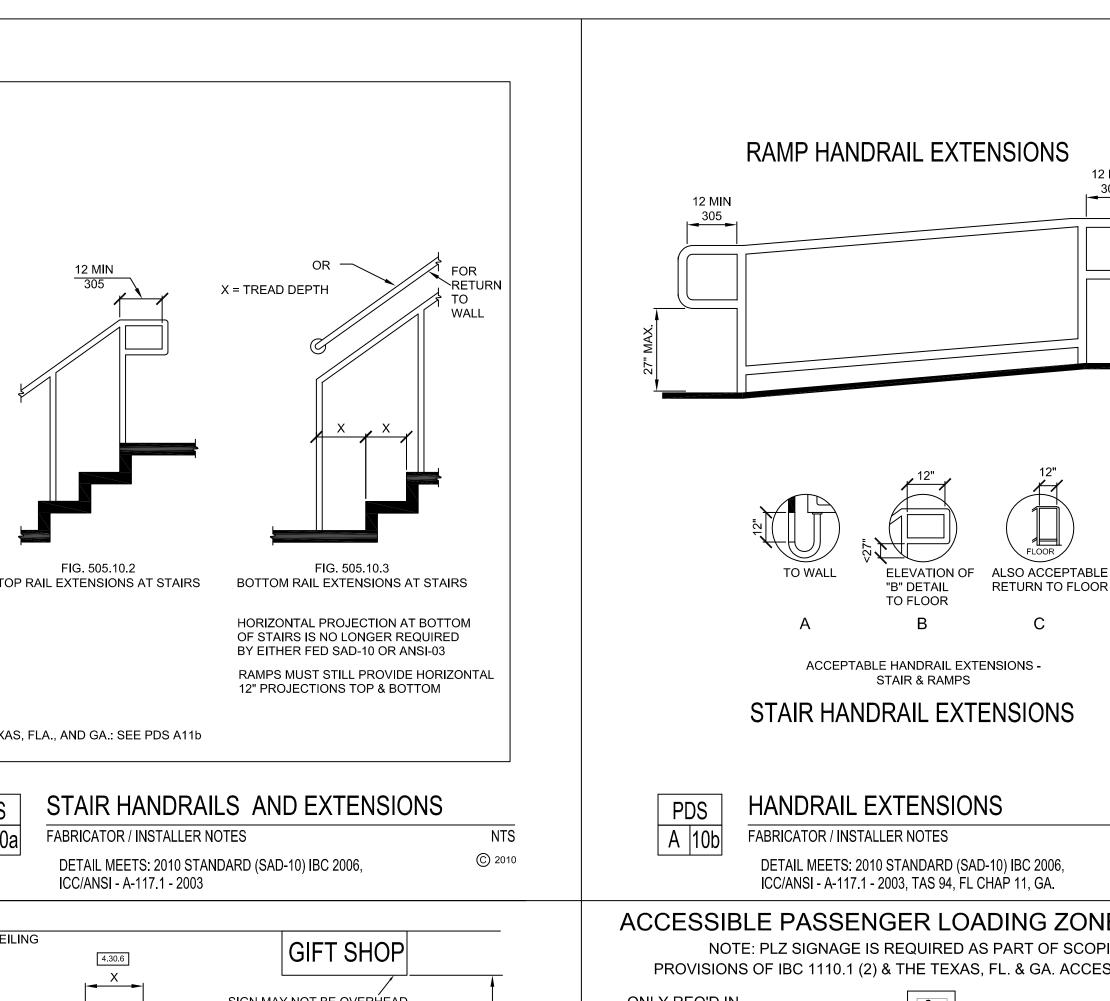

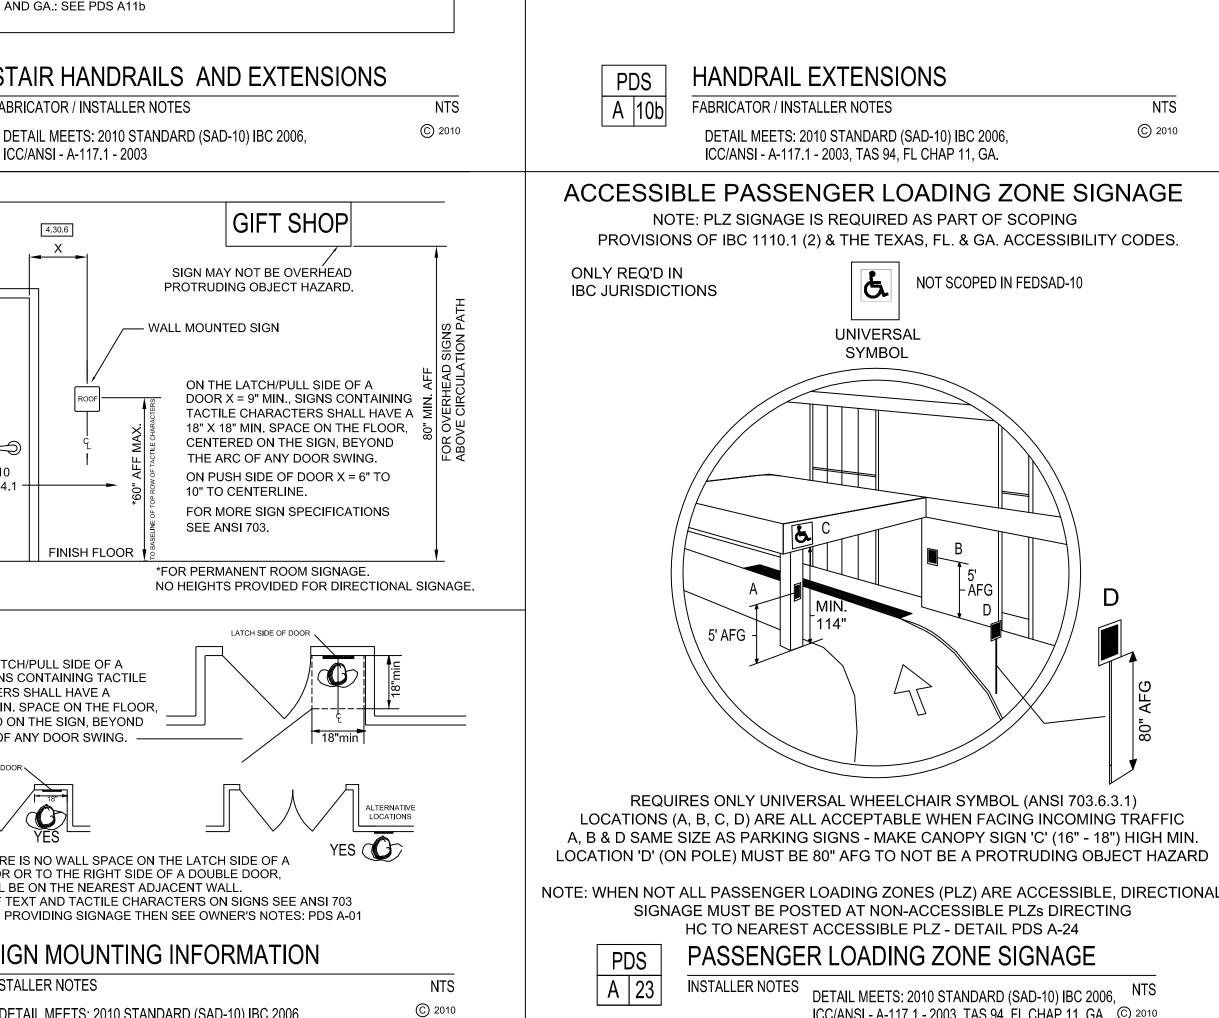

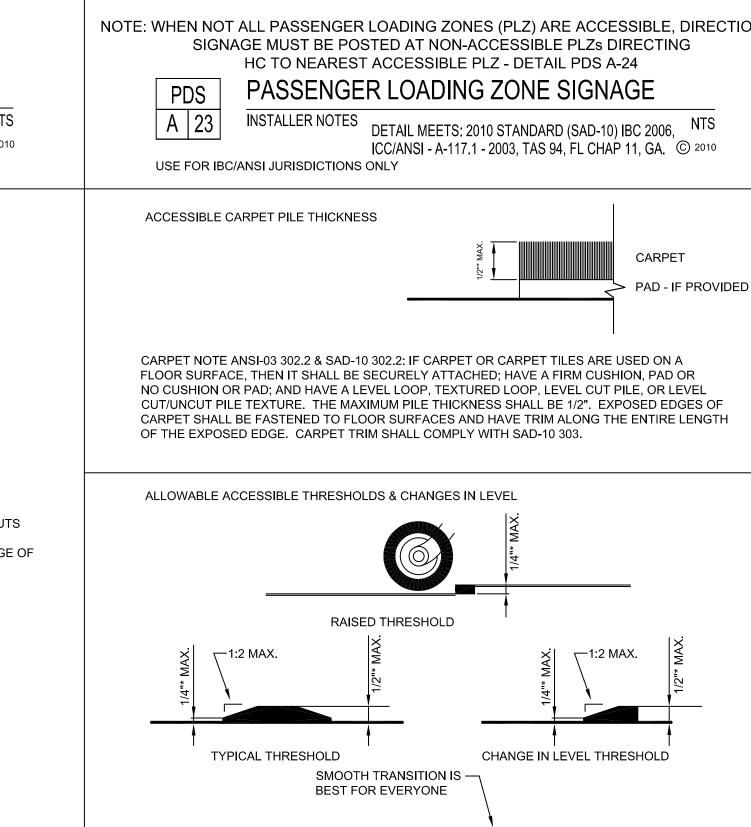


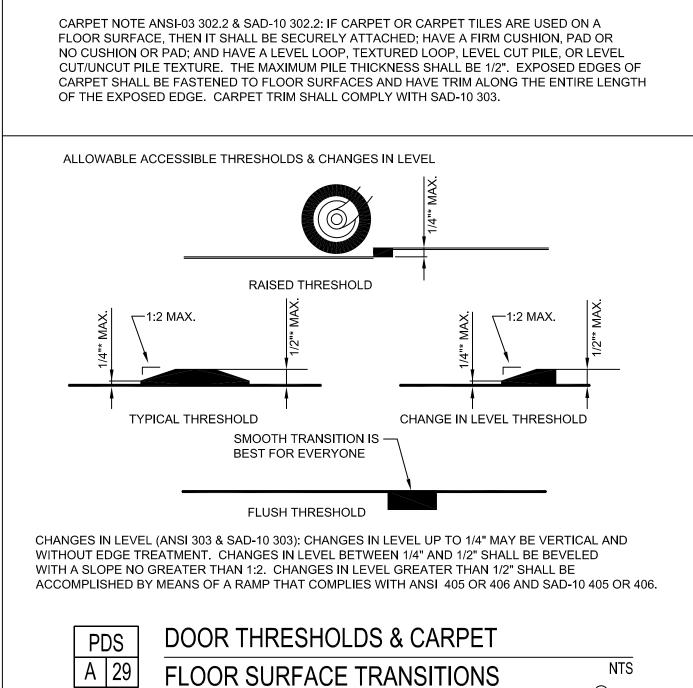



DETAIL MEETS: 2010 STANDARD (SAD-10) IBC 2006,


ICC/ANSI - A-117.1 - 2003, TAS 94, FL CHAP 11, GA.

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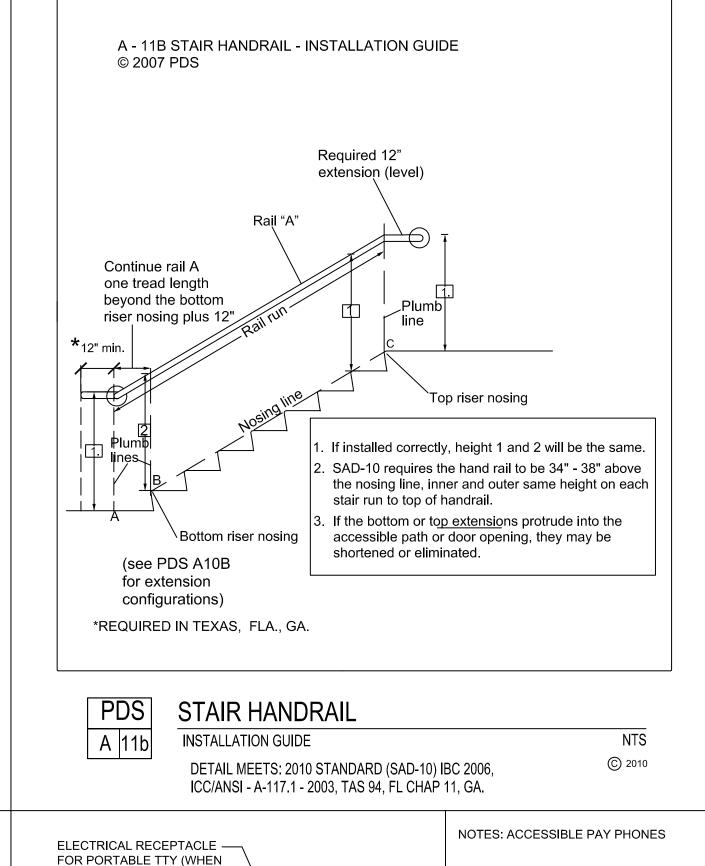


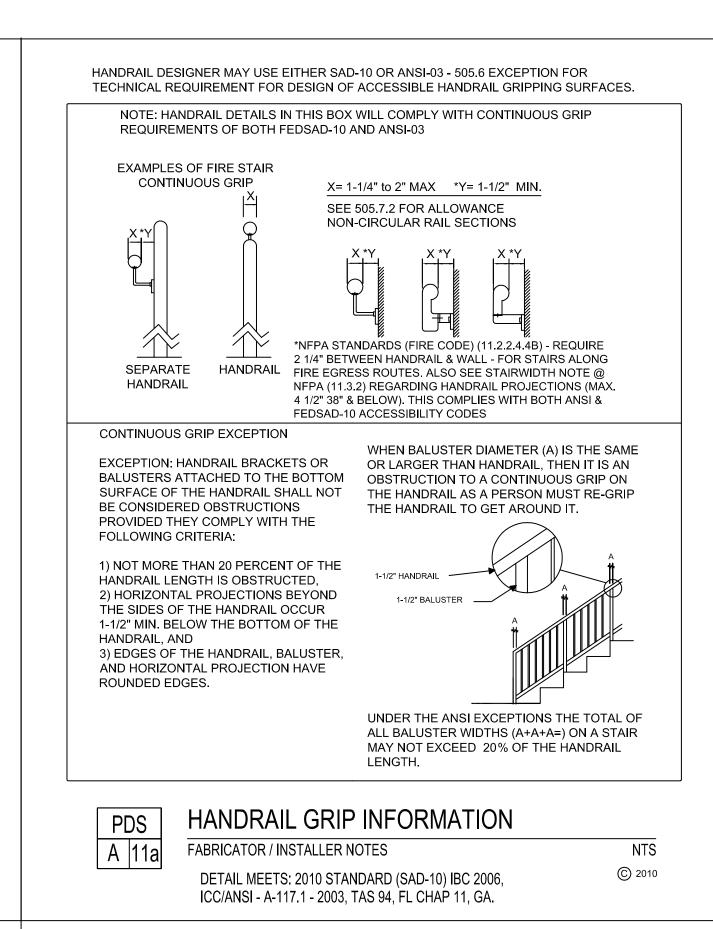


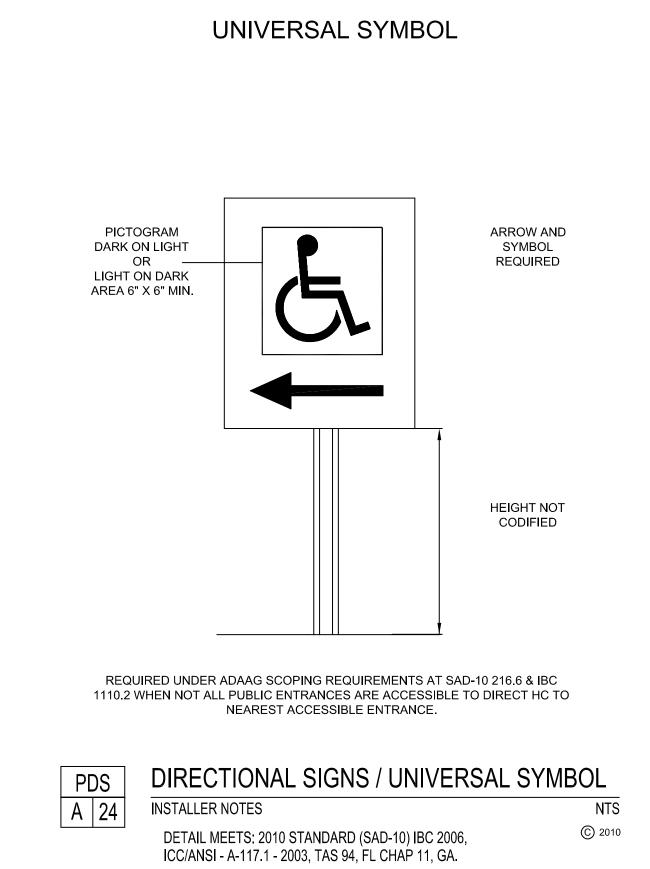
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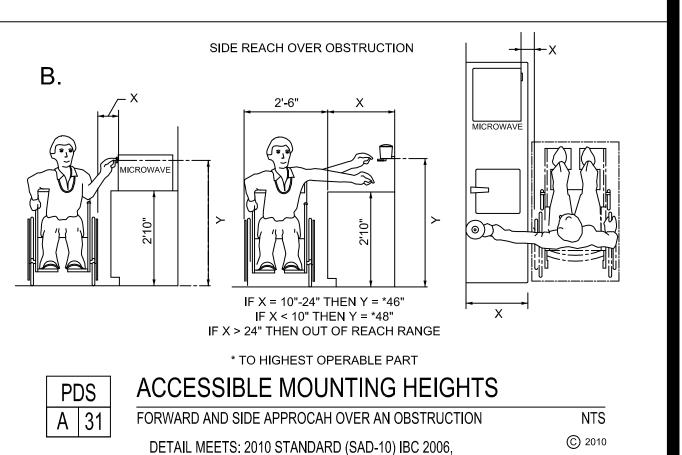
ICC/ANSI - A-117.1 - 2003, TAS 94, FL CHAP 11, GA.
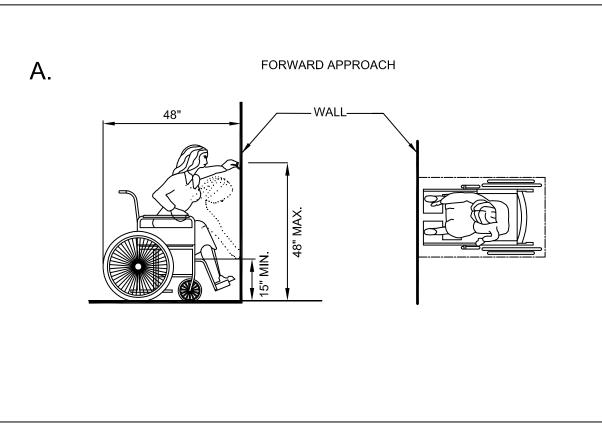
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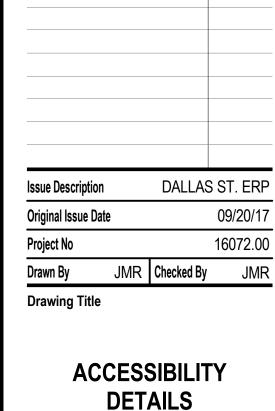


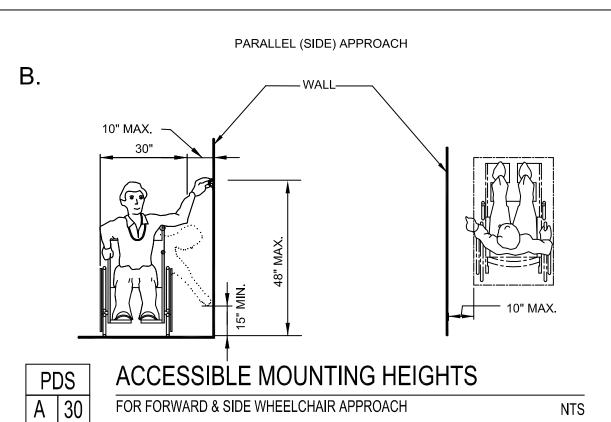



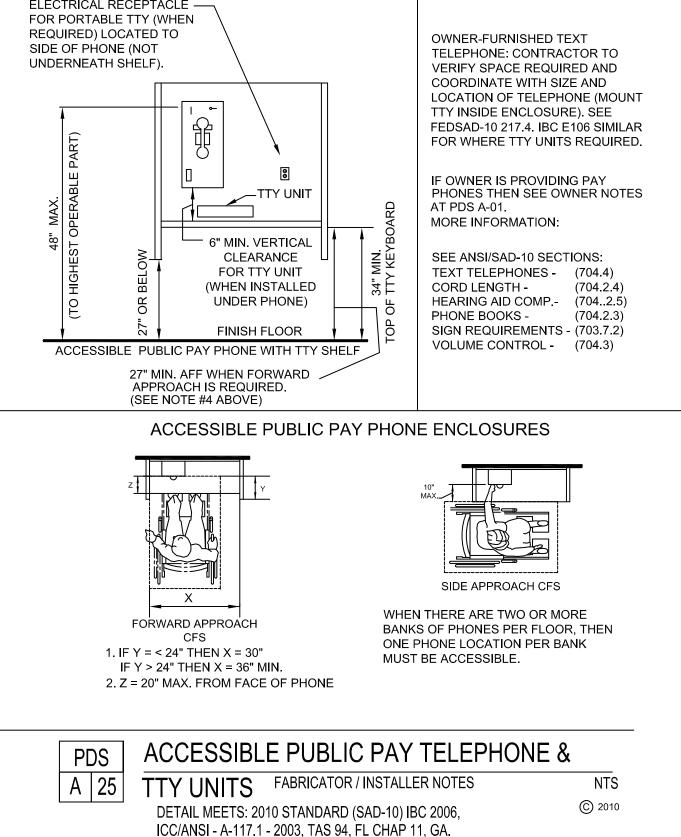


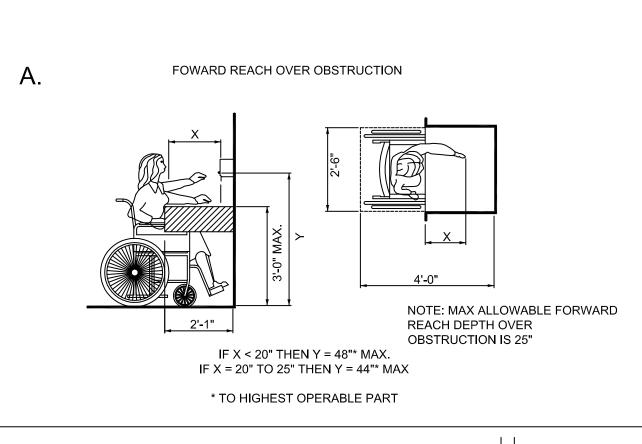ICC/ANSI - A-117.1 - 2003, TAS 94, FL CHAP 11, GA.




DOCUMENT CHANGES

PDS-02

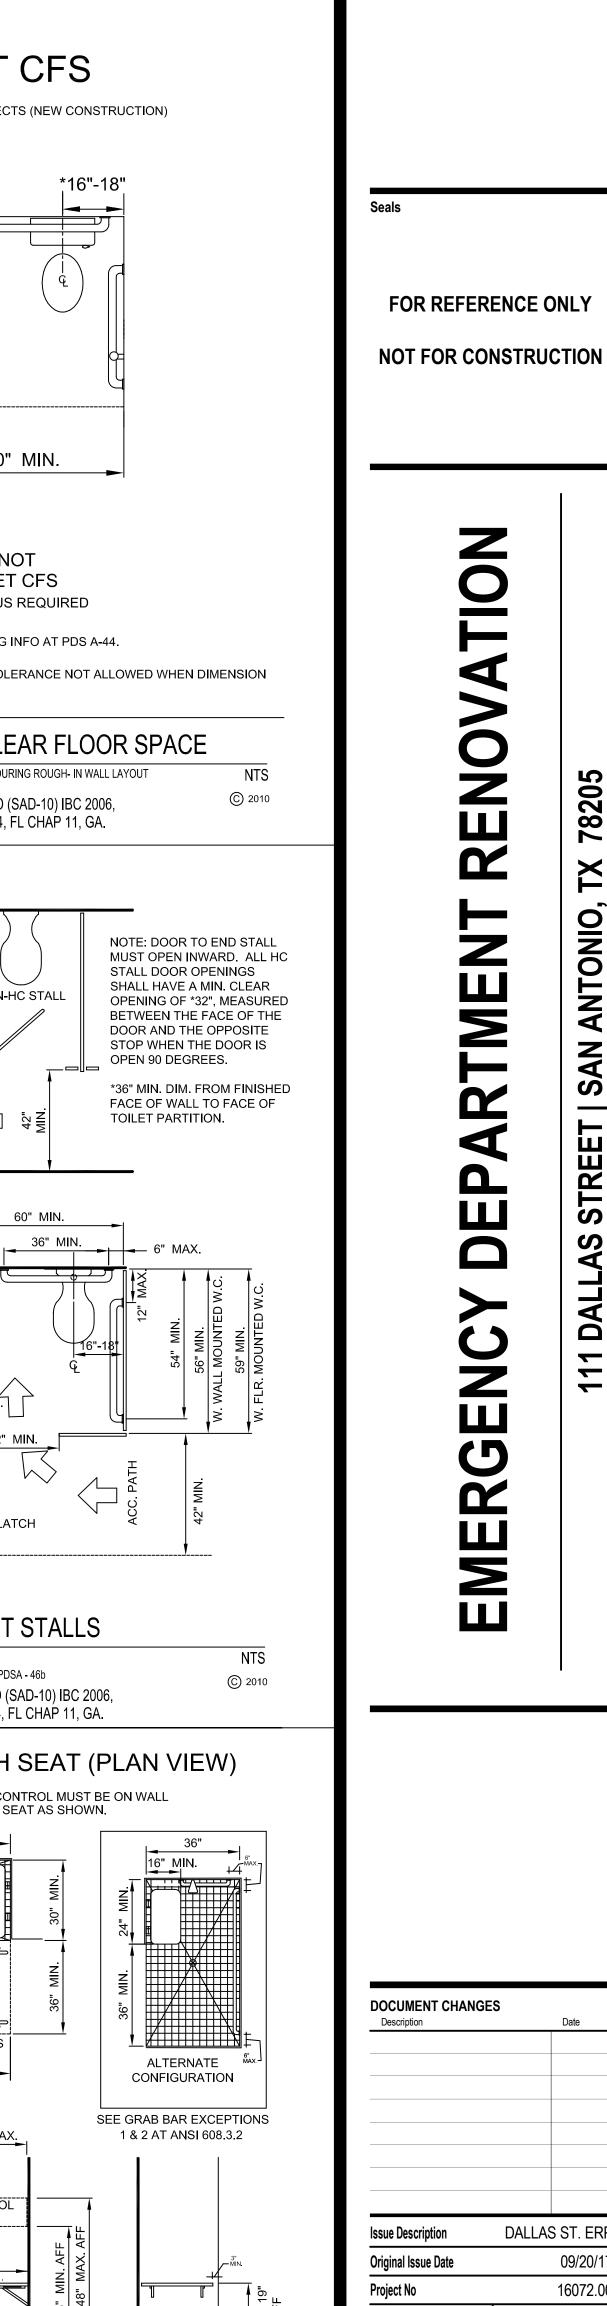

ACCESSIBILITY CONSULTANTS 1510 Lethia Dr. Nashville, TN 37206

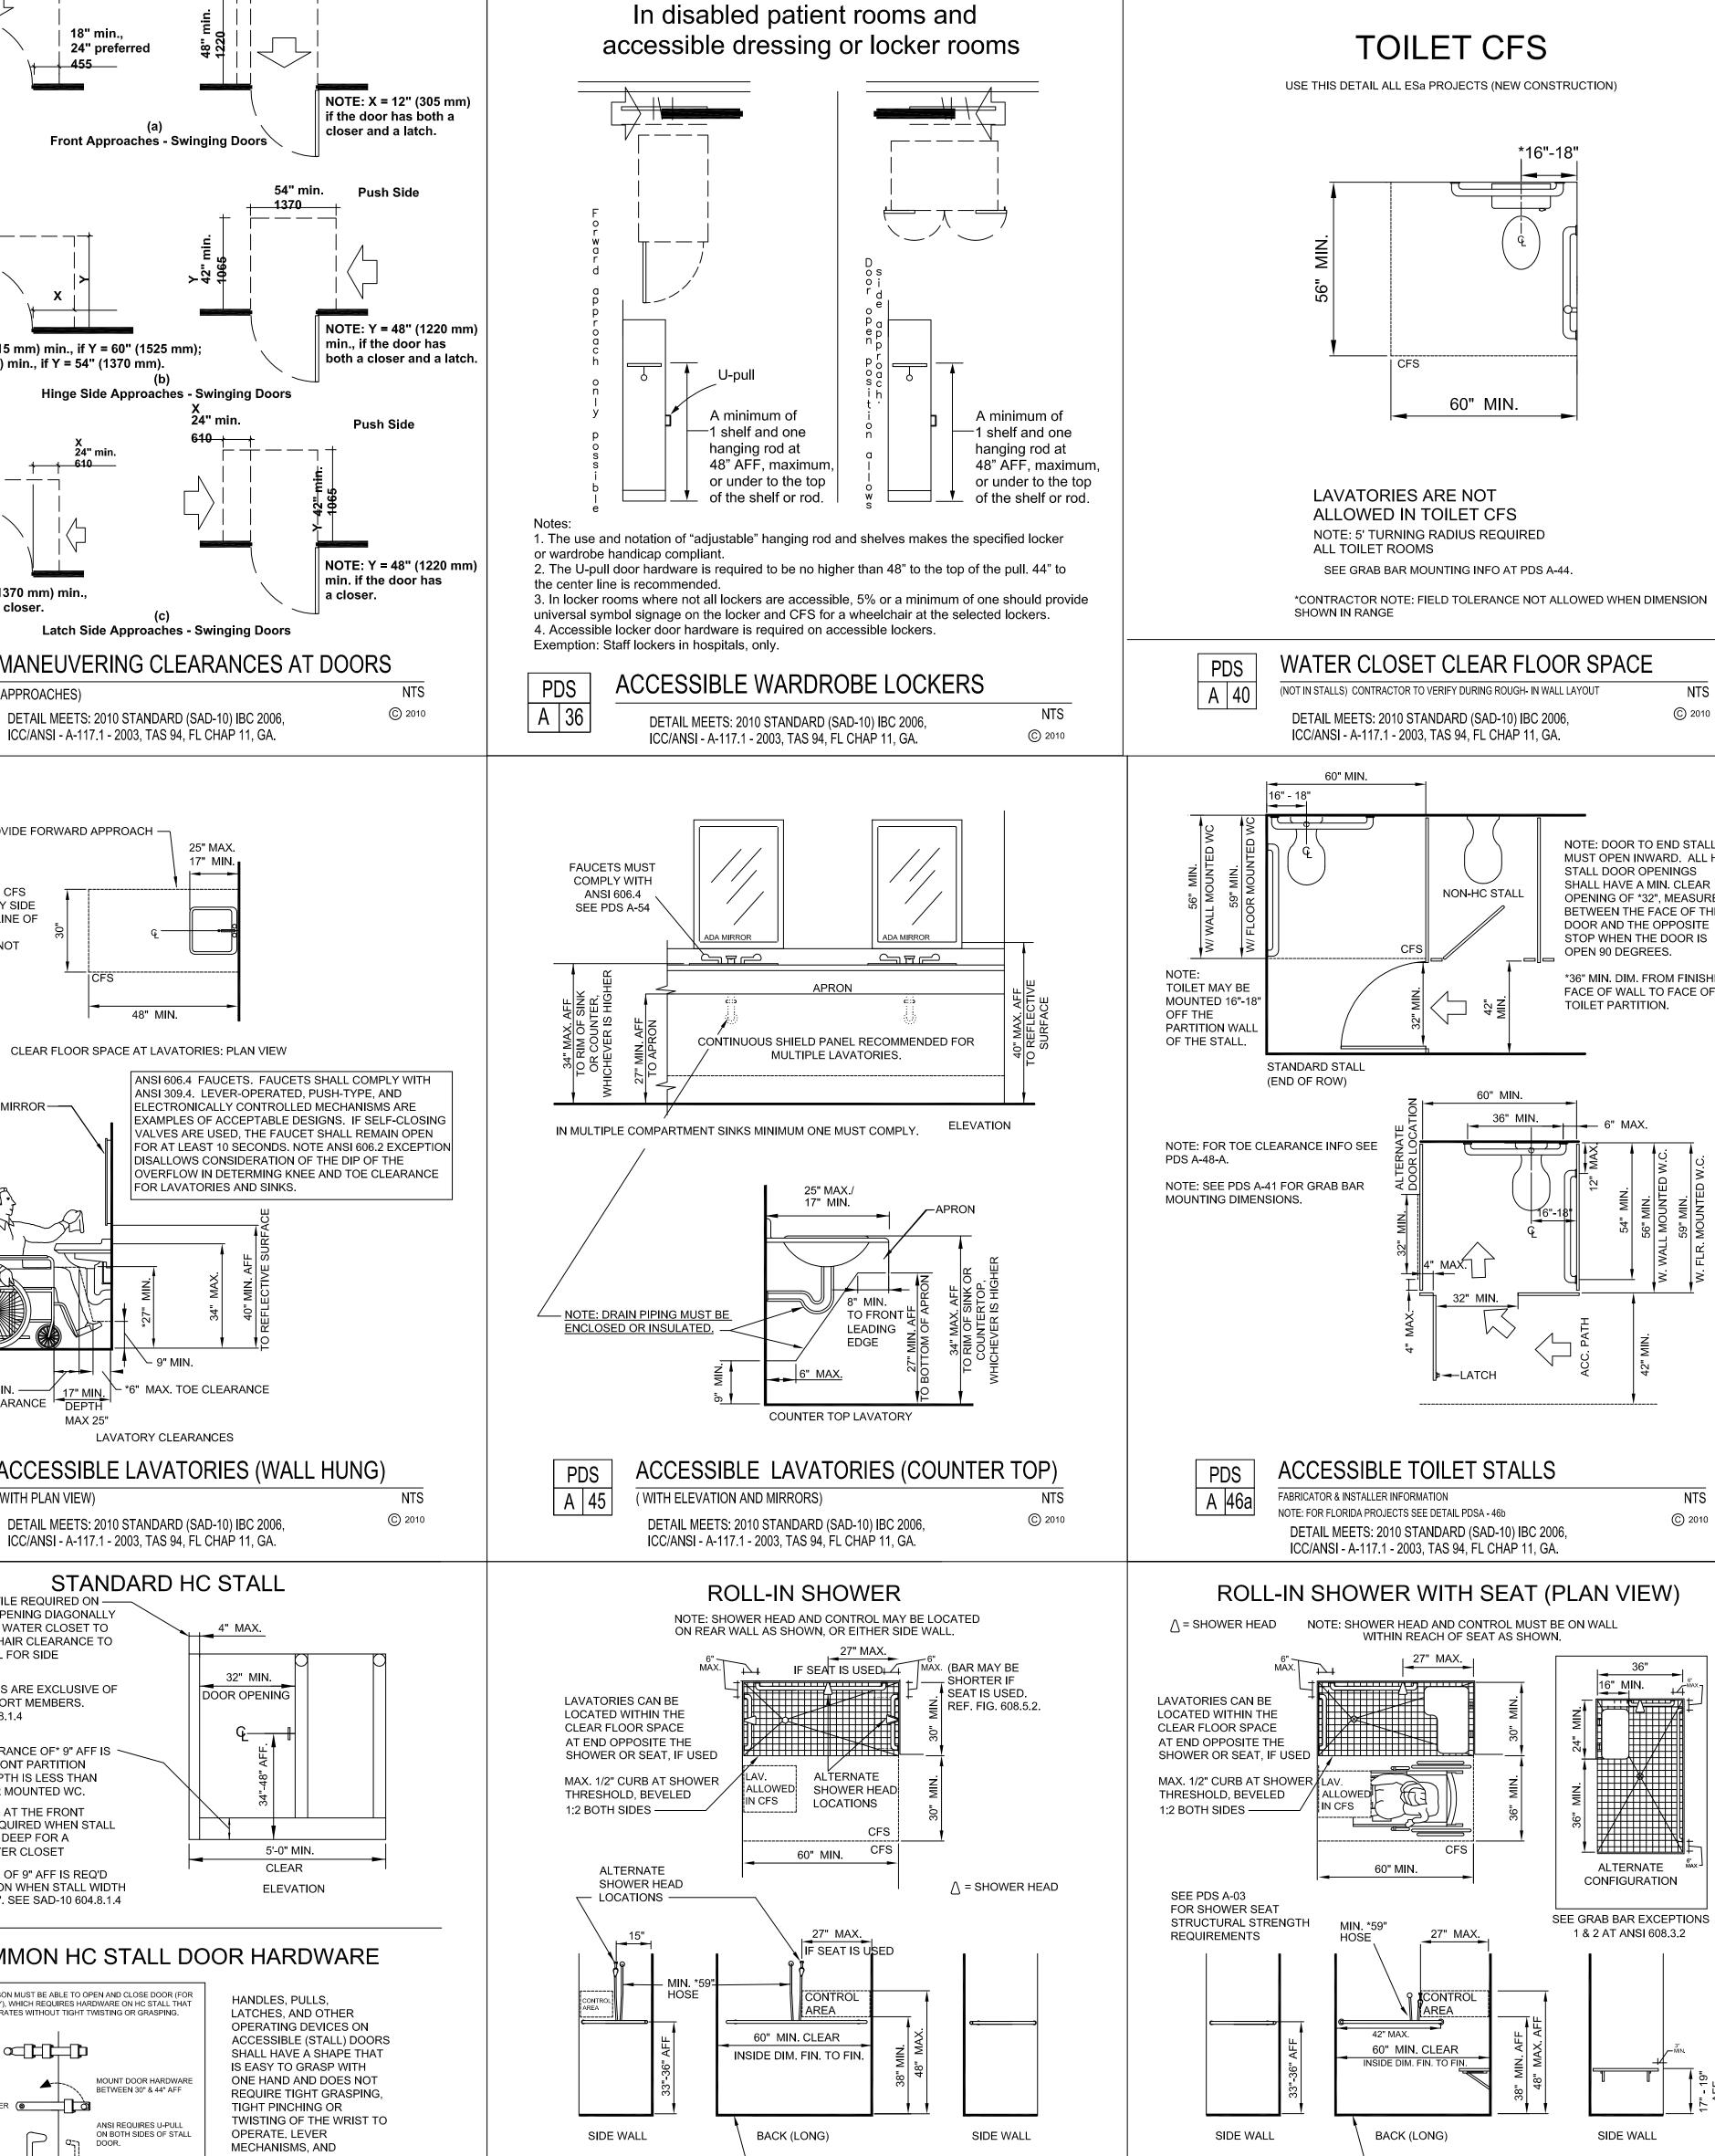

ACCESSIBLE WARDROBES AND LOCKERS

Push Side

+ 1370 +

Pull Side

NOTE: Y = 54'' (1370 mm) min.

if the door has a closer.

MAINTAIN 15" MIN. CFS

FROM FACE OF ANY SIDE

WALL TO CENTERLINE OF

RECOMMENDED: (NOT

LAVATORY

CODIFIED)

A 35

NOTE: X = 36" (915 mm) min., if Y = 60" (1525 mm);

MUST PROVIDE FORWARD APPROACH -

8" MIN. _______17" MIN. KNEE CLEARANCE DEPTH

INSTALLER NOTES

DETAIL MEETS: 2010 STANDARD (SAD-10) IBC 2006,

ICC/ANSI - A-117.1 - 2003, TAS 94, FL CHAP 11, GA.

x = 42" (1065 mm) min., if Y = 54" (1370 mm).

24" preferre

Front Approaches - Swinging Doors

Hinge Side Approaches - Swinging Doors

Latch Side Approaches - Swinging Doors

17" MIN. _I

FOR LAVATORIES AND SINKS.

DETAIL MEETS: 2010 STANDARD (SAD-10) IBC 2006,

ICC/ANSI - A-117.1 - 2003. TAS 94. FL CHAP 11. GA.

48" MIN.


' ─ 9" MIN.

LAVATORY CLEARANCES

- *6" MAX. TOE CLEARANCE

CLEAR FLOOR SPACE AT LAVATORIES: PLAN VIEW

610 + +

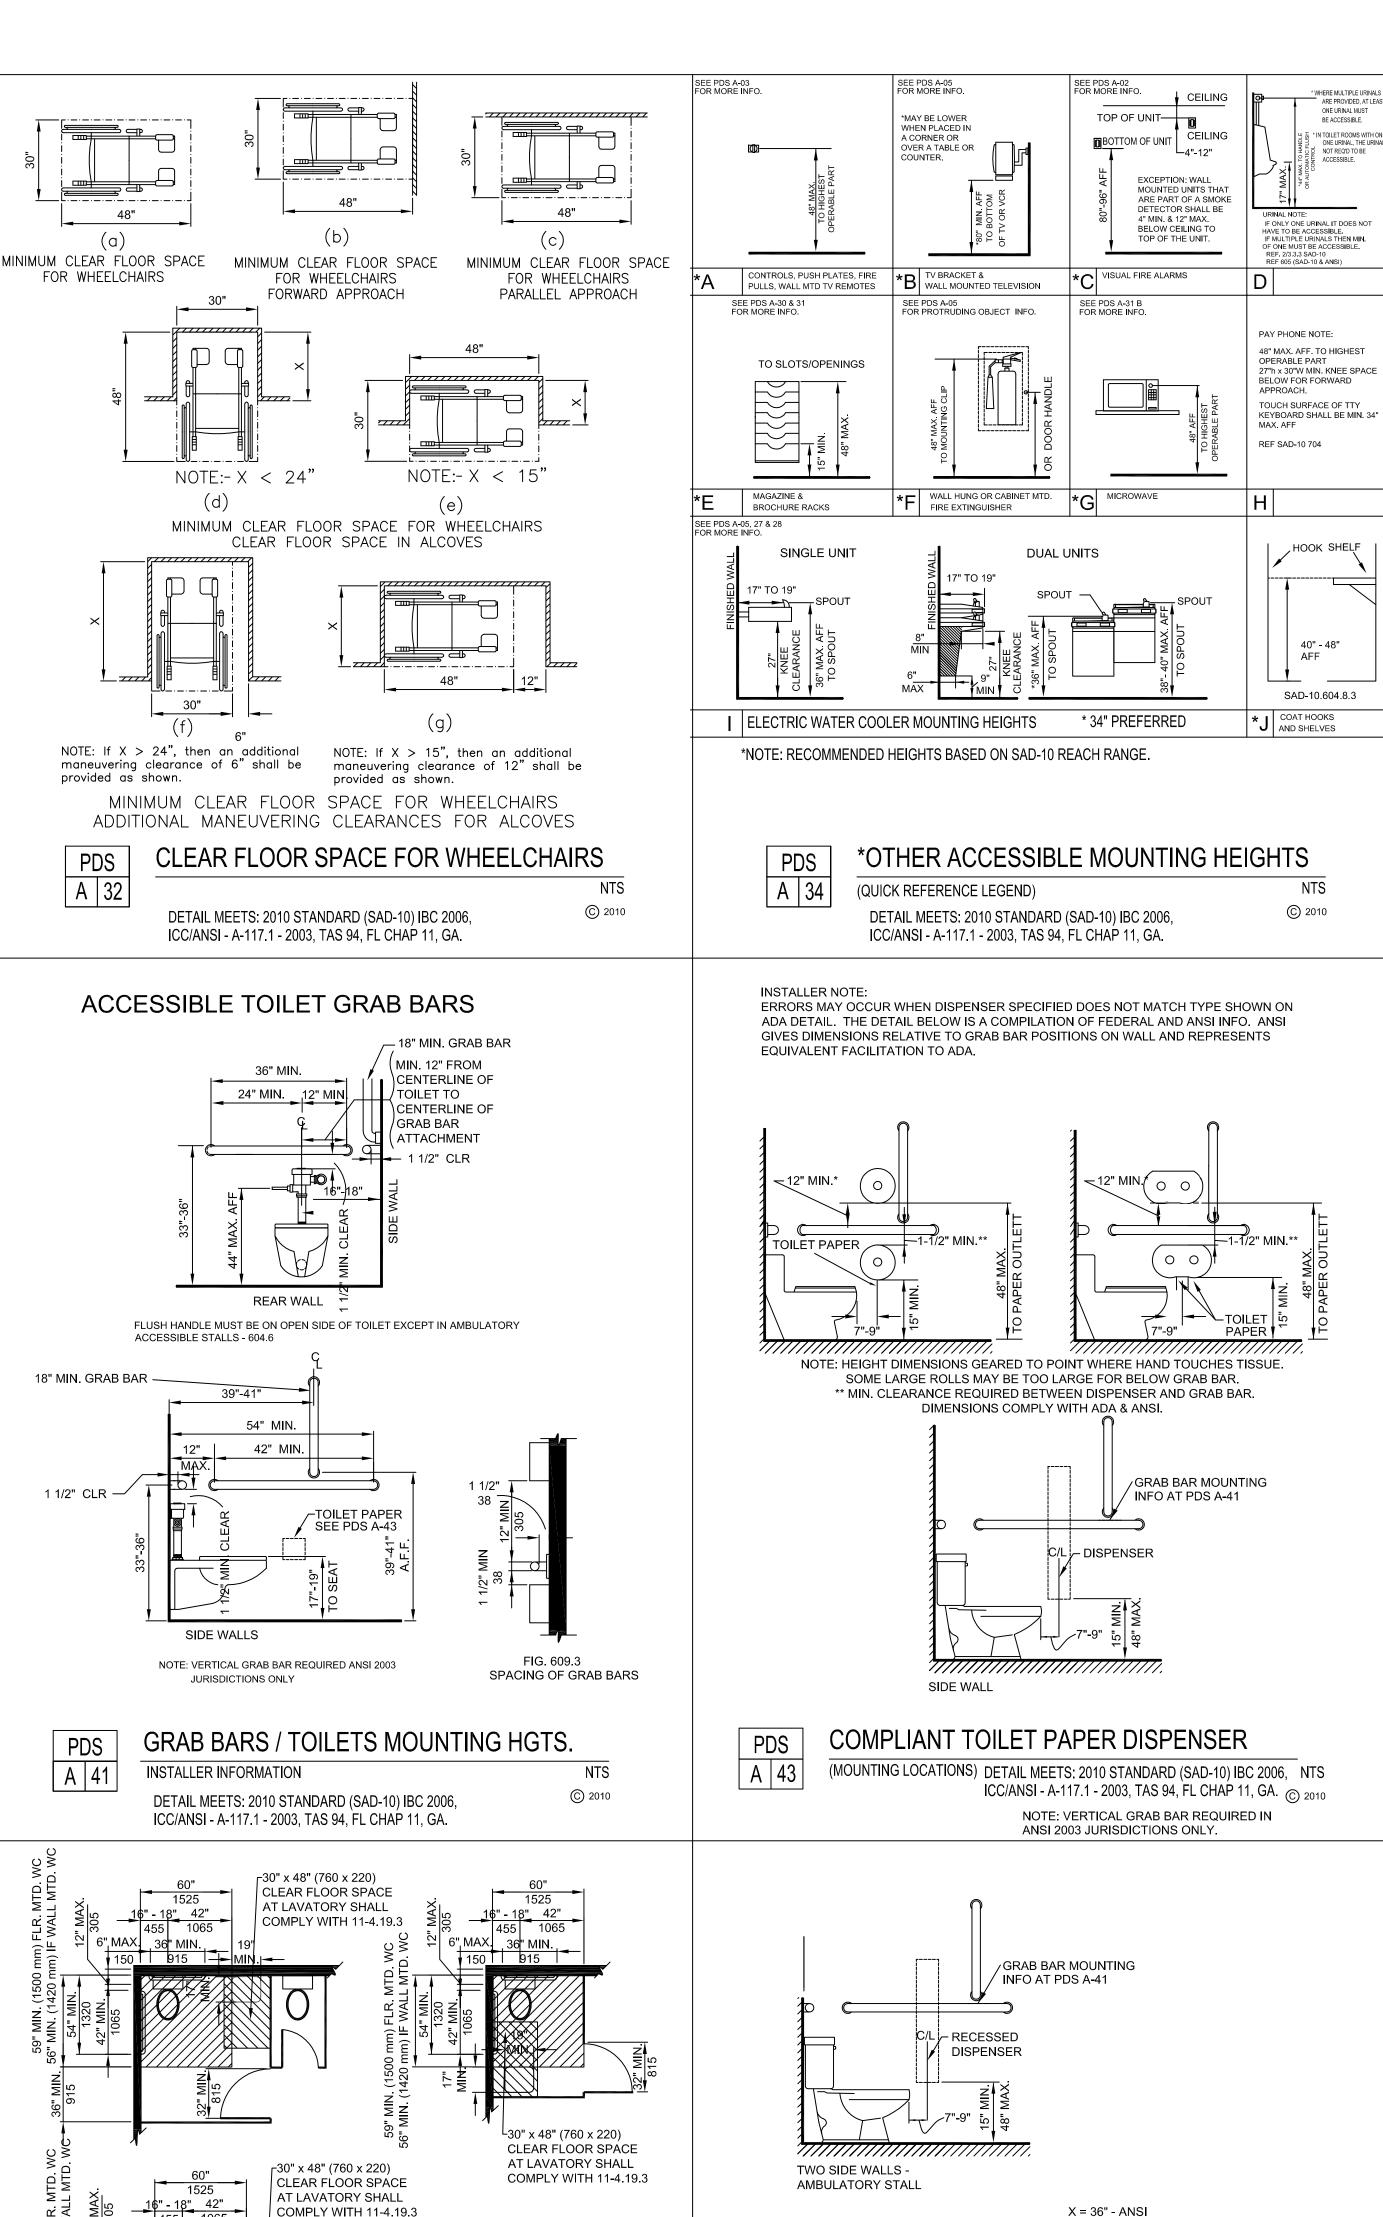

IN NEW CONSTRUCTION A LAVATORY SHALL BE PROVIDED WITHIN THE ACCESSIBLE TOILET STALL.

SEE FIGURE 40 FOR THE REQUIRED CLEAR FLOOR SPACE FOR THE WATER CLOSET.

THE WATER CLOSET SHALL BE LOCATED IN THE CORNER DIAGONAL TO THE DOOR.

FLUSH CONTROL SHALL COMPLY WITH SECTION 11-4.16.5

FABRICATOR & INSTALLER INFORMATION

USE FOR FLORIDA CHAPTER 11 LOCATIONS ONLY

ACCESSIBLE TOILET STALL.

THE LAVATORY SHALL NOT ENCROACH INTO THE REQUIRED CLEAR FLOOR SPACE FOR THE WATER


THE LOCATION SHOWN FOR THE LAVATORY IS ONLY ONE OF MANY POSSIBLE LOCATIONS WITHIN THE


TOILET STALL NEW CONSTRUCTION-FLA ONLY


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THE TOILET STALL DOOR SHALL NOT SWING INTO THE REQUIRED CLEAR FLOOR SPACE FOR ANY


DETAIL MEETS: 2010 STANDARD (SAD-10) IBC 2006



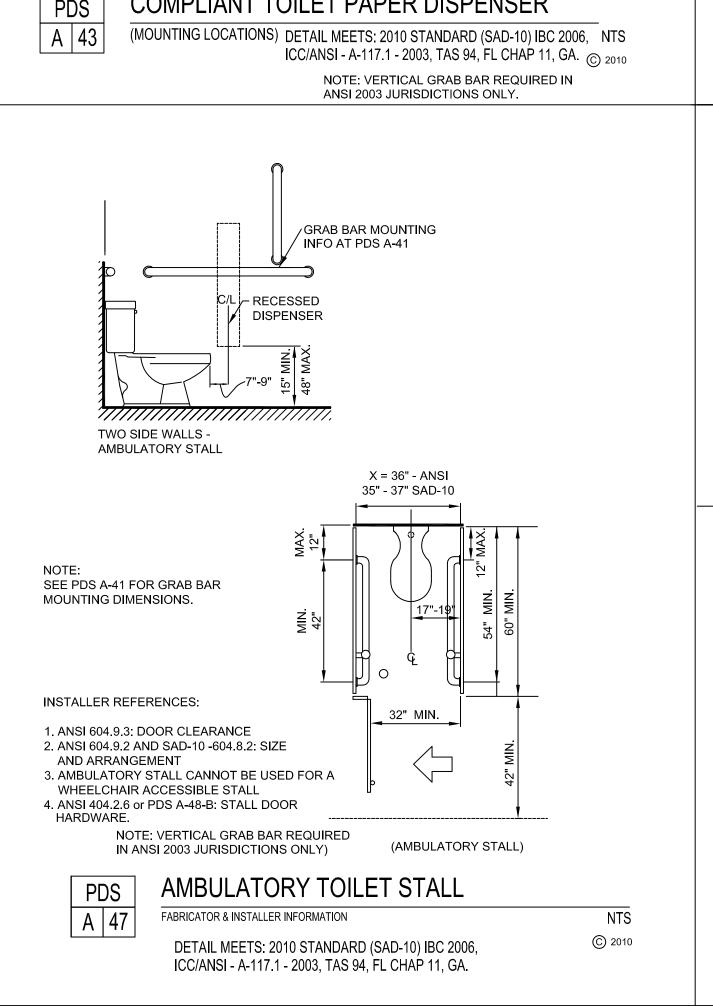

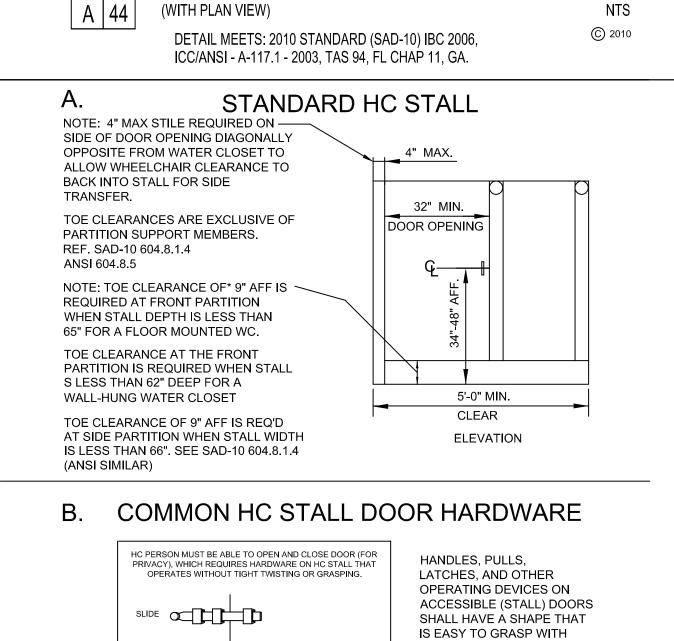
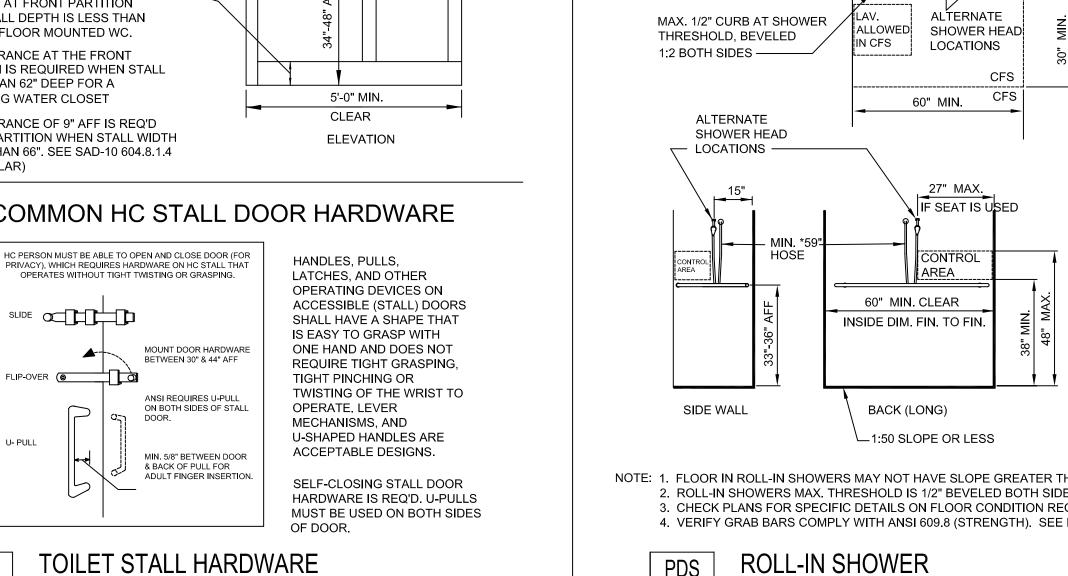
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DALLAS ST. ERP JMR | Checked By JMR Drawn By **Drawing Title** 1:50 SLOPE OR LESS NOTE: 1. FLOOR IN ROLL-IN SHOWERS MAY NOT HAVE SLOPE GREATER THAN *2% ALL DIRECTIONS. **ACCESSIBILITY** 2. ROLL-IN SHOWERS MAX. THRESHOLD IS 1/2" BEVELED BOTH SIDES. 3. CHECK PLANS FOR SPECIFIC DETAILS ON FLOOR CONDITION REQUIREMENTS IN SHOWER. 4. VERIFY GRAB BARS AND SEATS COMPLY WITH ANSI 609.8 (STRENGTH). SEE PDS A-03. 5. IF AN ADJUSTABLE HEIGHT SHOWER HEAD MOUNTED ON VERTICAL BAR IS USED, THE BAR

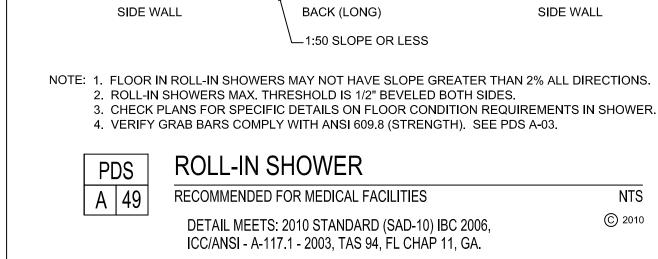(* ADAAG DIMENSIONS MORE STRINGENT) NTS

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SHALL NOT OBSTRUCT USE OF GRAB BARS.

ROLL-IN SHOWER WITH SEAT

DETAIL MEETS: 2010 STANDARD (SAD-10) IBC 2006,


ICC/ANSI - A-117.1 - 2003, TAS 94, FL CHAP 11, GA.

DETAILS

09/20/17

16072.00

PDS-03

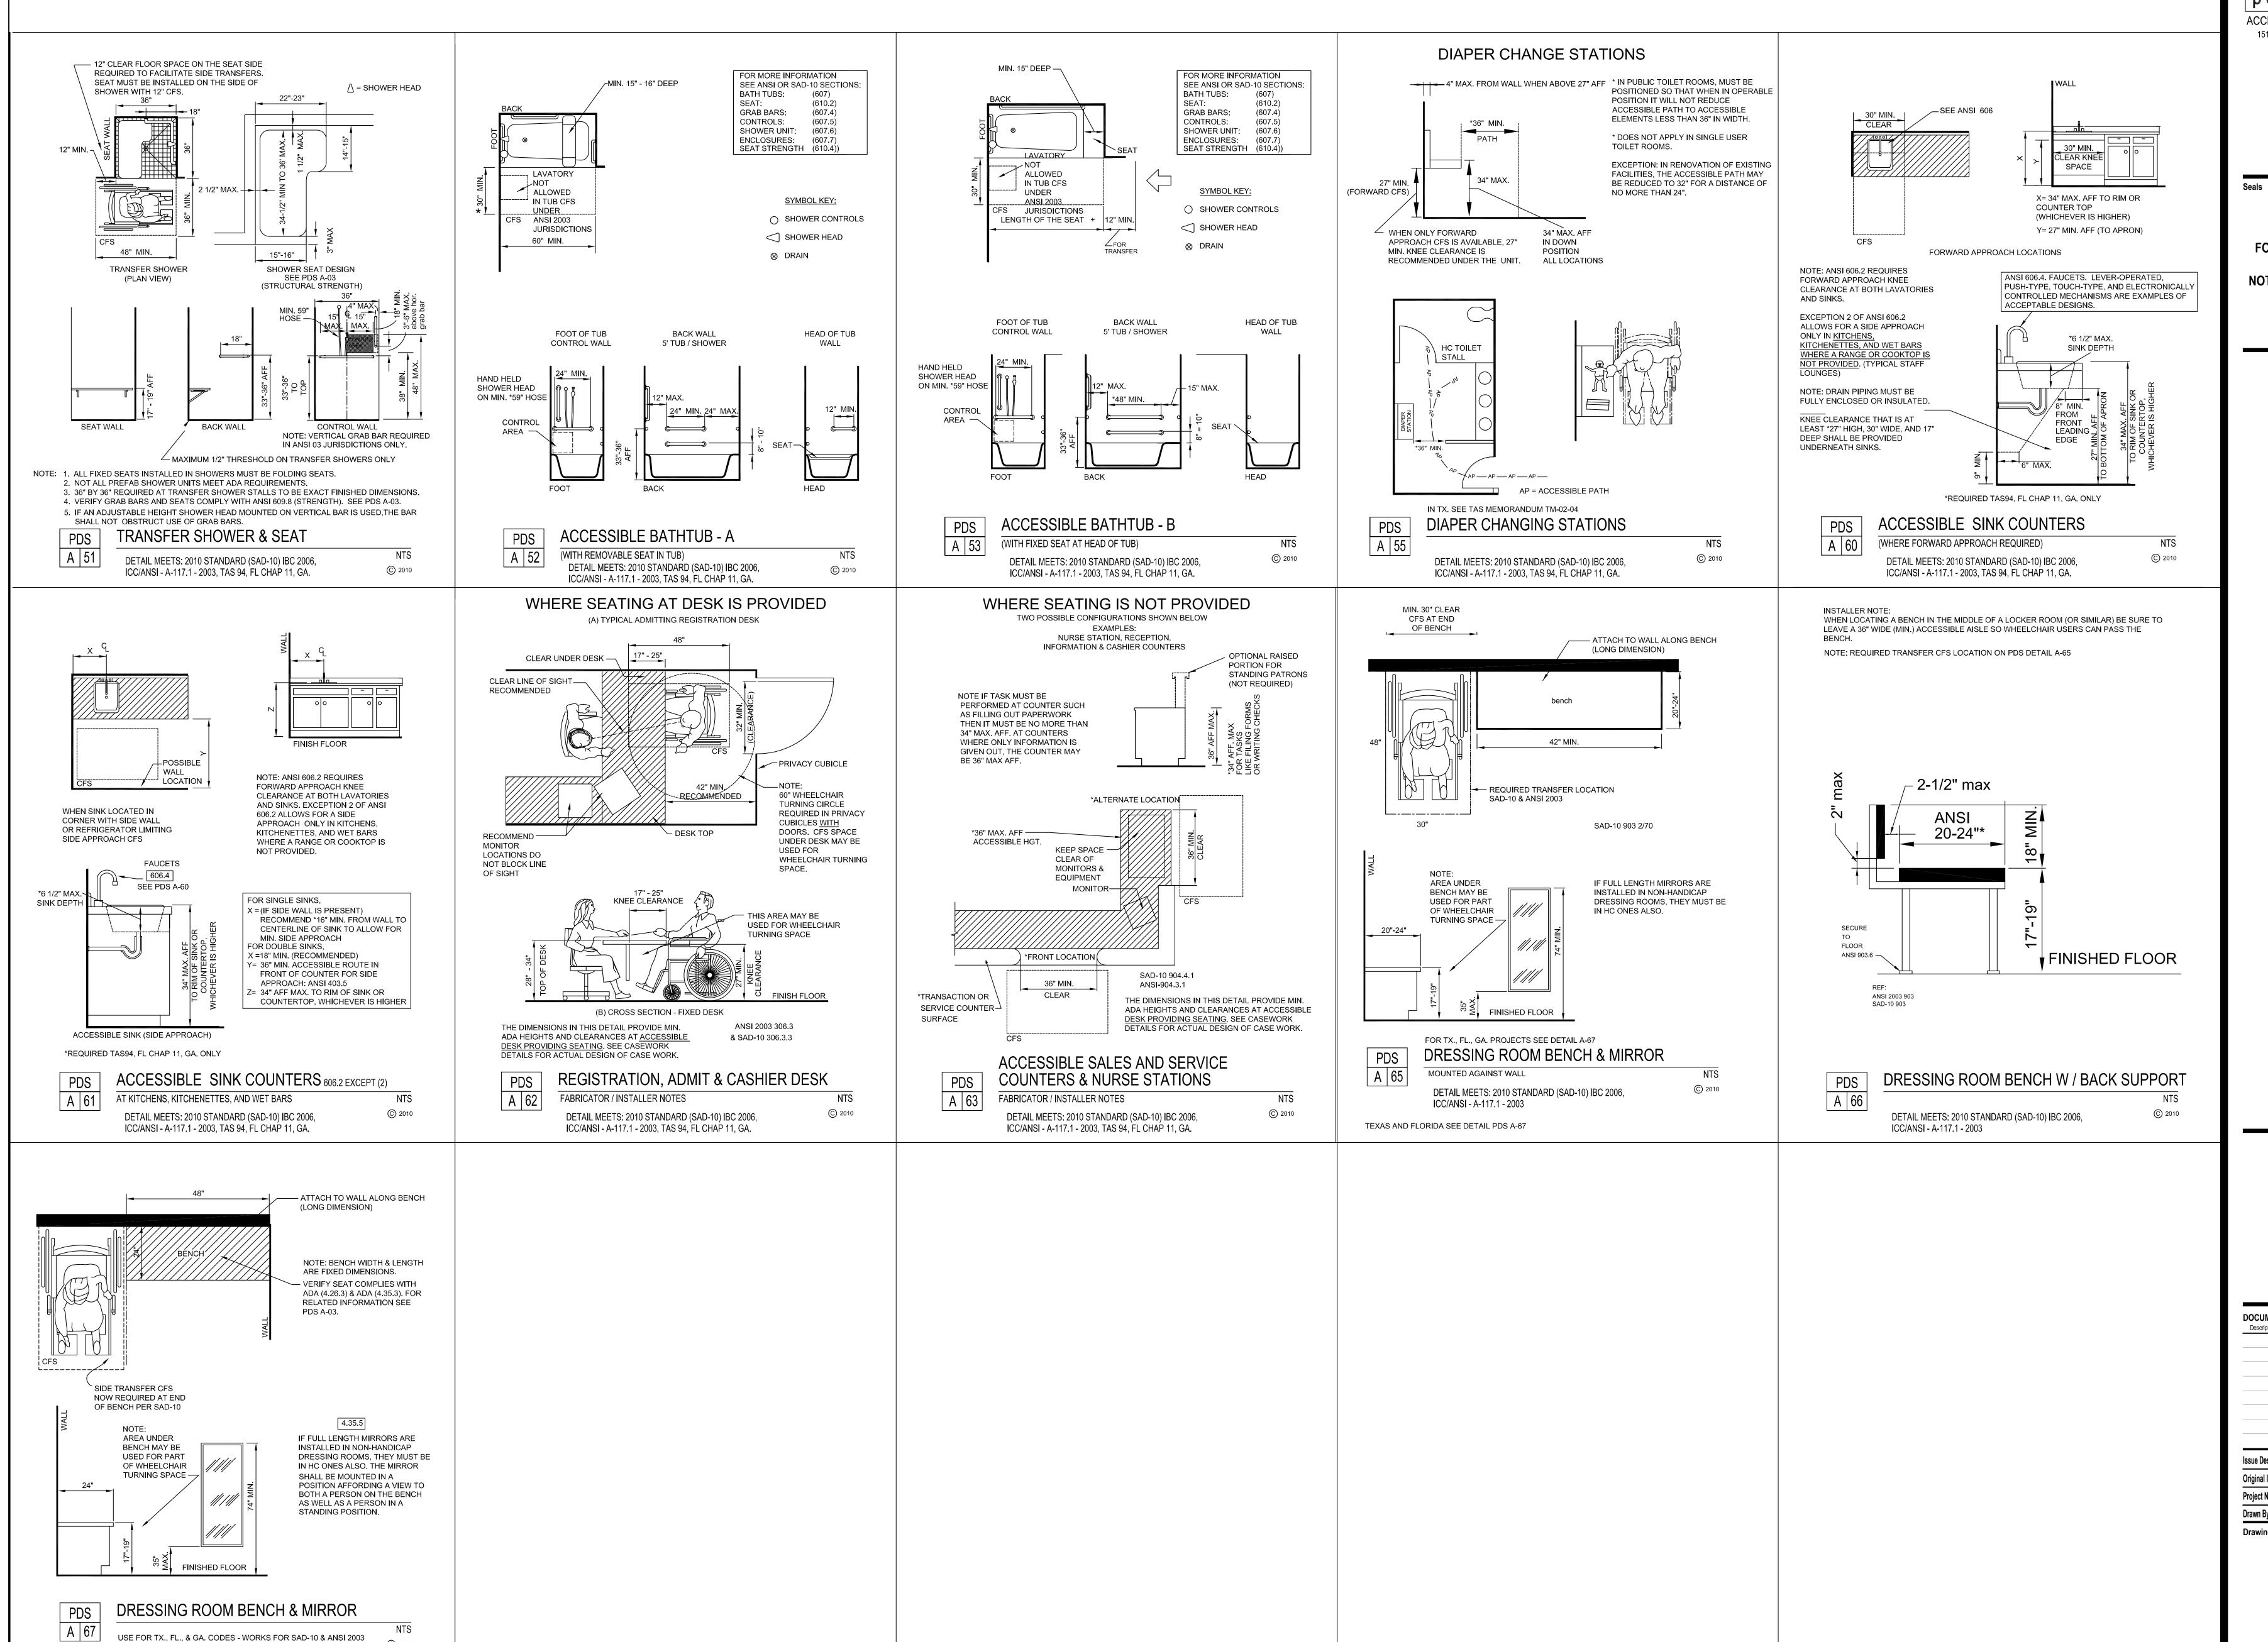

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FOR REFERENCE ONLY

NOT FOR CONSTRUCTION

RENOVATIO EMERGI

DOCUMENT CHANGES

Issue Description

DALLAS ST. ERP 09/20/17 Original Issue Date 16072.00 Drawn By JMR Checked By JMR

> **ACCESSIBILITY DETAILS**


PDS-04

ERP Issue Description


09/20/17 Original Issue Date 16072.00 Project No Drawn By CH.S Checked By JP

FOUNDATION/ DRILL PIER FRAMING PLAN-DALLAS STREET **ENTRY**

S1.01

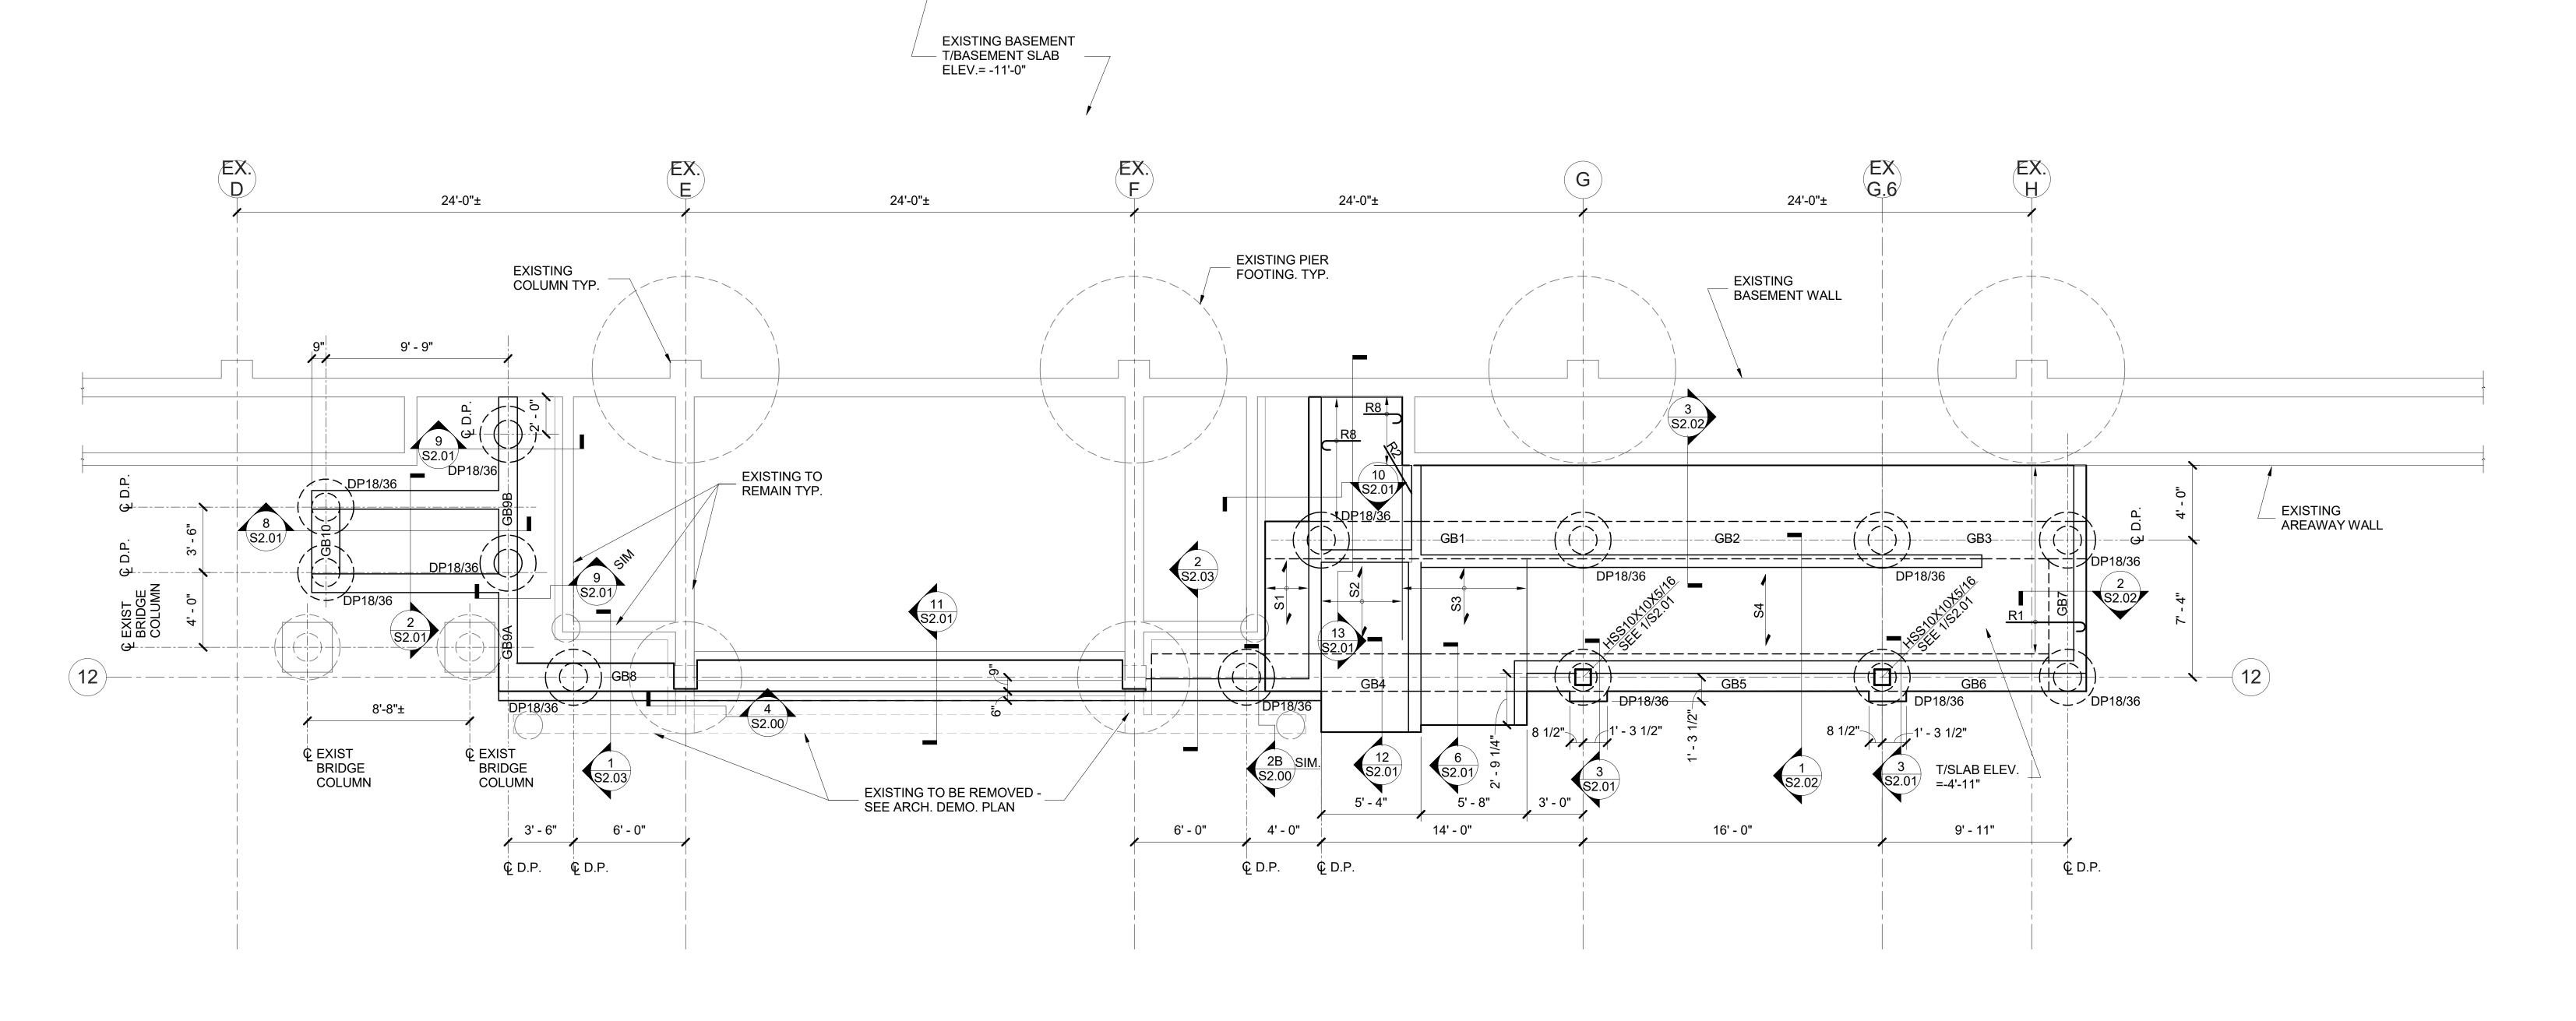



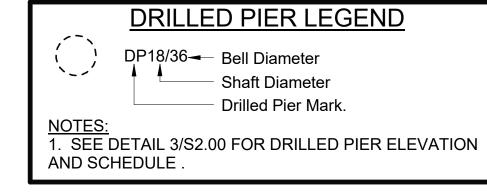


FOUNDATION NOTES

- 1. CONTRACTOR SHALL FIELD VERIFY ALL DIMENSION AND CONDITION RELATED TO THE EXISTING BUILDING PRIOR TO
- BEGINING CONTRACTION OR FABRICATION 2. EXISTING STRUCTURE IS SHOWN "SCREENED"
- 3. SEE ARCHITECTURAL DWGS. FOR DIMENSION NOT SHOWN. 4. SEE 1/S2.00 FOR GRADE BEAM SCHEDULE AND DETAILS 5. SEE S3.00 FOR CONCRETE SLAB SCHEDULE, REINFORCEMENT
- SCHEDULE AND DETAILS **1ST FLOOR KEY PLAN**

RAMP & VESTIBULE FRAMING PLANS-DALLAS STREET **ENTRY**

S1.02

1ST FLOOR KEY PLAN

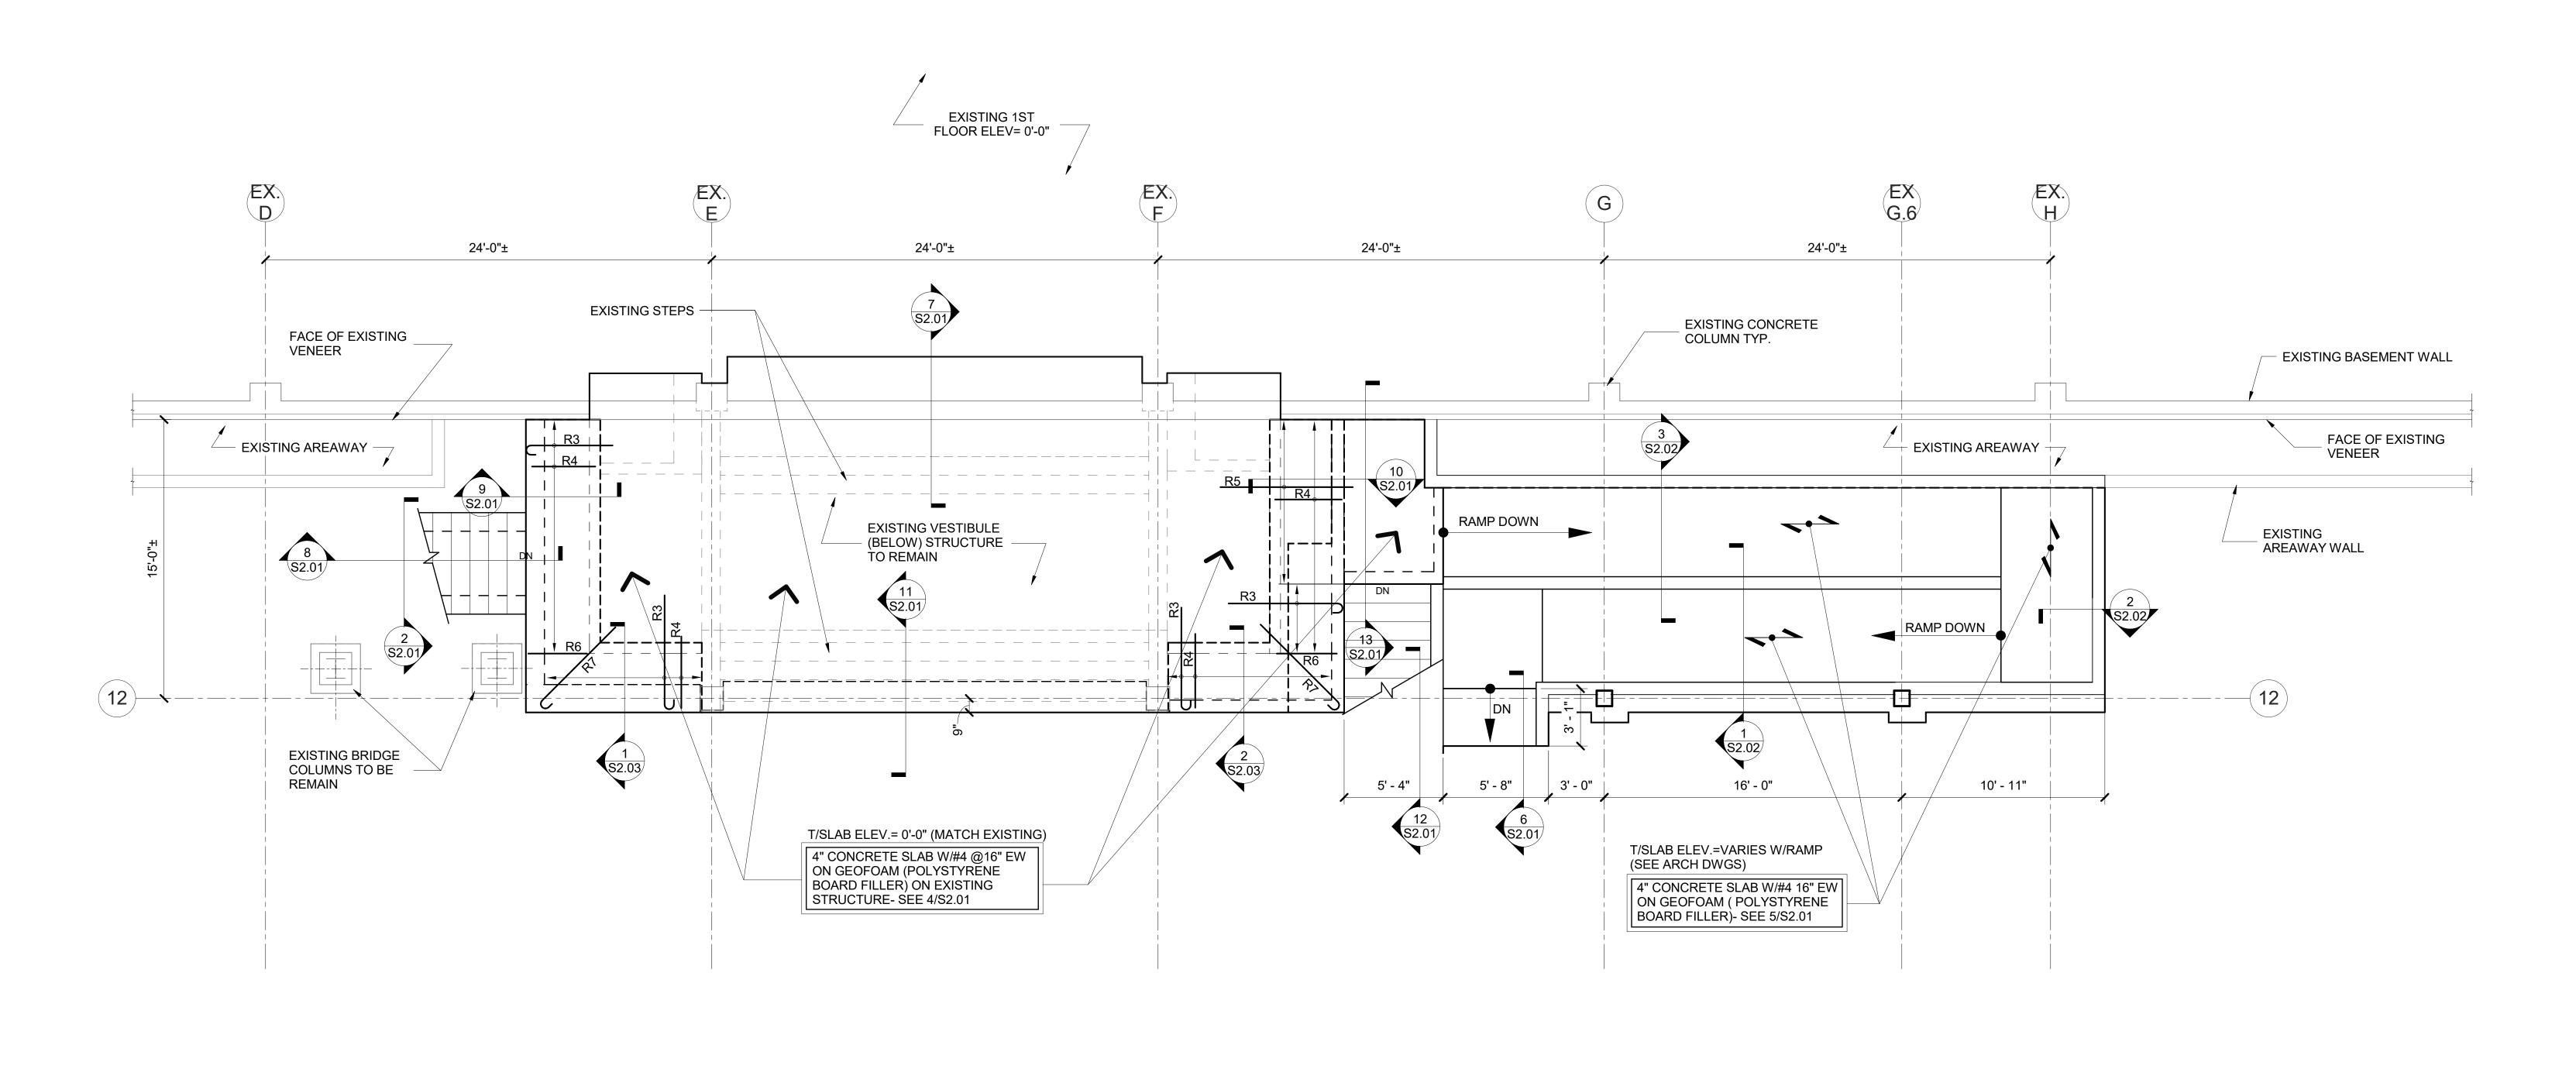



FOUNDATION NOTES

- 1. CONTRACTOR SHALL FIELD VERIFY ALL DIMENSION AND CONDITION RELATED TO THE EXISTING BUILDING PRIOR TO BEGINING CONTRACTION OR FABRICATION 2. EXISTING STRUCTURE IS SHOWN "SCREENED"
- 3. SEE ARCHITECTURAL DWGS. FOR DIMENSION NOT SHOWN. 4. SEE 1/S2.00 FOR GRADE BEAM SCHEDULE AND DETAILS
- 5. SEE S3.00 FOR CONCRETE SLAB SCHEDULE, REINFORCEMENT SCHEDULE AND DETAILS


MEDIC/

Issue Description ERP 09/20/17 Original Issue Date 16072.00 Project No Drawn By CH.S Checked By JP

> **CANOPY FRAMING PLAN- DALLAS**

STREET ENTRY

S1.03 1ST FLOOR KEY PLAN

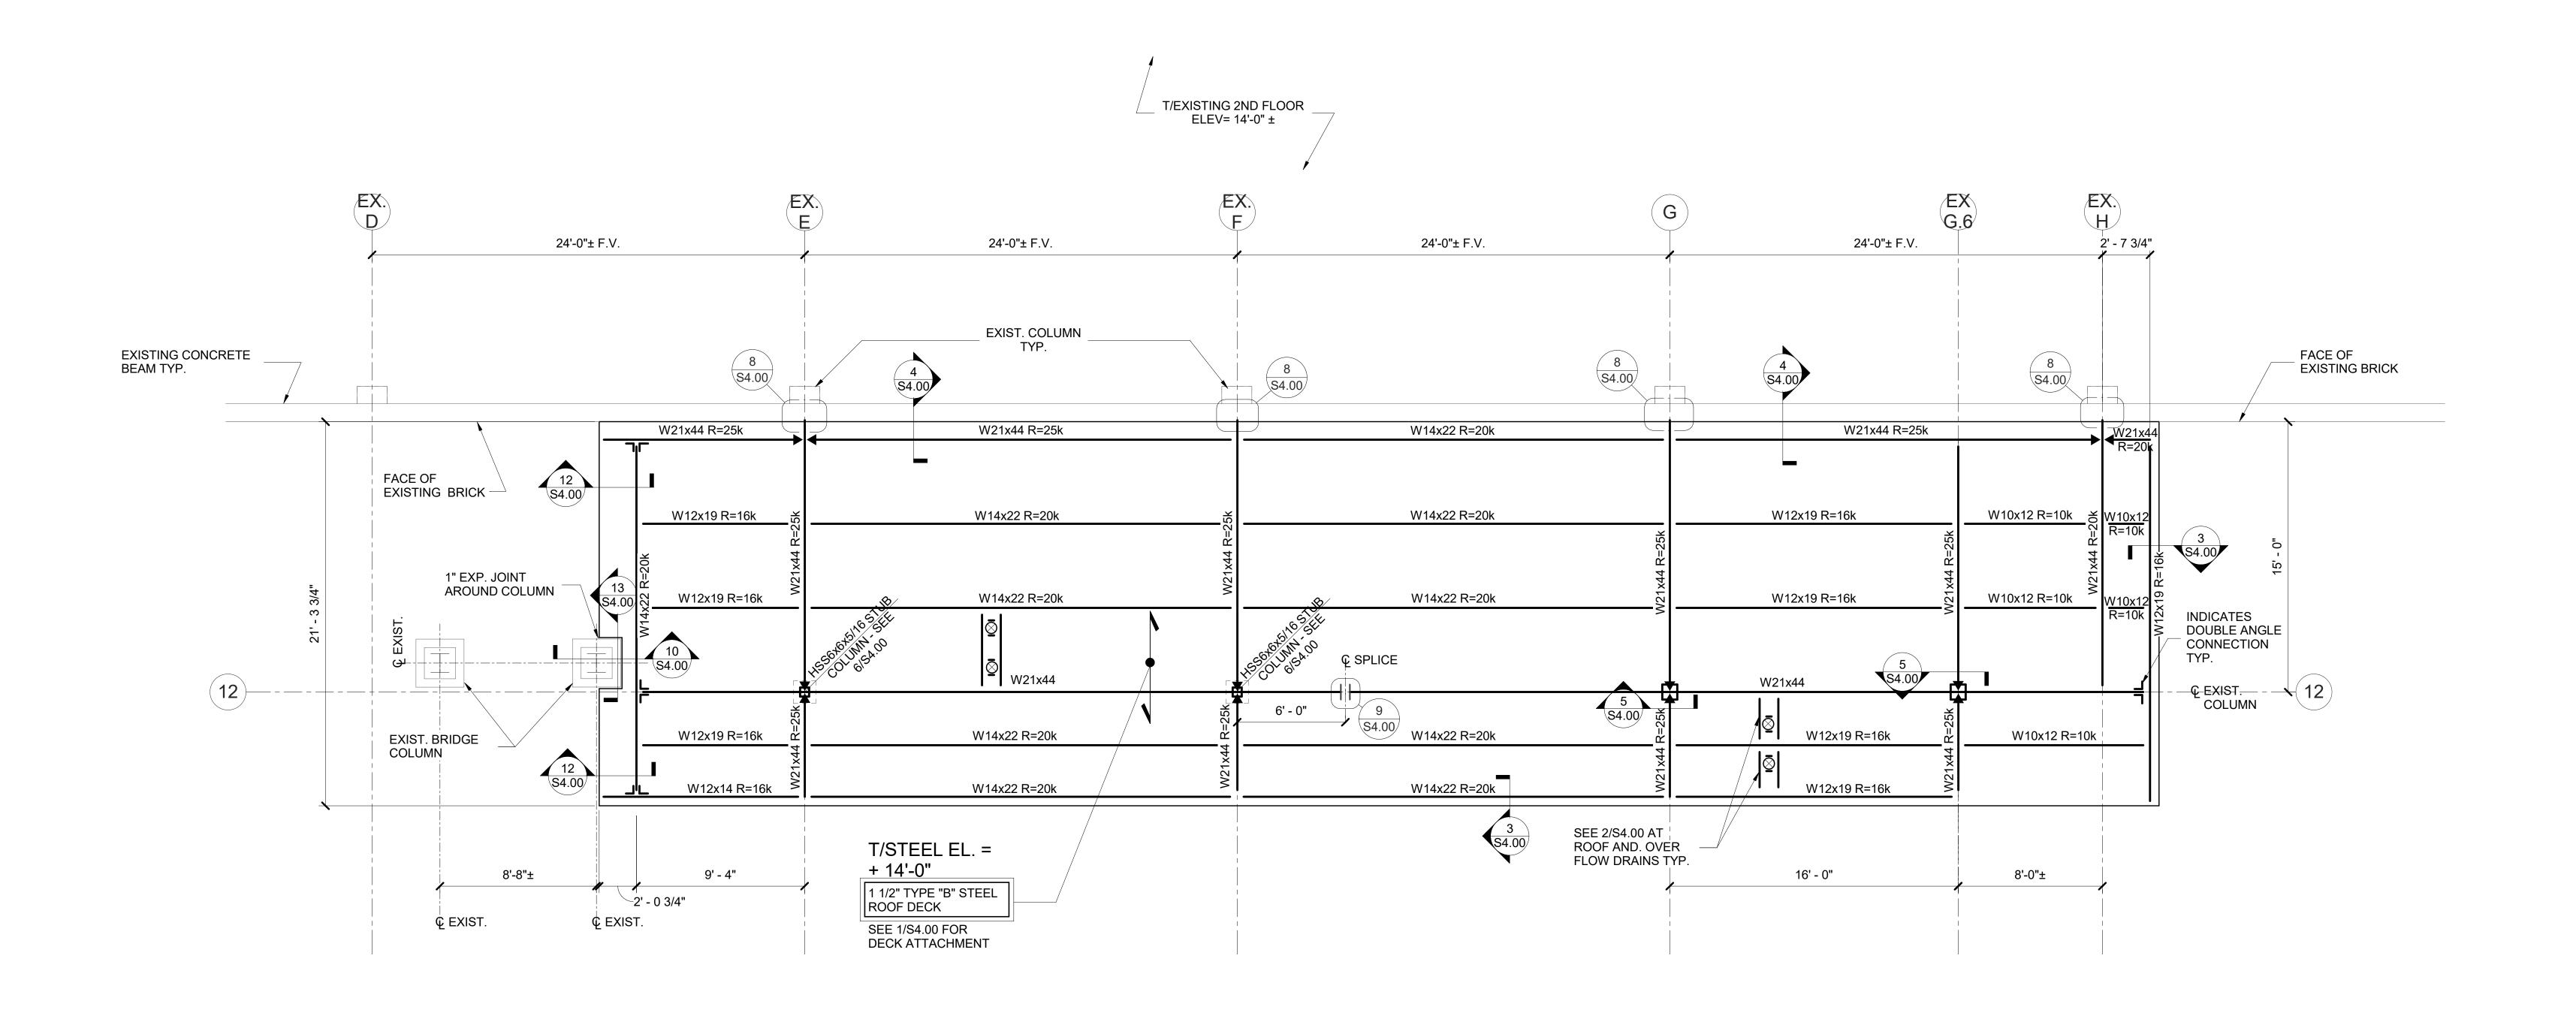



FRAMING NOTES

- 1. CONTRACTOR SHALL FIELD VERIFY ALL DIMENSIONS AND CONDITIONS RELATED TO THE EXISTING BUILDING PRIOR TO BEGINNING CONSTRUCTION OR FABRICATION
- 3. SEE ARCHITECTURAL DWGS FOR DIMENSIONS NOT SHOWN.
- 2. EXISTING STRUCTURE IS SHOWN " SCREENED"
- 4. SPACE BEAMS EQUALLY IN COLUMNS BAYS, U.N.O.
- 5. → DENOTES WELD THRU MOMENT CONNECTION- SEE 7/S4.00

Bender

Wells

EMER

DOCUMENT CHANGES


Original Issue Date Project No

PRESERVATION



Issue Description CONSTRUCTION DOCUMENTS 16072.00 BV Checked By LCC **Drawing Title**

TP1.00

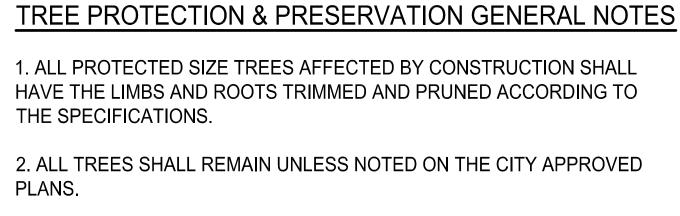

3. NO DISTURBANCE SHALL OCCUR IN THE ROOT PROTECTION ZONE

4. NO CONSTRUCTION SHALL BEGIN IN AREAS WHERE TREE PRESERVATION AND TREATMENT MEASURES HAVE NOT BEEN COMPLETED AND APPROVED.

5. TREE PROTECTION FENCING SHALL BE REQUIRED. TREE PROTECTION FENCING SHALL BE INSTALLED, MAINTAINED AND REPAIRED BY THE CONTRACTOR DURING SITE CONSTRUCTION.

THE CONTRACTOR SHALL AVOID CUTTING ROOTS LARGER THAN ONE-INCH IN DIAMETER WHEN EXCAVATING NEAR EXISTING TREES. EXCAVATIONS IN THE VICINITY OF TREES SHALL PROCEED WITH CAUTION. THE CONTRACTOR SHALL CONTACT THE CITY INSPECTOR FOR GUIDANCE.

7. EXPOSED ROOTS SHALL BE COVERED AT THE END OF THE WORK DAY USING TECHNIQUES SUCH AS COVERING WITH SOIL. MULCH OR WET BURLAP.

8. NO, EQUIPMENT, VEHICLES OR MATERIALS SHALL BE OPERATED OR STORED WITHIN THE ROOT PROTECTION ZONE OF ANY TREE NEAR THE PROJECT. THE ROOT PROTECTION ZONE FOR ALL PROTECTED TREES SHALL BE AN 8 FOOT DIAMETER (MIN.) ROOT PROTECTION ZONE.

9. ROOT OR BRANCHES IN CONFLICT WITH CONSTRUCTION SHALL BE CUT CLEANLY ACCORDING TO PROPER PRUNING METHODS. ALL OAK WOUNDS SHALL BE PAINTED WITHIN 30 MINUTES TO PREVENT 'OAK WIL INFECTION.

10. ANY TREE REMOVAL SHALL BE APPROVED BY THE CITY ARBORIST.

11. TREES WHICH ARE DAMAGED OR LOST DUE TO THE CONTRACTOR'S NEGLIGENCE DURING CONSTRUCTION SHALL BE MITIGATED TO THE CITY'S SATISFACTION.

12. TREES, TREE LIMBS, BUSHES AND SHRUBS LOCATED IN THE STREET OR ALLEY RIGHT-OF-WAY OR PAVEMENT EASEMENTS WHICH INTERFERE WITH PROPOSED CONSTRUCTION ACTIVITIES MAY BE NEATLY TRIMMED BY THE CONTRACTOR ONLY AFTER APPROVAL FROM THE INSPECTOR

13. SAPLINGS, SHRUBS, OR BUSHES TO BE CLEARED FROM THE PROTECTED ROOT ZONE AREA OF A PROTECTED TREE SHALL BE REMOVED BY HAND AS DESIGNATED BY THE INSPECTOR.

14. ALL DEBRIS GENERATED BY THE PRUNING AND REMOVAL OF THE CONTRACTOR AND SHALL BE DISPOSED OF PROPERLY.

IRRIGATION NOTE:

ROOT PROTECTION ZONE.

1. THE FENCING SHOWN ABOVE IS DIAGRAMATIC ONLY AND WILL

2. FOR ACCEPTABLE FENCING MATERIALS SEE SPECIFICATIONS.

ROOT PROTECTION ZONE-THE ROOT PROTECTION

ZONE IS A CIRCULAR AREA AROUND A TREE THAT IS BASED ON THE DIAMETER OF THE TREE. EACH 1 INCH

DIAMETER OF THE TREE EQUALS 1 FOOT RADIUS FOR

TREE PROTECTION FENCING

CONFORM TO THE DRIP LINE AND LIMITED TO PROJECT BOUNDARY.

ROOT PROTECTION

ZONE (RPZ)

6" MULCH INSIDE RPZ

UNDERSTORY OR TURF

WHEN THERE IS NO EXISTING

TREE CANOPY

THE EXISTING IRRIGATION SYSTEM SPRAY HEADS AND LATERAL LINES SHALL BE ADJUSTED AND MODIFIED IN THE FIELD TO PROVIDE FULL COVERAGE TO ALL EXISTING AND PROPOSED PLANTING AREAS. UTILIZE EXISTING CONTROLLER.

THE CONTRACTOR SHALL PROVIDE SHOP DRAWINGS OF PROPOSED ADJUSTMENTS TO THE EXISTING IRRIGATION SYSTEM, SHOWING ALL CONNECTIONS TO EXISTING SYSTEM, LOCATIONS, AND SIZES OF ALL PIPES, WIRING, VALVES, HEADS, AND FITTINGS NECESSARY FOR PERMITTING AND THE INSTALLATION OF THE WORK. APPROVAL OF DRAWINGS BY THE LANDSCAPE ARCHITECT MUST BE OBTAINED PRIOR TO BEGINNING CONSTRUCTION.

HYDRAULIC DESIGN AND SELECTION OF PRODUCTS SHALL BE CONSISTENT WITH THE CHARACTER AND PATTERN OF THE EXISTING IRRIGATION SYSTEM

THE CONTRACTOR SHALL MAINTAIN AT THE JOB SITE A SEPARATE SET OF PRINTS OF THE PROJECT FOR THE PURPOSE OF RECORDING "AS-BUILT" CHANGES AND DIAGRAMS OF THOSE PARTS OF THE WORK WHERE ACTUAL CONSTRUCTION DIFFERS FROM APPROVED SHOP DRAWINGS.

ALL SPRAY HEADS AND ELECTRIC VALVES TO BE AS MFG. BY WEATHERMATIC, OR APPROVED SUBSTITUTION. ALL DRIP IRRIGATION PRODUCTS TO BE AS MFG. BY PEPCO PRODUCTS OR APPROVED SUBSTITUTION.

PLANT SCHEDULE

	Key	Qty.	Common Name	Botanical Name	Size / Remarks
	SHR	UBS			
+	—GLIR —LIR —NAN	44 25 15	Giant Liriope Liriope Nandina	Liriope gigantea Liriope muscari Nandina domestica	1 gal. 1 gal. 5 gal.

APPURTENANCES

Bedding / Shrub areas: A minimum of 8" soil amendments. (Approx. 1,500sf) SOIL HARDWOOD NATIVE MULCH: minimum 4" depth (Approx. 2,084 sf) MULCH

(by Keller Materials or approved substitution.)

(Contractor shall verify/determine quantity required in the field.)

TREE INVENTORY **Understory Species** Significant Tree Significant Tree** Preserved for 10.0" - 23.5" 6" - 23.5" Heritage 3:1 Removed | Preserved | Preserved 08 20" live oak 09 27" live oak 23" live oak Sub. Tot. Inches= Total inches by category= reservation percentage= Significant Preservation Heritage Preservation tigation required (Commercial) = itigation required (Residential) = Residential (inches) Heritage Mitigation (inches) No category to fall below 10% preservation Preserved- Tree to remain that meets root protection zone requirements described in section 35-523 of the UDC. Mitigation 1:1 for significant trees below minimum preservation requirements; 3:1 for heritage trees below 100% preservation * Small species: Condalia, Redbud, Tx. Mountain Laurel, Tx. Persimmon, Hawthorn, Possumhaw - these are mitigated at 1:1 for Heritage Trees ** Ashe Juniper, Huisache, Mesquite, Arizona Ash, Hackberry protected at 10" dbh and mitigated at 1:1 for heritage trees *** Mitigation Trees; Unprotected-sized trees to be used for mitigation calculations; subtract inches from mitigation owed

COBBLE TO BE REMOVED MULCH (830sf) **GLIR**(20) EXISTING COBBLE & LIRIOPE-TO REMAIN PROTECTED. FILL IN GAPS AS NEEDED. QUANTITY T.B.D. IN THE FIELD. APPROX. (15) LIR

FENCING (180 If**EXISTING COBBLE &**

NOTE:

NOTE:

107: 30" LIVE OAK TO-

IN PLACE

GLIR(44)

MULCH-

(804sf)

PRESERVATION

REMAIN PROTECTED

LIRIOPE TO REMAIN PROTECTED (450sf)

STOCKPILE-

TREE PROTECTION PLAN SCALE 1" = 10'-0"

CONTRACTOR IS RESPONSIBLE FOR THE LOCATION AND MARKING OF ALL EXISTING UNDERGROUND OR ABOVE GROUND UTILITIES WITHIN THE PROJECT AREA.

ALL PLANTING SHALL BE SET OUT IN THE FIELD (STILL IN CONTAINERS) FOR APPROVAL OF LAYOUT PRIOR TO INSTALLATION.

CAMDEN STREET

 $^{\downarrow}_{\text{W}} \otimes \otimes_{\text{V}}$

10000(X)

CAMDEN STREET

A LICENSED ARBORIST SHALL BE HIRED TO PREPARE TREES 108 & 109 FOR CONSTRUCTION AND MONITOR AND MAINTAIN TREES THROUGHOUT CONSTRUCTION.

EXISTING NANDINA TO REMAIN PROTECTED

FILL IN GAPS AS NEEDED, QUANTITY T.B.D. IN

-EXISTING COBBLE & LIRIOPE TO REMAIN

EXISTING NANDINA TO REMAIN PROTECTED.

FILL IN GAPS AS NEEDED, QUANTITY T.B.D. IN

PROTECTED. FILL IN GAPS AS NEEDED,

QUANTITY T.B.D. IN THE FIELD.

THE FIELD. APPROX. (6) NAN

108: 20" LIVE OAK TO REMAIN.

FENCING (70 If)

SEE NOTE BELOW.

TO BE COUNTED AS REMOVED BUT

SHALL REMAIN PROTECTED IN PLACE

TREE PRESERVATION

-109: 27" LIVE OAK TO REMAIN, IF AT ALL

IF AT ALL POSSIBLE. CONSULT WITH

-110: 23" LIVE OAK TO REMAIN

THE FIELD. APPROX. (6) NAN

PROTECTED IN PLACE

POSSIBLE. TO BE COUNTED AS REMOVED

BUT SHALL REMAIN PROTECTED IN PLACE.

ARBORIST AND LANDSCAPE ARCHITECT.

APPROX. (10) LIR

-NAN(3)

MITIGATION NOTE:

NOTE:

TREES 108 AND 109 WILL HAVE CONSTRUCTION WITHIN THEIR RPZ (ROOT PROTECTION ZONES). DUE TO THE RPZ BEING COMPROMISED, TREES 108 AND 109 CANNOT BE COUNTED AS PRESERVED AND MUST BE COUNTED AS REMOVED. HOWEVER, TREES 108 AND 109 SHALL REMAIN IN PLACE AND BE PROTECTED THROUGHOUT CONSTRUCTION IF AT ALL POSSIBLE.

REQUIRED MITIGATION = 81" (at \$200 per inch) = \$16,200

\$16,200 WILL BE PAID BY THE OWNER INTO THE CITY TREE FUND.

SEE EARLY RELEASE PACKAGE FOR ALL WORK RELATED TO DALLAS STREET ENTRANCE Earl Swensson Associates, Inc.
richard I. miller, architect
1033 Demonbreun Street
Suite 800
Nashville Tennessee 37203
615-329-9445

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Seals



EMERGENCY DEPARTMENT RENOVATI

DOCUMENT CHANGES

Description Date

Issue Description CONSTRUCTION DOCUMENTS
Original Issue Date 10/11/17
Project No 16072.00
Drawn By JMR Checked By JMR

Prawing Title


FIRST FLOOR ORIENTATION PLAN

Sheet Number
A1.01


1ST FLOOR KEY PLAN

1ST FLOOR PLAN - OVERALL
SCALE: 1/16" = 1'-0"

Dallas

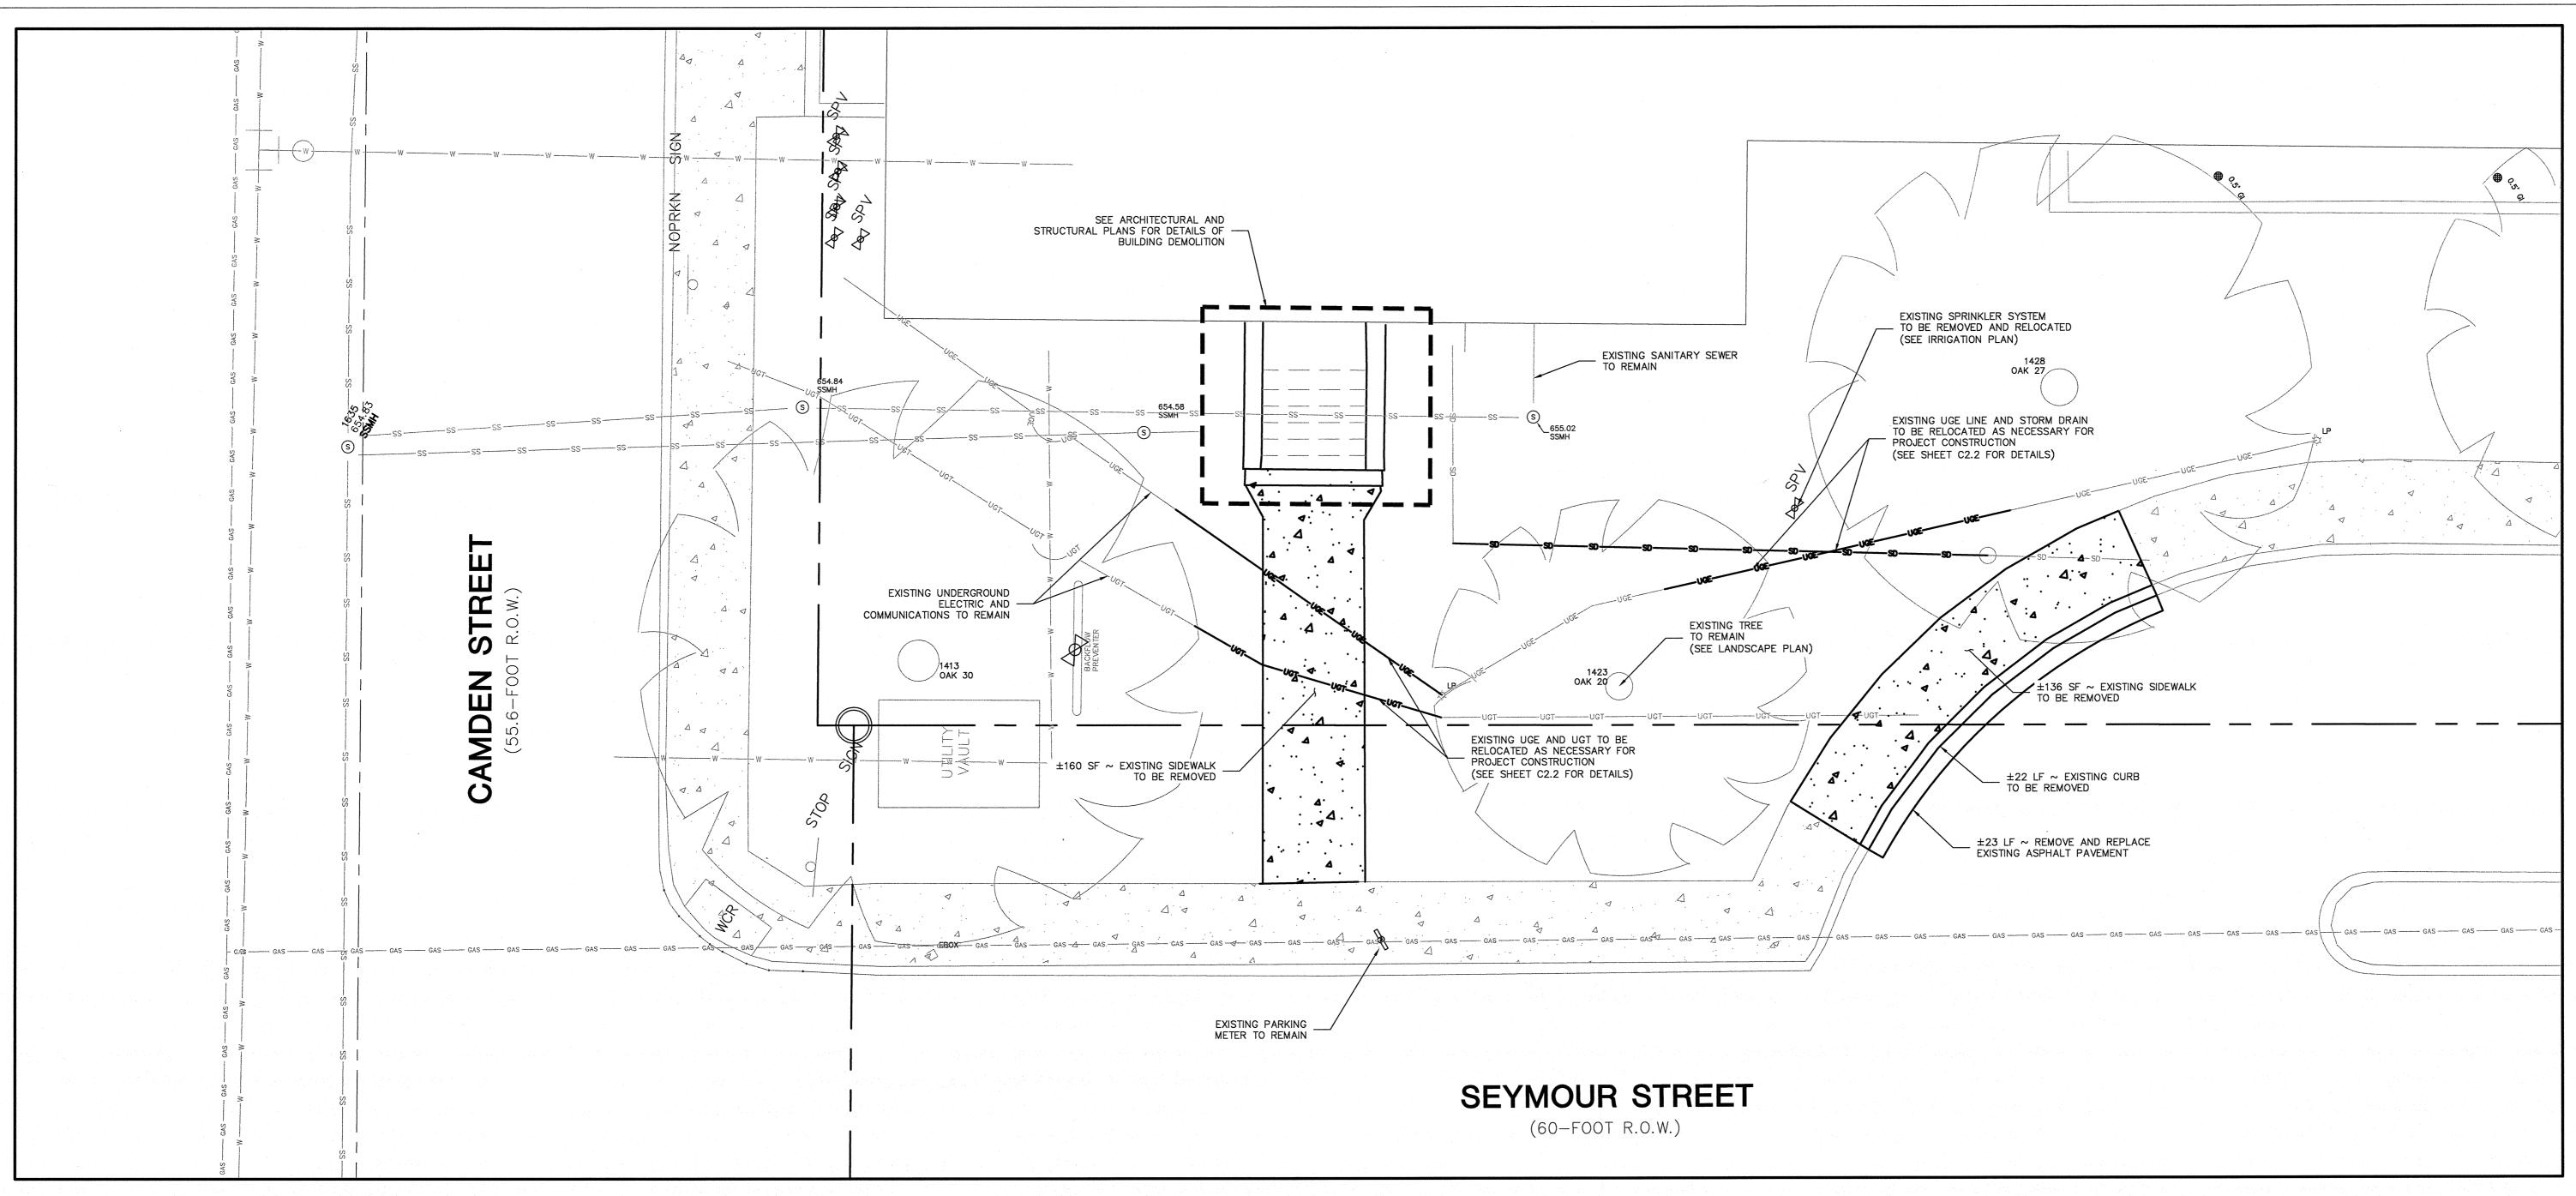

DEMOLITION PLAN

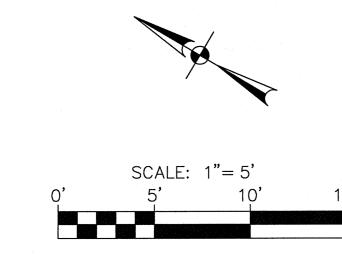

LEGEND

PROPERTY LINE

SID SID UNDERGROUND ELECTRIC

EXISTING UNDERGROUND COMMUNICATION

PROPOSED STORM DRAIN

W/ CLEANOUT

W/ CLEANOUT
PROPOSED ELECTRIC LINE
PROPOSED COMMUNICATION LINE

EXISTING SIDEWALK

SIDEWALK TO BE DEMOLISHED

PROPOSED SIDEWALK

DEMOLITION NOTES:

- THE CONTRACTOR SHALL BE RESPONSIBLE FOR ACQUIRING ALL NECESSARY PERMITS/APPROVALS BEFORE BEGINNING DEMOLITION.
 THE CONTRACTOR SHALL BE RESPONSIBLE FOR REMOVING FROM THE SITE ALL ITEMS SHOWN TO BE DEMOLISHED UNLESS OTHERWISE INDICATED. ALL MATERIALS SHALL BE DEMOLISHED AND REMOVED FROM SITE IN ACCORDANCE WITH ALL APPLICABLE, FEDERAL, STATE AND LOCAL REGULATIONS.
- 3. ALL EXISTING ITEMS NOT SPECIFICALLY NOTED TO BE DEMOLISHED SHALL REMAIN. CONTRACTOR IS RESPONSIBLE FOR REPLACING EXISTING ITEMS REMOVED DURING DEMOLITION THAT WERE TO REMAIN.
- 4. CONTRACTOR IS RESPONSIBLE FOR COORDINATION WITH ALL UTILITY COMPANIES REGARDING REMOVAL OF EXISTING SERVICES, POWER POLES TO BE REMOVED, VERIFYING UTILITIES ARE SHUT OFF OR DISCONNECTED, AND THAT ALL POSSIBLE SAFETY PRECAUTIONS HAVE BEEN ENACTED TO ENSURE THE SAFEST ENVIRONMENT FOR ALL PERSONNEL.
- 5. LOCATION AND DEPTH OF EXISTING UTILITIES SHOWN HEREON ARE APPROXIMATE ONLY. ACTUAL LOCATIONS AND DEPTHS MUST BE VERIFIED BY THE CONTRACTOR PRIOR TO THE CONSTRUCTION AND THE CONTRACTOR SHALL BE RESPONSIBLE FOR THE PROTECTION OF ALL UTILITIES, WHETHER SHOWN ON THE PLANS OR NOT, THROUGHOUT ALL PHASES OF CONSTRUCTION.

6. ALL NECESSARY EROSION CONTROL MEASURES ARE TO BE IN PLACE

- PRIOR TO CONSTRUCTION. EROSION CONTROL MEASURES ARE TO BE MAINTAINED AND IN WORKING CONDITION AT ALL TIMES.

 7. THE CONTRACTOR SHALL SAW CUT EXISTING PAVEMENT, CURBS AND SIDEWALKS AT NEW PAVEMENT, CURB AND SIDEWALK JUNCTURES, NO JAGGED OR IRREGULAR CUTS WILL BE ACCEPTED.
- 8. THE CONTRACTOR SHALL PROTECT ALL PROPERTY PINS, BENCH MARKS, CONSTRUCTION STAKES, HUBS, OR OTHER KEY CONTROL POINTS. THE CONTRACTOR SHALL BE RESPONSIBLE TO RE—ESTABLISH ANY SUCH POINTS AT THEIR OWN EXPENSE.
- 9. CONTRACTOR SHALL NOT DEMOLISH ANY PUBLIC WATER OR SANITARY SEWER LINES WITHOUT APPROVAL. EXISTING WATER AND SANITARY SEWER SERVICES SHALL REMAIN OPERATIONAL UNTIL NEW SERVICE IS COMPLETE. CUT AND CAP ANY ABANDONED SANITARY SEWER AND WATER SERVICES AT THE EXISTING MAIN. NO ABANDONED SERVICES SHALL REMAIN CONNECTED TO THE PUBLIC MAIN.
- 10. THE USE OF EXPLOSIVES WILL NOT BE PERMITTED.
- 11. THE CONTRACTOR SHALL BE REQUIRED TO LOCATE ALL PUBLIC OR PRIVATE UTILITIES INCLUDING BUT NOT LIMITED TO: WATER, SEWER, TELEPHONE, FIBER OPTIC LINES, SITE LIGHTING ELECTRIC, SECONDARY ELECTRIC, PRIMARY ELECTRICAL DUCT BANKS, LANDSCAPE IRRIGATION FACILITIES, AND GAS LINES. ANY UTILITY CONFLICTS THAT ARISE SHOULD BE COMMUNICATED TO THE ENGINEER IMMEDIATELY AND PRIOR TO CONSTRUCTION. THE CONTRACTOR SHALL CONTACT 1-800-DIG-TESS A MINIMUM OF 48 HOURS PRIOR TO THE START OF CONSTRUCTION. ANY DAMAGE TO EXISTING UTILITIES SHALL BE THE SOLE RESPONSIBILITY OF THE CONTRACTOR AND THE REPAIR SHALL BE AT THE CONTRACTORS SOLE EXPENSE WHETHER THE UTILITY IS SHOWN ON THESE PLANS OR NOT.
- 12. THE CONTRACTOR SHALL MAINTAIN THE SITE IN A CLEAN AND ORDERLY MANNER.
- 13. THE CONTRACTOR SHALL MEET ALL LOCAL, STATE, AND FEDERAL REGULATIONS FOR DUST CONTROL. THE CONTRACTOR SHALL BE RESPONSIBLE AT THEIR OWN EXPENSE FOR ANY FUGITIVE DUST ON ADJOINING PROPERTIES.


NOTES:

- 1. THE CONTRACTOR SHALL PROVIDE ALL TRAFFIC CONTROL REQUIRED BY THE CITY FOR THE CONSTRUCTION OF THIS PROJECT. THE CONTRACTOR SHALL PREPARE TRAFFIC CONTROL PLANS TO BE SUBMITTED TO THE CITY.
- 2. THE CONTRACTOR SHALL OBTAIN RIGHT-OF-WAY PERMITS AND SIDEWALK PERMITS AS REQUIRED FOR THE CONSTRUCTION.



ITONIO I AUSTIN I HOUSTON I FORT WORTH I DALLAS W LOOP 410 I SAN ANTONIO. TX 78213 I 210.375.9000

TBPE FIRM REGISTRATION #470 | TBPLS FIRM REGISTRATION #10028800

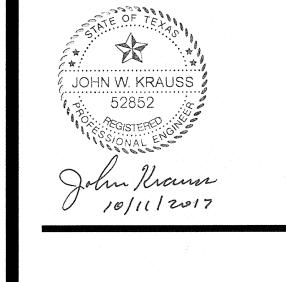

DEMOLITION PLAN

MC Checked By JK

C2.0

Drawn By

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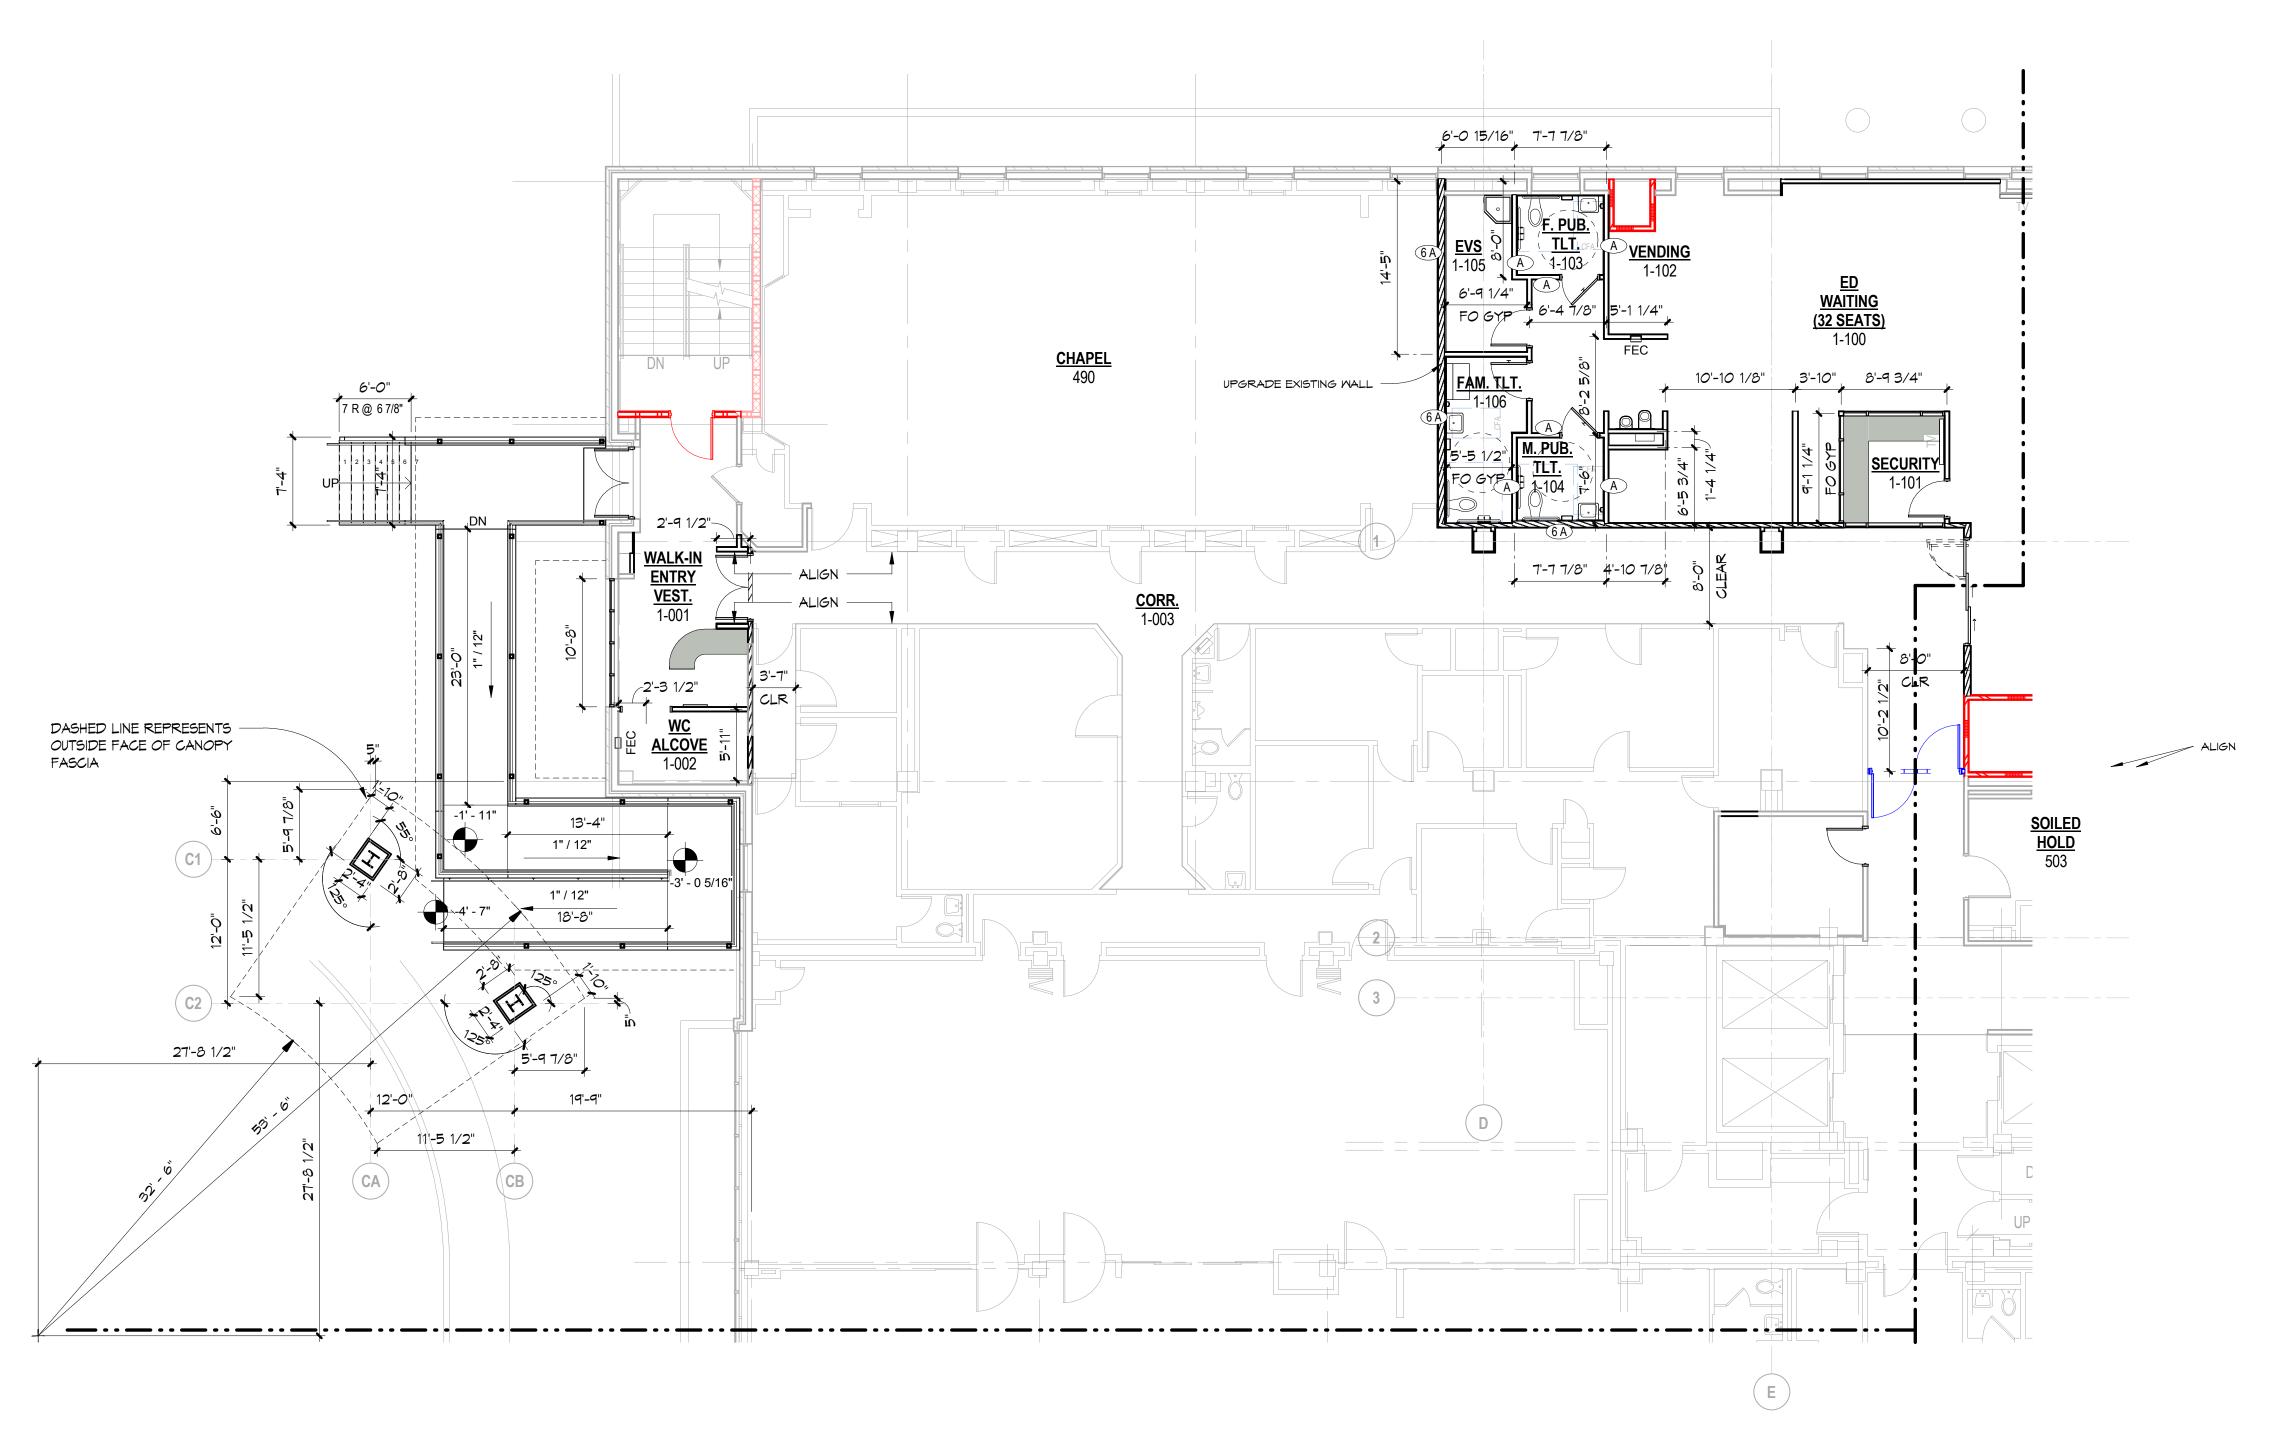
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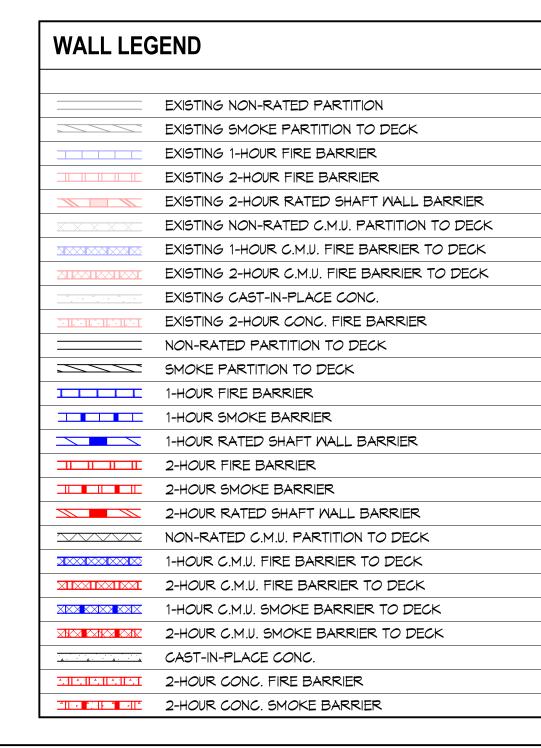
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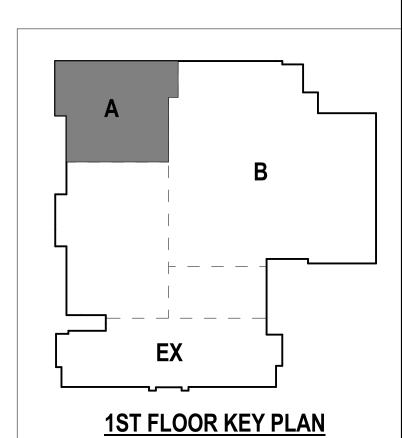
1ST FLOOR PLAN - PART A - DIMENSIONED

SCALE: 1/8" = 1'-0"



		LLS AND FURROUTS TO BE CONSTRUCTED WITH 3 5/8" METAL STUD DTED WITH TAGS BELOW.
0	5/8" GYP. BD.	ON 7/8" METAL FURRING OVER CONCRETE OR CMU SUBSTRATE
1	1 5/8" METAL	STUDS
2	2 1/2" METAL	STUDS
4_	4" METAL STU	DS OR CMU
6_	6" METAL STU	DS OR CMU
8_	8" METAL STU	DS, CMU OR CONCRETE
	SIONED NOTE:	
TO TH	E CENTERLINE C	ION LAYOUT, ALL STANDARD DRYWALL PARTITIONS ARE DIMENSIONED THE STUD. CHASES, SHAFTWALL AND CMU WALLS ARE DIMENSIONI TO FINISHED FACE. EXISTING WALLS ARE DIMENSIONED TO THE
TO TH	E CENTERLINE C FINISHED FACE	OF THE STUD. CHASES, SHAFTWALL AND CMU WALLS ARE DIMENSION!
TO TH	E CENTERLINE C FINISHED FACE ED FACE.	OF THE STUD. CHASES, SHAFTWALL AND CMU WALLS ARE DIMENSION: TO FINISHED FACE. EXISTING WALLS ARE DIMENSIONED TO THE
TO TH	E CENTERLINE C FINISHED FACE ED FACE. STC RANGE	DESCRIPTION EQUIVALENT TO MP 1072;
TO THE FROM FINISH	E CENTERLINE C FINISHED FACE ED FACE. STC RANGE STC 45-49	DESCRIPTION EQUIVALENT TO MP 1052; 5 1/2" MIN. STEEL STUD WALL SYSTEM
TO THE FROM FINISH:	E CENTERLINE C FINISHED FACE ED FACE. STC RANGE STC 45-49 STC 50-54	DESCRIPTION EQUIVALENT TO WP 1052; 5 1/2" MIN. STEEL STUD WALL SYSTEM EQUIVALENT TO WP 1522; EQUIVALENT TO WP 1522;
TO THE FROM FINISH:	E CENTERLINE C FINISHED FACE ED FACE. STC RANGE STC 45-49 STC 50-54	DESCRIPTION EQUIVALENT TO WP 1052; 5 1/2" MIN. STEEL STUD WALL SYSTEM EQUIVALENT TO WP 1522; 6 1/8" MIN. STEEL STUD WALL SYSTEM EQUIVALENT TO WP 1522; 6 1/8" MIN. STEEL STUD WALL SYSTEM EQUIVALENT TO WP 5060; 10 3/4" MIN. STEEL STUD WALL SYSTEM

NOTE: VERIFY ALL WALL THICKNESSES, STUD GAUGE, STUD SPACING AND SOUND ATTENUATION BLANKET WITH DOCUMENTS. REFER TO THE GYPSUM ASSOCIATION "FIRE RESISTANCE DESIGN MANUAL" FOR WP ASSEMBLIES.



DOCUMENT CHANGES

Description Date

FIRST FLOOR PL

FIRST FLOOR PLAN PART A -DIMENSIONED

Sheet Number
A1.01AD

PREFABRICATED ALUMINUM -CANOPY WITH INTEGRAL

A1.01AN A

<u>C1</u>

NEW LANDING AND STAIRS -TO SIDEWALK AND FINISH GRADE - SEE CIVIL

RUBBED CONCRETE -

FINISH ON SIDEMALL OF

SEYMOUR STREET ELEVATION

CA

1" / 12"


A2.04

A1.01AN

DRAINAGE SYSTEM

BEEN

SHEE

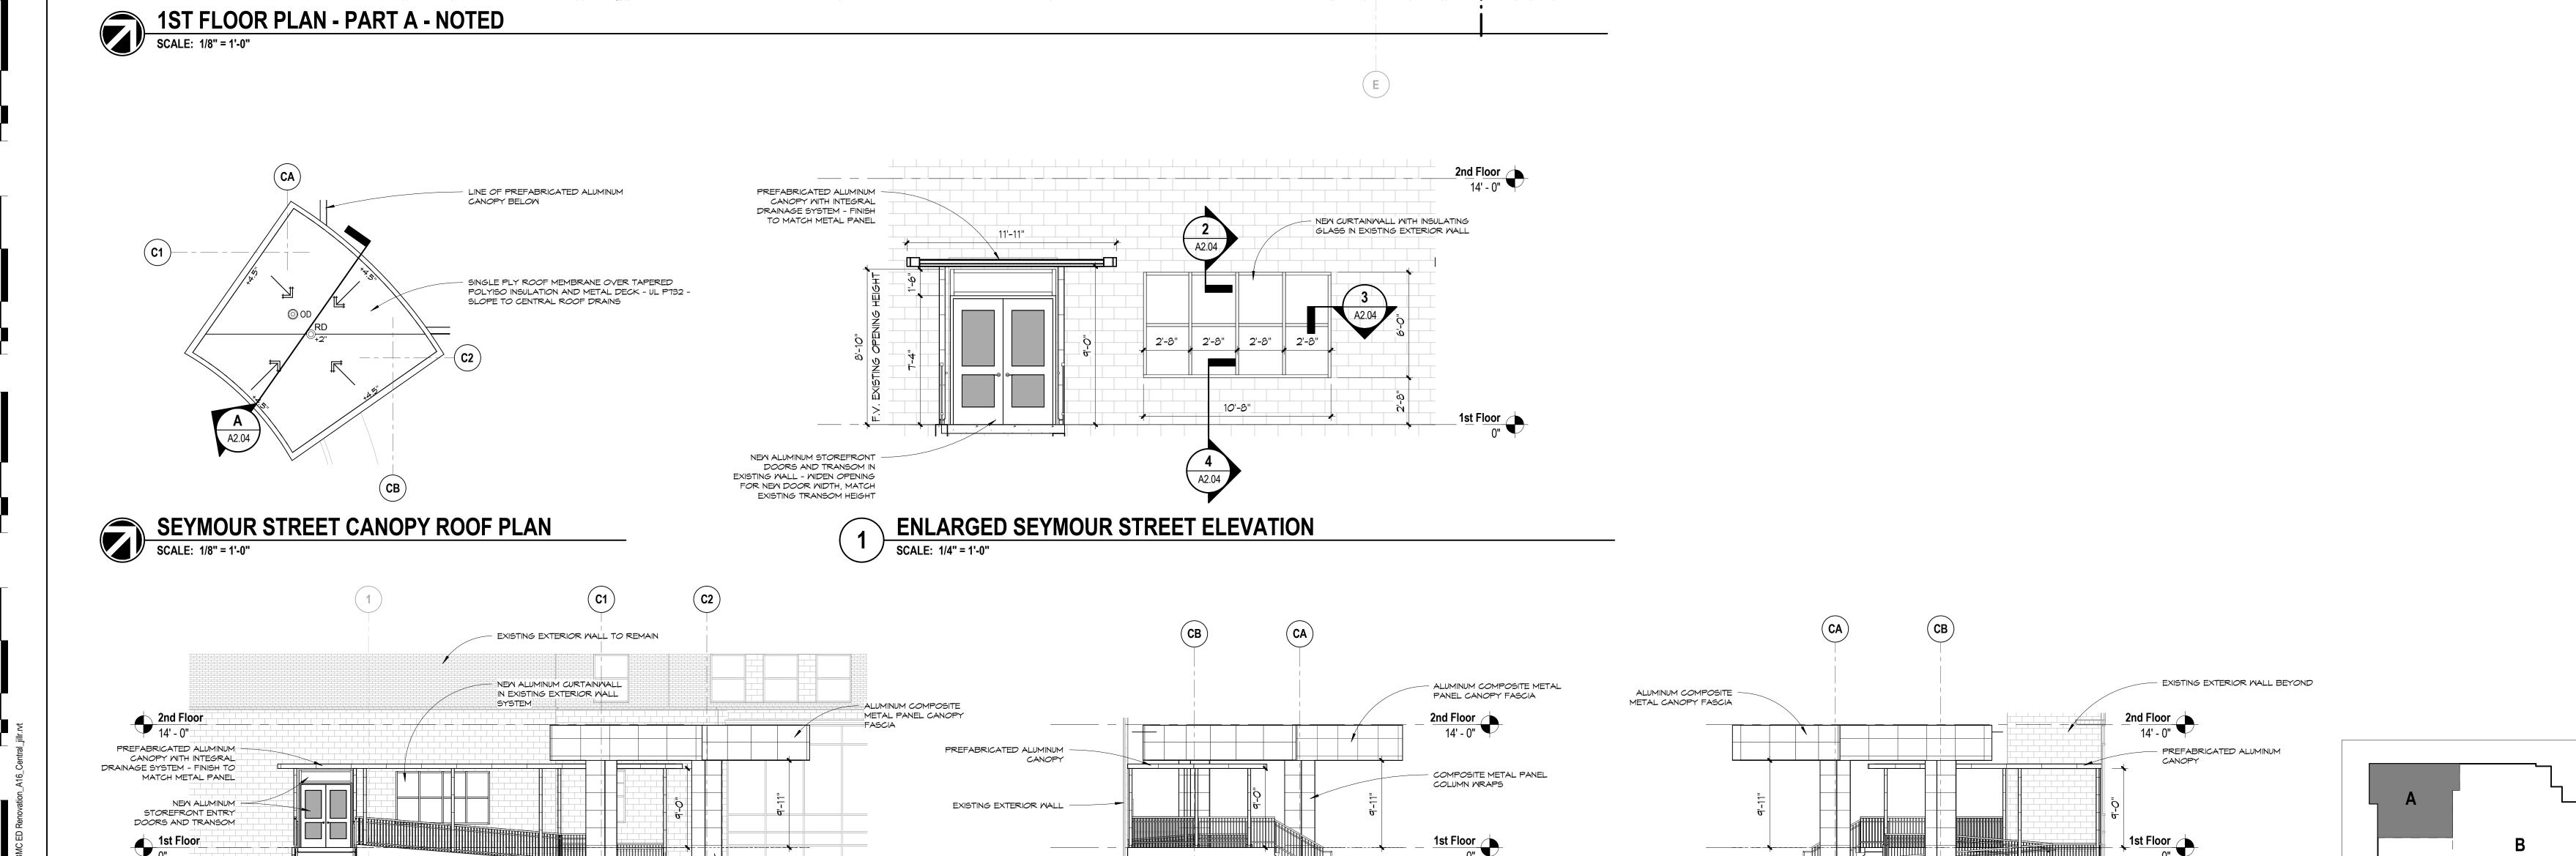

PAINTED METAL GUARDRAIL/HANDRAIL

RUBBED CONCRETE FINISH ON -

SOUTHEAST ELEVATION

SIDEMALL OF STAIRS, LANDING, & RAMP

- PAINTED METAL

GUARDRAIL/HANDRAIL

WAITING (32 SEATS

BALLISTIC GYP. BD., GLASS &

DOOR AT SECURITY.

TELECOM. 1-152

CHAPEL

EXISTING WALLS AS MARKED TO BE UPGRADED TO FULLY COMPLIANT SMOKE BARRIER, INCLUDING WALL CONSTRUCTION,

PENETRATIONS, DOORS, FRAMES,

COMPOSITE METAL PANEL COLUMN

RUBBED CONCRETE FINISH ON -SIDEWALL OF STAIR/LANDING

NORTHWEST ELEVATION

WRAPS - ALTERNATE VERTICAL

JOINTS ON ADJACENT SIDES

- PAINTED METAL GUARDRAIL/HANDRAIL

WALL LEGEND EXISTING NON-RATED PARTITION EXISTING SMOKE PARTITION TO DECK EXISTING 1-HOUR FIRE BARRIER EXISTING 2-HOUR FIRE BARRIER EXISTING 2-HOUR RATED SHAFT WALL BARRIER EXISTING NON-RATED C.M.U. PARTITION TO DECK EXISTING 1-HOUR C.M.U. FIRE BARRIER TO DECK EXISTING 2-HOUR C.M.U. FIRE BARRIER TO DECK EXISTING CAST-IN-PLACE CONC. EXISTING 2-HOUR CONC. FIRE BARRIER NON-RATED PARTITION TO DECK SMOKE PARTITION TO DECK 1-HOUR FIRE BARRIER 1-HOUR SMOKE BARRIER 1-HOUR RATED SHAFT WALL BARRIER 2-HOUR FIRE BARRIER 2-HOUR SMOKE BARRIER 2-HOUR RATED SHAFT WALL BARRIER NON-RATED C.M.U. PARTITION TO DECK 1-HOUR C.M.U. FIRE BARRIER TO DECK 2-HOUR C.M.U. FIRE BARRIER TO DECK 1-HOUR C.M.U. SMOKE BARRIER TO DECK 2-HOUR C.M.U. SMOKE BARRIER TO DECK CAST-IN-PLACE CONC. 2-HOUR CONC. FIRE BARRIER 2-HOUR CONC. SMOKE BARRIER

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EMERGI

DOCUMENT CHANGES

Issue Description CONSTRUCTION DOCUMENTS 10/11/17 Original Issue Date 16072.00 Project No JMR Checked By JMR

FIRST FLOOR PLAN PART A - NOTED

A1.01AN

1ST FLOOR KEY PLAN

EXTERIOR RAMP HANDRAIL

SEE PDS AMERICA DRAWINGS FOR ADDITIONAL INFORMATION

SCALE: 1 1/2" = 1'-0"

ROUTE RWL TO COLUMN WRAP -

PRE-FAB CANOPY AT EXISTING EXTERIOR WALL

SCALE: 3" = 1'-0"

2nd Floor 14' - 0"

EXTERIOR RAMP RAILING ELEVATIONS

SEE PDS AMERICA DRAWINGS FOR ADDITIONAL INFORMATION

SCALE: 1/2" = 1'-0"

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EXISTING STONE



DOCUMENT CHANGES Issue Description CONSTRUCTION DOCUMENTS

EMERGI

Original Issue Date 10/11/17 16072.00 Project No JF Checked By JMR

EXTERIOR DETAILS

A2.04

NEW WINDOW IN EXISTING MASONRY WALL

CURTAIN WALL ALUMINUM SILL

SCALE: 3" = 1'-0"