PLUMBING ABBREVIATIONS		INVERT	INV.
AMPERE	A(AMP)	JANITOR	JAN.
ABOVE FINISHED FLOOR	AFF		
ADJUSTABLE AIR CONDITIONING	ADJ. A/C	LAVATORYLONG RADIUS ELBOW	LAV LRE
AIR CONDITIONING AIR HANDLER UNIT	A/C AHU	LONG KADIOS ELBOW	
APPROXIMATE(LY)	APPROX.	MAN HOLE	MH
ARCHITECT(URAL)	ARCH('L)	MANUFACTURE(R) MAXIMUM	MFR. MAX
BUILDING	BLDG	MAXIMUM OVERCURRENT	
BRITISH THERMAL UNIT	BTU	PROTECTION	
CAST IRON	CI	MECHANICAL MEDIUM PRESSURE GAS	MECI MPG
CENTER	CTR	MEZZANINE	MEZZ
CLEAN OUT	co	MINIMUM_	MIN
COLD WATERCONCRETE	CW CONC.	MINIMUM CURRENT AMPACITY MISCELLANEOUS	MCA MISC
CONCRETE MASONRY UNIT	CONC.	MOP SINK	MS
CONDENSATE DRAIN	COND	MULTIPLE	MUL
CONDENSING UNIT CONSTRUCTION	CU CONST.	NOT APPLICABLE	N/A
CORRIDOR	CORR.	NATURAL	NAT.
CUBIC FOOT PER HOUR	CFH	NATURAL GAS	NG
DEGREE FAHRENHEIT	DegF.	NOMINALNON-FREEZE WALL HYDRANT	MOMNOM
DEMOLISH(ITION)	DEMO	NORTH	N
DETAIL	DET.	NOT IN CONTRACT	N.I.C.
DIAMETER	DIA./Ø	NOT TO SCALE NUMBER	N.T.S NO./#
DISCONNECT_ DISHWASHER BOX	DISC.	IAOIAIDEI/	
DIVISION	DIV.	OUTSIDE AIR	OA
DOMESTIC COLD WATER	DCW	OUTLET OVERFLOW ROOF DRAIN	OUT. ORD
DOMESTIC HOT WATER DOMESTIC HOT WATER RECIRCULATION	DHW DHWR	OVERFLOW ROOF DRAIN OVERFLOW STORM DRAIN	OSD
DOUBLE DOUBLE	DBL.		
DOUBLE CLEAN OUT	DCO	PANELPARTIAL	PNL. PART
DOWNDOWNSPOUT BOOT	DN DSB	PHASE	PART PH./Ø
DOWNSPOUT BOOT DOWNSPOUT NOZZLE	DSN DSN	POINT OF CONNECTION	POC
DRAINAGE FIXTURE UNIT	DFU	POLYVINYL CHLORIDE	PVC
DRAWING(S)	DWG(S)	POUND(S) POUNDS PER SQUARE INCH	LBS PSI
EACH	EA.	FOUNDS FER SQUARE INCIT	
EFFICIENCY	EFF.	QUANTITY	QTY.
ELECTRIC(AL)	ELEC.	RADIUS	RAD
ELECTRIC WATER COOLERELEVATION	EWC ELEV.	REFRIGERATOR BOX	RB
ELEVATION ELEVATION SUMP PUMP WASTE	EW	RECESSED	REC.
EMERGENCY EYE WASH	EEW	REINFORCE(ING)(ED)(MENT)	REIN
EMERGENCY EYE WASH & SHOWER EMERGENCY MIXING VALVE	EEW/S EMV	RETURN AIR REQUIRE(D)	RA REQ.(
EMERGENET WIXING VILEVE		,	
EMERGENCY SHOWER	ES ENGR.	ROOF DRAIN	RD
ENGINEEREQUAL		ROOF TOP UNIT	RTU
EQUIPMENT	EQPT.	ROOM	RM
ETCETERA	ETC.	SANITARY SEWER	SS
EXHAUST FANEXISTING	EF EXIST.	SCHEDULE	SCH
EXISTINGEXTERIOR CLEANOUT	ECO	SECTION	SECT
EXPOSED	EXP.	SHOWERSOUTH	SH S
EYE WASH	EW	SPECIFICATION(S)	
FIRE DEPARTMENT CONNECTION	FDC	SPRINKLER	SPRIN
FIRE PROTECTION	FP	SQUARESQUARE FEET	SQ. SF
FINISH(ED)FINISH FLOOR	FIN.('D)	STAINLESS STEEL	SF SST
FIXTURE	FIXT.	STEEL	STL.
FIXTURE UNIT	FU	STORM DRAIN	SD
FLEXIBLE FLOOR	FLEX FL.	SUPPLY FIXTURE UNIT	SFU
FLOOR CLEAN OUT	FCO	TEMPORARY	TEMI
FLOOR DRAIN	FD FD	TEXAS	TUDI
FLOOR SINK FLUSH VALVE	FS FV	THROUGHTOTAL DEVELOPED LENGTH	THRU TDL
EOOT/EEET	ET	TO FLOOR ABOVE	TFA
FROM FLOOR ABOVE	FFA	TO FLOOR BELOW	TFB
FROM FLOOR BELOW	FFB	TOP OF STEEL TRENCH DRAIN	TOS TD
GALLONS PER FLUSH	GPF	TYPICAL	TYP.
GALLONS PER MINUTE	GPM	LINDEDCROUND	
GALVANIZED GAS HEATER	GALV. GH	UNDERGROUNDUNDERWRITER LABORATORIES	UG UL
GAS PIPING	—GH	INC.	
GAS PRESSURE REGULATOR	GPR	UNIT HEATER	UH
GAUGE	GA. G.C.	UNLESS NOTED OTHERWISEURINAL	U.N.C UR
GENERAL CONTRACTORGREASE WASTE	G.C. GW	UTILITY	UTIL.
GROUND	GND.	VENT	
GROUND CLEANOUT_	GCO	VENTVENT THROUGH ROOF	V VTR
GYPSUM BOARD	GYP.	VOLUME	VIK VOL.
HEATER	HTR		
HEAT PUMP UNIT/HORSEPOWER		WALL CLEANOUT WASTE WATER	WCO WW
HEATING, VENTILATION & AIR CONDITIONING	HVAC		
HOSE BIBB	HB	WATER CLOSET	WC
HOT WATER DETURN	HW	WATER HAMMER ARRESTOR WATER HEATER	WHA WH
HOT WATER RETURN	HWR	WEIGHT	WT.
INFORMATION	INFO	WITH	W/
INLET	IN.	WITHOUT	W/O
INSPECTION PORTALINSULATION	IP INSUL.		

NOTE: NOT ALL ABBREVIATIONS ON THIS LIST ARE APPLICABLE TO THIS PROJECT.

FIRE PROTECTION NOTES

----- • HOT WATER PIPING

---- • WASTE WATER PIPING

VENT PIPING

──G**─** • GAS PIPING

• FIRE PIPING

— — — ● STORM PIPING

PLUMBING DEMOLITION LINE TYPES

PLUMBING EXISTING LINE TYPES

-··-- • HOT WATER RETURN PIPING

---- • DEMOLITION COLD WATER PIPING

---- • DEMOLITION WASTE WATER PIPING

---- • DEMOLITION HOT WATER PIPING

---- • DEMOLITION GAS PIPING

---- • DEMOLITION FIRE PIPING

---- • DEMOLITION STORM PIPING

----- • EXISTING COLD WATER PIPING

---- • EXISTING HOT WATER PIPING

— — — — • EXISTING VENT PIPING

 EXISTING FIRE PIPING ---- • EXISTING STORM PIPING

---- • EXISTING WASTE WATER PIPING

- A. PROVIDE ALL MATERIALS AND EQUIPMENT AND PERFORM ALL LABOR REQUIRED TO INSTALL COMPLETE AND OPERATE FIRE PROTECTION SYSTEMS AS INDICATED ON THE DRAWINGS, AS SPECIFIED, AND IN COMPLIANCE WITH THE STANDARDS OF THE NATIONAL FIRE PROTECTION ASSOCIATION, INDUSTRIAL RISK INSURERS, FACTORY MUTUAL, AND ALL STATE AND LOCAL REGULATIONS.
- B. THE ENTIRE BUILDING SPRINKLER SYSTEM SHALL BE HYDRAULICALLY DESIGNED BY QUALIFIED FIRE PROTECTION ENGINEER. HEAD SPACING IN GENERAL AND WATER QUANTITY SHALL BE BASED ON LIGHT HAZARD OCCUPANCY
- C. THE ENTIRE BUILDING SPRINKLER SYSTEM SHALL BE PIPE SCHEDULE DESIGNED UNLESS OTHERWISE NOTED. HEAD SPACING IN GENERAL AND WATER QUANTITY SHALL BE BASED ON LIGHT HAZARD OCCUPANCY
- D. PROVIDE AN AUTOMATIC DRY PIPE SPRINKLER SYSTEM THROUGHOUT THE ENTIRE BUILDING, COMPLETE IN ALL RESPECTS AND READY FOR OPERATION, INCLUDING ALL TEST AND DRAIN LINES, PRESSURE GAUGES, DRY PIPE VALVES, AIR COMPRESSORS, HANGERS AND SUPPORTS, SIGNS, AND OTHER STANDARD APPURTENANCES. WIRING SHALL BE PROVIDED UNDER THE ELECTRICAL DIVISION.
- E. SEE THE ARCHITECTURAL DRAWINGS FOR THE EXACT LOCATION OF FIRE EXTINGUISHER CABINETS, FIRE HOSE CABINETS, AND SIAMESE CONNECTIONS.
- F. ALL SHUTOFF VALVES IN THE SPRINKLER, STANDPIPE, AND COMBINED SYSTEMS SHALL BE APPROVED, INDICATING TYPE.
- G. COORDINATE SPRINKLER HEAD LOCATIONS WITH THE ARCHITECTURAL REFLECTED CEILING PLANS, LIGHTING, AND OTHER CEILING ITEMS, AND MAKE MINOR MODIFICATIONS FOR SUITABILITY PURPOSES.
- H. SPRINKLERS INSTALLED IN THE CEILINGS OF FINISHED AREAS SHALL BE SYMMETRICAL IN RELATION TO CEILING SYSTEM COMPONENTS AND CENTERED IN THE CEILING TILE.
- I. COORDINATE LOCATION OF BACKFLOW PREVENTER TO MINIMIZE DEAD WATER IN THE INCOMING FIRE LINE.

PLUMBING RISER SYMBOLS POINT OF CONNECTION FLOOR CLEAN OUT - SEE SCHEDULE RISER COLD WATER GENERAL ⊚ DCO DOUBLE EXTERIOR CLEAN OUT RISER COLD/HOT WATER ⊢ CO CLEAN OUT WALL CLEAN OUT • RISER COLD WATER HOSE BIBB FLOOR DRAIN WATER HAMMER ARRESTER RISER WASTE WATER GENERAL HOSE BIBB NON-FREEZE WALL HYDRANT ₩H RISER WASTE WATER LAVATORY FLOOR SINK • BALL VALVE RISER WASTE WATER FLOOR DRAIN CHECK VALVE FLOW CONTROL VALVE RISER WASTE WATER FLOOR SINK • GAS COCK GAS REGULATOR RISER WASTE WATER HUB DRAIN GATE VALVE RISER WASTE WATER VENT THROUGH ROOF OS&Y GATE VALVE STRAINER INSPECTION PORTAL PLUMBING LINE TYPES PIPING UP ----- • COLD WATER PIPING

PIPING DOWN

PIPING TEE DOWN

• BACKFLOW PREVENTER

NOTE: NOT ALL SYMBOLS ON THIS LIST ARE APPLICABLE TO THIS PROJECT.

PLUMBING GENERAL NOTES

- A. DO NOT SCALE DRAWINGS. REFER TO ARCHITECTURAL DOCUMENTS FOR EXACT LOCATION OF FIXTURES & EQUIPMENT.
- B. PROVIDE ALL MATERIALS AND EQUIPMENT AND PERFORM ALL LABOR REQUIRED TO INSTALL COMPLETE AND OPERABLE PLUMBING SYSTEMS AS INDICATED ON THE DRAWINGS, AND AS SPECIFIED AND REQUIRED BY CODE.
- C. RUN ALL SOIL WASTE AND VENT PIPING WITH 2 PERCENT MINIMUM GRADE UNLESS OTHERWISE NOTED.
- D. WASTEWATER PIPE SIZES 3" TO 6" SHALL HAVE A MINIMUM SLOPE OF 1/8"/FT AND 8" OR LARGER PIPE SHALL HAVE A MINIMUM SLOPE OF 1/16"/FT.
- E. VENT PIPING SHALL BE 2" MINIMUM UNLESS OTHERWISE NOTED
- F. ELEVATIONS AS SHOWN ON THE DRAWINGS ARE TO THE BOTTOM OF ALL PRESSURE PIPING AND TO THE INVERT OF ALL GRAVITY PIPING.
- G. ADJUST SEWER INVERTS TO KEEP THE TOPS OF PIPES IN LINE WHERE THE PIPE'S SIZE
- H. MAINTAIN A MINIMUM OF 2 FEET OF GROUND COVER OVER ALL UNDERGROUND WATER MAINS AND UNDERGROUND SEWERS AND DRAINS.
- I. PROVIDE SHUTOFF VALVES IN ALL DOMESTIC WATER PIPING SYSTEM BRANCHES.
- J. UNLESS OTHERWISE NOTED, ALL DOMESTIC COLD WATER PIPING SHALL BE A MINIMUM
- K. UNLESS OTHERWISE NOTED, ALL PIPING IS OVERHEAD, TIGHT TO THE UNDERSIDE OF THE SLAB, WITH SPACE FOR INSULATION IF REQUIRED.
- L. INSTALL PIPING SO ALL VALVES, STRAINERS, UNIONS, TRAPS, FLANGES, AND OTHER
- APPURTENANCES REQUIRING ACCESS ARE ACCESSIBLE. M. WHERE DOMESTIC COLD WATER PIPING DROPS INTO A PIPE CHASE, THE SIZE SHOWN
- FOR THE PIPE DROPS SHALL BE USED TO THE LAST FIXTURE. N. INSTALL ALL PIPING WITHOUT FORCING OR SPRINGING.
- O. ALL PIPING SHALL CLEAR DOORS AND WINDOWS.
- P. ALL PIPING SHALL GRADE TO LOW POINTS. PROVIDE HOSE END DRAIN VALVES AT THE BOTTOM OF ALL RISERS AND LOW POINTS.
- Q. UNIONS AND/OR FLANGES SHALL BE INSTALLED AT EACH PIECE OF EQUIPMENT, IN BYPASSES, AND IN LONG PIPING RUNS (100 FT. OR MORE) TO PERMIT DISASSEMBLY FOR ALTERATION AND REPAIRS.
- R. ALL VALVES SHALL BE ADJUSTED FOR SMOOTH AND EASY OPERATION.
- S. ALL VALVES AND STRAINERS SHALL BE THE FULL SIZE OF THE PIPE BEFORE REDUCING THE SIZE TO MAKE CONNECTIONS TO THE EQUIPMENT.
- T. PROVIDE ALL PLUMBING FIXTURES AND EQUIPMENT WITH ACCESSIBLE STOPS.

AND SHALL BE 6 IN. FOR PIPE SIZES LARGER THAN 6 IN.

- U. UNLESS OTHERWISE NOTED, DRAINS SHALL BE INSTALLED AT THE LOW POINT OF ROOFS,
- AREAWAYS, FLOORS, ETC. V. PROVIDE CLEANOUTS IN SANITARY AND STORM DRAINAGE SYSTEMS AT ENDS OF RUNS, AT CHANGES IN DIRECTION, NEAR THE BASE OF STACKS, EVERY 50 FT. IN HORIZONTAL
- RUNS AND ELSEWHERE AS INDICATED (EDIT HORIZONTAL CLEANOUT SPACING TO SUIT CODE AND PROJECT REQUIREMENTS). W. ALL CLEANOUTS SHALL BE THE FULL SIZE OF THE PIPE FOR PIPE SIZES 6 IN. AND SMALLER,
- X. ALL BALANCING VALVES AND BUTTERFLY VALVES SHALL BE PROVIDED WITH POSITION
- INDICATORS AND MAXIMUM ADJUSTABLE STOPS (MEMORY STOPS). Y. ALL VALVES SHALL BE INSTALLED SO THE VALVE REMAINS IN SERVICE WHEN THE
- EQUIPMENT OR PIPING ON THE EQUIPMENT SIDE OF THE VALVE IS REMOVED. Z. ALL PIPING WORK SHALL BE COORDINATED WITH ALL TRADES INVOLVED PRIOR TO INSTALLATION. OFFSETS IN PIPING AROUND OBSTRUCTIONS SHALL BE PROVIDED AT NO
- ADDITIONAL COST TO THE OWNER. AA. PROVIDE FLEXIBLE CONNECTIONS IN ALL PIPING SYSTEMS CONNECTED TO PUMPS AND OTHER EQUIPMENT THAT REQUIRE VIBRATION ISOLATION. FLEXIBLE CONNECTIONS
- THE DRAWINGS.
- HEATED WATER TO THE TERMINATION OF THE FIXTURE SUPPLY PIPE SHALL BE 0'-6" FOR PUBLIC LAVATORY FAUCETS AND 21'-0" FOR ALL OTHER FIXTURES AND APPLIANCES. THE MAXIMUM ALLOWABLE 1/2" PIPING LENGTH FROM THE NEAREST SOURCE OF HEATED WATER TO THE TERMINATION OF THE FIXTURE SUPPLY PIPE SHALL BE 2'-0" FOR PUBLIC

APPLICABLE CODES
2018 IBC
2018 IMC
2018 IPC
2018 IECC
2017 NFC

P000	PLUMBING GENERAL NOTES, LEGEND & ABBREVIATIONS
P001	PLUMBING SPECIFICATIONS
P002	PLUMBING SITE PLAN
2100	PLUMBING WASTEWATER BUILDING 1 - OVERALL PLAN
2101	PLUMBING WASTEWATER BUILDING 1a - LEVEL 1
102	PLUMBING WASTEWATER BUILDING 1b - LEVEL 1
2103	PLUMBING WASTEWATER BUILDING 1c - LEVEL 1
P104	PLUMBING WASTEWATER BUILDING 1d - LEVEL 1
P105	PLUMBING WASTEWATER BUILDING 1e - LEVEL 1
P106	PLUMBING WASTEWATER BUILDING 1a - LEVEL 2
P107	PLUMBING WASTEWATER BUILDING 1b - LEVEL 2
P108	PLUMBING WASTEWATER BUILDING 1c - LEVEL 2
P109	PLUMBING WASTEWATER BUILDING 1d - LEVEL 2
P110	PLUMBING WASTEWATER BUILDING 1e - LEVEL 2
P111	PLUMBING WASTEWATER BUILDING 1a - LEVEL 3
112	PLUMBING WASTEWATER BUILDING 1b - LEVEL 3
P113	PLUMBING WASTEWATER BUILDING 1c - LEVEL 3
P114	PLUMBING WASTEWATER BUILDING 1d - LEVEL 3
P115	PLUMBING WASTEWATER BUILDING 1e - LEVEL 3
P116	PLUMBING WASTEWATER BUILDING 1a - LEVEL 4
P117	PLUMBING WASTEWATER BUILDING 1b - LEVEL 4
P118	PLUMBING WASTEWATER BUILDING 1c - LEVEL 4
P119	PLUMBING WASTEWATER BUILDING 1d - LEVEL 4
P120	PLUMBING WASTEWATER BUILDING 1e - LEVEL 4
P126	PLUMBING WASTEWATER BUILDING II (#2 & #3) - LEVEL 1
E127	PLUMBING WASTEWATER BUILDING II (#4 & #5) - LEVEL 1
P128	PLUMBING WASTEWATER BUILDING II (#2, #3 & #5) - LEV
129	PLUMBING WASTEWATER BUILDING II (#4) - LEVEL 2

PLUMBING WASTEWATER BUILDING II (#2, #3 & #5) - LEVEL 3 PLUMBING WASTEWATER BUILDING II (#4) - LEVEL 3

PLUMBING DOMESTIC WATER BUILDING 1a - LEVEL 1 PLUMBING DOMESTIC WATER BUILDING 1b - LEVEL 1 PLUMBING DOMESTIC WATER BUILDING 1c - LEVEL 1

PLUMBING DOMESTIC WATER BUILDING 1b - LEVEL 2

PLUMBING DOMESTIC WATER BUILDING 1a - LEVEL 4

PLUMBING DOMESTIC WATER BUILDING 1b - LEVEL 4

PLUMBING DOMESTIC WATER BUILDING 1c - LEVEL 4

PLUMBING DOMESTIC WATER BUILDING 1d - LEVEL 4

PLUMBING DOMESTIC WATER BUILDING 1e - LEVEL 4

PLUMBING DOMESTIC WATER BUILDING II (#2 & #3) - LEVEL 1

PLUMBING DOMESTIC WATER BUILDING II (#4 & #5) - LEVEL 1

PLUMBING DOMESTIC WATER BUILDING II (#4) - LEVEL 2

PLUMBING DOMESTIC WATER BUILDING II (#4) - LEVEL 3

PLUMBING POOL RESTROOM, RISER ROOM & MAINTENANCE

ENCOTECH

TBPE Firm | 8500 Bluffstone Cove, Suite B-103 1141 | Austin, Texas 78759 | 512.338.1101 Project No.: 18054.MS.AUS

PLUMBING DOMESTIC WATER BUILDING II (#2, #3 & #5) - LEVEL 2

PLUMBING DOMESTIC WATER BUILDING II (#2, #3 & #5) - LEVEL 3

PLUMBING DOMESTIC WATER BUILDING 1d - LEVEL 1 PLUMBING DOMESTIC WATER BUILDING 1e - LEVEL 1 PLUMBING DOMESTIC WATER BUILDING 1a - LEVEL 2

PLUMBING DOMESTIC WATER BUILDING 1c - LEVEL 2 PLUMBING DOMESTIC WATER BUILDING 1d - LEVEL 2

PLUMBING DOMESTIC WATER BUILDING 1e - LEVEL 2 PLUMBING DOMESTIC WATER BUILDING 1a - LEVEL 3 PLUMBING DOMESTIC WATER BUILDING 1b - LEVEL 3

PLUMBING UNIT A1 & A2

PLUMBING UNIT A6 & A7

PLUMBING UNIT B1 & B2

PLUMBING UNIT B6 & C1

PLUMBING CALCULATIONS

PLUMBING CALCULATIONS

PLUMBING FIXTURE SCHEDULES

PLUMBING WASTEWATER RISER

PLUMBING WASTEWATER RISER

PLUMBING WASTEWATER RISER

PLUMBING WASTEWATER RISER

PLUMBING DETAILS

PLUMBING DETAILS

PLUMBING DETAILS

PLUMBING DOMESTIC WATER RISER

PLUMBING DOMESTIC WATER RISER

PLUMBING UNIT B3, B4 & B5

PLUMBING UNIT A2-ALT-1, A3, A4 & A5

P302

P502

PLUMBING DOMESTIC WATER BUILDING 1c - LEVEL 3 P214 PLUMBING DOMESTIC WATER BUILDING 1d - LEVEL 3 PLUMBING DOMESTIC WATER BUILDING 1e - LEVEL 3

SHALL BE PROVIDED AS CLOSE TO THE EQUIPMENT AS POSSIBLE OR AS INDICATED ON

AB. PROVIDE BACKFLOW PREVENTERS AT ALL LOCATIONS REQUIRED BY THE LATEST ADOPTED CODES AND ORDINANCES. AC. THE MAXIMUM ALLOWABLE 3/4" PIPING LENGTH FROM THE NEAREST SOURCE OF

LAVATORY FAUCETS AND 43'-0" FOR ALL OTHER FIXTURES AND APPLIANCES.

2018 IBC
2018 IMC
2018 IPC
2018 IECC
2017 NEC
LOCAL CODES AND ORDINANCES

DAY		45
COLLA	BORA	TĪVĒ
3607 S Lamar Blvd, Suite 103	Austin, Texas 78704	512.852.43
Structural Enginee	er:	

Structural Engineer.

VIEWTECH INC. 4205 Beltway Dr. Addison, TX 75001 Victor Lisiak III 972.661.8187

MEP Engineer:

ENCOTECH 8500 Bluffstone Cove, Austin, TX. 78759 Tessa Roberts 512.338.1101

Civil Engineer:

MBC & Associates, Inc 1035 Central Pkwy N, San Antonio, TX 78732 David Allen 210.545.1122

Landscape Architect:

LEE & Associates, Inc. 9020 N Capital of Texas Hwy, Austin, TX. 78759 Amber Rothwell

Interior Designer:

512.345.8477

SJL Design Group 921 N. Riverfront Blvd. Suite 100, Dallas, TX 75207 Cassie Farley 214.443.9090

ISSUANCES		
01	SCHEMATIC DESIGN	09.10.18
02	DEVELOPMENT DESIGN	11.09.18
03	PERMIT SET	01.28.19

REVISIONS



a multifamily project for NRP Group

West Cevallos

San Antonio, Texas

PLUMBING GENERAL NOTES, LEGENDS & ABBREVIATIONS

18054 Project Number 01/14/2018 TLR Drawn By EEC Checked By

GENERAL PLUMBING REQUIREMENT

- A. THE PLUMBING WORK CONSISTS OF PROVIDING LABOR, MATERIALS, PRODUCTS, AND IN PERFORMING ALL OPERATIONS REQUIRED FOR THE COMPLETE OPERATING INSTALLATION OF ALL PLUMBING SYSTEMS IN ACCORDANCE WITH SPECIFICATIONS, APPLICABLE DRAWINGS, TERMS, CONDITIONS OF THE CONTRACT AND ALL APPLICABLE CODES AND ORDINANCES GOVERNING THE INSTALLATION OF THE VARIOUS MECHANICAL AND PLUMBING SYSTEMS. ALL WORK SHALL BE FULLY CORRELATED WITH THE WORK OF OTHER CRAFTS.
- B. EACH CONTRACTOR SHALL STUDY THE CONTRACT DOCUMENTS TO DETERMINE THE EXTENT OF WORK PROVIDED UNDER THIS CONTRACT, AS WELL AS TO ASCERTAIN THE DIFFICULTY TO BE ENCOUNTERED IN PERFORMING THE WORK ON THE DRAWINGS AND OUTLINED HEREINAFTER AND IN MAKING CONNECTIONS TO EXISTING UTILITIES, INSTALLING NEW EQUIPMENT AND SYSTEMS AND COORDINATING THE WORK WITH THE OTHER TRADES.
- C. EXAMINATION OF SITE: THE CONTRACTOR SHALL THOROUGHLY EXAMINE SITE AND SATISFY HIMSELF AS TO THE CONDITIONS UNDER WHICH THE WORK IS TO BE PERFORMED. THE CONTRACTOR SHALL VERIFY, AT THE SITE, ALL MEASUREMENTS AFFECTING HIS WORK AND SHALL BE RESPONSIBLE FOR THE CORRECTNESS OF SAME NO EXTRA COMPENSATION WILL BE ALLOWED TO THE CONTRACTOR FOR EXPENSES DUE TO HIS NEGLECT TO EXAMINE OR FAILURE TO DISCOVER CONDITIONS WHICH AFFECT HIS WORK. NO EXTRA COMPENSATION WILL BE ALLOWED ON ACCOUNT OF DIFFERENCES BETWEEN ACTUAL DIMENSIONS AND THOSE INDICATED ON THE DRAWINGS.

1.2 REGULATORY REQUIREMENTS

- A. CODES AND ORDINANCES/PERMIT AND FEES: PERFORM ALL WORK IN ACCORDANCE WITH ALL STATE AND LOCAL CODES AND ORDINANCES, INCLUDING THE AMERICANS WITH DISABILITIES ACT (LATEST EDITION), THE CURRENT EDITION OF NFPA, THE LATEST ADOPTED BUILDING CODE, LATEST ADOPTED MECHANICAL CODE, LATEST ADOPTED PLUMBING CODE, AND ALL CURRENT SUPPLEMENTS THERETO, AND ANY OTHER AUTHORITIES HAVING JURISDICTION OVER THE WORK. PROCURE AND PAY FOR ALL PERMITS, LICENSES, FEES AND CHARGES, AND GIVE ALL NOTICES NECESSARY.
- B. IN CASE OF CONFLICT BETWEEN THE CONTRACT DOCUMENTS AND REQUIREMENTS OF ANY CODE OR AUTHORITIES HAVING JURISDICTION, THE MOST STRINGENT REQUIREMENTS OF THE AFOREMENTIONED SHALL GOVERN.
- C. SHOULD THE CONTRACTOR PERFORM ANY WORK THAT DOES NOT COMPLY WITH THE REQUIREMENTS OF THE APPLICABLE BUILDING CODES, STATE LAWS, LOCAL ORDINANCES AND INDUSTRY STANDARDS, HE SHALL BEAR ALL COSTS ARISING IN CORRECTING THE DEFICIENCIES, AS APPROVED BY THE ARCHITECT.
- D. INTENT: THE DRAWINGS SHOW GENERAL ARRANGEMENTS AND THE EXTENT OF THE WORK. THE DRAWINGS DO NOT SHOW, IN MINUTE DETAIL, ALL FEATURES OF THE INSTALLATION. FOLLOW THE DRAWINGS AS CLOSELY AS ACTUAL CONSTRUCTION WILL PERMIT. ALL MATERIAL AND LABOR NECESSARY TO COMPLETE THE WORK IN ACCORDANCE WITH THE INTENT OF THE SPECIFICATIONS AND DRAWINGS SHALL BE FURNISHED BY THE CONTRACTOR WITHOUT ADDITIONAL CHARGE. THE JOB SHALL BE BID AND INSTALLED COMPLETE AND CONSISTENT IN EVERY REQUEST.

1.3 COORDINATION OF WORK

- A. EACH CONTRACTOR SHALL COMPARE HIS DRAWINGS AND SPECIFICATIONS WITH THOSE OF OTHER TRADES. ALL WORK SHALL BE INSTALLED IN COOPERATION WITH OTHER TRADES INSTALLING INTERRELATED WORK. BEFORE INSTALLATION, ALL TRADES SHALL MAKE PROPER PROVISIONS TO AVOID INTERFERENCES.
- B. EACH CONTRACTOR SHALL COORDINATE THE LOCATION OF THEIR SYSTEMS SO THAT ALL OUTSIDE AIR INTAKES AND PLUMBING VENTS ARE LOCATED IN SUCH A WAY AS TO PREVENT CROSS-CONTAMINATION. PLUMBING VENTS SHALL BE LOCATED AT A DISTANCE OF NOT LESS THAN 10'-0" FROM OUTSIDE AIR INTAKES OR AS REQUIRED BY APPLICABLE CODES & ORDINANCES.
- C. LOCATIONS OF CONDUIT, DUCTS, PIPING, SPRINKLER HEADS AND EQUIPMENT SHALL BE ADJUSTED TO ACCOMMODATE THE WORK WITH INTERFERENCES ANTICIPATED AND ENCOUNTERED. EXACT ROUTING AND LOCATION OF SYSTEMS SHALL BE DETERMINED PRIOR TO FABRICATION OR INSTALLATION.
- D. OFFSETS AND CHANGES OF DIRECTION IN ALL PIPING SYSTEMS SHALL BE MADE AS REQUIRED TO MAINTAIN PROPER HEADROOM AND PITCH OF SLOPING LINES.
- PERFORM ALL WORK WITH HIGHEST REGARD TO SAFETY. EXCAVATE BY HAND AND WITH CAUTION TO LOCATE ALL UTILITIES IN THE BOUNDS OF THE AREA TO BE EXCAVATED PRIOR TO MACHINE EXCAVATING. PROCEED WITH SAFETY AND CAUTION SO THAT NO UTILITY IS DAMAGED OR INTERRUPTED.
- F. PRIOR TO BID, VERIFY AND COORDINATE ALL REQUIRED CONNECTIONS AND/OR RELOCATIONS OF UTILITIES WITH UTILITY COMPANIES. PERFORM SUCH WORK IN ACCORDANCE WITH UTILITY COMPANY REGULATIONS. PAY ALL APPLICABLE FEES AND COSTS, INCLUDING THOSE FOR ANY EXTENSIONS. RELOCATIONS AND/OR CONNECTIONS
- G. CONTRACTOR SHALL VERIFY LOCATIONS OF ALL ABOVE GROUND AND MARKED UTILITIES.

1.4 SUBMITTALS

- A. SUBMITTALS SHALL BE COMPLETE FOR SYSTEM(S) INVOLVED. PROVIDE SUBMITTALS FOR ALL PLUMBING FIXTURES AND EQUIPMENT REQUIRING SUBMITTAL. REFER TO INDIVIDUAL EQUIPMENT SPECIFICATION SECTIONS.
- B. WHERE EQUIPMENT OF THE ACCEPTABLE MANUFACTURERS REQUIRE DIFFERENT ARRANGEMENT OR CONNECTIONS FROM WHAT IS SCHEDULED, IT SHALL BE THE RESPONSIBILITY OF THE CONTRACTOR TO INSTALL THE EQUIPMENT TO OPERATE PROPERLY AND IN HARMONY WITH THE ORIGINAL INTENT OF THE DRAWINGS AND SPECIFICATIONS. THE CONTRACTOR SHALL MAKE ALL NECESSARY CHANGES IN ALL AFFECTED RELATED WORK PROVIDED UNDER OTHER SECTIONS INCLUDING LOCATION OF ROUGH-IN CONNECTIONS BY OTHER TRADES, CONDUIT SUPPORTS, INSULATION, ETC. ALL CHANGES SHALL BE MADE AT NO INCREASE IN THE CONTRACT AMOUNT OR ADDITIONAL COST TO THE OTHER TRADES AND/OR OWNER.

1.6 GUARANTEE

A. ALL EQUIPMENT AND WORK SHALL BE GUARANTEED FOR A PERIOD OF 12 MONTHS FROM THE SUBMITTAL COMPLETION DATE. ANY DEFECTS IN EQUIPMENT OR WORKMANSHIP SHALL BE PROMPTLY REPAIRED OR REPLACED BY THE CONTRACTOR WITHOUT ADDITIONAL EXPENSE TO THE OWNER. THE GUARANTEE PERIOD OF ANY PART OF THE REPAIRED ITEM SHALL BE EXTENDED FOR A PERIOD OF ONE YEAR FROM THE DATE OF SUCH REPAIR OR REPLACEMENT.

1.7 COMPLETION

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A. UPON COMPLETION OF THE PLUMBING INSTALLATION, DEMONSTRATE TO THE OWNER'S SATISFACTION THAT THE SYSTEMS HAVE BEEN INSTALLED IN A SATISFACTORY MANNER IN ACCORDANCE WITH THE PLANS AND APPLICABLE CODES. SHOW THAT ALL SYSTEMS ARE OPERABLE AND ARE PROPERLY ADJUSTED IN ACCORDANCE WITH THE DESIGN, THAT ALL FIXTURES AND EQUIPMENT OPERATES PROPERLY, THAT FILTERS AND STRAINERS ARE CLEAN, AND THAT ALL COMPONENTS OF ALL SYSTEMS ARE INSTALLED AND ADJUSTED FOR PROPER OPERATION.

PRODUCTS

LABEL.

ALL MATERIALS SHALL BE NEW AND OF THE QUALITY SPECIFIED. MATERIALS SHALL BE FREE FROM DEFECTS. MANUFACTURERS SHALL BE AS SPECIFIED HEREIN, OR BY ADDENDA. ALL PIPING EQUIPMENT, ETC., WHICH NEEDS TO BE INSULATED TO CONSERVE HEAT OR COLD, OR TO PREVENT FREEZING OR CONDENSATION, SHALL BE

INSULATED. ALL MATERIALS SHALL HAVE THE UNDERWRITERS LABORATORIES, INC.

BASIC PLUMBING METHODS

- 1.1 DIMENSION AND FIT
- A. CUT MATERIALS ACCURATELY FROM MEASUREMENTS TAKEN ON THE JOB SITE.

B. DO NOT SPRING OR BEND PIPE TO FIT CONDITIONS OR MAKE UP JOINTS.

- 1.2 SERVICEABILITY OF PRODUCTS
- A. FURNISH ALL PRODUCTS TO PROVIDE THE PROPER ORIENTATION OF SERVICEABLE COMPONENTS TO ACCESS SPACE PROVIDED.
- COORDINATE INSTALLATION OF PIPING, EQUIPMENT, SYSTEM COMPONENTS, AND OTHER PRODUCTS TO ALLOW PROPER SERVICE OF ALL ITEMS REQUIRING PERIODIC MAINTENANCE OR REPLACEMENT.
- REPLACE OR RELOCATE ALL PRODUCTS INCORRECTLY ORDERED OR INSTALLED TO PROVIDE PROPER SERVICEABLILTY
- D. PROVIDE ACCESS DOORS AND ACCESS PANELS IN CEILINGS, WALLS, FLOORS, ETC., FOR ACCESS TO TRAPS, VALVES, PRIMERS, AUTOMATIC DEVICES, AND ALL SERVICEABLE OR OPERABLE EQUIPMENT IN CONCEALED SPACES.
- 1.3 ROUTING
- A. ROUTE ALL PIPELINES PARALLEL WITH BUILDING LINES AND AS HIGH AS POSSIBLE WHILE MAINTAINING SLOPE.
- ROUTE PIPING TO CLEAR ALL DOORS, WINDOWS, AND OTHER OPENINGS AND TO AVOID ALL OTHER PIPES AND DUCTS, LIGHT FIXTURES AND SIMILAR PRODUCTS.
- PROVIDE UNIONS ADJACENT TO ALL EQUIPMENT AND WHERE REQUIRED FOR
- DISCONNECT AND MAINTENANCE OF EQUIPMENT. D. SECURELY FASTEN ALL PLUMBING WORK TO THE STRUCTURE TO PREVENT HAZARD HUMAN LIFE AND LIMB, AND TO PREVENT DAMAGE TO PRODUCTS OF CONSTRUCTION
- UNDER ALL CONDITIONS OF OPERATION. DO ALL SLEEVNG, CUTTING AND PATCHING OF ROUGH CONSTRUCTION FOR PIPING. ALL CUTTING, REPAIRING AND REQUIRED STRUCTURAL REINFORCING FOR INSTALLATION OF THIS WORK SHALL BE DONE IN CONFORMANCE WITH ARCHITECT'S DIRECTIONS AND ANY DAMAGE CAUSED BY CUTTING SHALL BE REPAIRED EQUAL TO

ORIGINAL CONDITIONS. NO CUTTING WITHOUT ARCHITECT'S APPROVAL

- PLACE ANY SLEEVES, CHASES, CONCRETE INSERTS, ANCHOR BOLTS, ETC., BEFORE CONCRETE IS POURED, AND BE RESPONSIBLE FOR CORRECT LOCATION AND INSTALLATION OF THESE ITEMS.
- IN CONCEALED LOCATIONS WHERE PIPING, OTHER THAN CAST-IRON OR GALVANIZED STEEL, IS INSTALLED THROUGH HOLES OR NOTCHES IN STUDS, JOISTS, RAFTERS OR SIMILAR MEMBERS LESS THAN 1-1/4 INCHES FROM THE NEAREST EDGE OF THE MEMBER, THE PIPE SHALL BE PROTECTED BY STEEL SHIELD PLATES. SUCH SHIELD PLATES SHALL HAVE A THICKNESS OF NOT LESS THAN 0.0575 INCH (NO 16 GAUGEO. SUCH PLATES SHALL COVER THE AREA OF THE PIPE WHERE THE MEMBER IS NOTCHED OR BORED, AND SHALL EXTEND NOT LESS THAN 2 INCHES ABOVE SOLE PLATES AND BELOW TOP PLATES.

PLUMBING INSULATION

1.1 SCOPE

- A. FURNISH ALL LABOR AND MATERIALS NECESSARY FOR THE COMPLETE INSTALLATION OF THERMAL INSULATION ON ALL HOT AND COLD PIPING SURFACES INSTALLED UNDER THIS CONTRACT WHICH REQUIRE INSULATION FOR HEAT OR COLD CONSERVATION, FREEZE PROTECTION, PREVENTION OF CONDENSATION OR DRIPPING, EFFICIENCY OR EASE OF OPERATION. PLUMBING INSULATION SHALL BE COMPLETE AND EFFECTIVE
- SYSTEMS TO RECEIVE INSULATION INCLUDE, BUT ARE NOT NECESSARILY LIMITED TO:
- 1. DOMESTIC HOT AND COLD WATER.

THROUGHOUT THE PROJECT.

2. PIPING ACCESSORIES AND SPECIALTIES.

3. CONDENSATE DRAIN LINE 1.2 PIPE INSULATION

- ALL ABOVE GRADE INSULATION SHALL BE JACKETED, AND JACKETS SHALL BE ADHERED TO INSULATION WITH ADHESIVE OR CEMENT TO MAINTAIN COMPOSITE FIRE AND SMOKE HAZARD RATING AS TESTED UNDER PROCEDURE ASTM E-84 AND NFPA 251.
- APPROVED MANUFACTURERS: CERTAINTEED, OWENS/CORNING, JOHNS-MANVILLE, UPJOHN, ARMSTRONG, OR APPROVED EQUIVALENT.
- C. INSULATE ALL DOMESTIC HOT WATER LINES, INCLUDING RUNOUTS TO HANDICAPPED FIXTURES. MINIMUM THICKNESS SHALL BE 1" FOR MOLDED FIBERGLASS INSULATION, 3/4" FOR MOLDED URETHANE INSULATION, 3/4" FOR CLOSED CELL POLYMER INSULATION (ARMAFLEX AP) OR AS REQUIRED BY LATEST ADOPTED CODES &

3 INSTALLATION

ORDINANCES.

- A. INSTALL MATERIALS IN ACCORDANCE WITH MANUFACTURER'S INSTRUCTIONS.
- B. CONTINUE INSULATION VAPOR BARRIER THROUGH PENETRATIONS.
- C. PIPING INSULATION 1. LOCATE INSULATION AND COVER SEAMS IN LEAST VISIBLE LOCATIONS.

- NEATLY FINISH INSULATION AT SUPPORTS, PROTRUSIONS, AND INTERRUPTIONS. PROVIDE INSULATED DUAL TEMPERATURE PIPES OR COLD PIPES CONVEYING
- FLUIDS BELOW AMBIENT TEMPERATURE WITH VAPOR BARRIER JACKETS. FINISH WITH GLASS CLOTH AND VAPOR BARRIER ADHESIVE. INSULATE COMPLETE
- FOR INSULATED PIPES CONVEYING FLUIDS ABOVE AMBIENT TEMPERATURE, PROVIDE STANDARD JACKETS. BEVEL AND SEAL ENDS OF INSULATION AT

EQUIPMENT, FLANGES, AND UNIONS.

- 5. FOR PIPES WITH EXPOSED INSULATION, PROVIDE SUPPORT SHIELDS NOT LESS THAN 12" AT ALL SUPPORTS.
- PROVIDE INSERT BETWEEN SUPPORT SHIELD AND PIPING ON PIPING 2 INCHES DIAMETER OR LARGER. FABRICATE OF CORK OR OTHER HEAVY DENSITY INSULATING MATERIAL SUITABLE FOR TEMPERATURE, NOT LESS THAN 6 INCHES

PLUMBING EQUIPMENT, FIXTURES, PIPING AND SPECIALTIES

1.1 CONNECTION TO WATER SOURCE

- A. PROVIDE CONNECTION, AND COORDINATE ALL INCIDENTAL SERVICES TO PROPERLY INTERFACE THE WATER DISTRIBUTION SYSTEM WITH THE WATER SOURCE. PROVIDE APPROPRIATE MATERIALS, COMPATIBLE JOINTS, DIELECTRIC UNIONS, SUPPORTS, AND ALL OTHER PRODUCTS FOR THE PROPER CONNECTION AT THE SOURCE. REFERENCE CIVIL DRAWINGS FOR CONNECTION POINT.
- 1.2 CONNECTION TO DISPOSAL POINT
- A. PROVIDE CONNECTION AND COORDINATE ALL INCIDENTAL SERVICES TO PROPERLY INTERFACE THE WASTEWATER SYSTEM WITH THE POINT OF DISPOSAL. PROVIDE APPROPRIATE MATERIALS, COMPATIBLE JOINTS, SUPPORTS, AND ALL OTHER PRODUCTS FOR CONNECTION TO THE DISPOSAL POINT. REFERENCE CIVIL DRAWINGS FOR CONNECTION POINT.

2.1 SANITARY SEWER PIPING

- A. SCHEDULE 40 PVC UNLESS UNDER DRIVE AREA. PIPING UNDER DRIVE AREAS SHALL BE SCHEDULE 80 PVC.
- B. GRADE ALL HORIZONTAL RUNS OF PIPE IN BUILDING AND UNDER FLOOR SLAB AT 1/4" PER FOOT DOWNWARD IN DIRECTION OF FLOW.
- SUPPORT ALL HORIZONTAL RUNS OF PIPE IN BUILDING AT INTERVALS NOT TO EXCEED 5'-0" AND AT EACH CHANGE OF DIRECTION. PROVIDE A SUPPORT AT THE BASE OF VERTICAL RISERS WITH INTERMEDIATE SUPPORTS AS REQUIRED. BRACE ALL PIPING ADEQUATELY TO PREVENT MOTION, PER MANUFACTURER'S RECOMMENDATIONS.

D. CLEANOUTS:

- PROVIDE A CLEANOUT EVERY 100 FEET.
- 2. PROVIDE 2-WAY CLEANOUT AT EACH POINT WASTEWATER LEAVES THE BUILDING.
- 3. PROVIDE CLEANOUTS AT ALL POINTS REQUIRED BY LATEST ADOPTED CODE. E. VENTING
- PROVIDE A VENT FOR EACH TRAP OR AS SHOWN ON THE DRAWINGS.
- 2. EXTEND EACH VENT VERTICALLY TO A POINT NOT LESS THAN 6" ABOVE THE EXTREME OVERFLOW LEVEL OF THE FIXTURE SERVED BEFORE OFFSETTING HORIZONTALLY. WHENEVER TWO OR MORE VENT PIPES CONVERGE, EXTEND EACH SUCH PIPE AT LEAST 6" IN HEIGHT ABOVE THE TOP OF THE PLUMBING FIXTURE IT SERVES BEFORE BEING CONNECTED TO ANY OTHER VENT.
- VENTS THROUGH ROOF: EXTEND VENTS THROUGH THE ROOF A MINIMUM DISTANCE OF 6" AND TERMINATE AT LEAST 15 FT. HORIZONTALLY FROM OPERABLE WINDOWS, DOORS OR AIR INTAKES, AND AT LEAST 3 FT. ABOVE SUCH OPENINGS OR AS ADOPTED BY THE LATEST CODES & ORDINANCES.
- 2.2 WATER PIPING, BURIED BEYOND BUILDING A. PVC PIPE: ASTM D1785, SCHEDULE 40, OR ASTM D2241, MINIMUM 150 PSIG PRESSURE
- RATING WITH SOLVENT WELD JOINTS. 2.3 WATER PIPING, BURIED UNDER BUILDING
- A. COPPER TUBING: ASTM B88, TYPE K, ANNEALED WITH WROUGHT COPPER FITTINGS

2.4 WATER PIPING, ABOVE GRADE

AND GRADE 95TA SOLDER JOINTS.

A. COPPER TUBING: ASTM B88, TYPE L, HARD DRAWN, WITH CAST BRASS OR WROUGHT COPPER FITTINGS AND GRADE 95TA SOLDER JOINTS.

- 2.5 ACCESS PANELS A. AT A MINIMUM, PROVIDE ACCESS PANELS WHERE REQUIRED BY CODE AND FOR MAINTENANCE OR SERVICE. ACCESS PANELS SHALL BE PROVIDED FOR VALVES, CONTROLS AND EQUIPMENT ABOVE GYPSUM PLASTER, OR SIMILAR CEILINGS OR
- BEHIND GYPSUM PLASTER OR SIMILAR WALLS. B. PANELS IN CEILINGS SHALL BE FLANGED STEEL CONSTRUCTION, WITH CONTINUOUS HINGE AND WITH QUARTER TURN SCREW LOCK, INSTALLED FLUSH WITH ADJACENT SURFACES AND PAINTED TO MATCH. UNLESS OTHERWISE INDICATED, PANELS SHALL BE SIZED AND LOCATED FOR EASY ACCESS TO AND REPLACEMENT OF EQUIPMENT BUT
- NOT LESS THAN 24" X 24". ACCESS PANELS IN WALLS SHALL BE OF FLANGED SATIN FINISH STAINLESS STEEL

CONSTRUCTION. 2.6 PLUMBING FIXTURES

- A. REFER TO FIXTURE SCHEDULE ON DRAWINGS.
- B. PLUMBING FIXTURES SHALL BE STANDARD PRODUCTS AS MANUFACTURED BY CRANE, KOHLER, ELJER, AMERICAN STANDARD, DELTA, OR UNIVERSAL RUNDALL.
- PROVIDE PERMANENT METAL AND WIRE POSITIONERS AND SUPPORTS TO SECURE FIXTURES AND PIPING RIGIDLY IN PROPER ALIGNMENT WITHOUT SWAY OR SIDEPLAY
- D. INSTALL ALL FIXTURES PLUMB, LEVEL AND FLUSH TO THE FINISHED ARCHITECTURAL SURFACE, SO THAT THE MAXIMUM GAP BETWEEN THE FIXTURE AND THE SURFACE DOES NOT EXCEED 3/16 INCH. CAULK THE EDGE OF THE JOINT BETWEEN FIXTURE AND
- ADJUST ALL FUNCTIONAL COMPONENTS FOR PROPER OPERATION IN ACCORDANCE WITH MANUFACTURER'S RECOMMENDATIONS, OR AS OTHERWISE DIRECTED.

SURFACE WITH SILICONE OR BUTYL TYPE WATERPROOF CAULKING COMPOUND.

- G. CLEAN ALL FIXTURES AND TRIM THOROUGHLY TO SPOTLESSLY CLEAN CONDITION.
- H. ALL WALL HUNG PLUMBING FIXTURES SHALL BE SUPPORTED BY MEANS OF A CARRIER CONCEALED WITHIN THE WALL, AS MANUFACTURED BY J.R. SMITH, JOSAM, OR ZURN.

A. PROVIDE TRAP PRIMERS FOR ALL FLOOR DRAINS, HUB DRAINS AND FLOOR SINKS.

PRESSURE DROP ACTIVATION AND VACUUM BREAKER.

- 1. GRAVITY FED (FROM LAVATORIES ONLY): SIOUX MODEL 200-090 OR EQUIVALENT. 2. MECHANICALLY ACTIVATED: JOSAM MODEL 88300 OR EQUIVALENT WITH 5 PSI
- 3. ELECTRONICALLY ACTIVATED: ZURN MODEL Z1020 OR EQUIVALENT. COORDINATE WITH ELECTRICAL CONTRACTOR TO PROVIDE POWER FROM NEAREST RECEPTACLE

C. EQUIVALENT MANUFACTURERS: JOSAM, ZURN, SLOAN, SIOUX, OR JAY R. SMITH.

- D. TRAP PRIMERS AND TRAP PRIMER SHUT OFF VALVES SHALL BE LOCATED WITHIN THE WALL OR ABOVE THE CEILING AND SHALL BE PROVIDED WITH ACCESS PANELS OR OTHER APPROVED MEANS OF ACCESS. FOR EACH ROOM, THE CONTRACTOR SHALL CENTRALLY LOCATE TRAP PRIMERS TO MINIMIZE THE NUMBER OF ACCESS PANELS.
- COORDINATE ALL ACCESS PANELS WITH THE ARCHITECT. 2.8 FREEZE PROTECTION

B. ACCEPTABLE TYPES AND MODELS

- A. ALL DOMESTIC WATER PIPING SUBJECTED TO FREEZING TEMPERATURES SHALL BE PROVIDED WITH FREEZE PROTECTION EITHER BY HEAT TRACE, MANUAL SHUT OFF, OR
- OTHER APPROVED METHOD.
- 3.1 INSTALLATION PROVIDE DIELECTRIC CONNECTIONS WHEREVER JOINING DISSIMILAR METALS.
- B. INSTALL PIPING TO CONSERVE BUILDING SPACE AND NOT INTERFERE WITH USE OF SPACE. GROUP PIPING WHENEVER PRACTICAL AT COMMON ELEVATIONS.
- C. INSTALL PIPING TO ALLOW FOR EXPANSION AND CONTRACTION WITHOUT STRESSING PIPE, JOINTS, OR CONNECTED EQUIPMENT.
- D. PROVIDE CLEARANCE FOR INSTALLATION OF INSULATION AND ACCESS TO VALVES AND FITTINGS.
- E. SLOPE WATER PIPING AND ARRANGE TO DRAIN AT LOW POINTS.
- F. INSTALL BELL AND SPIGOT PIPE WITH BELL END UPSTREAM.
- G. INSTALL SPECIALTIES IN ACCORDANCE WITH MANUFACTURER'S INSTRUCTIONS. H. EXTEND CLEANOUTS TO FINISHED FLOOR OR WALL SURFACE. LUBRICATE THREADED CLEANOUT PLUGS WITH MIXTURE OF GRAPHITE AND LINSEED OIL. ENSURE CLEARANCE
- AT CLEANOUT FOR RODDING OF DRAINAGE SYSTEM. INSTALL WATER HAMMER ARRESTORS AS MANUFACTURED BY SIOUX CHIEF, WATTS, J.R. SMITH OR APPROVED EQUIVALENT ON COLD WATER AND HOT WATER SUPPLIES
- TO PLUMBING FIXTURES, COMPLETE WITH ACCESSIBLE ISOLATION VALVE. J. INSTALL EACH FIXTURE WITH CHROME PLATED RIGID OR FLEXIBLE SUPPLIES WITH STOP VALVES, REDUCERS, AND ESCUTCHEONS.
- K. ADJUST STOPS OR VALVES FOR INTENDED WATER FLOW RATE TO FIXTURES WITHOUT SPLASHING, NOISE, OR OVERFLOW.

. INSTALL WATER HEATERS IN ACCORDANCE WITH MANUFACTURER'S INSTRUCTIONS

LENGTHS OF RED BRASS PIPE WITH THREADED ENDS OF COPPER TO IPS ADAPTERS,

- AND TO NFPA & UL REQUIREMENTS. COORDINATE WITH PLUMBING PIPING AND RELATED ELECTRICAL WORK TO ACHIEVE OPERATING SYSTEM. M. WHERE REQUIRED FOR CONNECTIONS TO FIXTURES, EQUIPMENT ITEMS, ETC., EMPLOY
- BRASS COUPLINGS. ETC.. TO THE END THAT THERE SHALL BE NO FERROUS PIPE IN ANY WATER PIPING SYSTEMS. N. STERILIZE EACH UNIT OF COMPLETED SUPPLY LINE AND DISTRIBUTION SYSTEM WITH CHLORINE BEFORE ACCEPTANCE FOR DOMESTIC OPERATION. PROVIDE WRITTEN CERTIFICATION TO OWNER THAT PROPER STERILIZATION OF DOMESTIC SYSTEM HAS
- BEEN COMPLETED. O. ALL PIPING SHALL BE SUPPORTED PER LATEST ADOPTED CODES & ORDINANCES.



Structural Engineer

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MEP Engineer

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Civil Engineer:

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Landscape Architect

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ISSUANCES			
01	SCHEMATIC DESIGN	09.10.18	
02	DEVELOPMENT DESIGN	11.09.18	
03	PERMIT SET	01.28.19	



REVISIONS



a multifamily project for

West Cevallos

San Antonio. Texas

PLUMBING SPECIFICATIONS

18054 **Project Number** 01/14/2018 TLR Drawn By EEC Checked By

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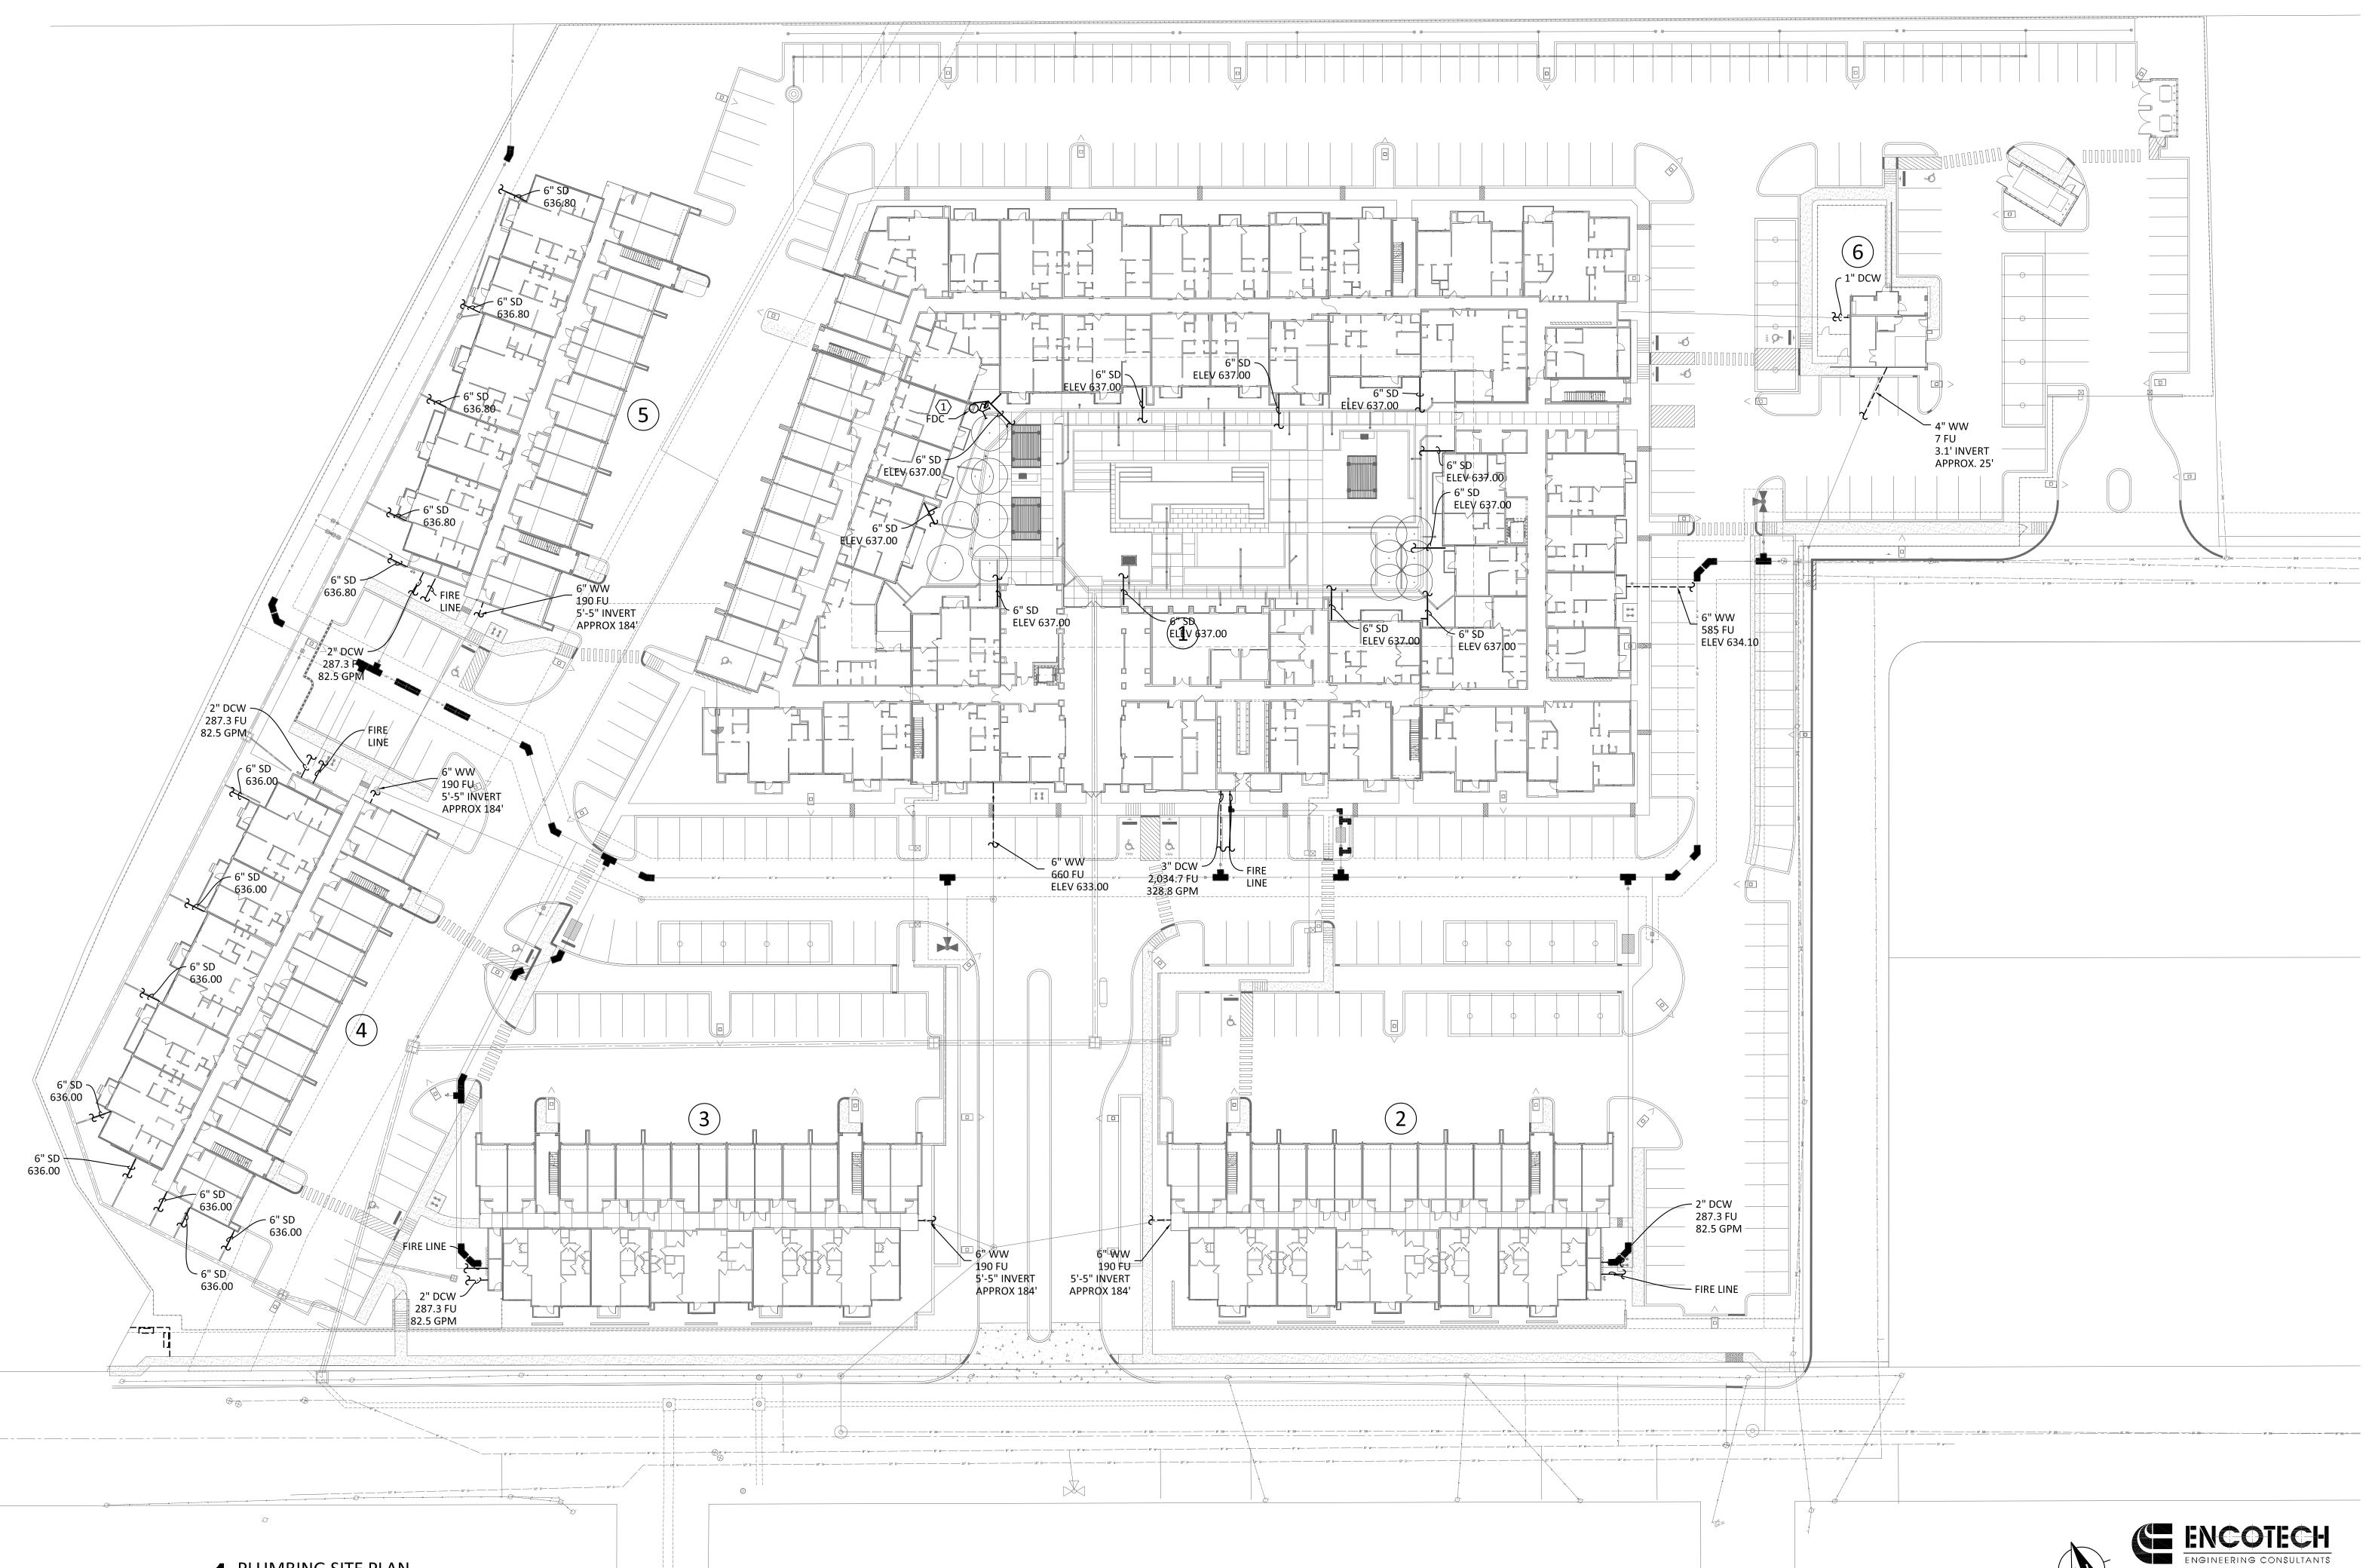


- A. REFER TO SHEET POOD FOR ADDITIONAL INFORMATION.
- FIRE LINE SHOWN FOR COORDINATION ONLY. SIZING AND ROUTING SHALL BE PER FIRE PROTECTION CONTRACTOR AND ENGINEER.

KEYED NOTES

ED NOTES

PROVIDE FIRE DEPARTMENT CONNECTION IN COURTYARD. REFER TO FIRE PROTECTION PLANS FOR ADDITIONAL INFORMATION AND SIZE.



PLUMBING SITE PLAN

SCALE: 1"=30'-0"



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ISSUANCES 01 SCHEMATIC DESIGN 09.10.18 02 DEVELOPMENT DESIGN 11.09.18 03 PERMIT SET 01.28.19



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PLUMBING SITE PLAN

Project Number 18054

Date 01/14/2018


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PLUMBING WASTEWATER - BUILDING I - OVERALL
SCALE: 1/8"=1'-0"







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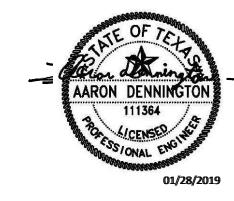
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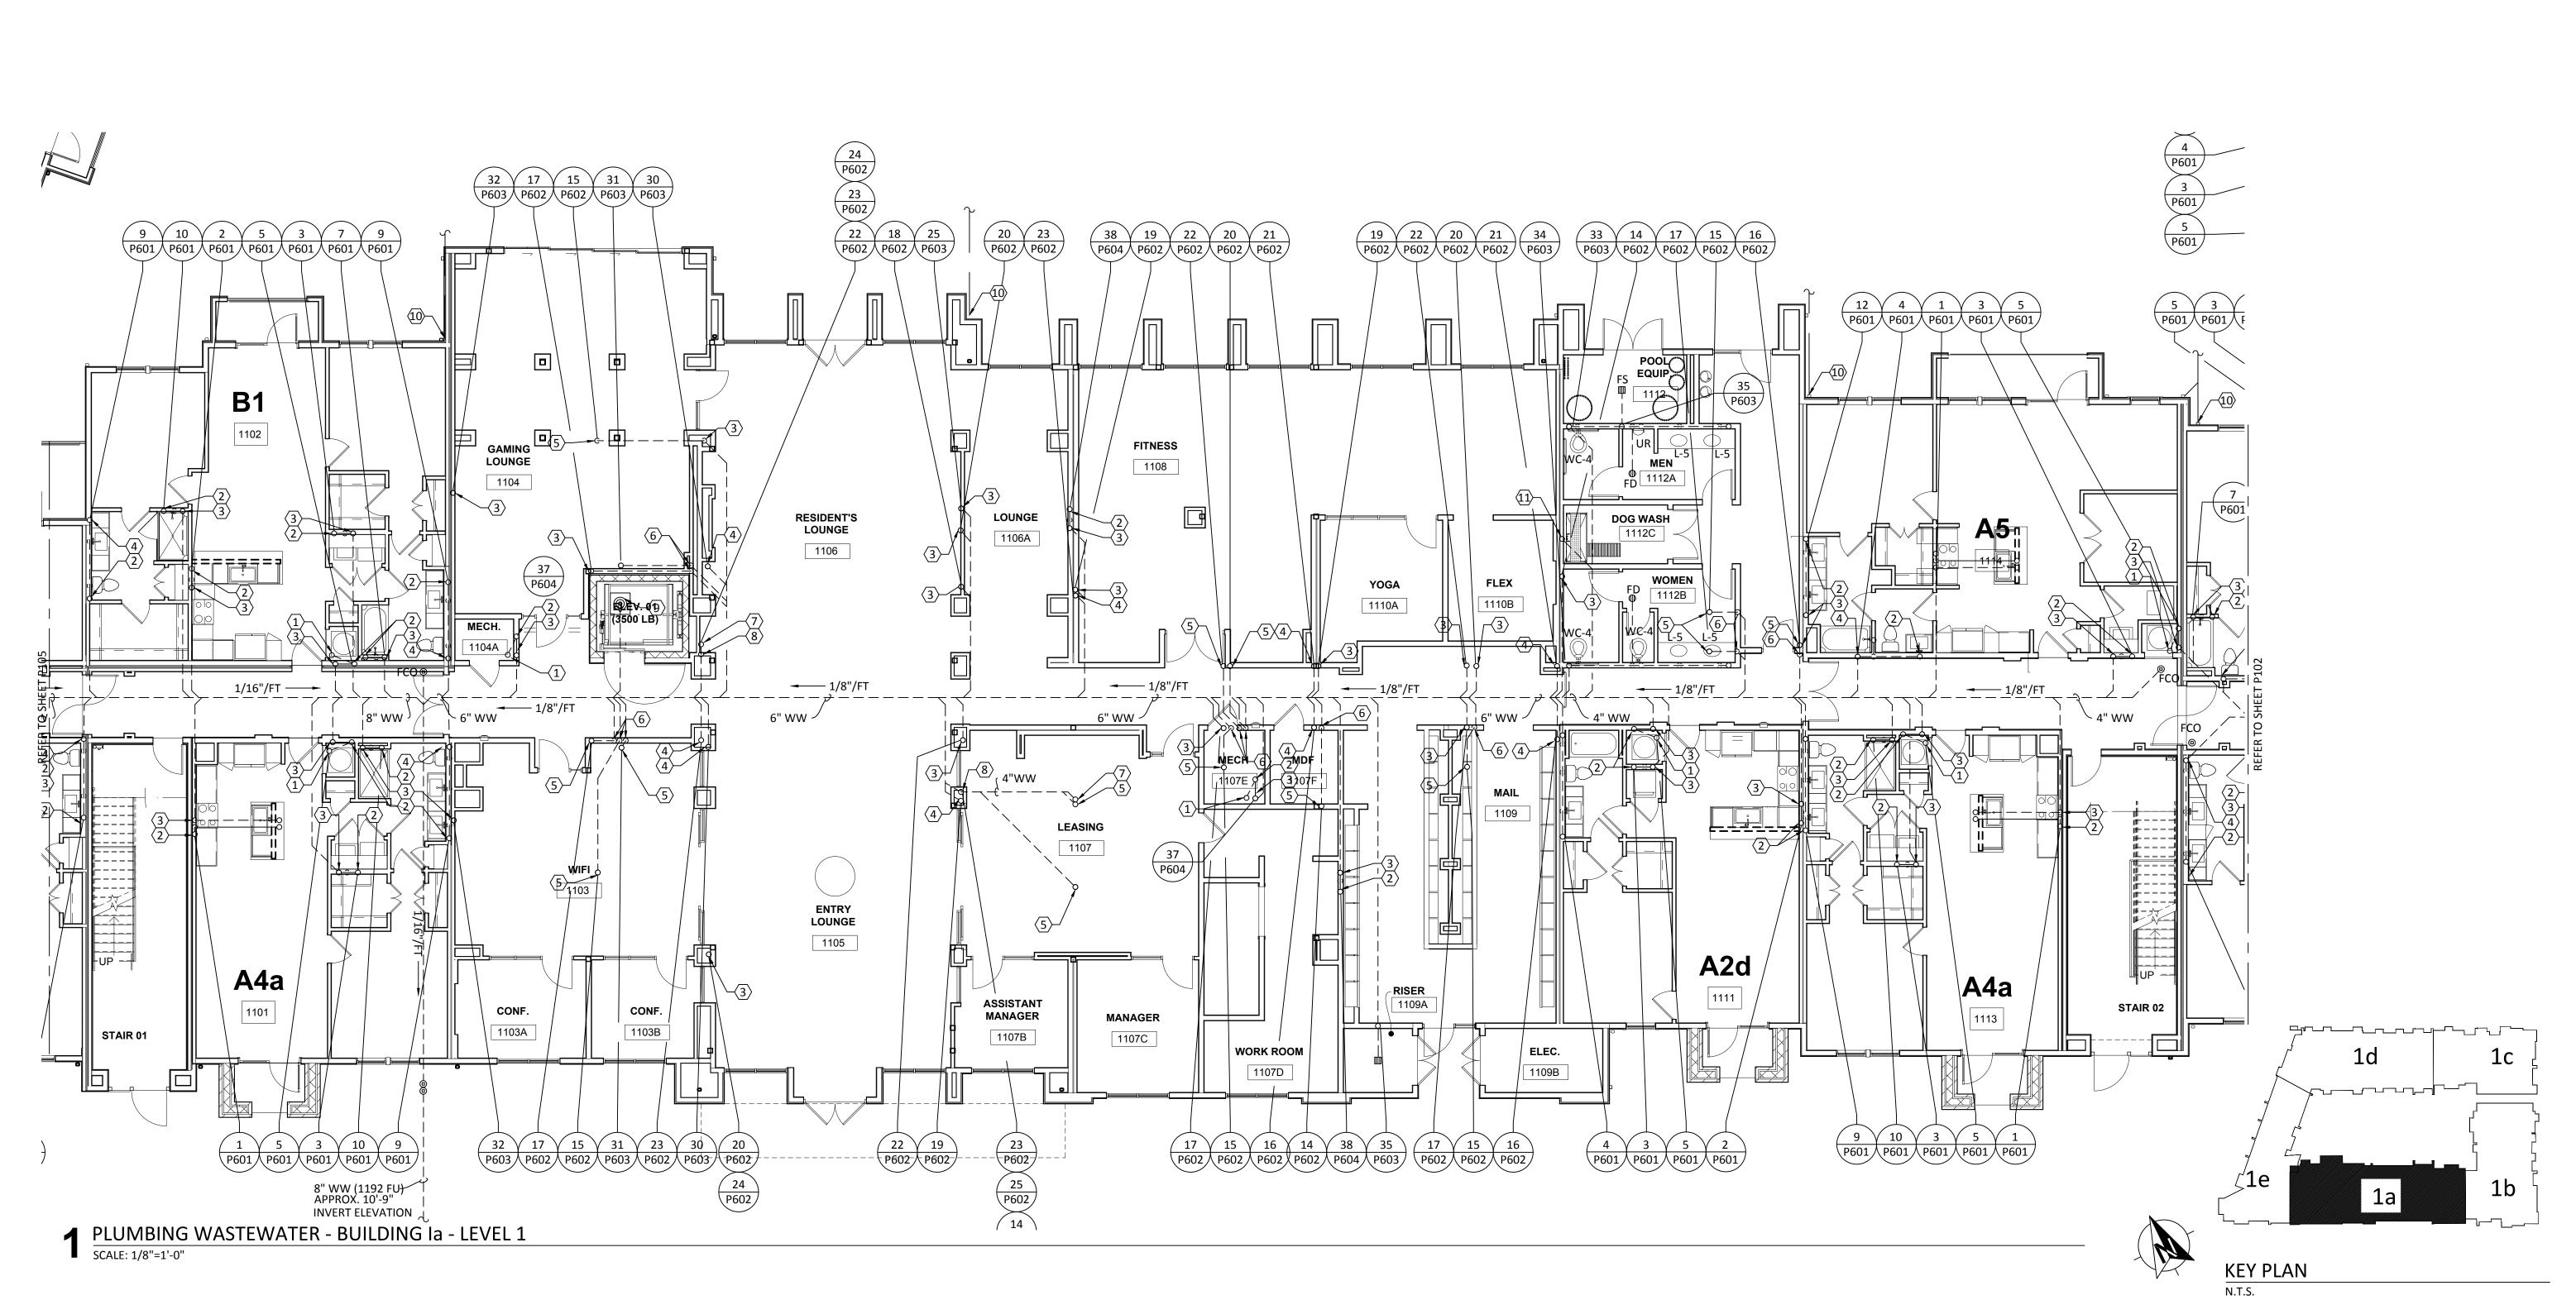
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PLUMBING WASTEWATER BUILDING 1 OVERALL

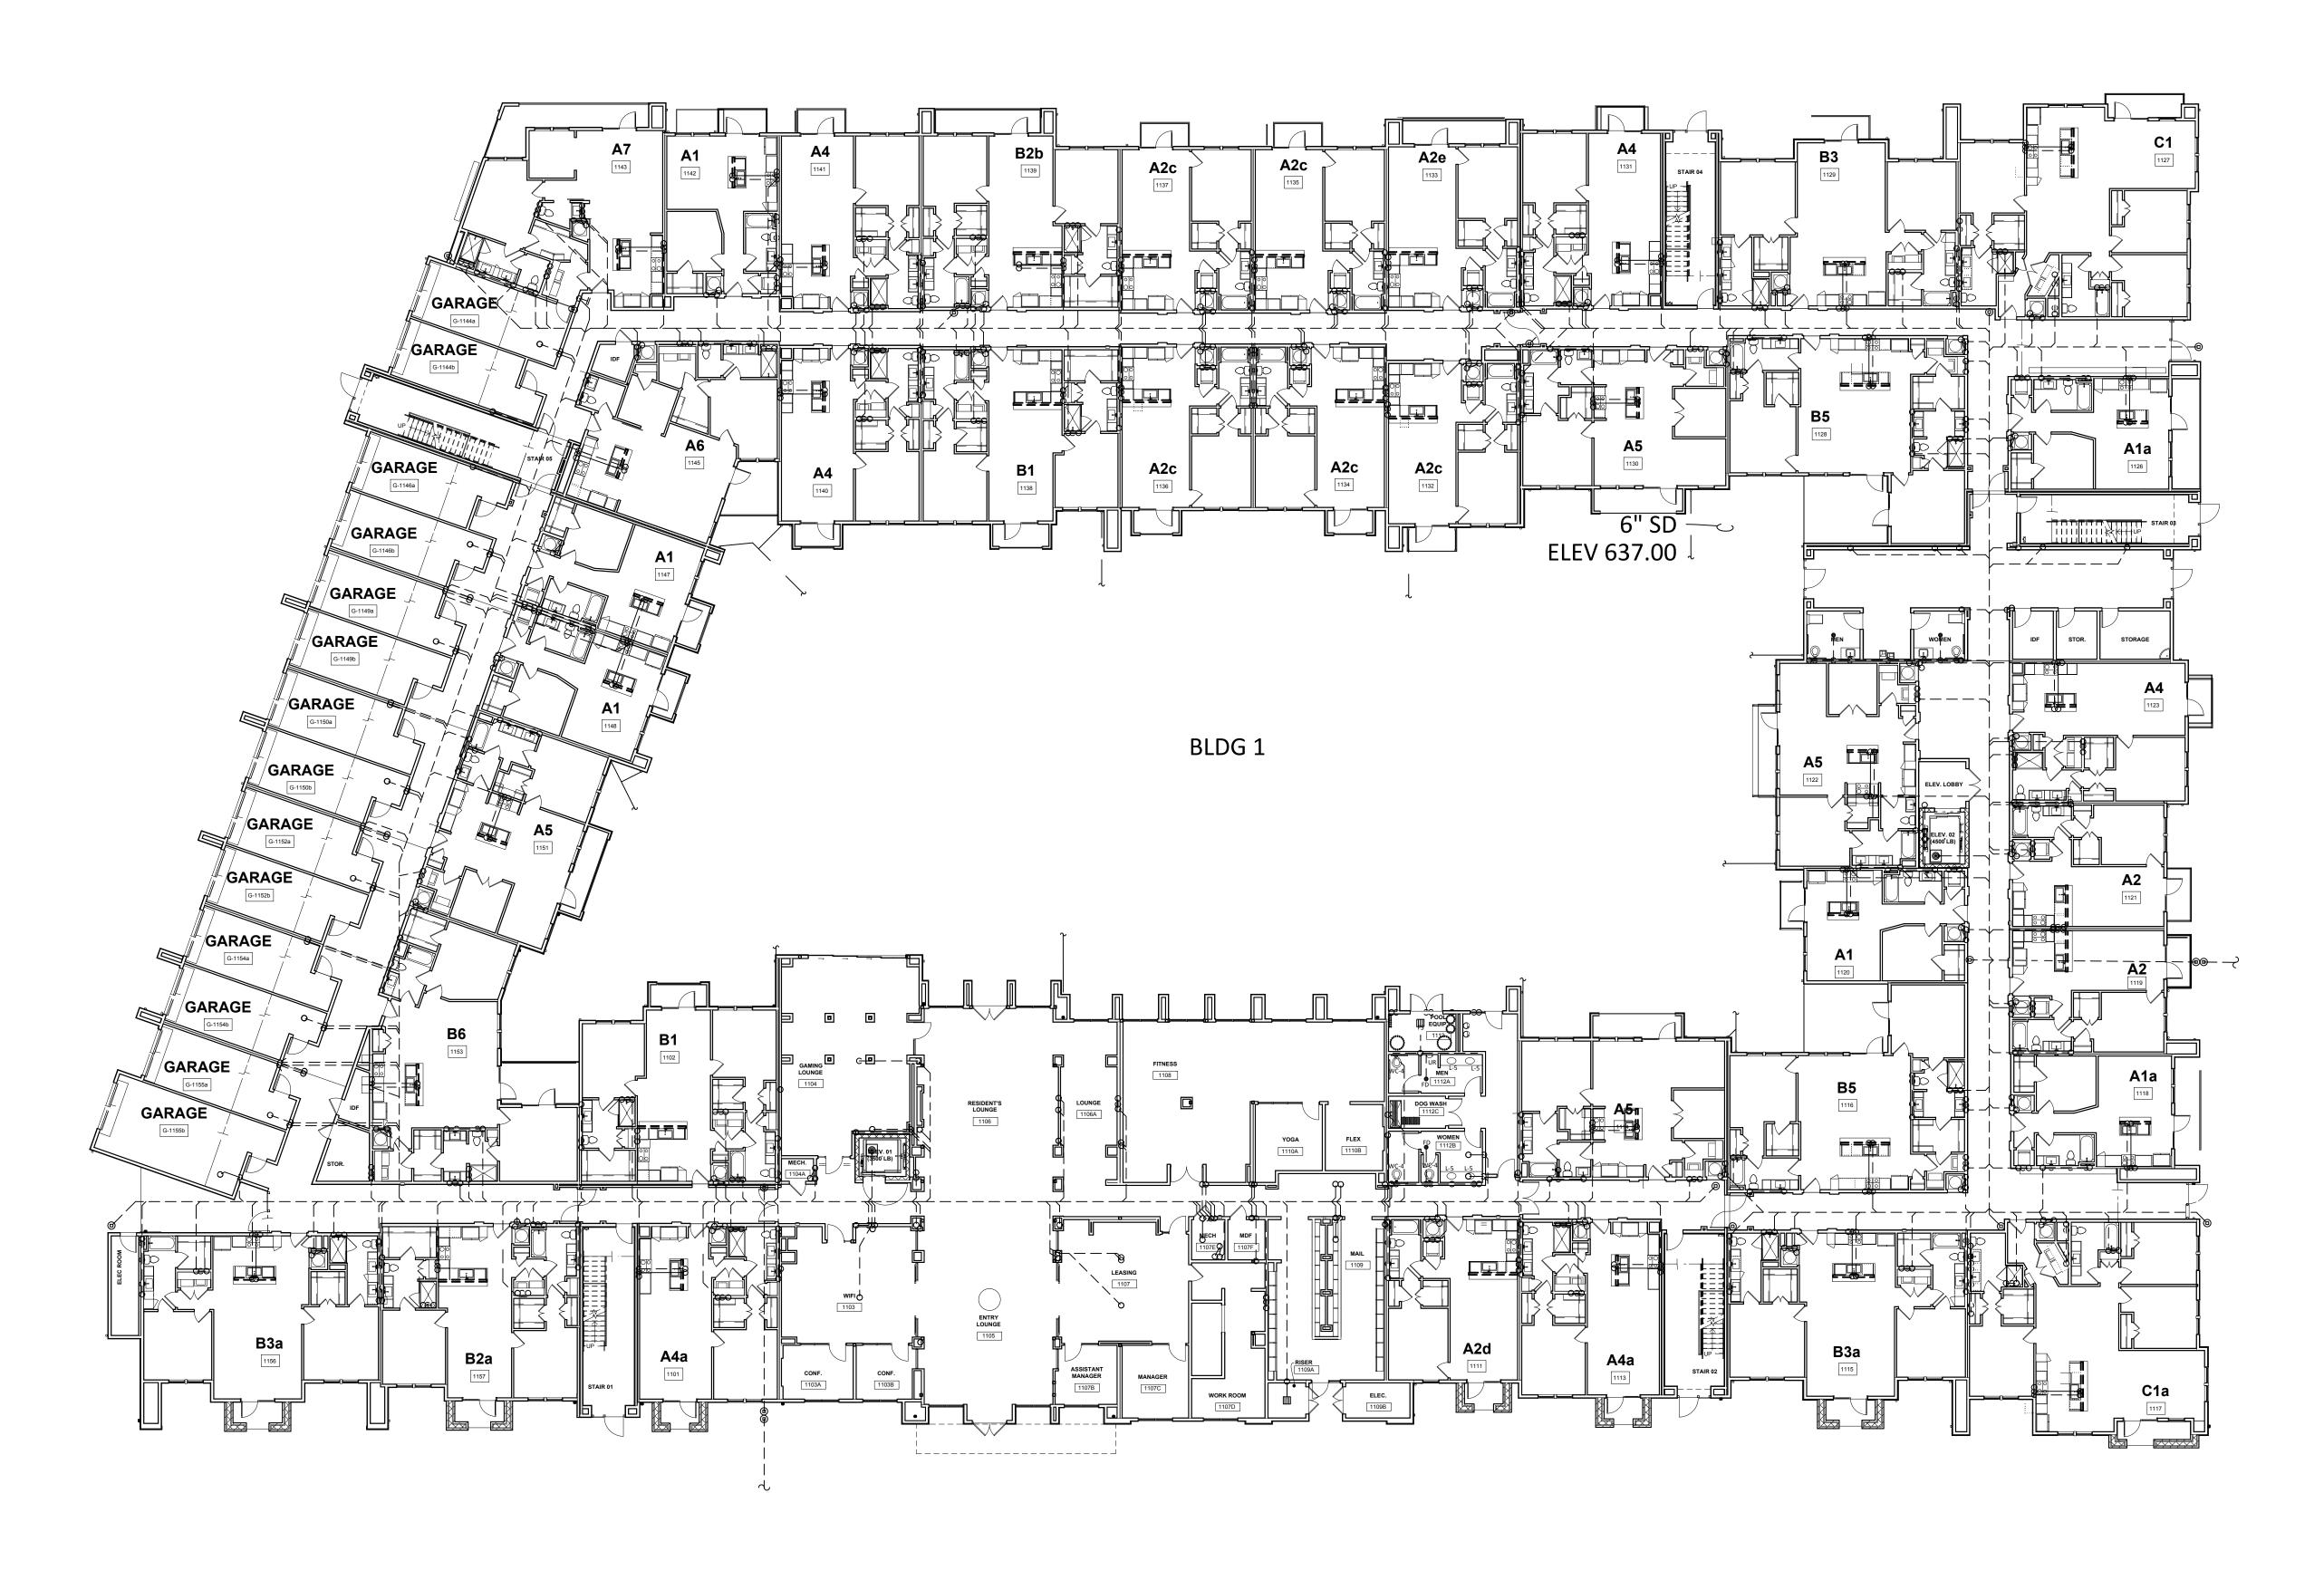Project Number	18054
Date	01/14/2018
Drawn By	TLR
Checked By	EEC

P100





Structural Engineer:

GENERAL NOTES:

KEYED NOTES:

FOR ACCESSIBILITY.

2. 2" VENT TO FLOOR ABOVE.

REFER TO SHEET P000 FOR ADDITIONAL INFORMATION.

3. 2" WASTEWATER FROM FLOOR ABOVE TO BELOW SLAB.

4" WASTEWATER FROM FLOOR ABOVE TO BELOW SLAB.

PROVIDE SUMP PUMP "SP-1" IN ELEVATOR PIT. DISCHARGE TO WASTEWATER DRAIN. REFER TO STRUCTURAL FOR EXACT LOCATION

0. CONNECT 6" DOWNSPOUT TO 6" STORM PIPE IN COURTYARD. ALL

ELEVATIONS ARE 637.00 AT POINT OF CONNECTION.

L. PROVIDE 2" WASTEWATER DRAIN FOR DOG WASH.

2" WASTEWATER FROM FLOOR ABOVE.

4" WASTEWATER FROM FLOOR ABOVE.

2" WASTEWATER TO BELOW SLAB.

4" WASTEWATER TO BELOW SLAB.

OF PIT. REFER TO DETAIL 8/P703.

PROVIDE TRAP PRIMER FOR ALL HUB DRAINS AND FLOOR DRAINS. EXTND 1/2" DOMESTIC WATER TO TRAP PRIMER.

2" HUB DRAIN "HB-1" LOCATED IN FRONT OF MECHANICAL CLOSET

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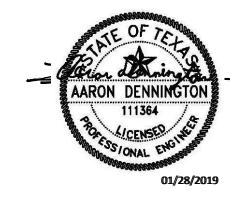
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West Cevallos San Antonio, Texas


PLUMBING WASTEWATER **BUILDING 1a LEVEL 1**

Project Number	18054
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ENGINEERING CONSULTANTS

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✓ PLUMBING WASTEWATER - BUILDING Ib - LEVEL 1



REFER TO SHEET P000 FOR ADDITIONAL INFORMATION.

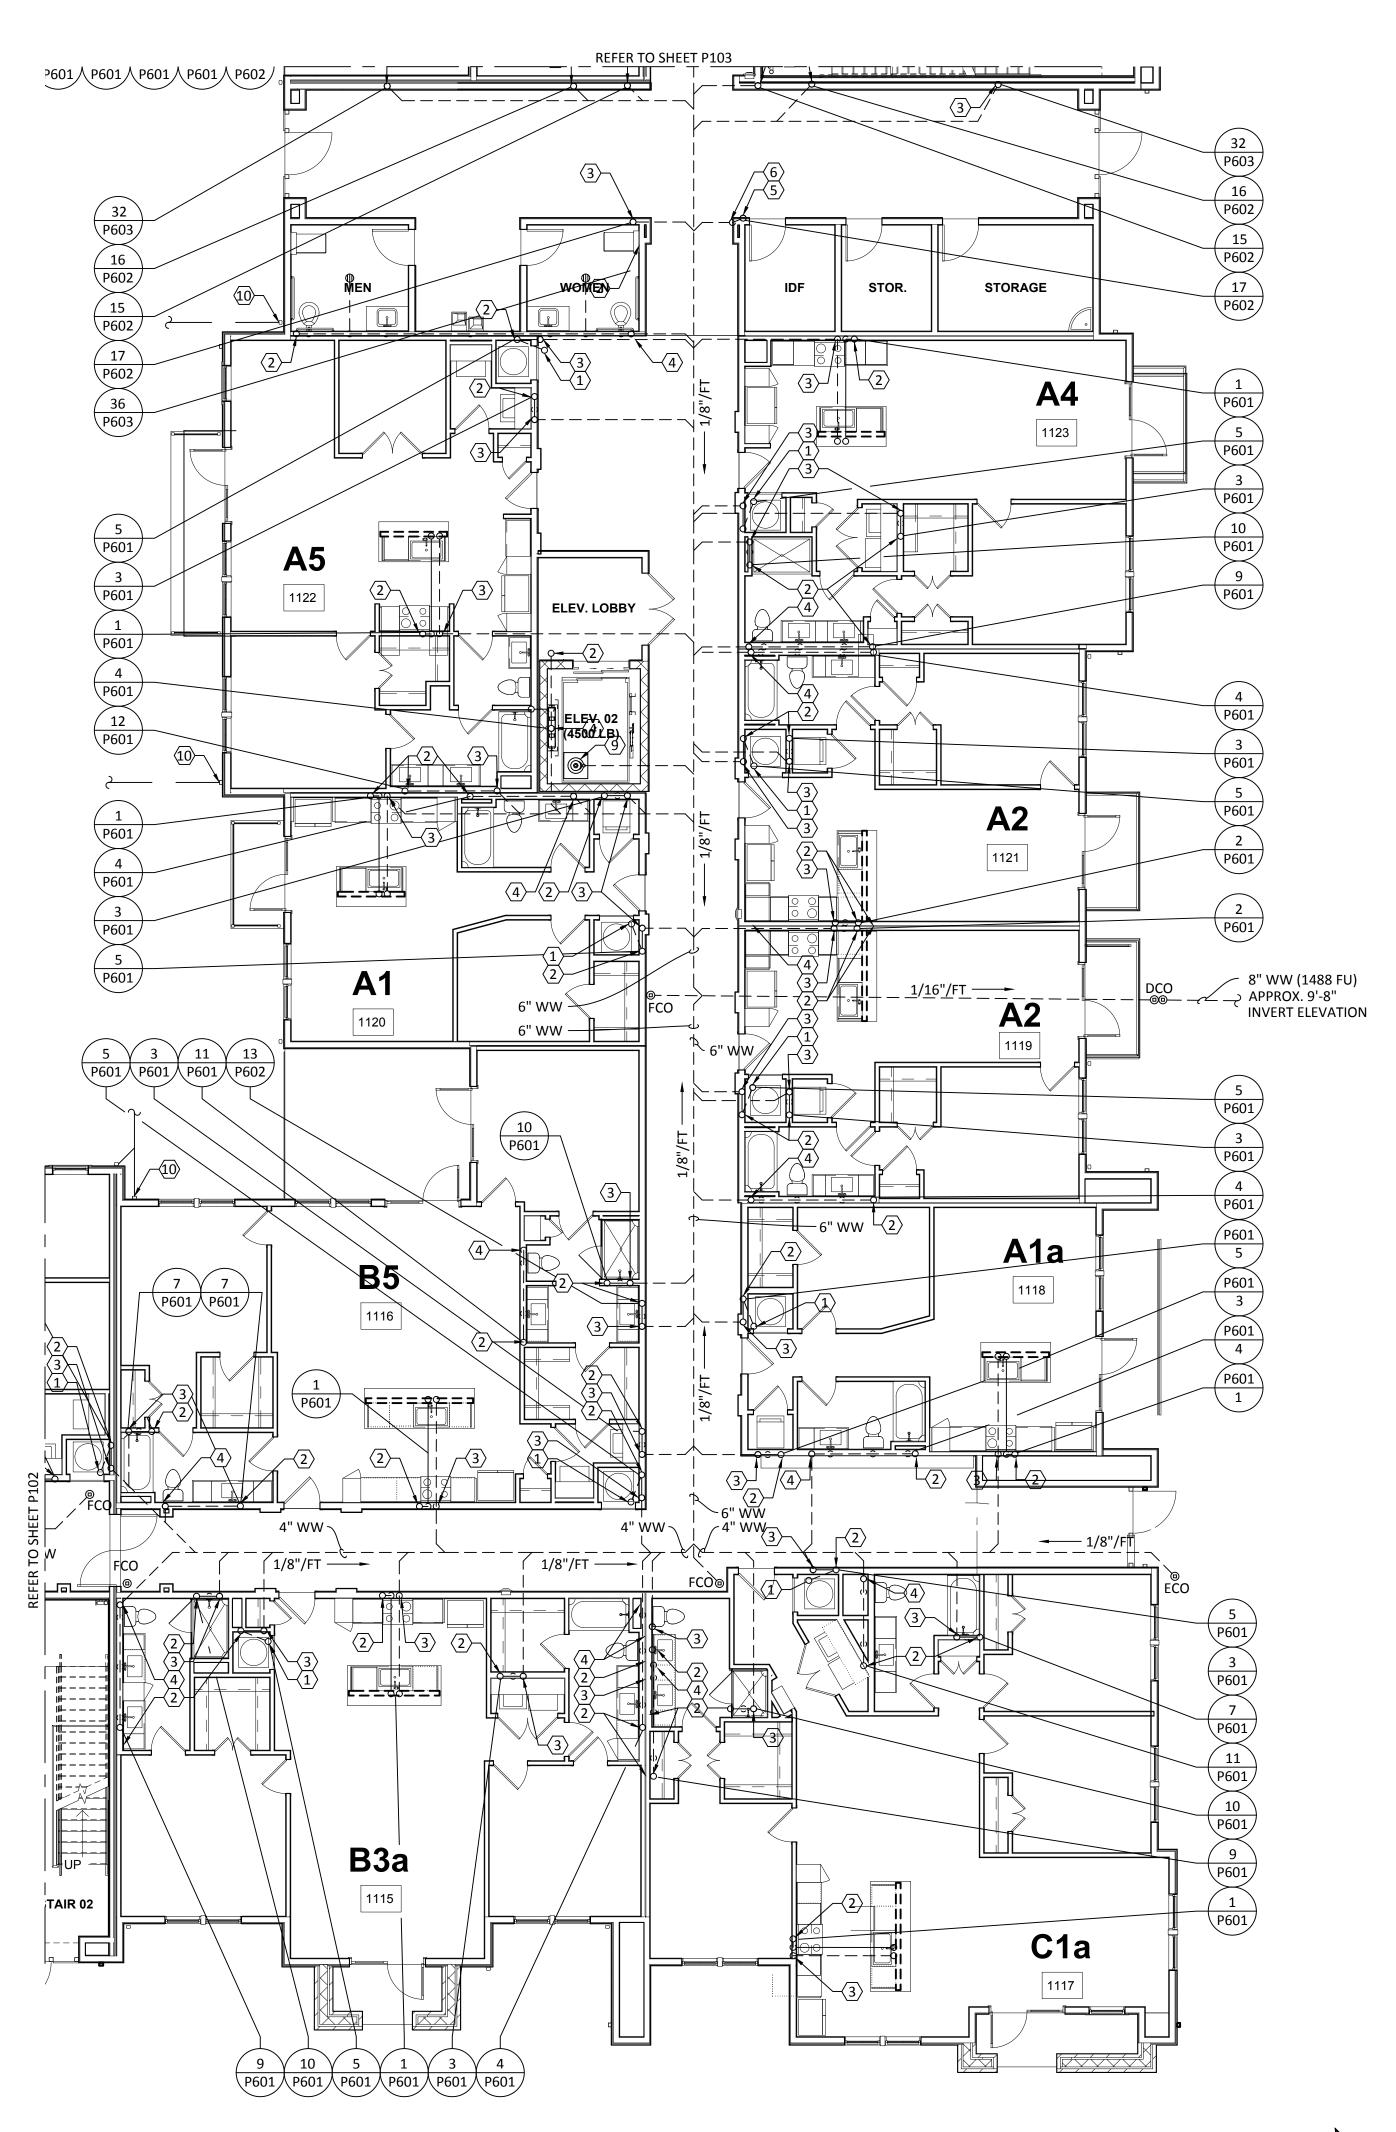PROVIDE TRAP PRIMER FOR ALL HUB DRAINS AND FLOOR DRAINS. EXTND 1/2" DOMESTIC WATER TO TRAP PRIMER.

KEYED NOTES:

- 2" HUB DRAIN "HB-1" LOCATED IN FRONT OF MECHANICAL CLOSET FOR ACCESSIBILITY.
- 2. 2" VENT TO FLOOR ABOVE.
- 3. 2" WASTEWATER FROM FLOOR ABOVE TO BELOW SLAB.
- 4" WASTEWATER FROM FLOOR ABOVE TO BELOW SLAB.
- 2" WASTEWATER FROM FLOOR ABOVE.
- 2" WASTEWATER TO BELOW SLAB.
- 4" WASTEWATER FROM FLOOR ABOVE.
- 4" WASTEWATER TO BELOW SLAB.

OF PIT. REFER TO DETAIL 8/P703.

- PROVIDE SUMP PUMP "SP-1" IN ELEVATOR PIT. DISCHARGE TO WASTEWATER DRAIN. REFER TO STRUCTURAL FOR EXACT LOCATION
-). CONNECT 6" DOWNSPOUT TO 6" STORM PIPE IN COURTYARD. ALL ELEVATIONS ARE 637.00 AT POINT OF CONNECTION.
- . PROVIDE 2" WASTEWATER DRAIN FOR DOG WASH.

DAVIES COLLABORATIVE

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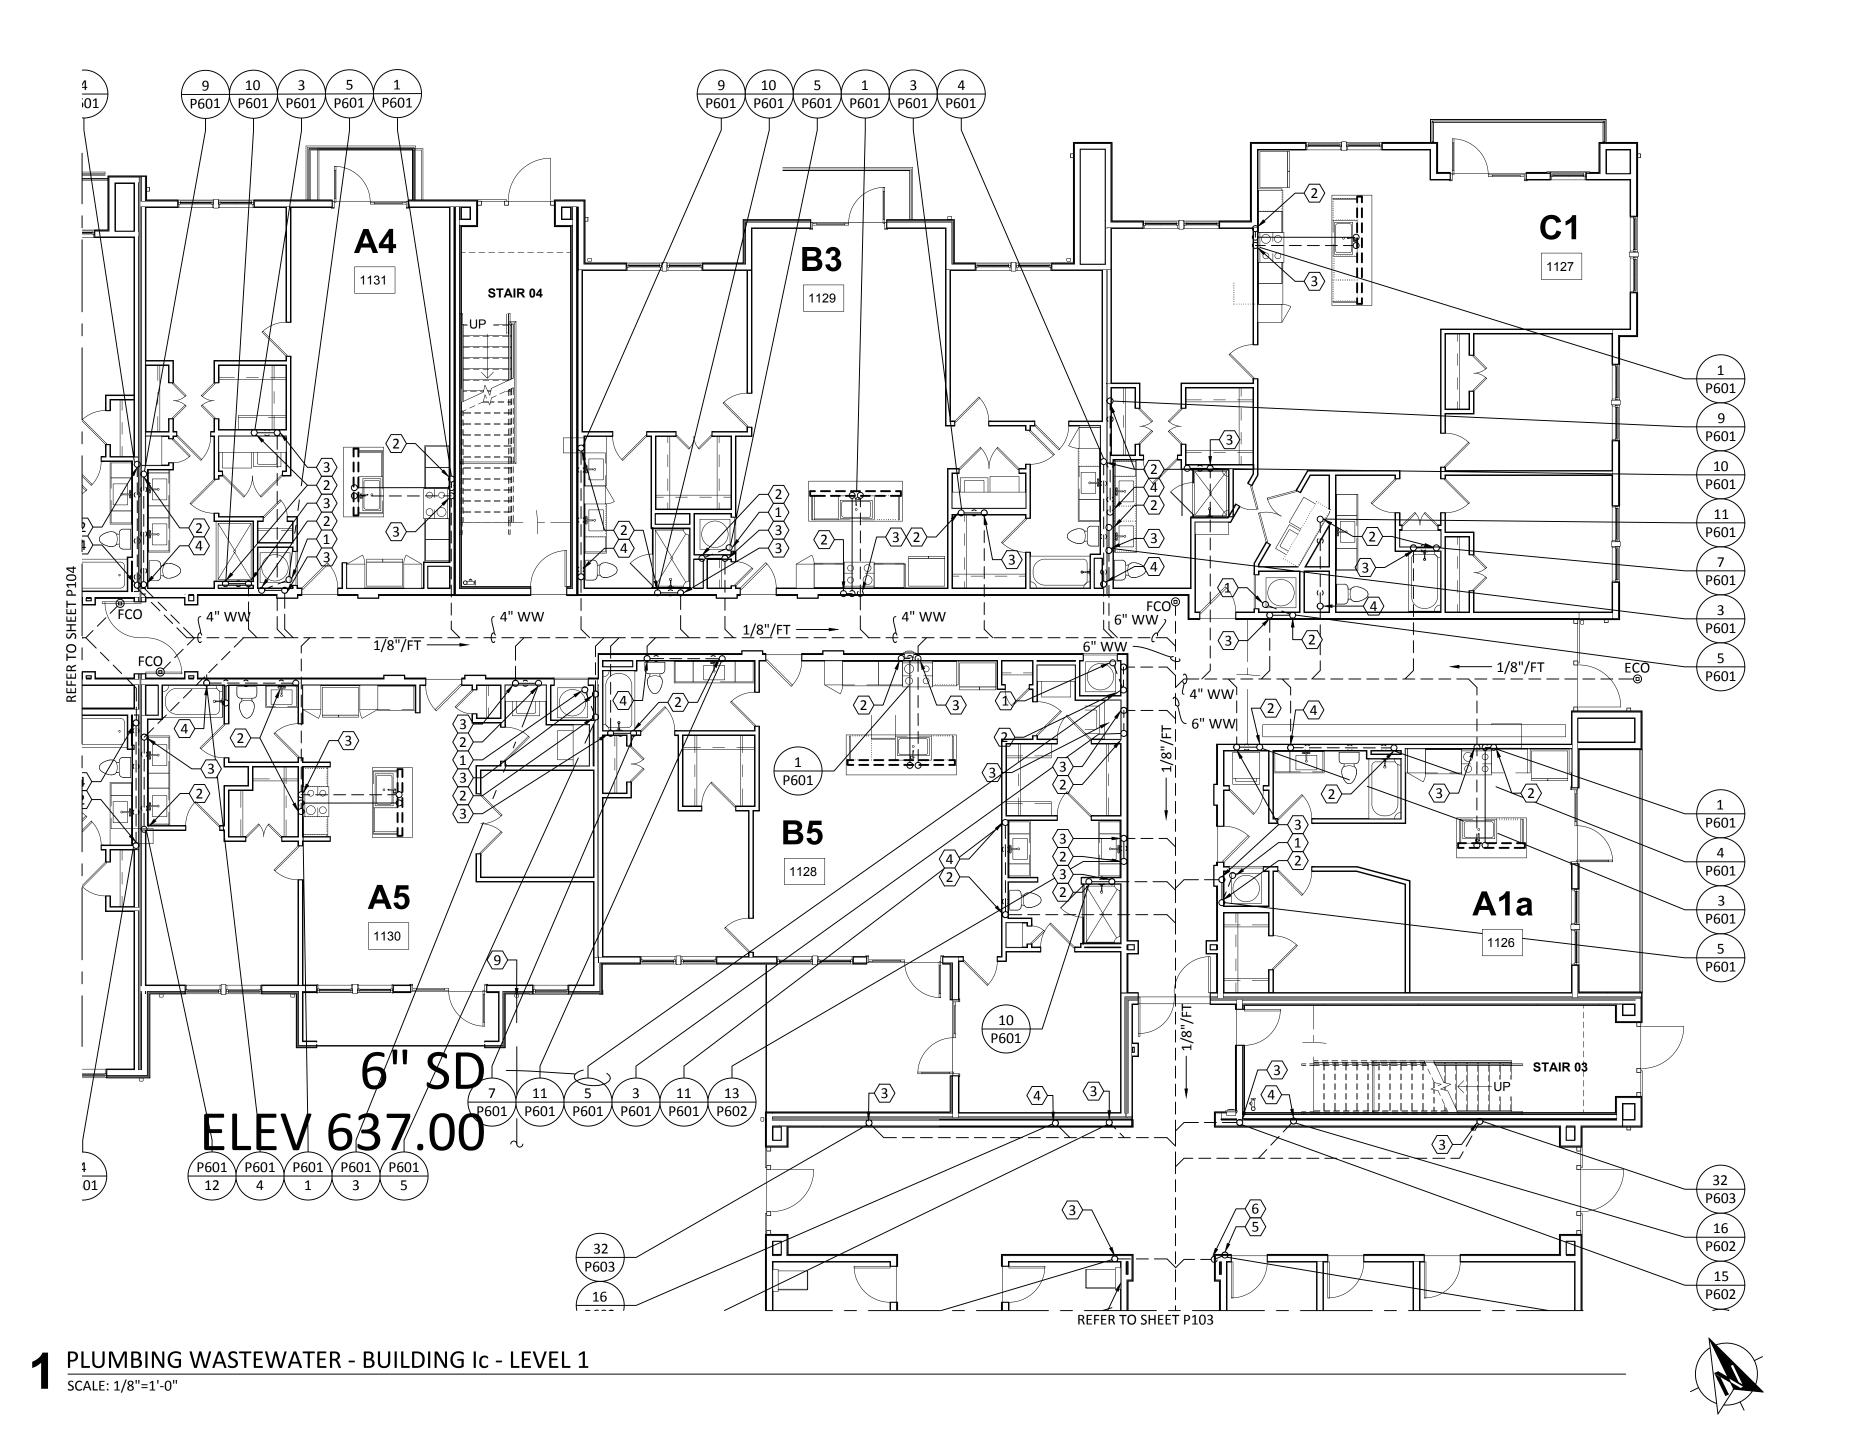
PLUMBING WASTEWATER BUILDING 1b LEVEL 1

Project Number 01/14/2018 TLR Drawn By Checked By EEC

ENCOTECH ENGINEERING CONSULTANTS TBPE Firm 8500 Bluffstone Cove, Suite B-103 1141 Austin, Texas 78759 512.338.1101 Project No.: 18054.MS.AUS



KEY PLAN



A. REFER TO SHEET POOD FOR ADDITIONAL INFORMATION.

PROVIDE TRAP PRIMER FOR ALL HUB DRAINS AND FLOOR DRAINS. EXTND 1/2" DOMESTIC WATER TO TRAP PRIMER.

KEYED NOTES:

- 2" HUB DRAIN "HB-1" LOCATED IN FRONT OF MECHANICAL CLOSET FOR ACCESSIBILITY.
- VENT TO FLOOR ABOVE. REFER TO WASTEWATER RISER DIAGRAMS FOR VENT PIPE SIZES.
- 3. 2" WASTEWATER FROM FLOOR ABOVE TO BELOW SLAB.
- 4. 4" WASTEWATER FROM FLOOR ABOVE TO BELOW SLAB.
- 5. 2" WASTEWATER FROM FLOOR ABOVE.
- 6. 2" WASTEWATER TO BELOW SLAB.
- 7. 4" WASTEWATER FROM FLOOR ABOVE.
- 8. 4" WASTEWATER TO BELOW SLAB.
- 9. CONNECT 6" DOWNSPOUT TO 6" STORM PIPE IN COURTYARD. ALL ELEVATIONS ARE 637.00 AT POINT OF CONNECTION.



Structural Engineer:

VIEWTECH INC. 4205 Beltway Dr. Addison, TX 75001 Victor Lisiak III 972.661.8187

MEP Engineer:

ENCOTECH 8500 Bluffstone Cove, Austin, TX. 78759 Tessa Roberts 512.338.1101

Civil Engineer:

MBC & Associates, Inc 1035 Central Pkwy N, San Antonio, TX 78732 David Allen

Landscape Architect:

210.545.1122

LEE & Associates, Inc. 9020 N Capital of Texas Hwy, Austin, TX. 78759 Amber Rothwell 512.345.8477

Interior Designer:

SJL Design Group 921 N. Riverfront Blvd. Suite 100, Dallas, TX 75207 Cassie Farley 214.443.9090

ISSUANCES		
01	SCHEMATIC DESIGN	09.10.18
02	DEVELOPMENT DESIGN	11.09.18
03	PERMIT SET	01.28.19

REVISIONS



a multifamily project for NRP Group

West Cevallos
San Antonio, Texas


PLUMBING WASTEWATER BUILDING 1c LEVEL 1

Project Number	18054
Date	01/14/2018
Drawn By	TLF
Checked By	EE

P103

TBPE Firm 1141 8500 Bluffstone Cove, Suite B-103 Austin, Texas 78759 512.338.1101 Project No.: 18054.MS.AUS

KEY PLAN

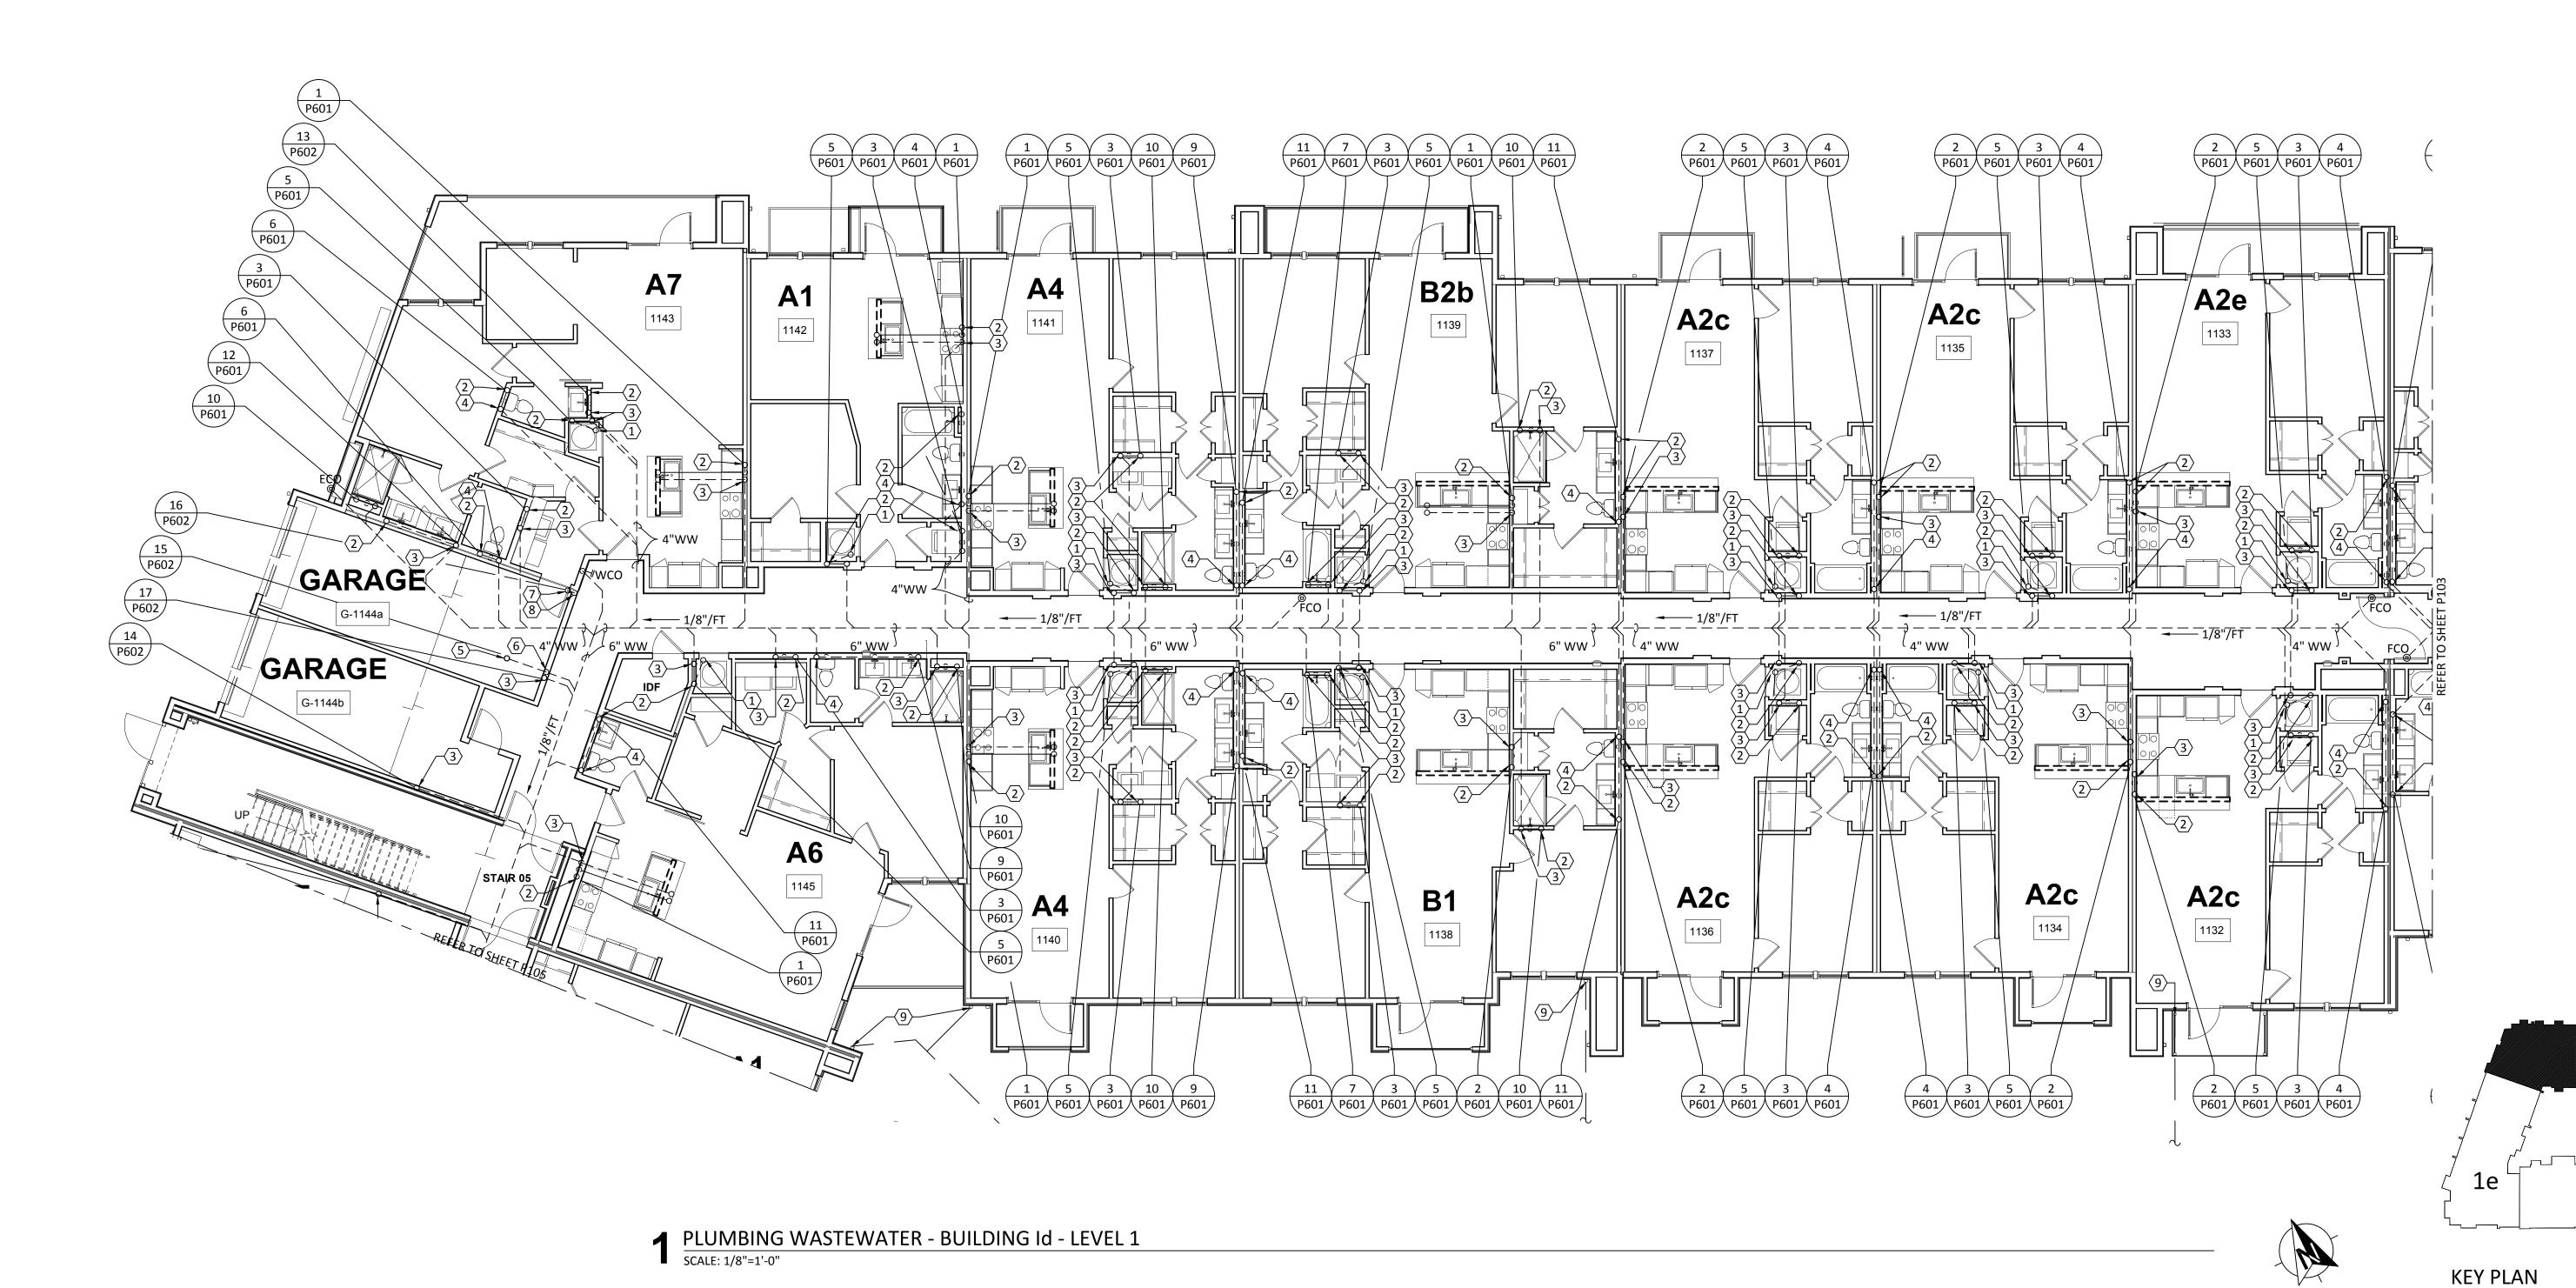

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KEY PLAN
N.T.S.

ENGINEERING CONSULTANTS

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ISSUANCES		
01	SCHEMATIC DESIGN	09.10.18
02	DEVELOPMENT DESIGN	11.09.18
03	PERMIT SET	01.28.19
REVISIONS	•	




a multifamily project for NRP Group

West Cevallos San Antonio, Texas

PLUMBING WASTEWATER BUILDING 1d LEVEL 1

Project Number	18054
Date	01/14/2018
Drawn By	TLR
Checked By	EEC

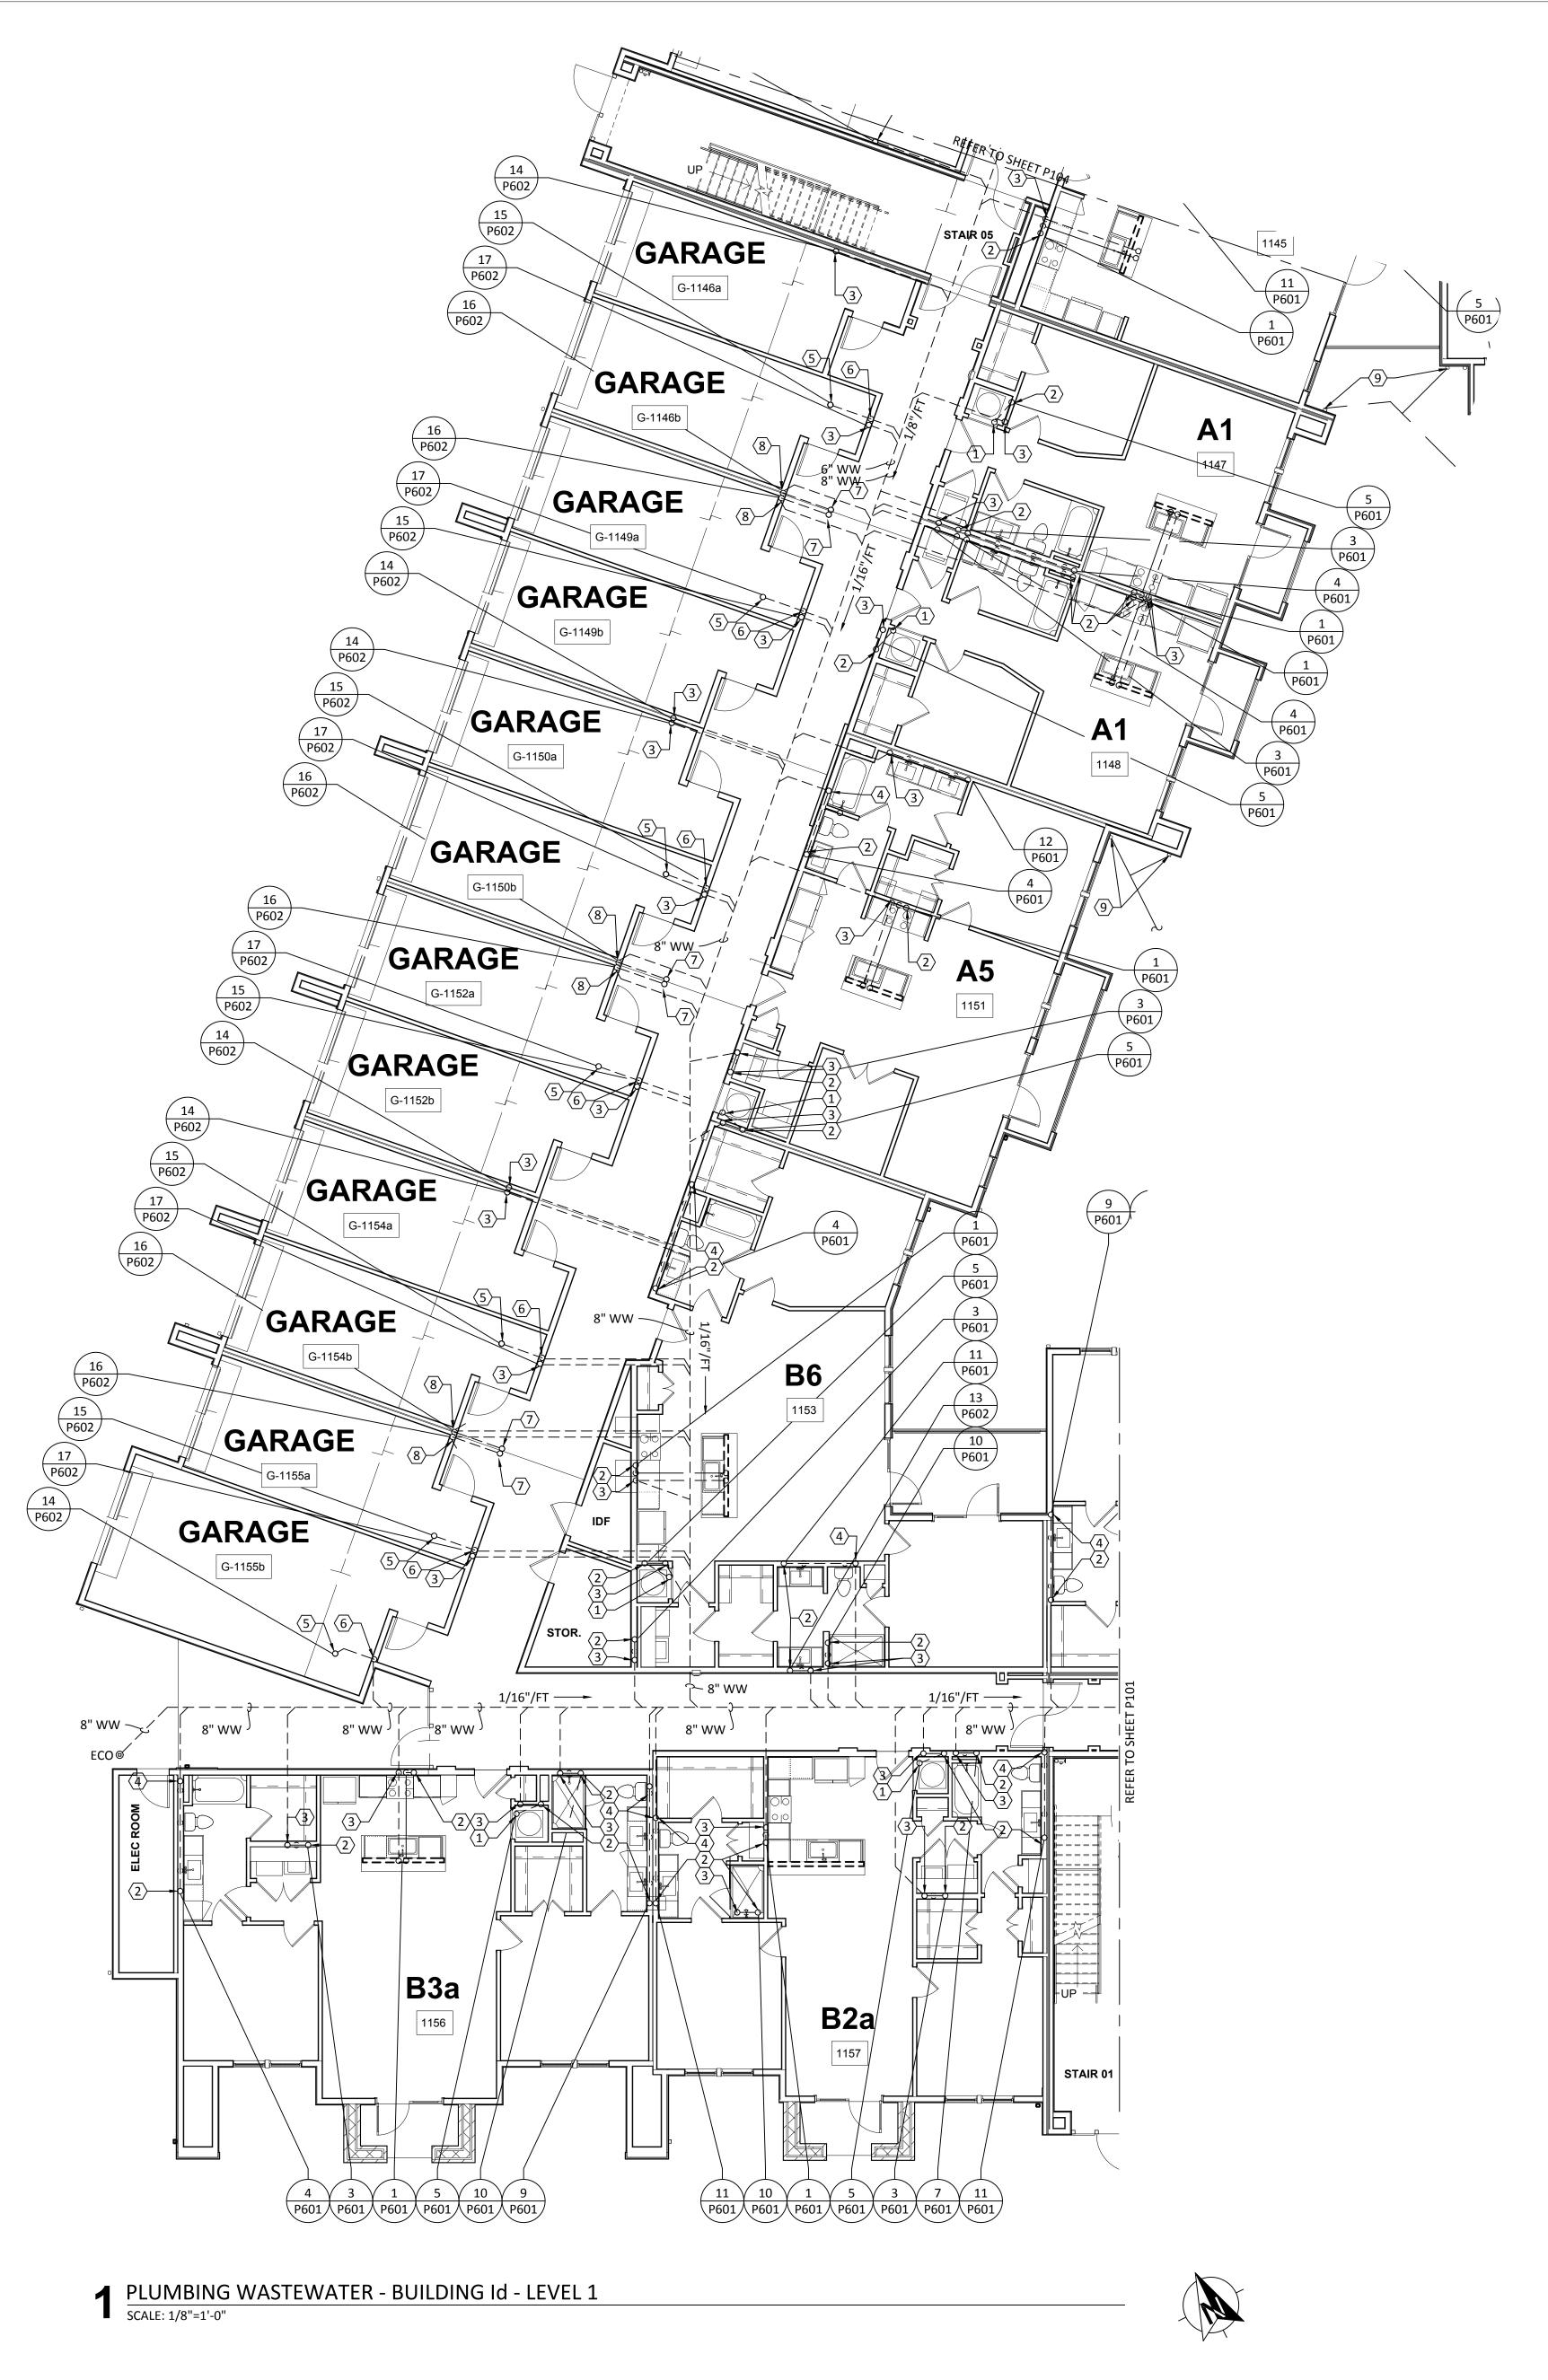

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MEP Engineer:

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ISSUANCES		
01	SCHEMATIC DESIGN	09.10.18
02	DEVELOPMENT DESIGN	11.09.18
03	PERMIT SET	01.28.19

REVISIONS



a multifamily project for NRP Group

West Cevallos
San Antonio, Texas

PLUMBING WASTEWATER BUILDING 1e LEVEL 1

Project Number	18054
Date	01/14/2018
Drawn By	TLR
Checked By	EEC

P105

TBPE Firm 1141 8500 Bluffstone Cove, Suite B-103 Austin, Texas 78759 | 512.338.1101 Project No.: 18054.MS.AUS

KEY PLAN
N.T.S.

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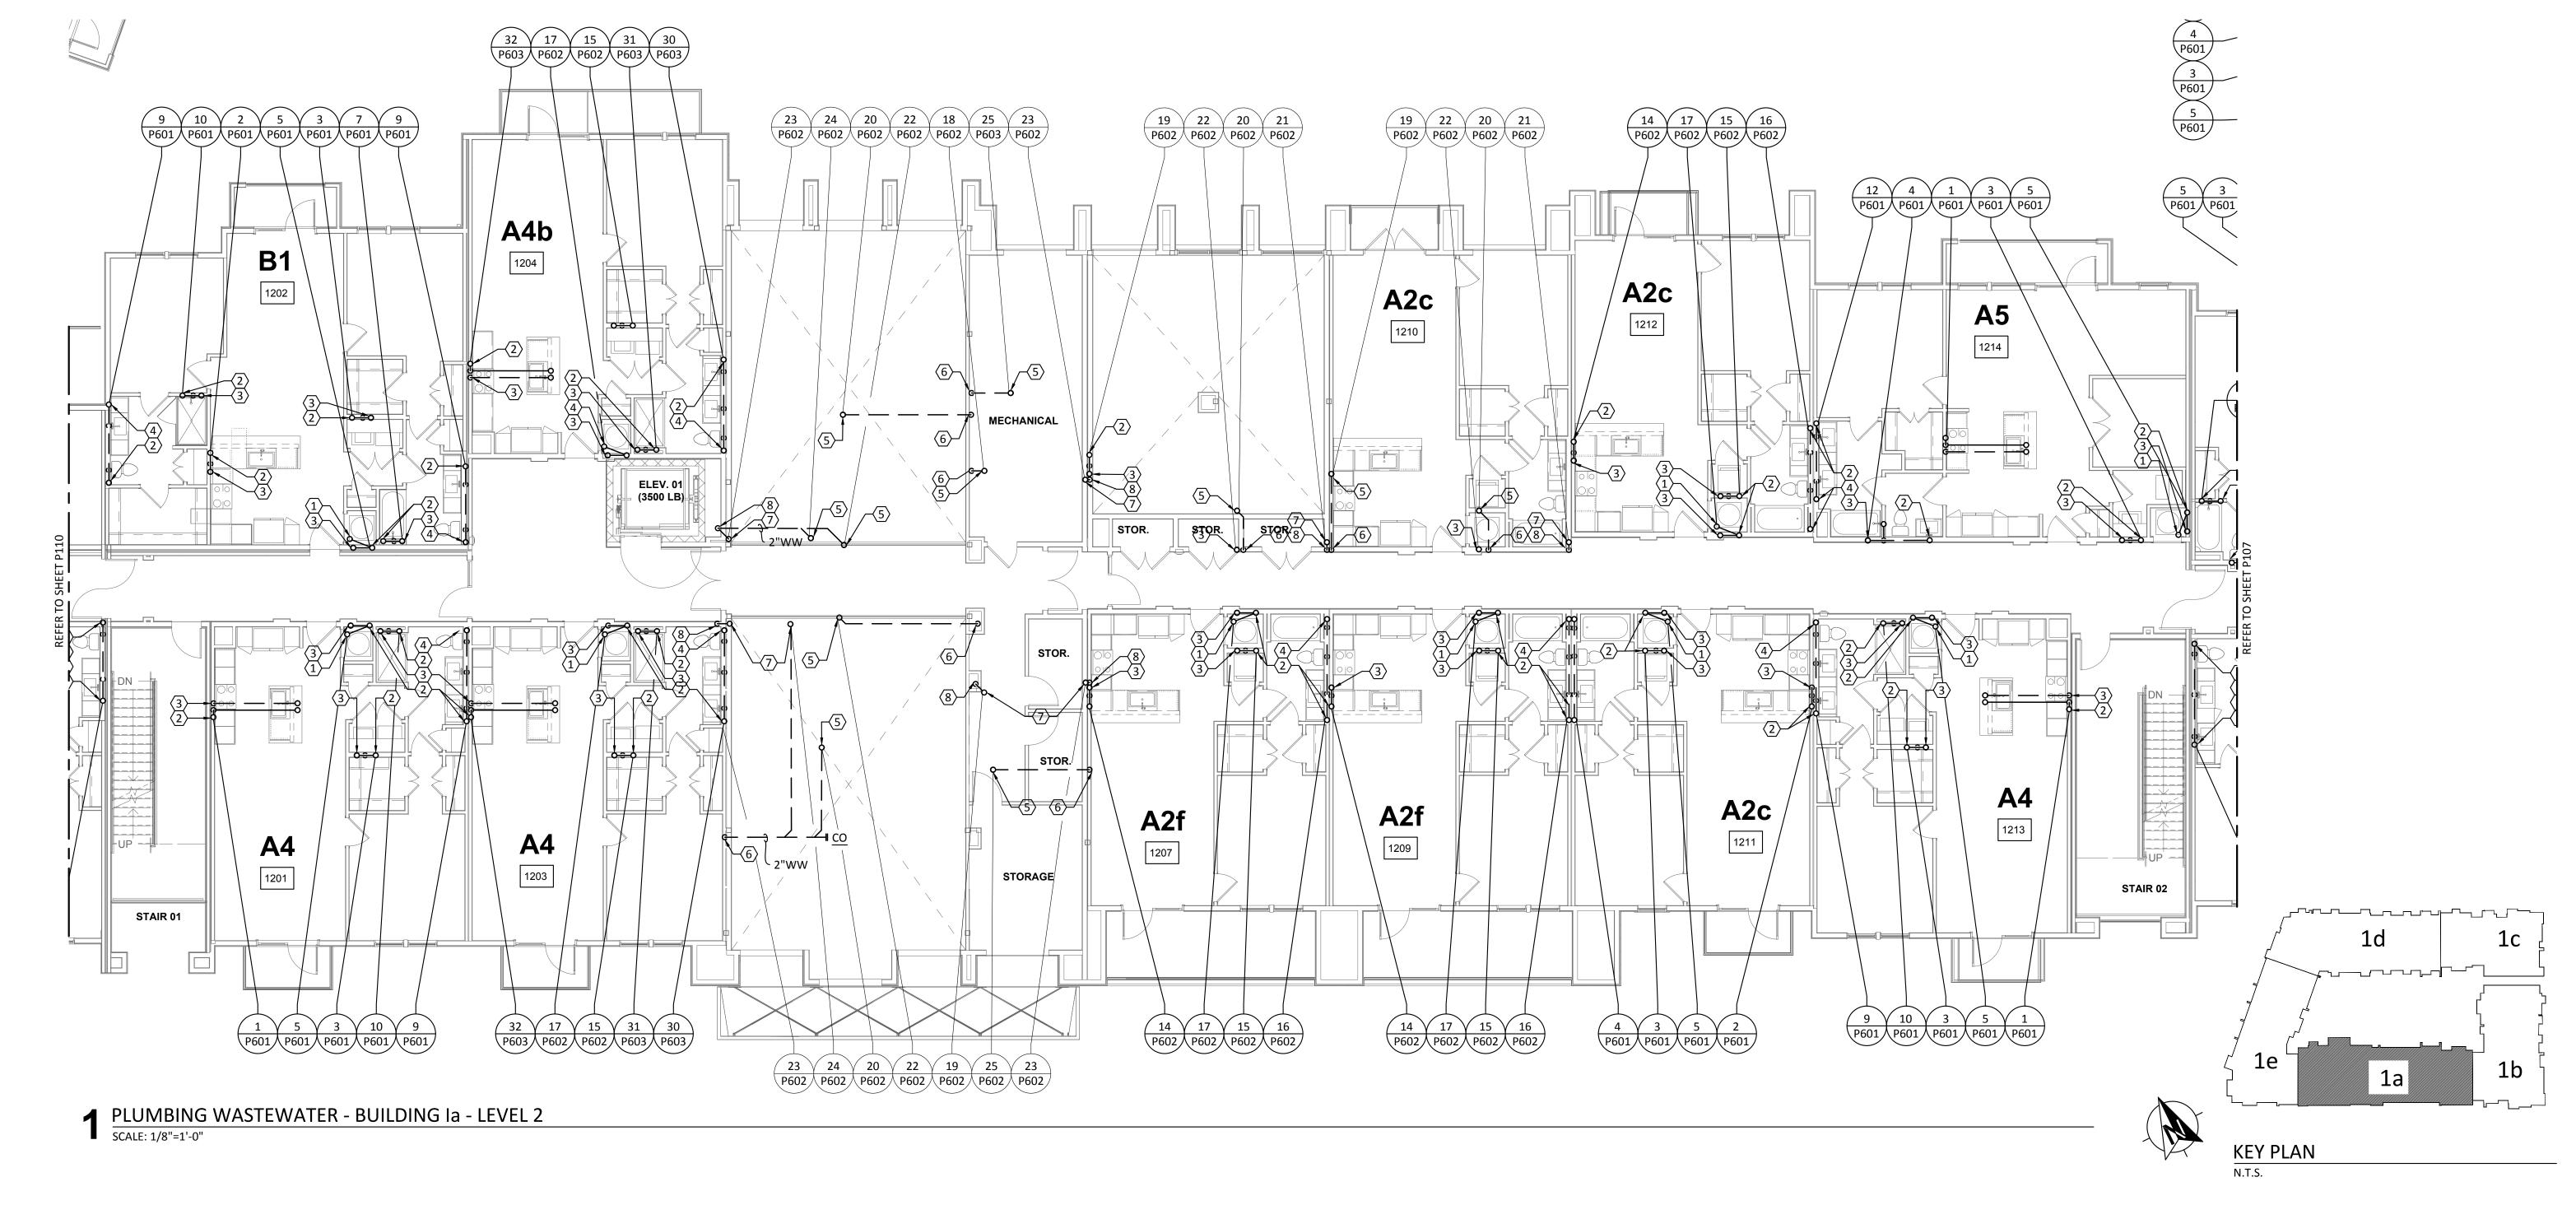
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MEP Engineer:

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Landscape Architect:


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Interior Designer:

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ISSUANCES 01 SCHEMATIC DESIGN 09.10.18 02 DEVELOPMENT DESIGN 11.09.18 03 PERMIT SET 01.28.19

REVISION




a multifamily project for NRP Group

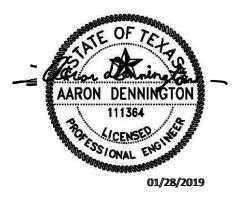West Cevallos
San Antonio, Texas

PLUMBING WASTEWATER BUILDING 1a LEVEL 2

Project Number	18054
Date	01/14/2018
Drawn By	TLR
Checked By	EEC

P106

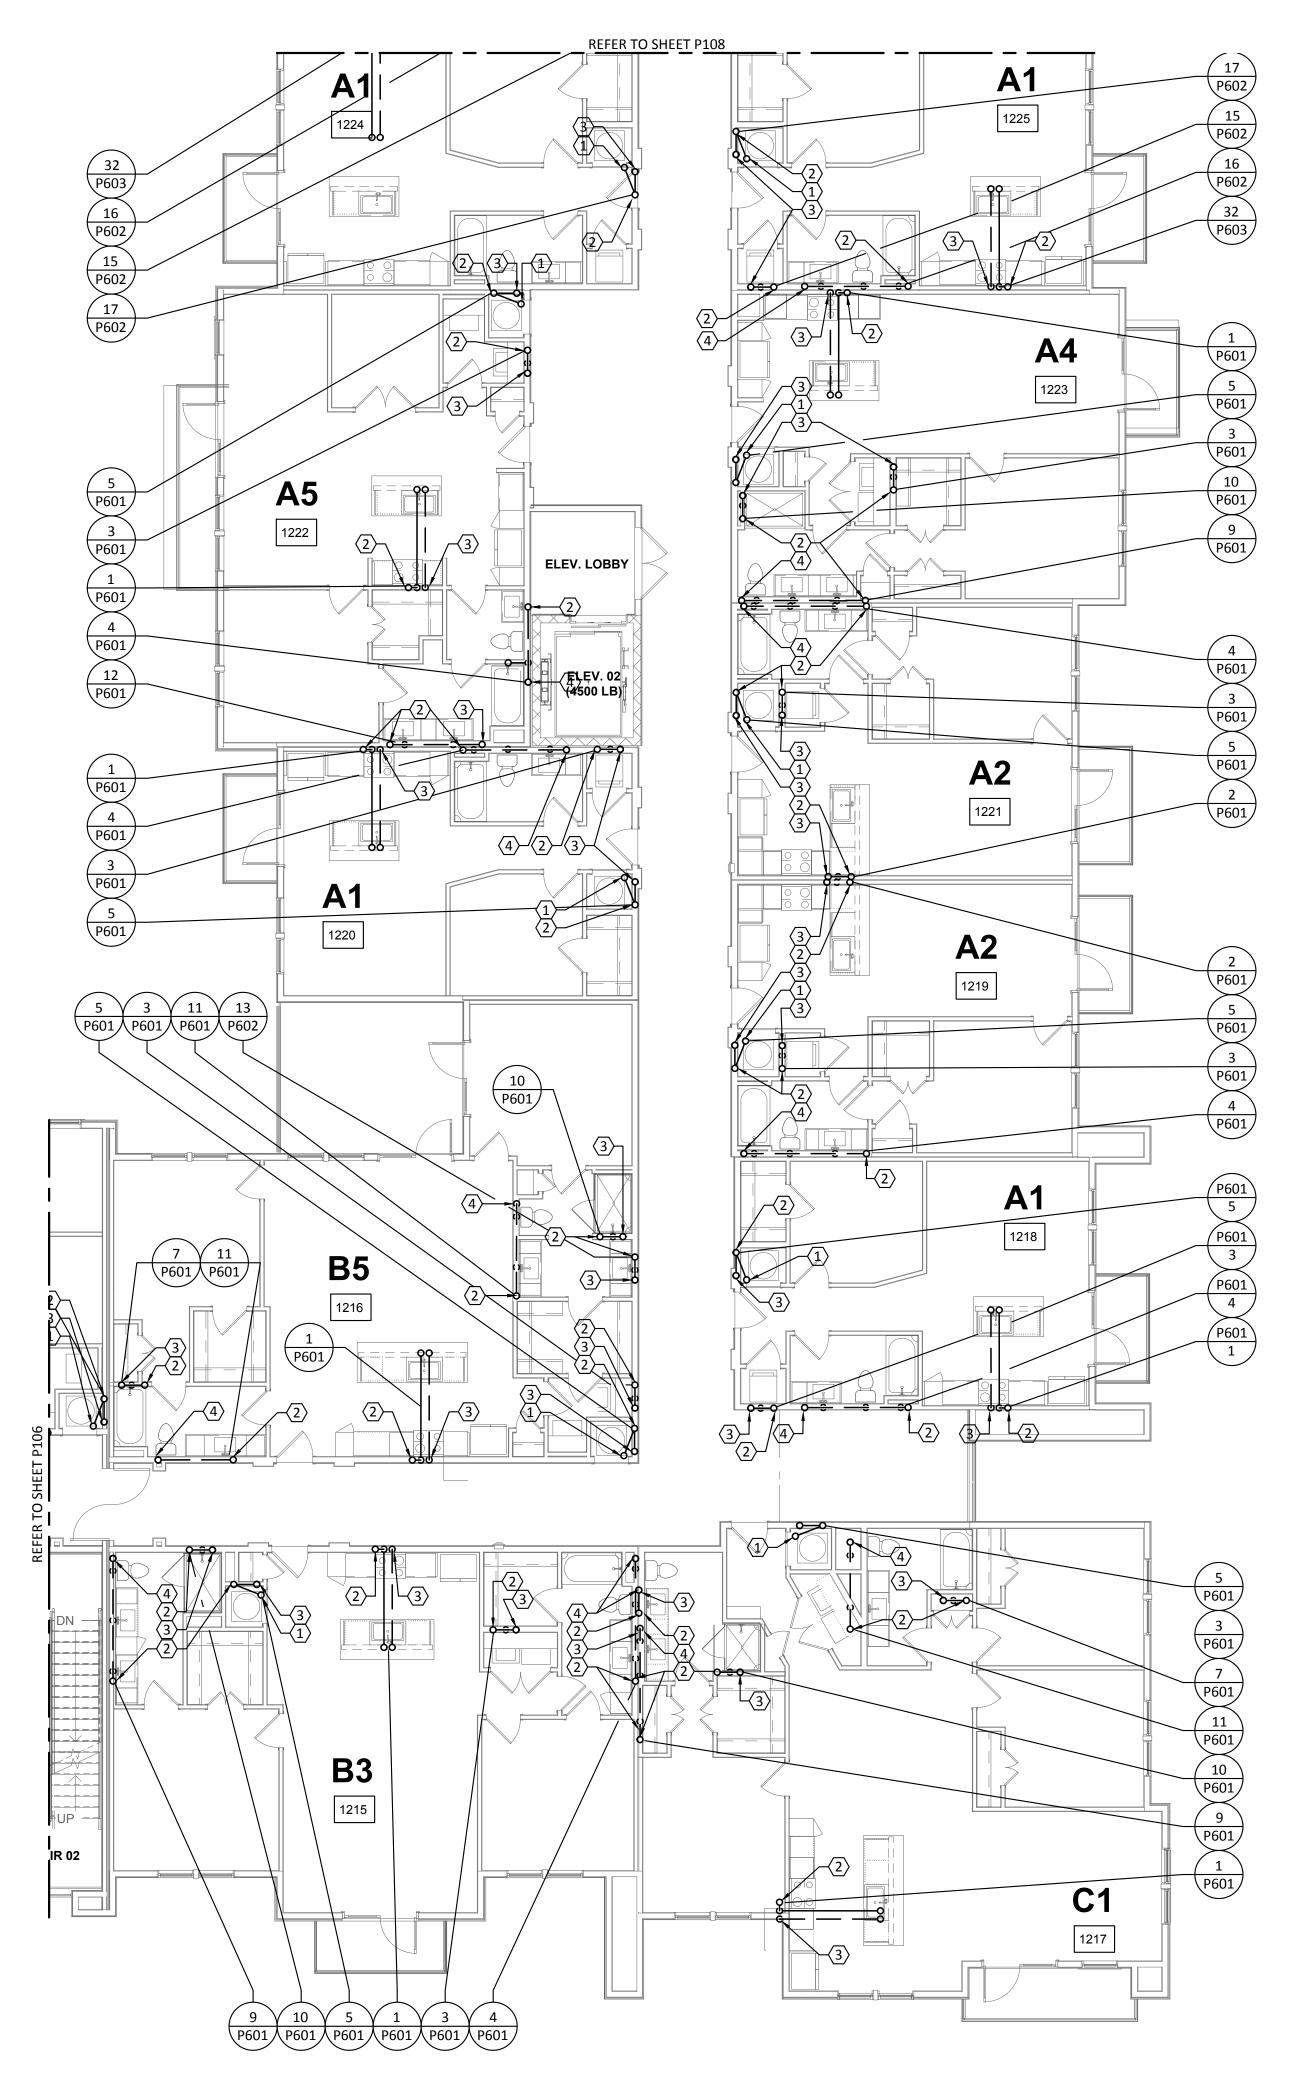

PLUMBING WASTEWATER - BUILDING Ib - LEVEL 2

SCALE: 1/8"=1'-0"



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PROVIDE TRAP PRIMER FOR ALL HUB DRAINS AND FLOOR DRAINS. EXTND 1/2" DOMESTIC WATER TO TRAP PRIMER.

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COLLABORATIVE 2007 O Lang Red Octo 400

Structural Engineer:

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MEP Engineer:

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8500 Bluffstone Cove, Austin, TX. 78759 Tessa Roberts 512.338.1101

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	ISSUANCES		
	01	SCHEMATIC DESIGN	09.10.18
	02	DEVELOPMENT DESIGN	11.09.18
	03	PERMIT SET	01.28.19
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a multifamily project for NRP Group

West Cevallos San Antonio, Texas

PLUMBING WASTEWATER BUILDING 1b LEVEL 2

18054
01/14/2018
TLR
EEC

P107




KEY PLAN
N.T.S.



- A. REFER TO SHEET P000 FOR ADDITIONAL INFORMATION.
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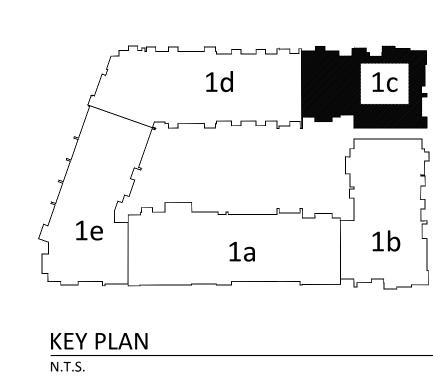
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PLUMBING WASTEWATER BUILDING Ic - LEVEL 2

SCALE: 1/8"=1'-0"



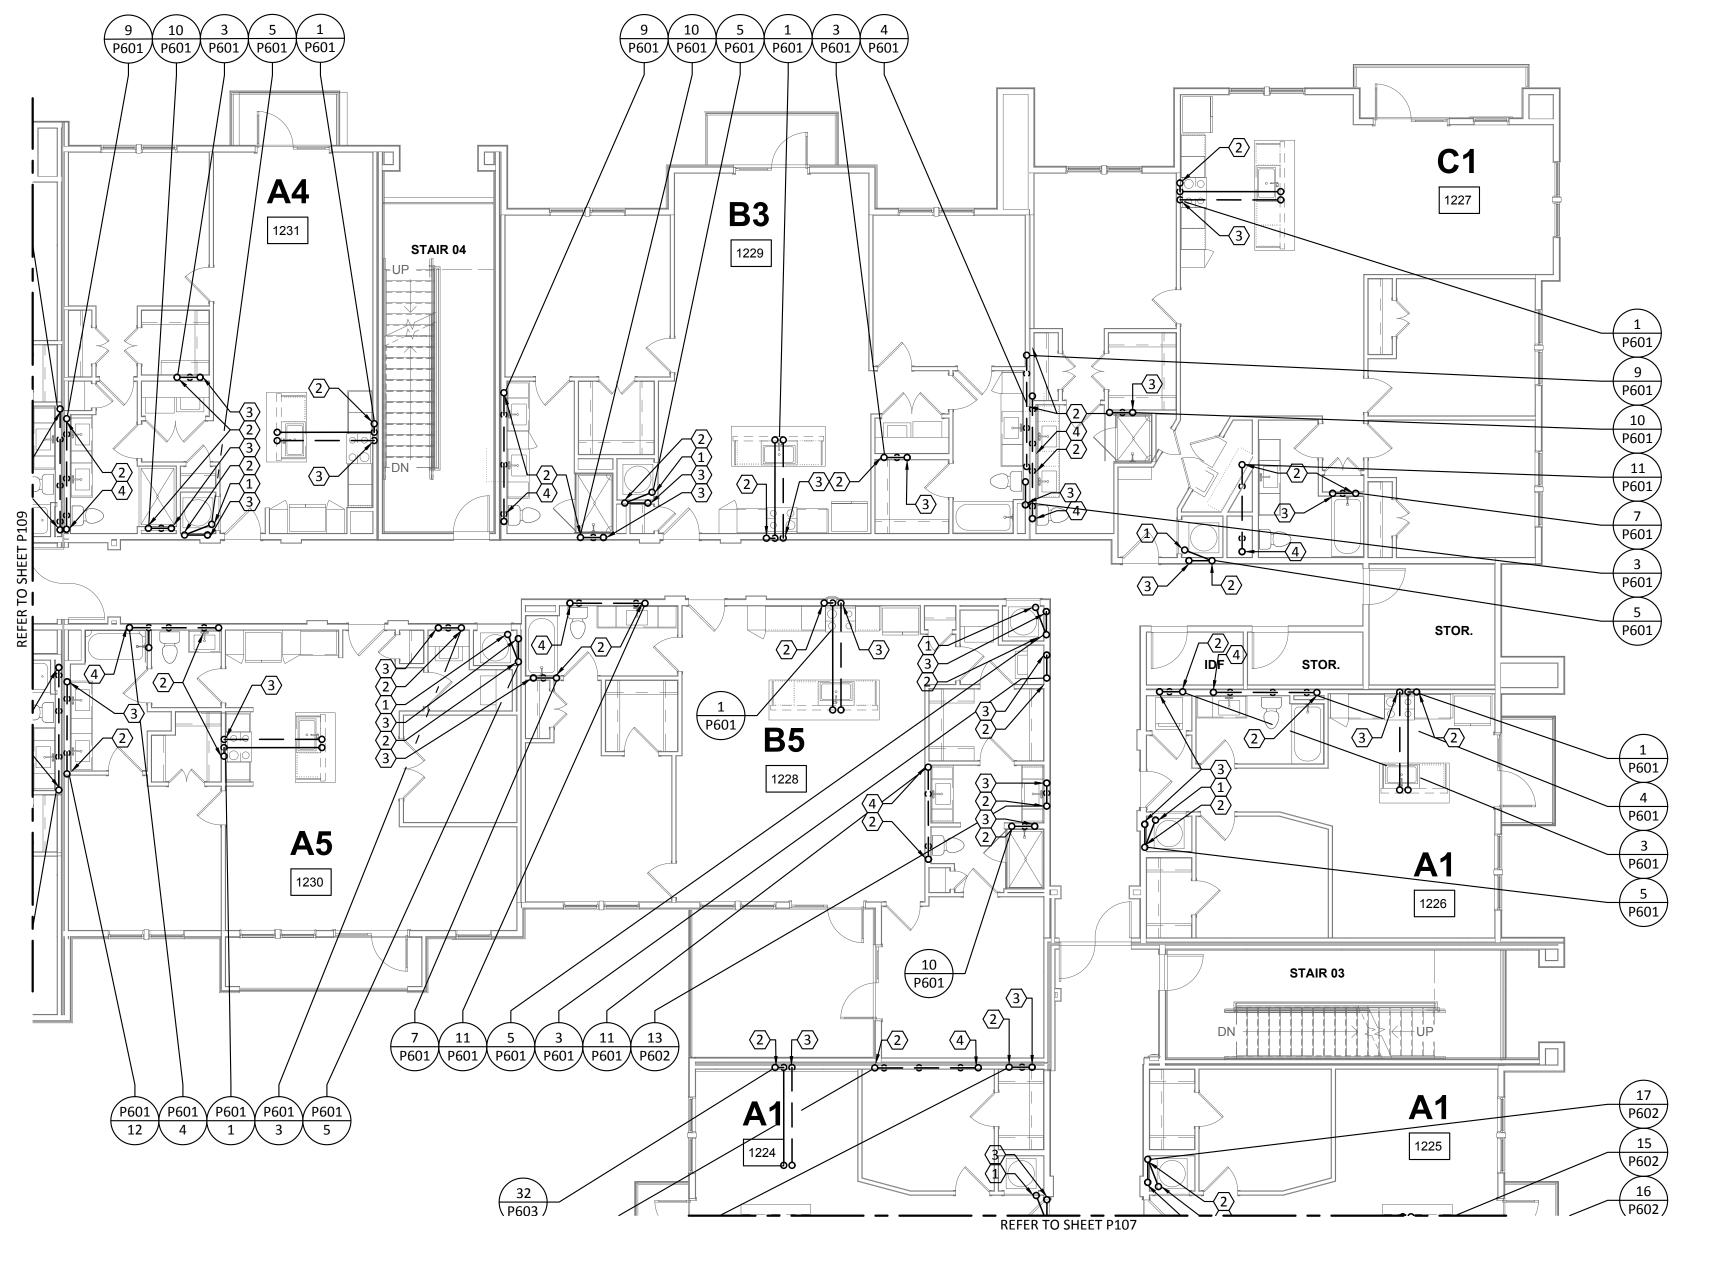





Structural Engineer:

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MEP Engineer:

ENCOTECH 8500 Bluffstone Cove, Austin, TX. 78759 Tessa Roberts

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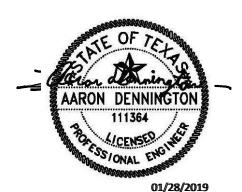
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	03	PERMIT SET	01.28.19
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a multifamily project for NRP Group

West Cevallos
San Antonio, Texas

PLUMBING WASTEWATER BUILDING 1c LEVEL 2

Project Number 18054

Date 01/14/2018

Drawn By TLR

Checked By EEC

P108




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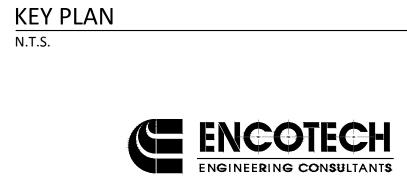
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PLUMBING WASTEWATER - BUILDING Id - LEVEL 2

SCALE: 1/8"=1'-0"



TBPE Firm | 8500 Bluffstone Cove, Suite B-103 1141 | Austin, Texas 78759 | 512.338.1101 Project No.: 18054.MS.AUS

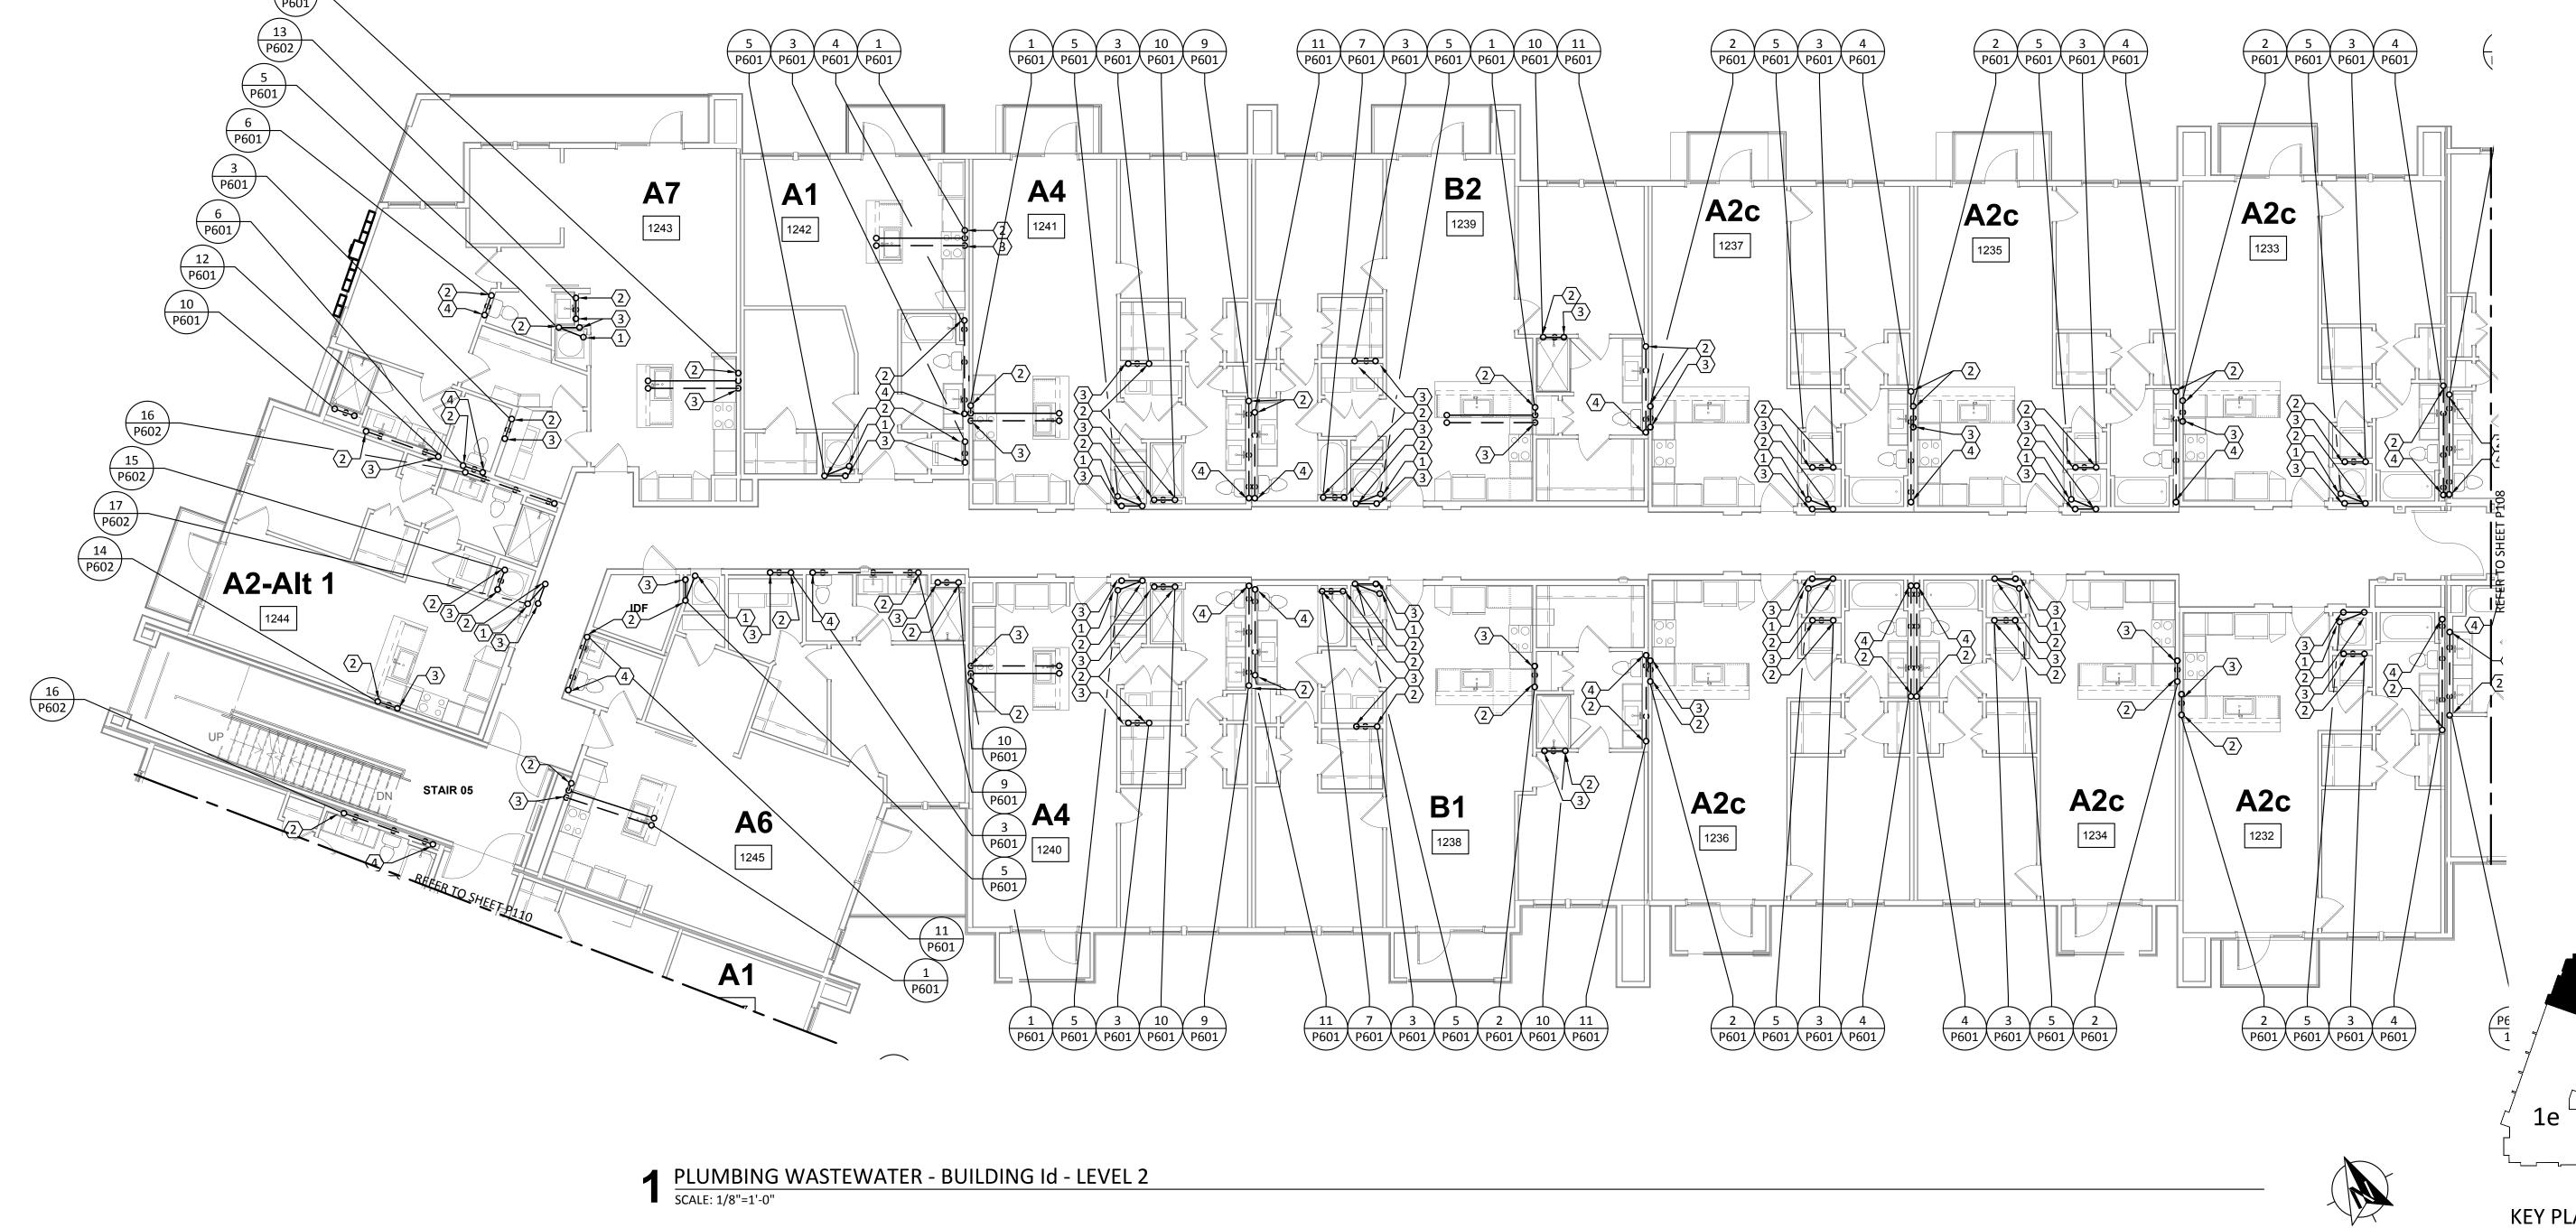1b

COLLABORATIVE 3607 S Lamar Blvd, Suite 103 Austin, Texas 78704 512.852.4310

Structural Engineer:

VIEWTECH INC. 4205 Beltway Dr. Addison, TX 75001 Victor Lisiak III 972.661.8187

MEP Engineer:

512.338.1101

ENCOTECH 8500 Bluffstone Cove, Austin, TX. 78759 Tessa Roberts

Civil Engineer:

MBC & Associates, Inc 1035 Central Pkwy N, San Antonio, TX 78732 David Allen 210.545.1122

Landscape Architect:

LEE & Associates, Inc. 9020 N Capital of Texas Hwy, Austin, TX. 78759 Amber Rothwell

Interior Designer:

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SJL Design Group 921 N. Riverfront Blvd. Suite 100, Dallas, TX 75207 Cassie Farley 214.443.9090

ISSUANCES

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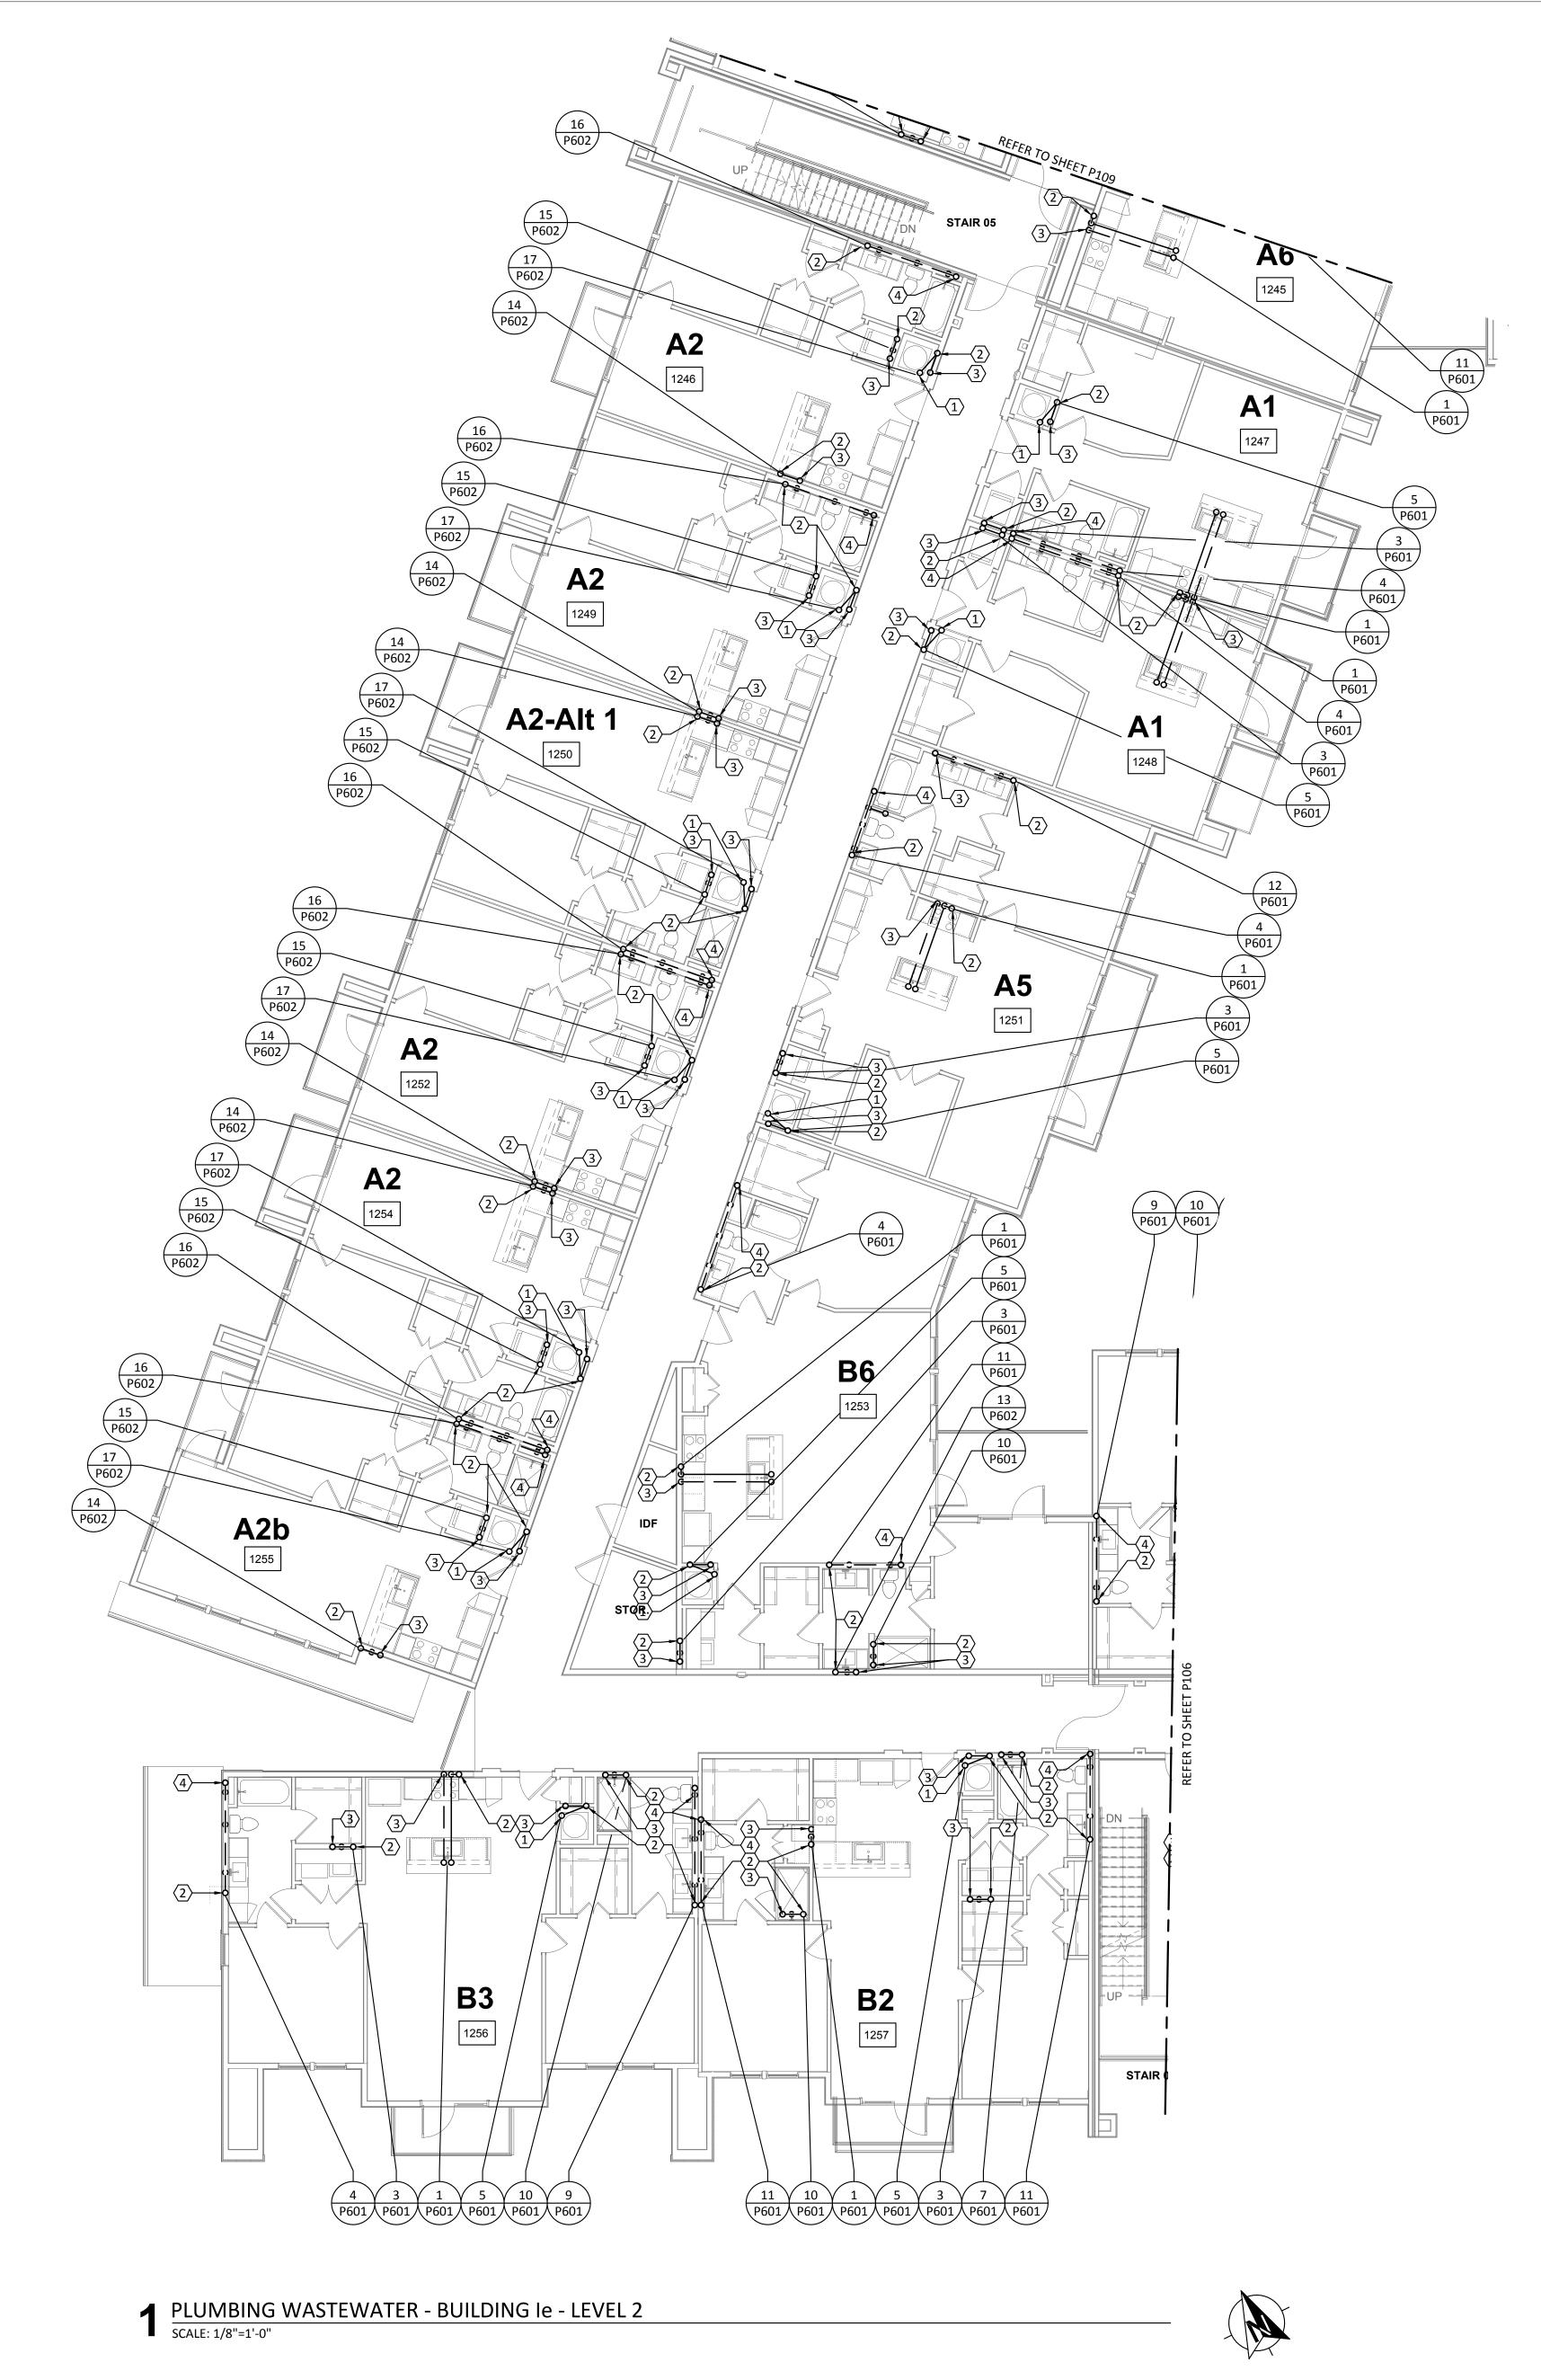


a multifamily project for NRP Group

West Cevallos San Antonio, Texas

PLUMBING WASTEWATER BUILDING Id LEVEL 2

Project Number 01/14/2018 Drawn By TLR Checked By EEC



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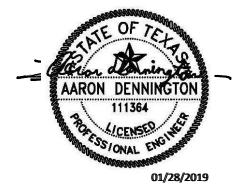
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ISSUANCES		
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03	PERMIT SET	01.28.19



a multifamily project for NRP Group

West Cevallos San Antonio, Texas

PLUMBING WASTEWATER BUILDING 1e LEVEL 2

Project Number 01/14/2018 Drawn By TLR Checked By EEC

P110

ENCOTECH ENGINEERING CONSULTANTS

KEY PLAN




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PLUMBING WASTEWATER - BUILDING Ia - LEVEL 3

SCALE: 1/8"=1'-0"



Project No.: 18054.MS.AUS

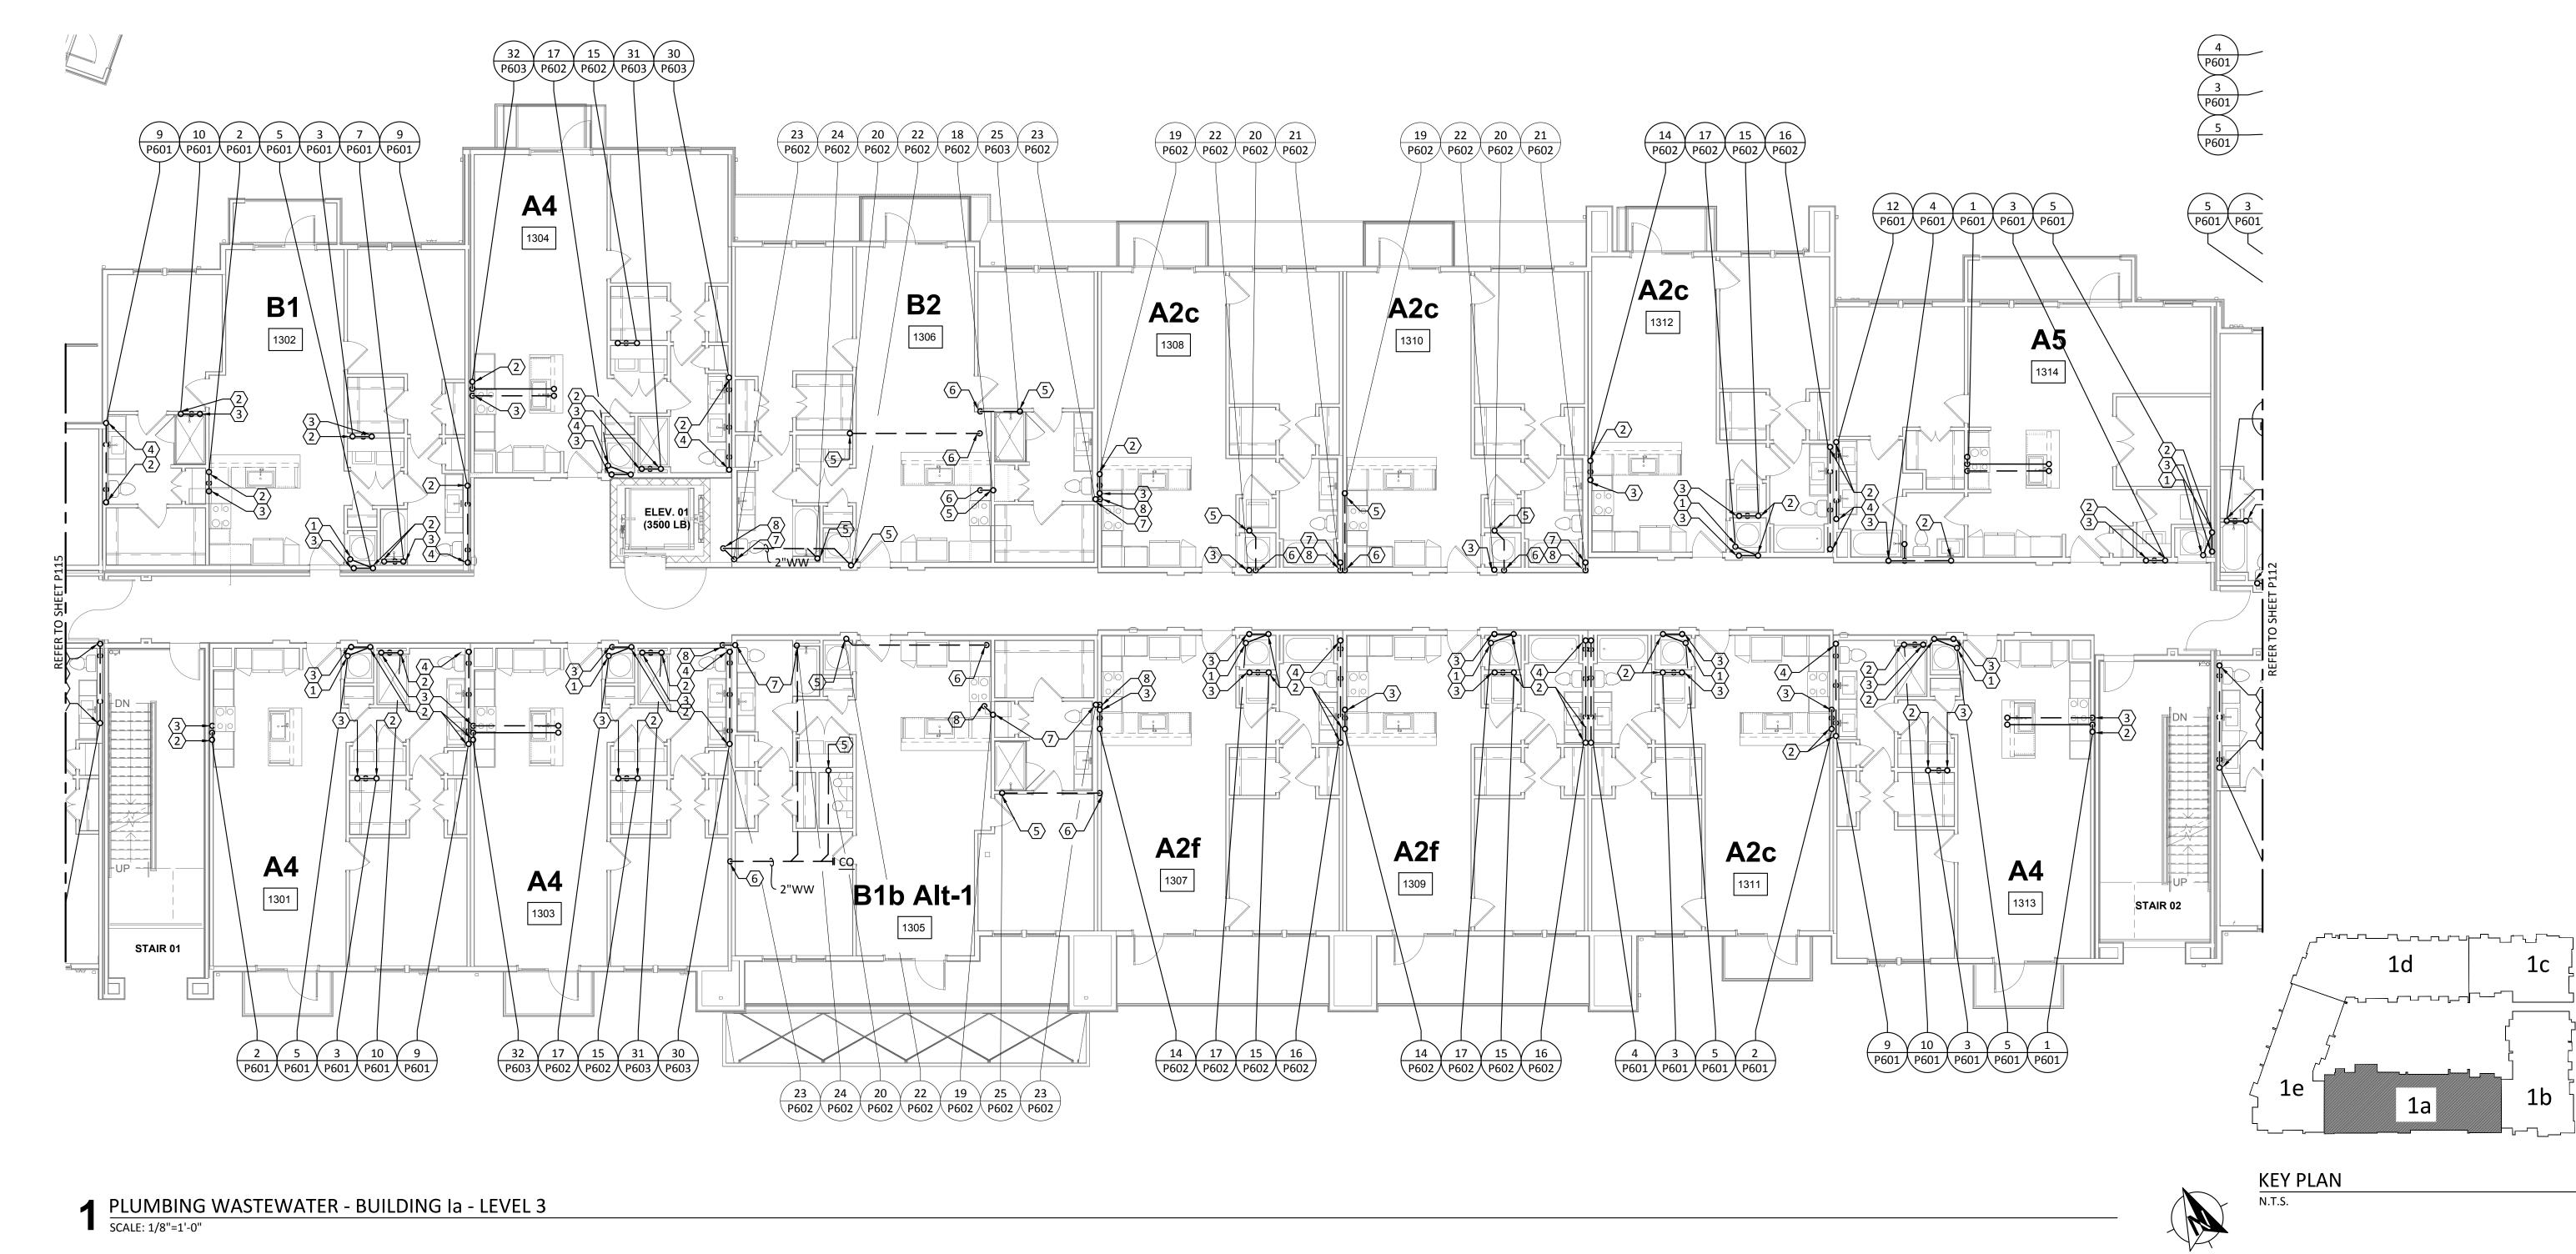

Structural Engineer:

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MEP Engineer:

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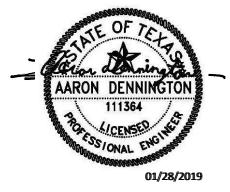
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ISSUANCES SCHEMATIC DESIGN 09.10.18 DEVELOPMENT DESIGN 11.09.18 PERMIT SET 01.28.19




a multifamily project for NRP Group

West Cevallos San Antonio, Texas

PLUMBING WASTEWATER BUILDING 1a LEVEL 3

Project Number 01/14/2018 TLR Drawn By Checked By EEC

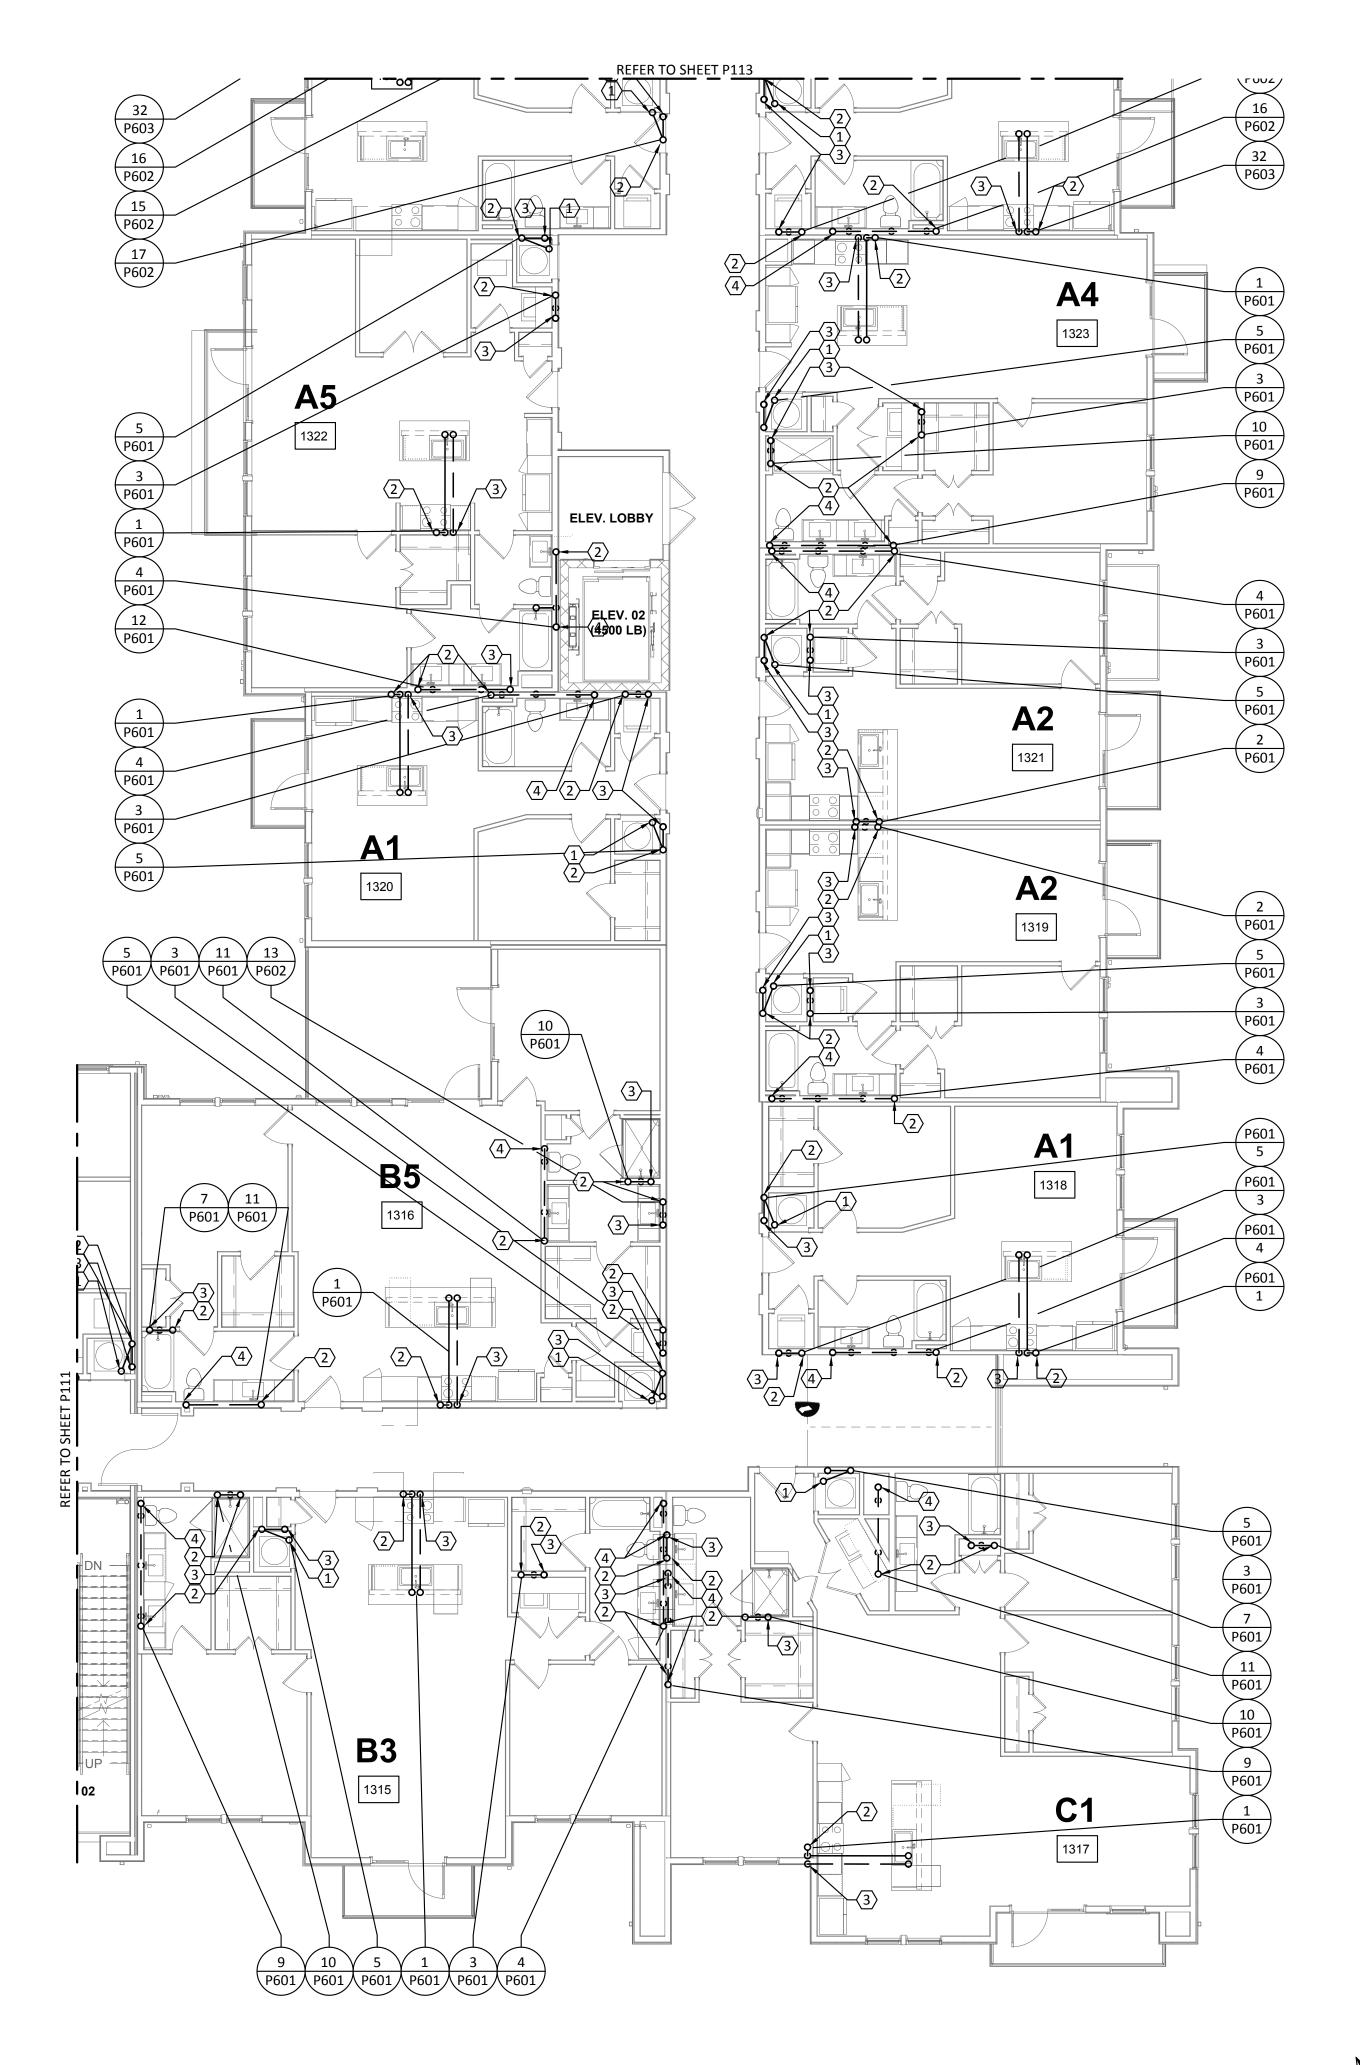

PLUMBING WASTEWATER - BUILDING Ib - LEVEL 3

SCALE: 1/8"=1'-0"



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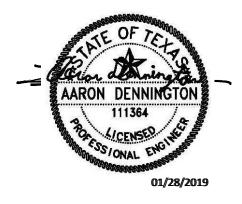
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REVISIONS



a multifamily project for NRP Group

West Cevallos San Antonio, Texas

PLUMBING WASTEWATER BUILDING 1b LEVEL 3

Project Number	18054
Date	01/14/2018
Drawn By	TLR
Checked By	EEC

P112




KEY PLAN
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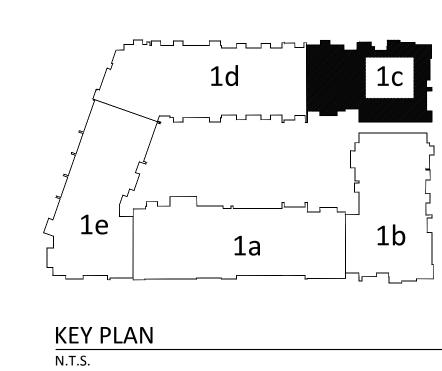
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PLUMBING WASTEWATER - BUILDING Ic - LEVEL 3

SCALE: 1/8"=1'-0"







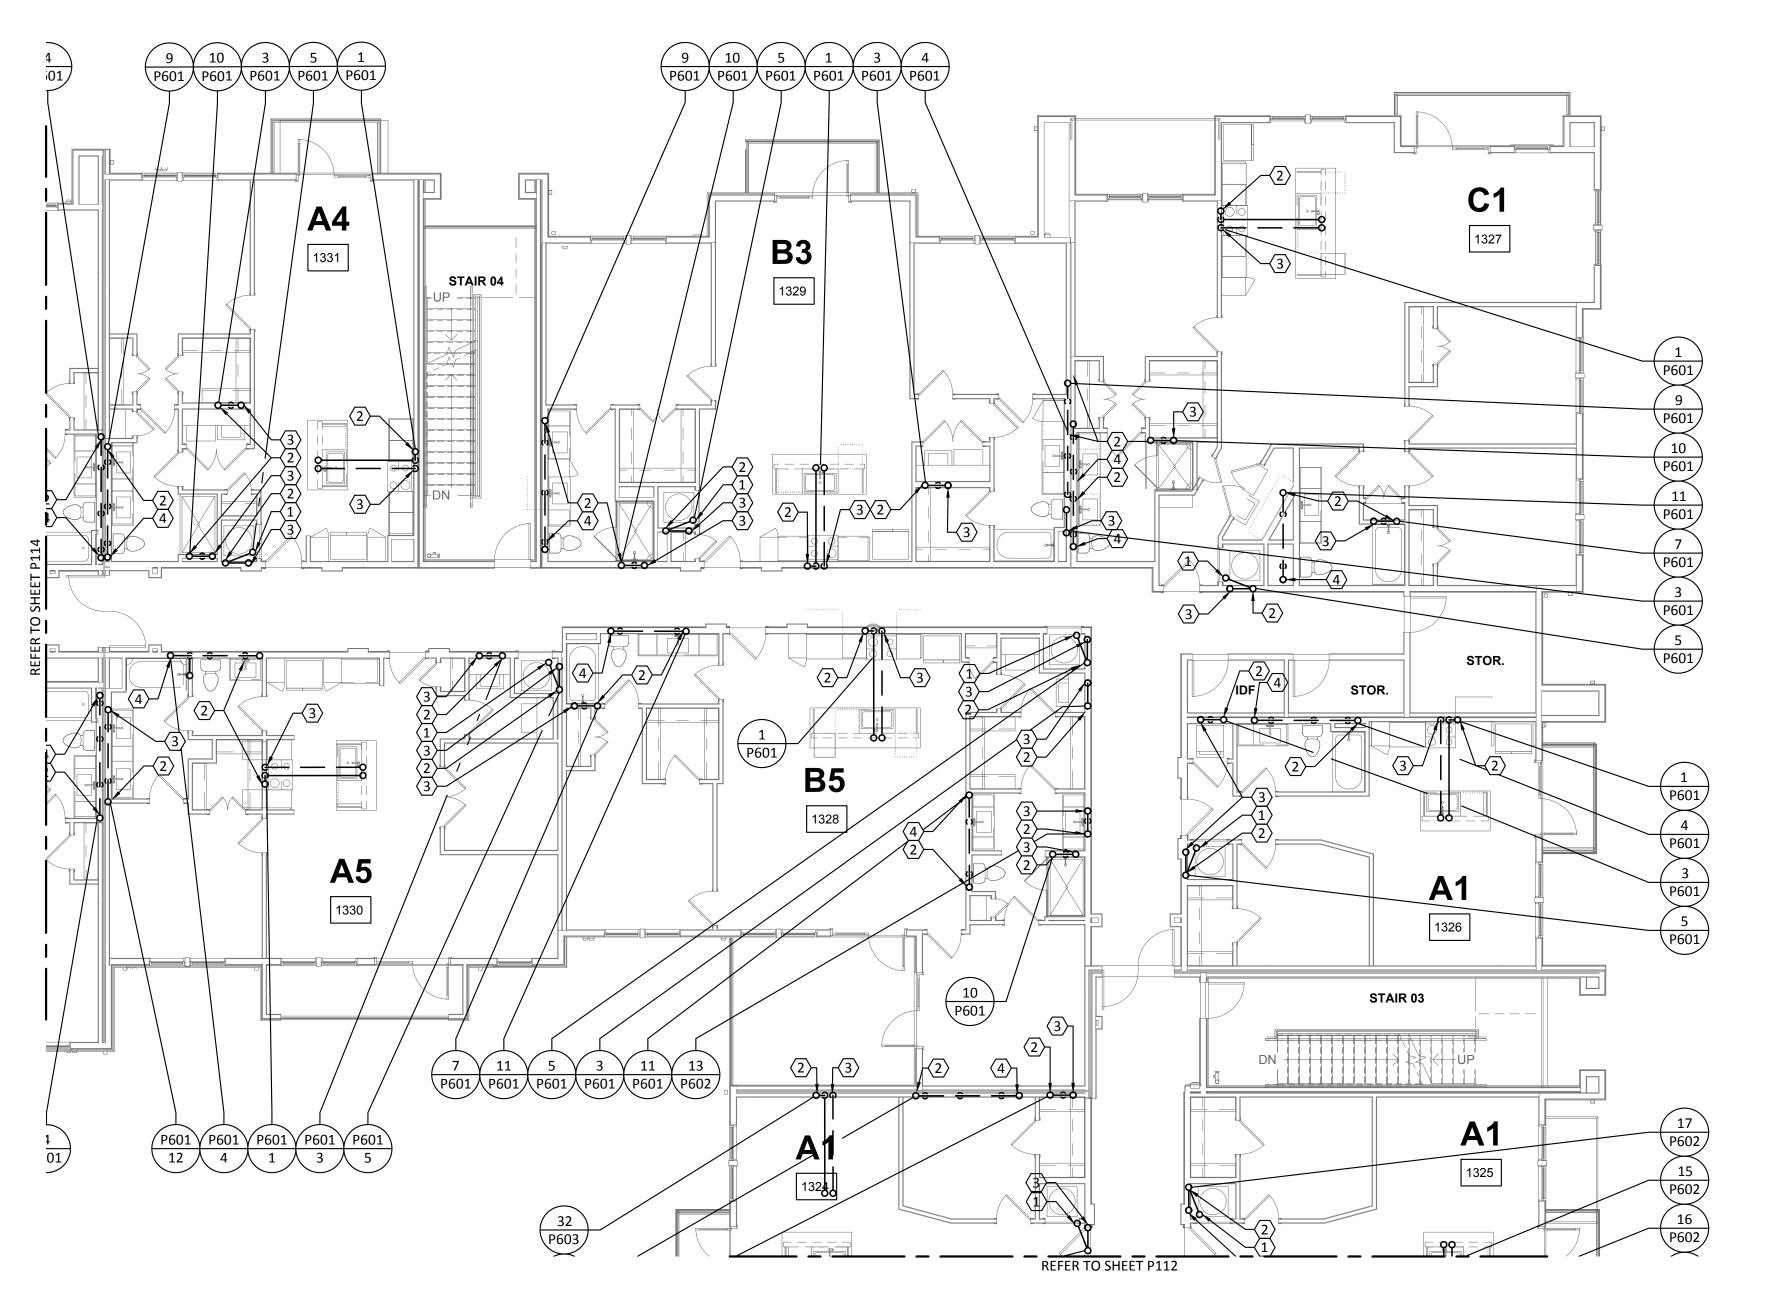

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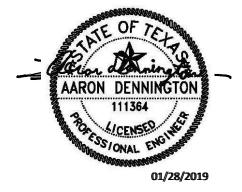
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West Cevallos
San Antonio, Texas

PLUMBING WASTEWATER BUILDING 1c LEVEL 3

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Drawn By TLR

Checked By EEC


P113

REFER TO SHEET P000 FOR ADDITIONAL INFORMATION.

PROVIDE TRAP PRIMER FOR ALL HUB DRAINS AND FLOOR DRAINS. EXTND 1/2" DOMESTIC WATER TO TRAP PRIMER.

KEYED NOTES:


- 2" HUB DRAIN "HB-1" LOCATED IN FRONT OF MECHANICAL CLOSET FOR ACCESSIBILITY.
- VENT TO FLOOR ABOVE. REFER TO WASTEWATER RISER DIAGRAMS FOR VENT PIPE SIZES.
- 2" WASTEWATER FROM FLOOR ABOVE TO FLOOR BELOW.
- 4" WASTEWATER FROM FLOOR ABOVE TO FLOOR BELOW.

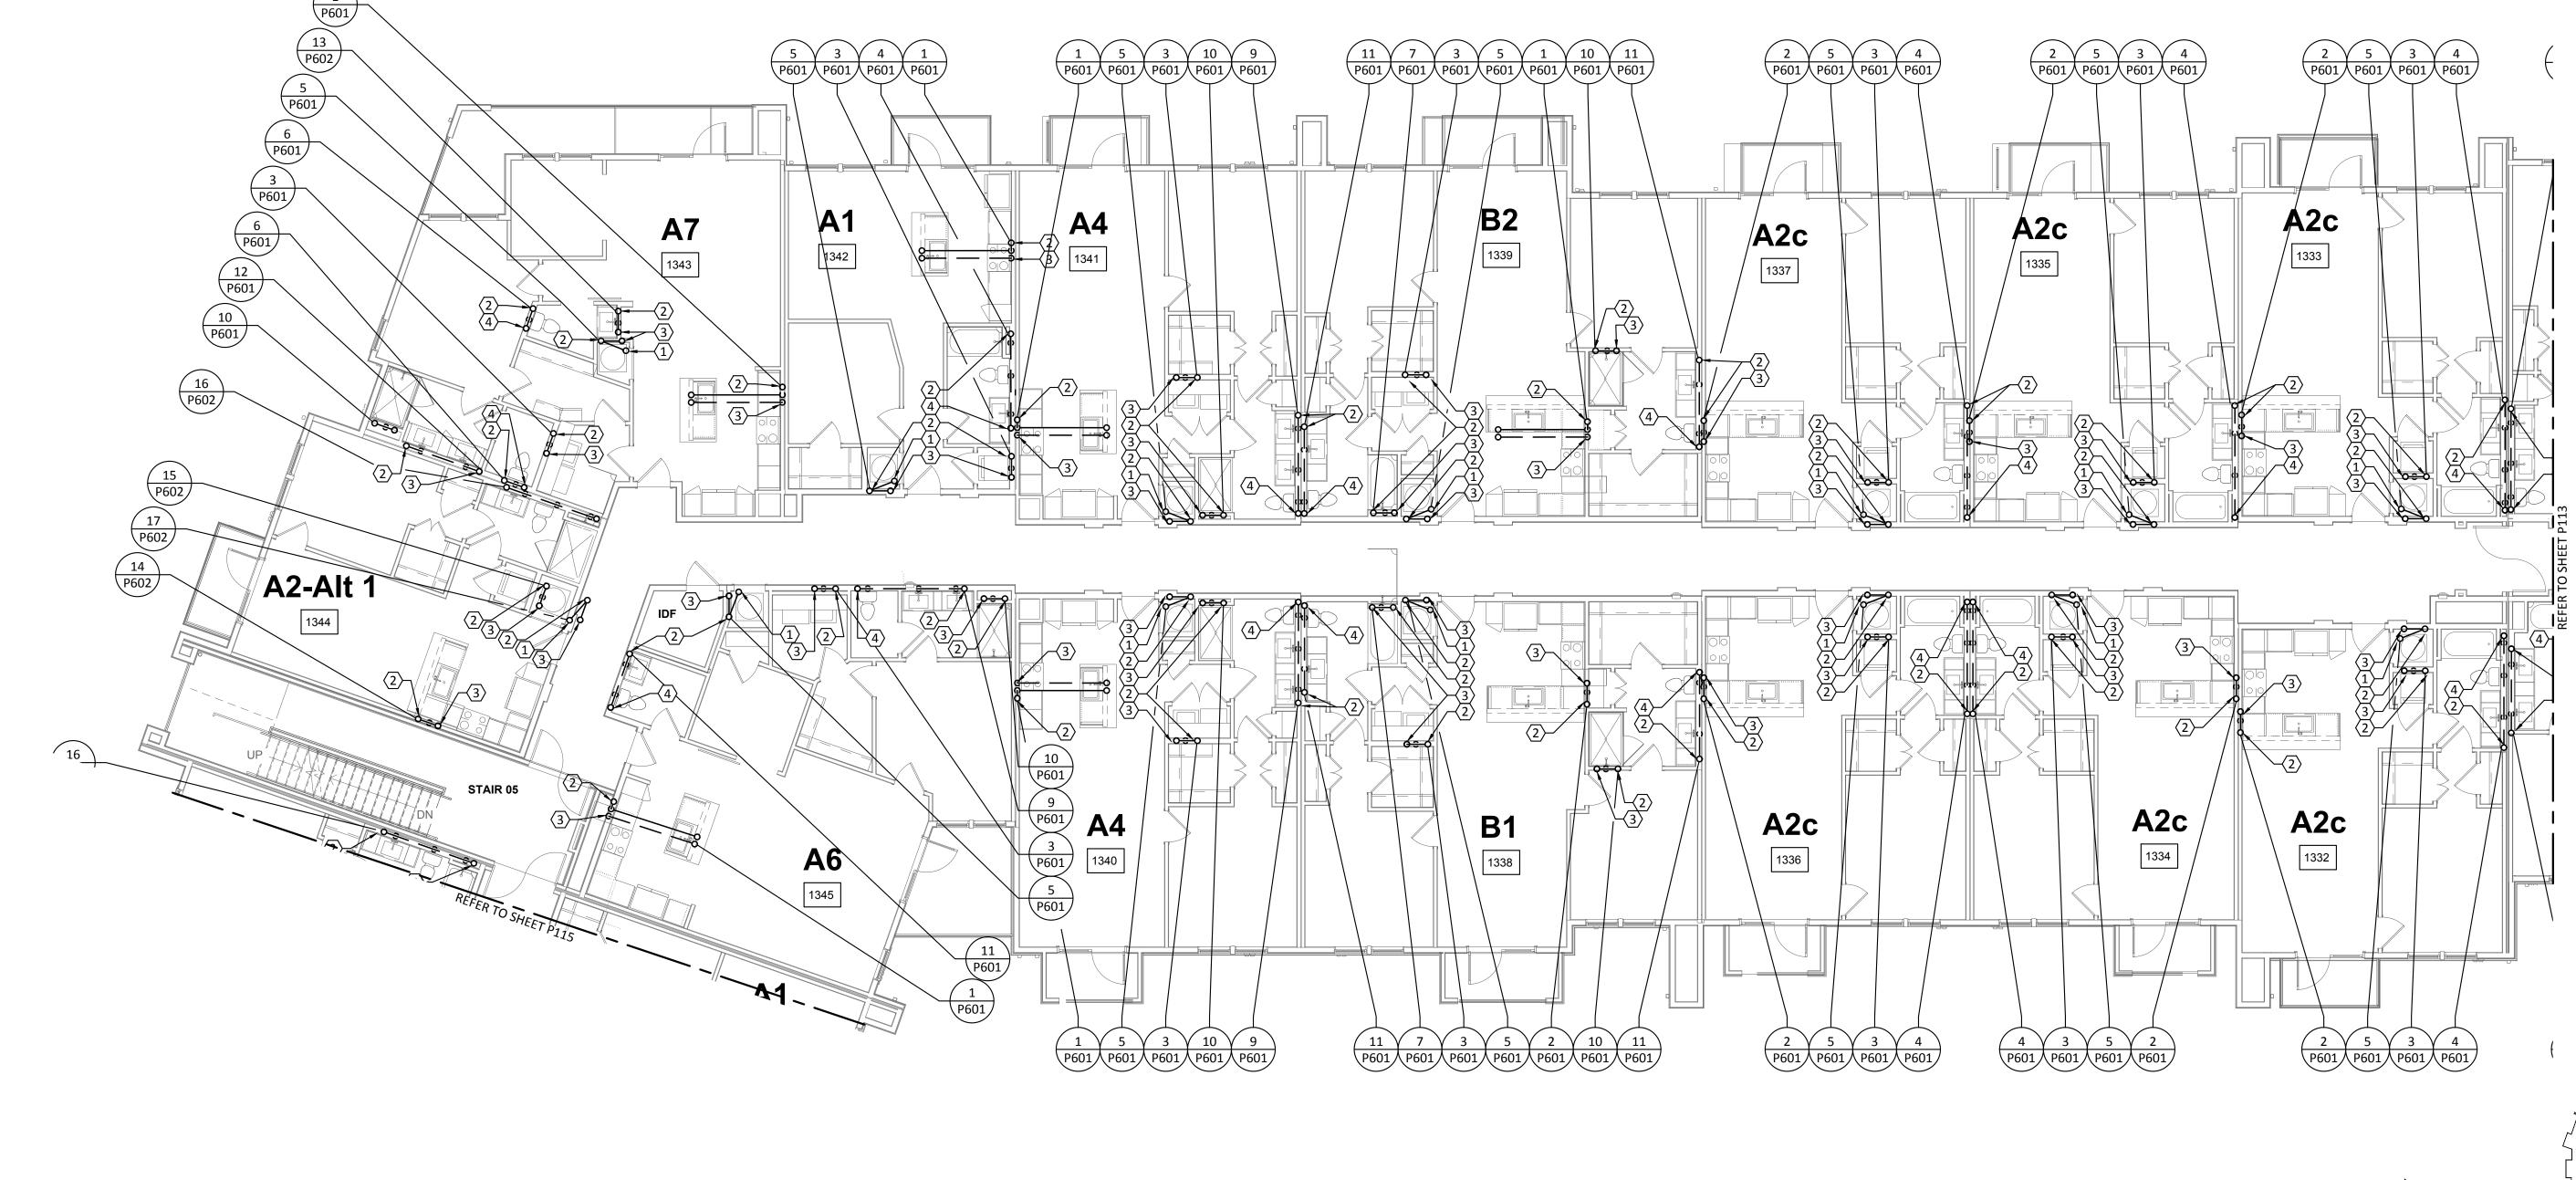

PLUMBING WASTEWATER - BUILDING Id - LEVEL 3

SCALE: 1/8"=1'-0"



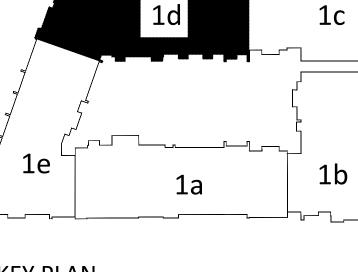

KEY PLAN
N.T.S.





Structural Engineer:

VIEWTECH INC. 4205 Beltway Dr. Addison, TX 75001 Victor Lisiak III 972.661.8187

MEP Engineer:

ENCOTECH 8500 Bluffstone Cove, Austin, TX. 78759 Tessa Roberts

Civil Engineer:

512.338.1101

MBC & Associates, Inc 1035 Central Pkwy N, San Antonio, TX 78732 David Allen 210.545.1122

Landscape Architect:

LEE & Associates, Inc. 9020 N Capital of Texas Hwy, Austin, TX. 78759 Amber Rothwell

Interior Designer:

512.345.8477

SJL Design Group 921 N. Riverfront Blvd. Suite 100, Dallas, TX 75207 Cassie Farley 214.443.9090

ISSUANCES

01	SCHEMATIC DESIGN	09.10.18
02	DEVELOPMENT DESIGN	11.09.18
03	PERMIT SET	01.28.19




a multifamily project for NRP Group

West Cevallos San Antonio, Texas

PLUMBING WASTEWATER BUILDING Id LEVEL 3

Project Number	18054
Date	01/14/2018
Drawn By	TLR
Checked By	EEC

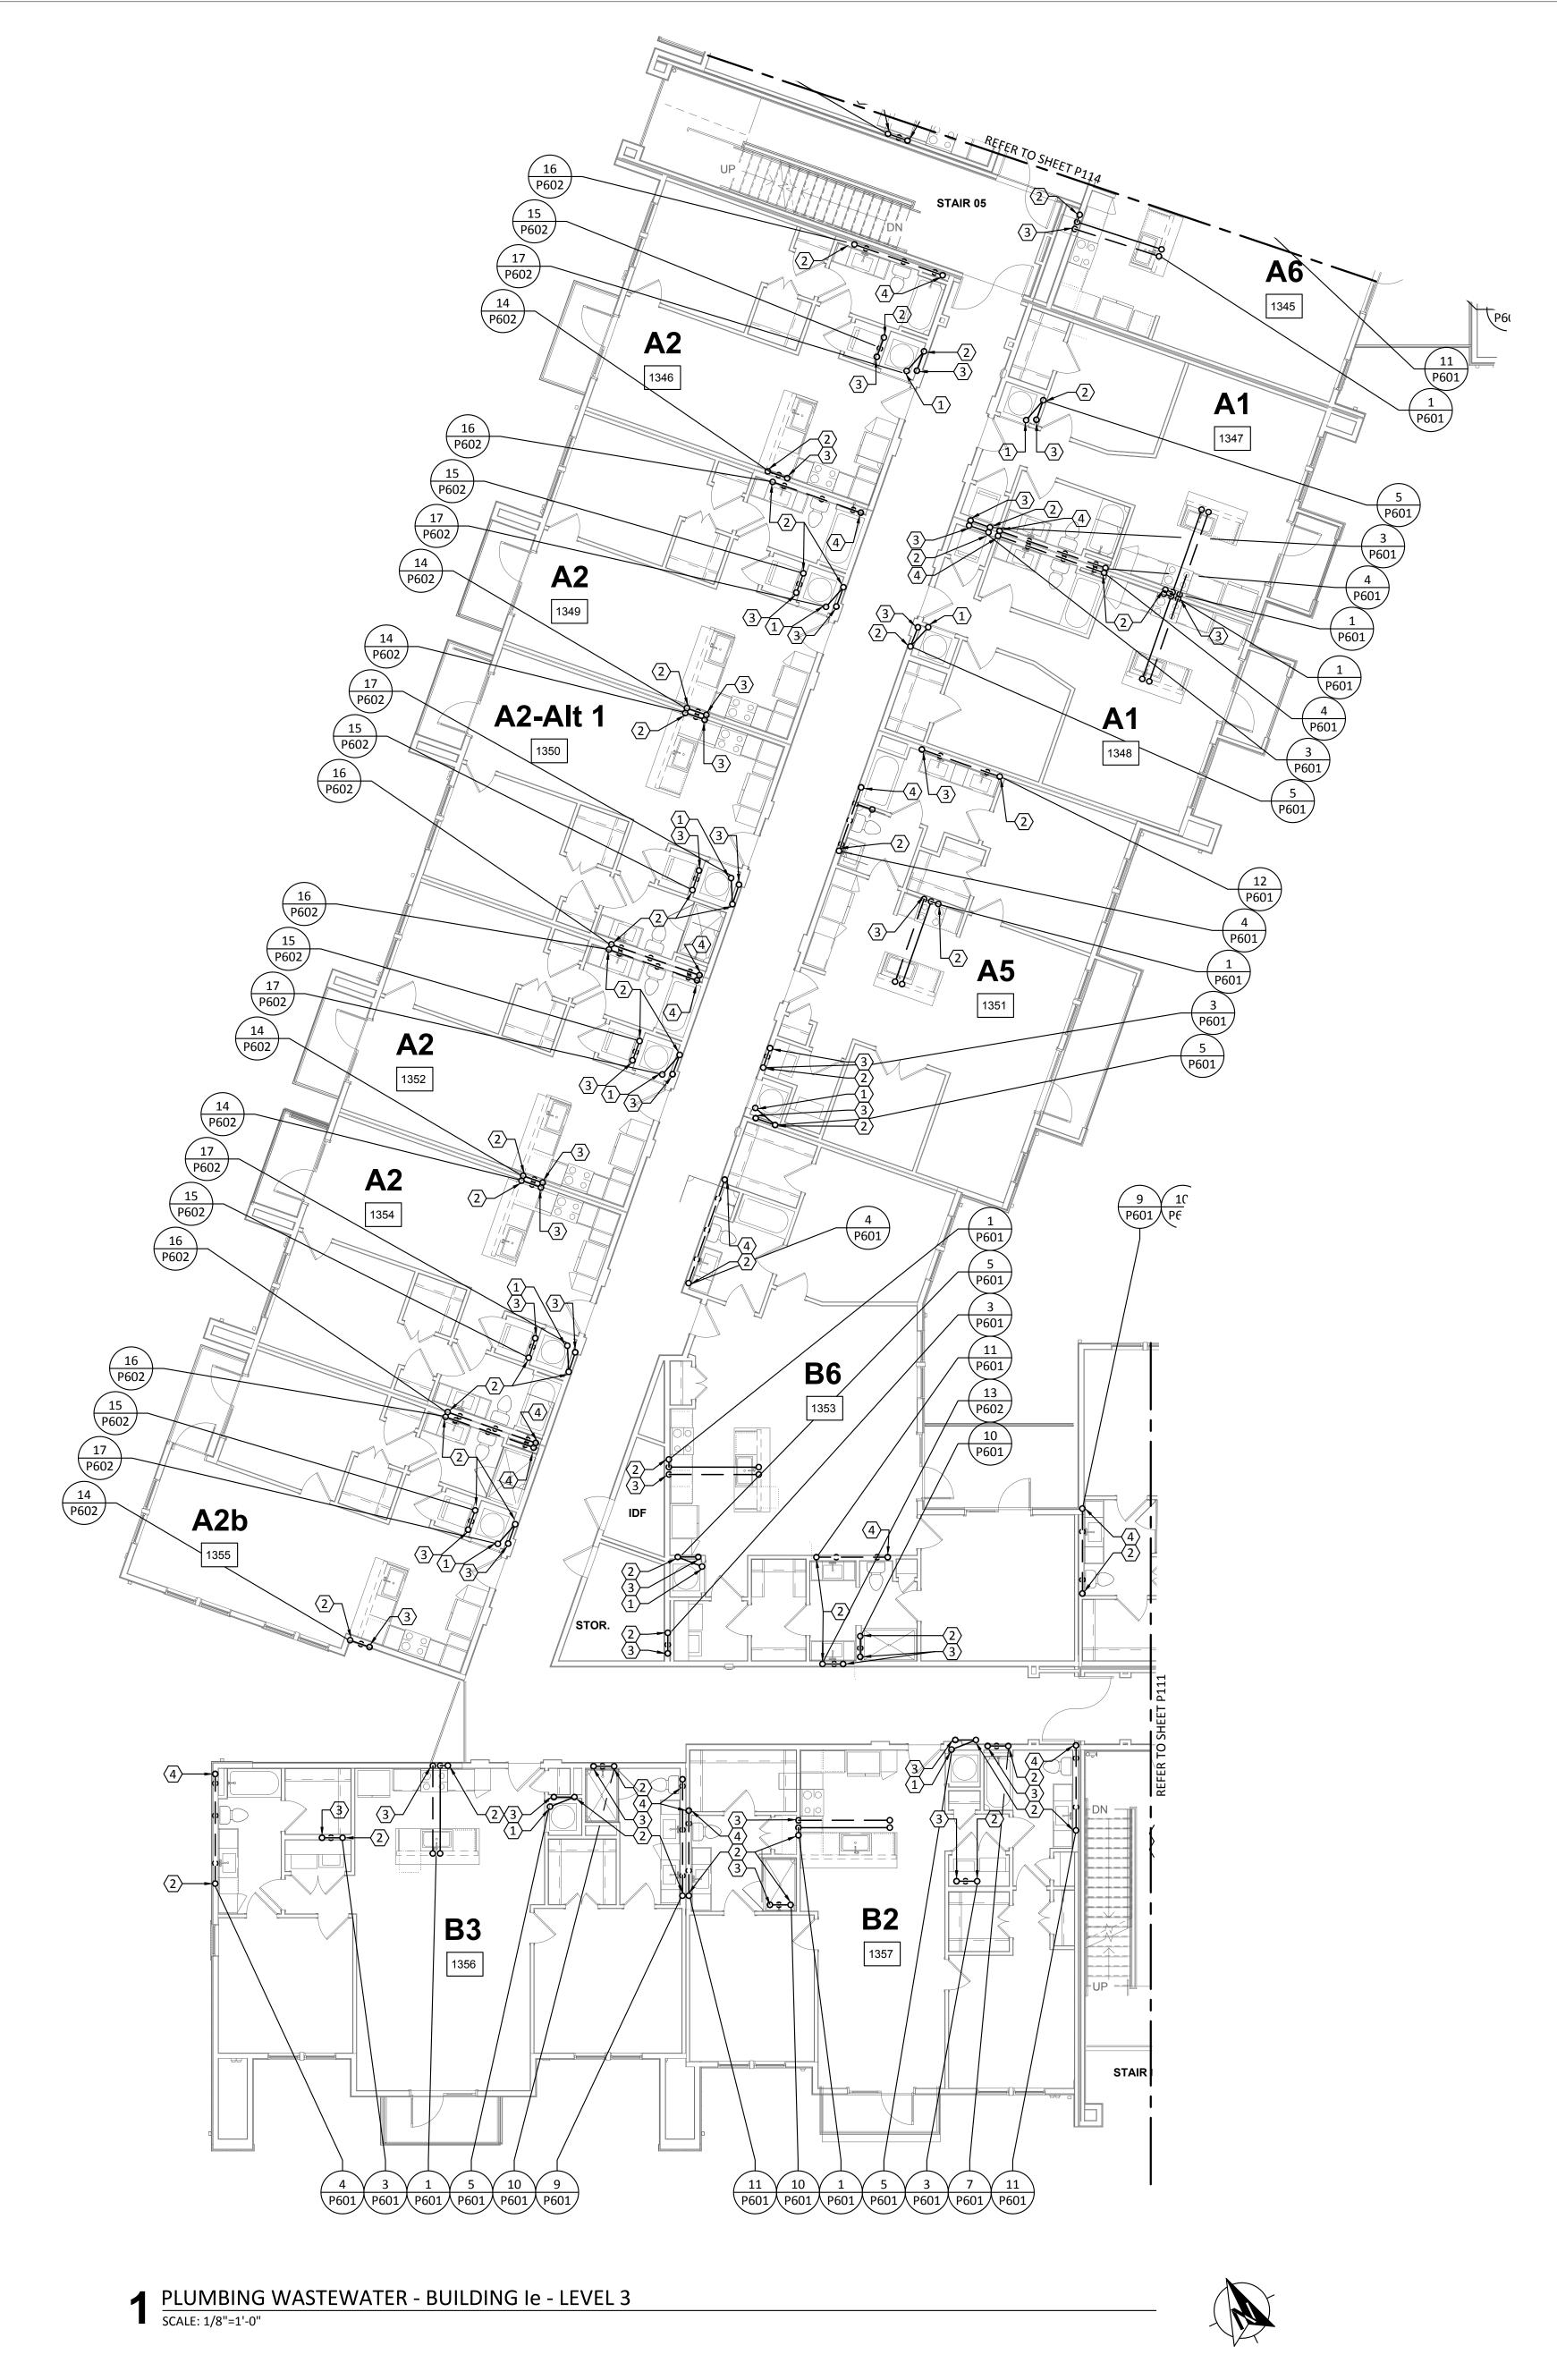

REFER TO SHEET P000 FOR ADDITIONAL INFORMATION.

PROVIDE TRAP PRIMER FOR ALL HUB DRAINS AND FLOOR DRAINS. EXTND 1/2" DOMESTIC WATER TO TRAP PRIMER.

KEYED NOTES:

2" HUB DRAIN "HB-1" LOCATED IN FRONT OF MECHANICAL CLOSET FOR ACCESSIBILITY.

VENT TO FLOOR ABOVE. REFER TO WASTEWATER RISER DIAGRAMS FOR VENT PIPE SIZES.

2" WASTEWATER FROM FLOOR ABOVE TO FLOOR BELOW.

4" WASTEWATER FROM FLOOR ABOVE TO FLOOR BELOW.

COLLABORATIVE
2607 S Lorger Plyd Suite 103

Structural Engineer:

VIEWTECH INC. 4205 Beltway Dr. Addison, TX 75001 Victor Lisiak III 972.661.8187

MEP Engineer:

ENCOTECH 8500 Bluffstone Cove, Austin, TX. 78759 Tessa Roberts 512.338.1101

Civil Engineer:

210.545.1122

MBC & Associates, Inc 1035 Central Pkwy N, San Antonio, TX 78732 David Allen

Landscape Architect:

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Interior Designer:

512.345.8477

SJL Design Group 921 N. Riverfront Blvd. Suite 100, Dallas, TX 75207 Cassie Farley 214.443.9090

	ISSUANCES		
	01	SCHEMATIC DESIGN	09.10.18
	02	DEVELOPMENT DESIGN	11.09.18
	03	PERMIT SET	01.28.19



a multifamily project for NRP Group


West Cevallos San Antonio, Texas

PLUMBING WASTEWATER BUILDING 1e LEVEL 3

Project Number 01/14/2018 Drawn By Checked By EEC

P115

TBPE Firm 8500 Bluffstone Cove, Suite B-103 1141 Austin, Texas 78759 | 512.338.1101 Project No.: 18054.MS.AUS

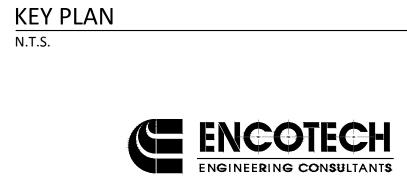




REFER TO SHEET P000 FOR ADDITIONAL INFORMATION.

PROVIDE TRAP PRIMER FOR ALL HUB DRAINS AND FLOOR DRAINS. EXTND 1/2" DOMESTIC WATER TO TRAP PRIMER.

KEYED NOTES:

- 2" HUB DRAIN "HB-1" LOCATED IN FRONT OF MECHANICAL CLOSET FOR ACCESSIBILITY.
- VENT TO FLOOR ABOVE. REFER TO WASTEWATER RISER DIAGRAMS FOR VENT PIPE SIZES.
- 2" WASTEWATER TO FLOOR BELOW.
- 4" WASTEWATER TO FLOOR BELOW.

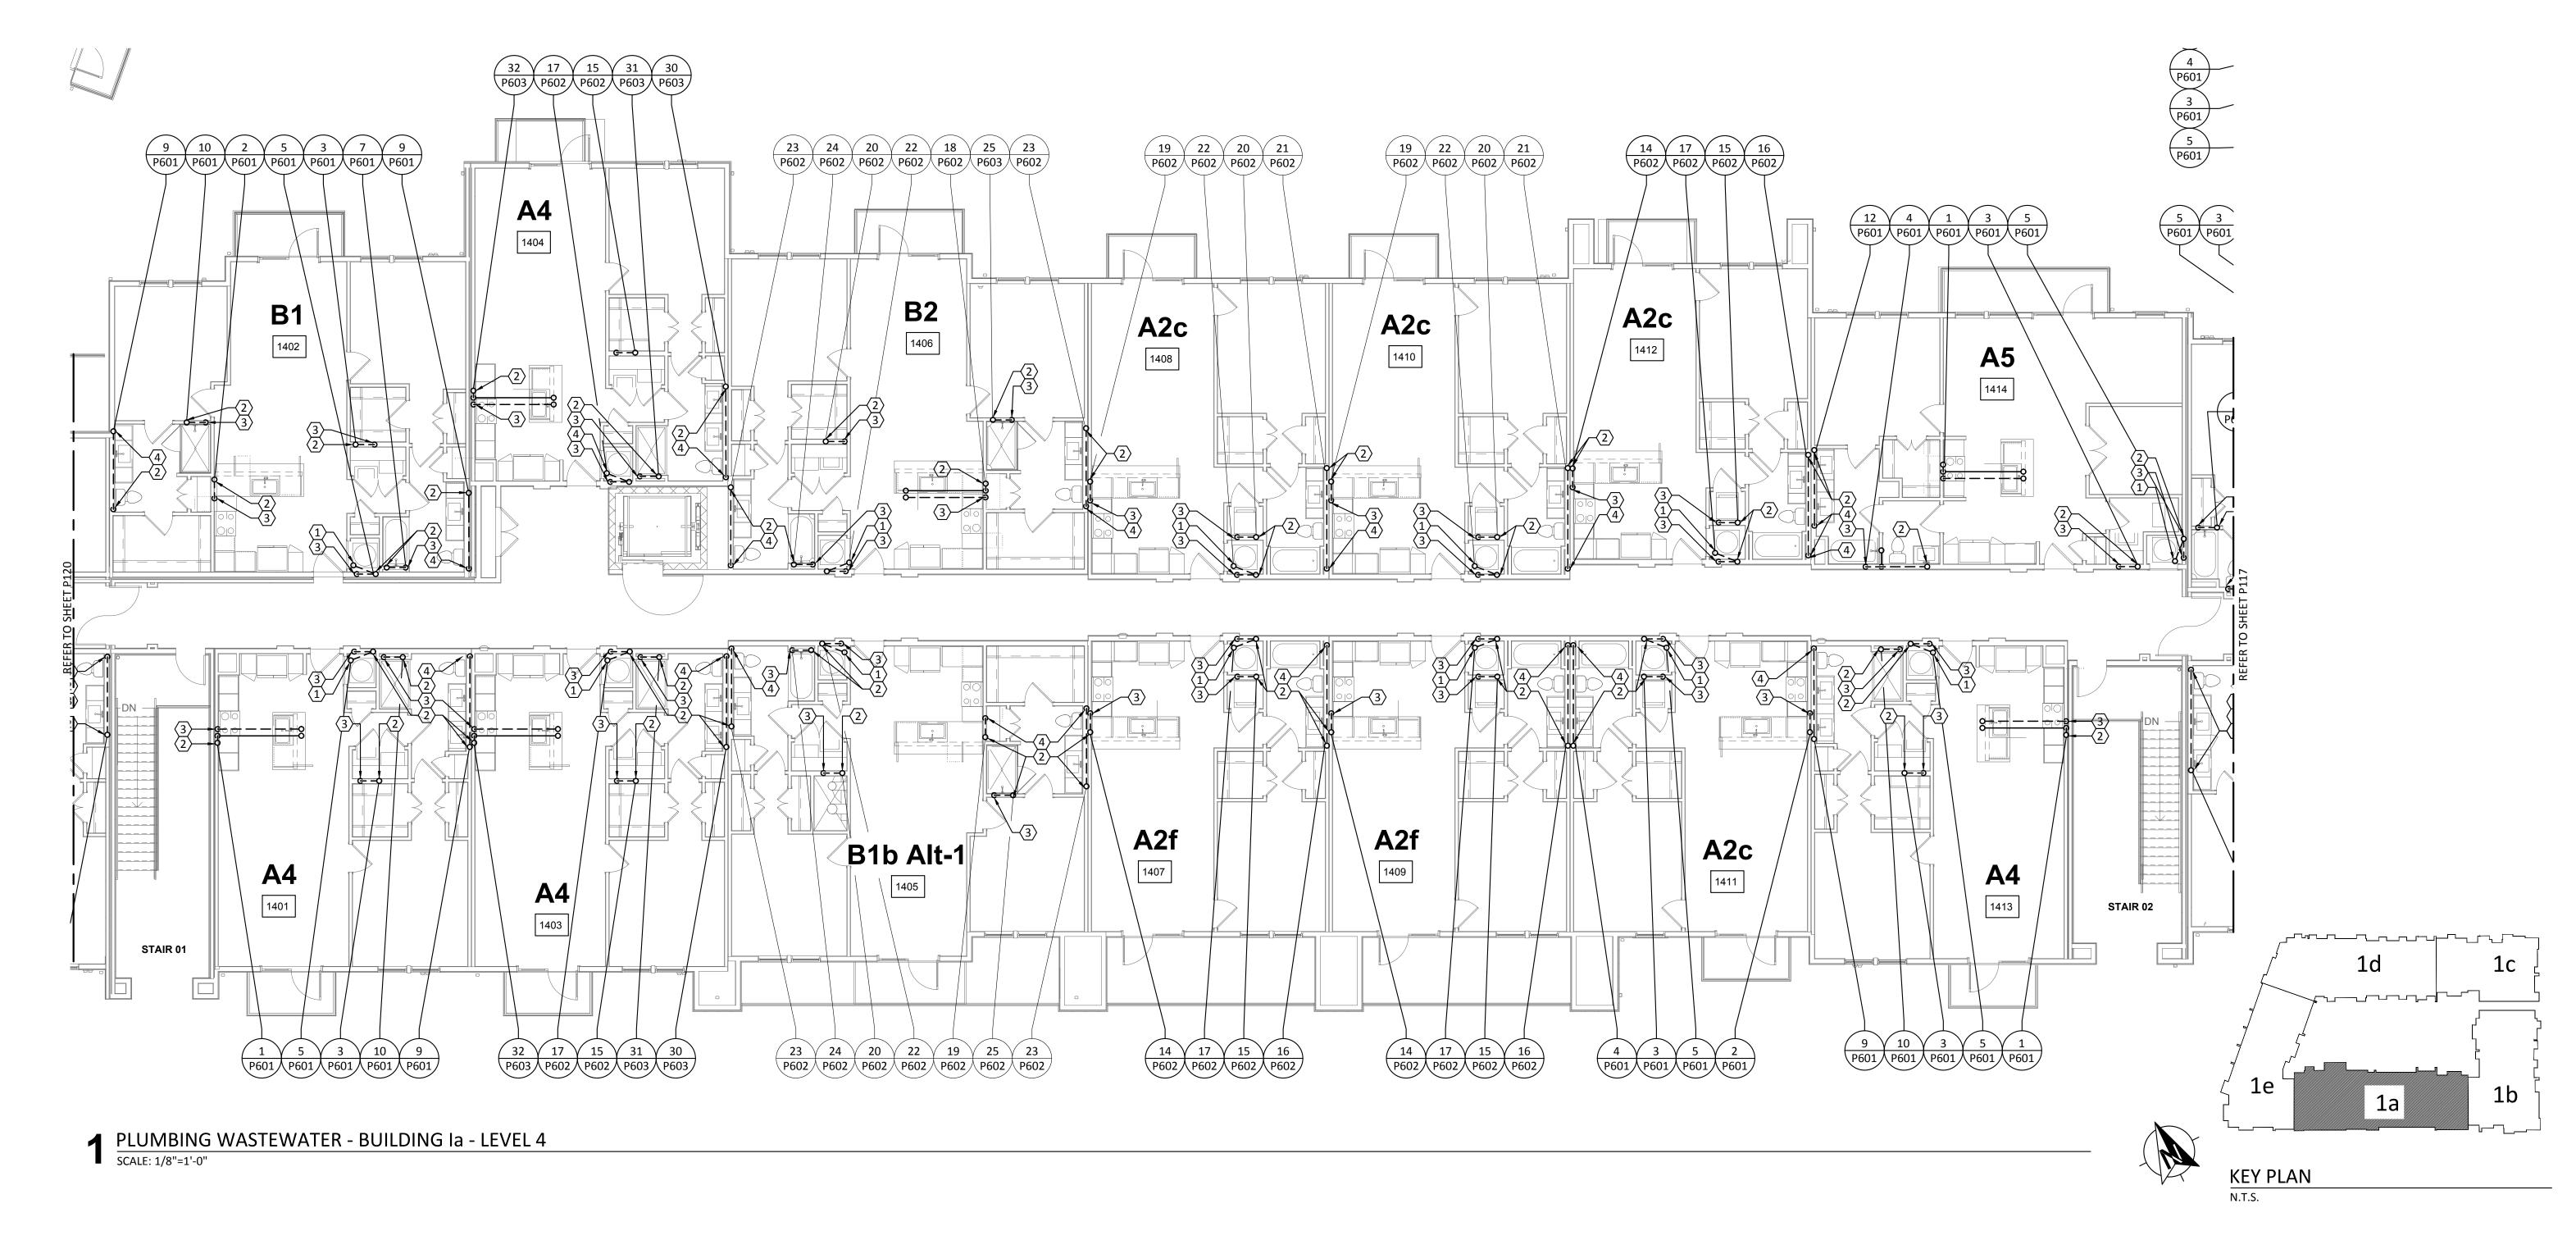



4205 Beltway Dr. Addison, TX 75001 Victor Lisiak III 972.661.8187

MEP Engineer:

ENCOTECH 8500 Bluffstone Cove, Austin, TX. 78759 Tessa Roberts 512.338.1101

Civil Engineer:

MBC & Associates, Inc 1035 Central Pkwy N, San Antonio, TX 78732 David Allen 210.545.1122

Landscape Architect:

LEE & Associates, Inc. 9020 N Capital of Texas Hwy, Austin, TX. 78759 Amber Rothwell

Interior Designer:

512.345.8477

SJL Design Group 921 N. Riverfront Blvd. Suite 100, Dallas, TX 75207 Cassie Farley 214.443.9090

ISSUANCES		
01	SCHEMATIC DESIGN	09.10.18
02	DEVELOPMENT DESIGN	11.09.18
03	PERMIT SET	01.28.19



a multifamily project for NRP Group


West Cevallos San Antonio, Texas

PLUMBING WASTEWATER BUILDING 1a LEVEL 4

Project Number	18054
Date	01/14/2018
Drawn By	TLR
Checked By	EEC

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ENGINEERING CONSULTANTS TBPE Firm | 8500 Bluffstone Cove, Suite B-103 1141 | Austin, Texas 78759 | 512.338.1101 Project No.: 18054.MS.AUS

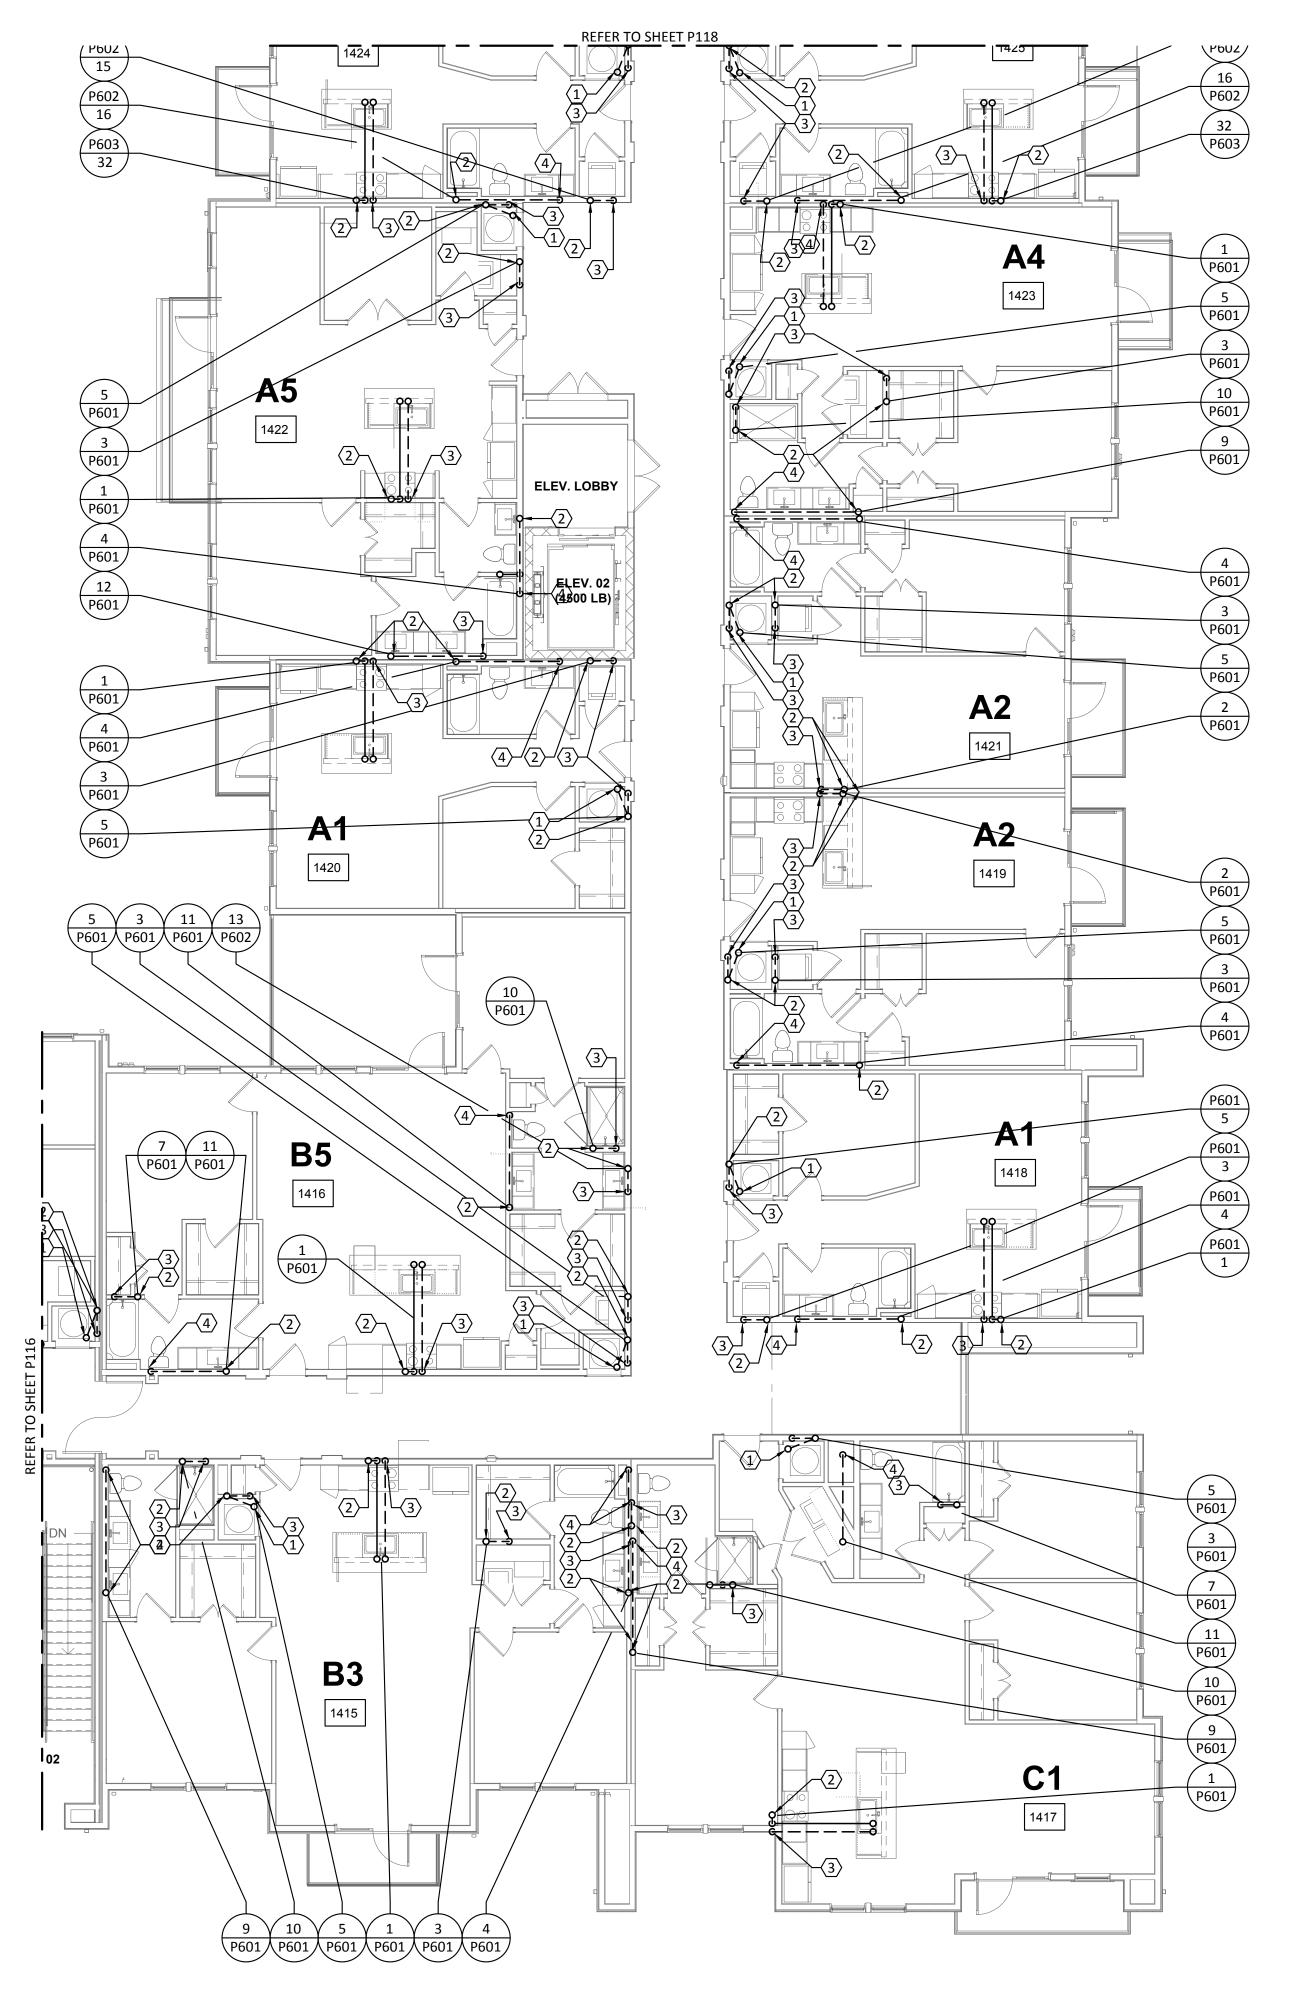

1 PLUMBING WASTEWATER - BUILDING Ib - LEVEL 4
SCALE: 1/8"=1'-0"



REFER TO SHEET P000 FOR ADDITIONAL INFORMATION.

PROVIDE TRAP PRIMER FOR ALL HUB DRAINS AND FLOOR DRAINS. EXTND 1/2" DOMESTIC WATER TO TRAP PRIMER.

KEYED NOTES:

- 2" HUB DRAIN "HB-1" LOCATED IN FRONT OF MECHANICAL CLOSET FOR ACCESSIBILITY.
- VENT TO FLOOR ABOVE. REFER TO WASTEWATER RISER DIAGRAMS FOR VENT PIPE SIZES.
- 2" WASTEWATER TO FLOOR BELOW.
- 4" WASTEWATER TO FLOOR BELOW.

DAVIES COLLABORATIVE

Structural Engineer:

VIEWTECH INC. 4205 Beltway Dr. Addison, TX 75001 Victor Lisiak III

MEP Engineer:

972.661.8187

ENCOTECH 8500 Bluffstone Cove, Austin, TX. 78759

Civil Engineer:

210.545.1122

Tessa Roberts 512.338.1101

MBC & Associates, Inc 1035 Central Pkwy N, San Antonio, TX 78732 David Allen

Landscape Architect:

LEE & Associates, Inc. 9020 N Capital of Texas Hwy, Austin, TX. 78759 Amber Rothwell

Interior Designer:

512.345.8477

SJL Design Group 921 N. Riverfront Blvd. Suite 100, Dallas, TX 75207 Cassie Farley 214.443.9090

	ISSUANCES		
	01	SCHEMATIC DESIGN	09.10.18
	02	DEVELOPMENT DESIGN	11.09.18
	03	PERMIT SET	01.28.19
•			



a multifamily project for NRP Group

West Cevallos San Antonio, Texas

PLUMBING WASTEWATER BUILDING 1b LEVEL 4

Project Number 01/14/2018 Drawn By TLR Checked By EEC

P117

ENCOTECH ENGINEERING CONSULTANTS

1e

KEY PLAN
N.T.S.



REFER TO SHEET P000 FOR ADDITIONAL INFORMATION.

PROVIDE TRAP PRIMER FOR ALL HUB DRAINS AND FLOOR DRAINS. EXTND 1/2" DOMESTIC WATER TO TRAP PRIMER.

KEYED NOTES:

- 2" HUB DRAIN "HB-1" LOCATED IN FRONT OF MECHANICAL CLOSET FOR ACCESSIBILITY.
- VENT TO FLOOR ABOVE. REFER TO WASTEWATER RISER DIAGRAMS FOR VENT PIPE SIZES.
- . 2" WASTEWATER TO FLOOR BELOW.
- 4" WASTEWATER TO FLOOR BELOW.



Structural Engineer:

VIEWTECH INC. 4205 Beltway Dr. Addison, TX 75001 Victor Lisiak III

MEP Engineer:

972.661.8187

ENCOTECH 8500 Bluffstone Cove, Austin, TX. 78759 Tessa Roberts

Civil Engineer:

210.545.1122

512.338.1101

MBC & Associates, Inc 1035 Central Pkwy N, San Antonio, TX 78732 David Allen

Landscape Architect:


LEE & Associates, Inc. 9020 N Capital of Texas Hwy, Austin, TX. 78759 Amber Rothwell

Interior Designer:

512.345.8477

SJL Design Group 921 N. Riverfront Blvd. Suite 100, Dallas, TX 75207 Cassie Farley 214.443.9090

ISSUANCES		
01	SCHEMATIC DESIGN	09.10.18
02	DEVELOPMENT DESIGN	11.09.18
03	PERMIT SET	01.28.19
	ISSUANCES 01 02 03	01 SCHEMATIC DESIGN 02 DEVELOPMENT DESIGN

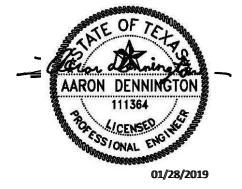

a multifamily project for NRP Group

West Cevallos San Antonio, Texas


PLUMBING WASTEWATER BUILDING 1c LEVEL 4

Project Number	18054
Date	01/14/2018
Drawn By	TLR
Checked By	EEC

C1 1427 **B3** 1431 **B5 A1** 1430 1426 1425 1424

✓ PLUMBING WASTEWATER - BUILDING Ic - LEVEL 4

SCALE: 1/8"=1'-0"

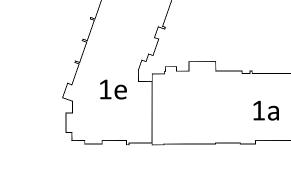

KEY PLAN
N.T.S.

ENCOTECH ENGINEERING CONSULTANTS TBPE Firm | 8500 Bluffstone Cove, Suite B-103 1141 | Austin, Texas 78759 | 512.338.1101 Project No.: 18054.MS.AUS




A. REFER TO SHEET P000 FOR ADDITIONAL INFORMATION.

PROVIDE TRAP PRIMER FOR ALL HUB DRAINS AND FLOOR DRAINS. EXTND 1/2" DOMESTIC WATER TO TRAP PRIMER.

KEYED NOTES:


- 2" HUB DRAIN "HB-1" LOCATED IN FRONT OF MECHANICAL CLOSET FOR ACCESSIBILITY.
- VENT TO FLOOR ABOVE. REFER TO WASTEWATER RISER DIAGRAMS FOR VENT PIPE SIZES.
- 2" WASTEWATER TO FLOOR BELOW.
- 4" WASTEWATER TO FLOOR BELOW.

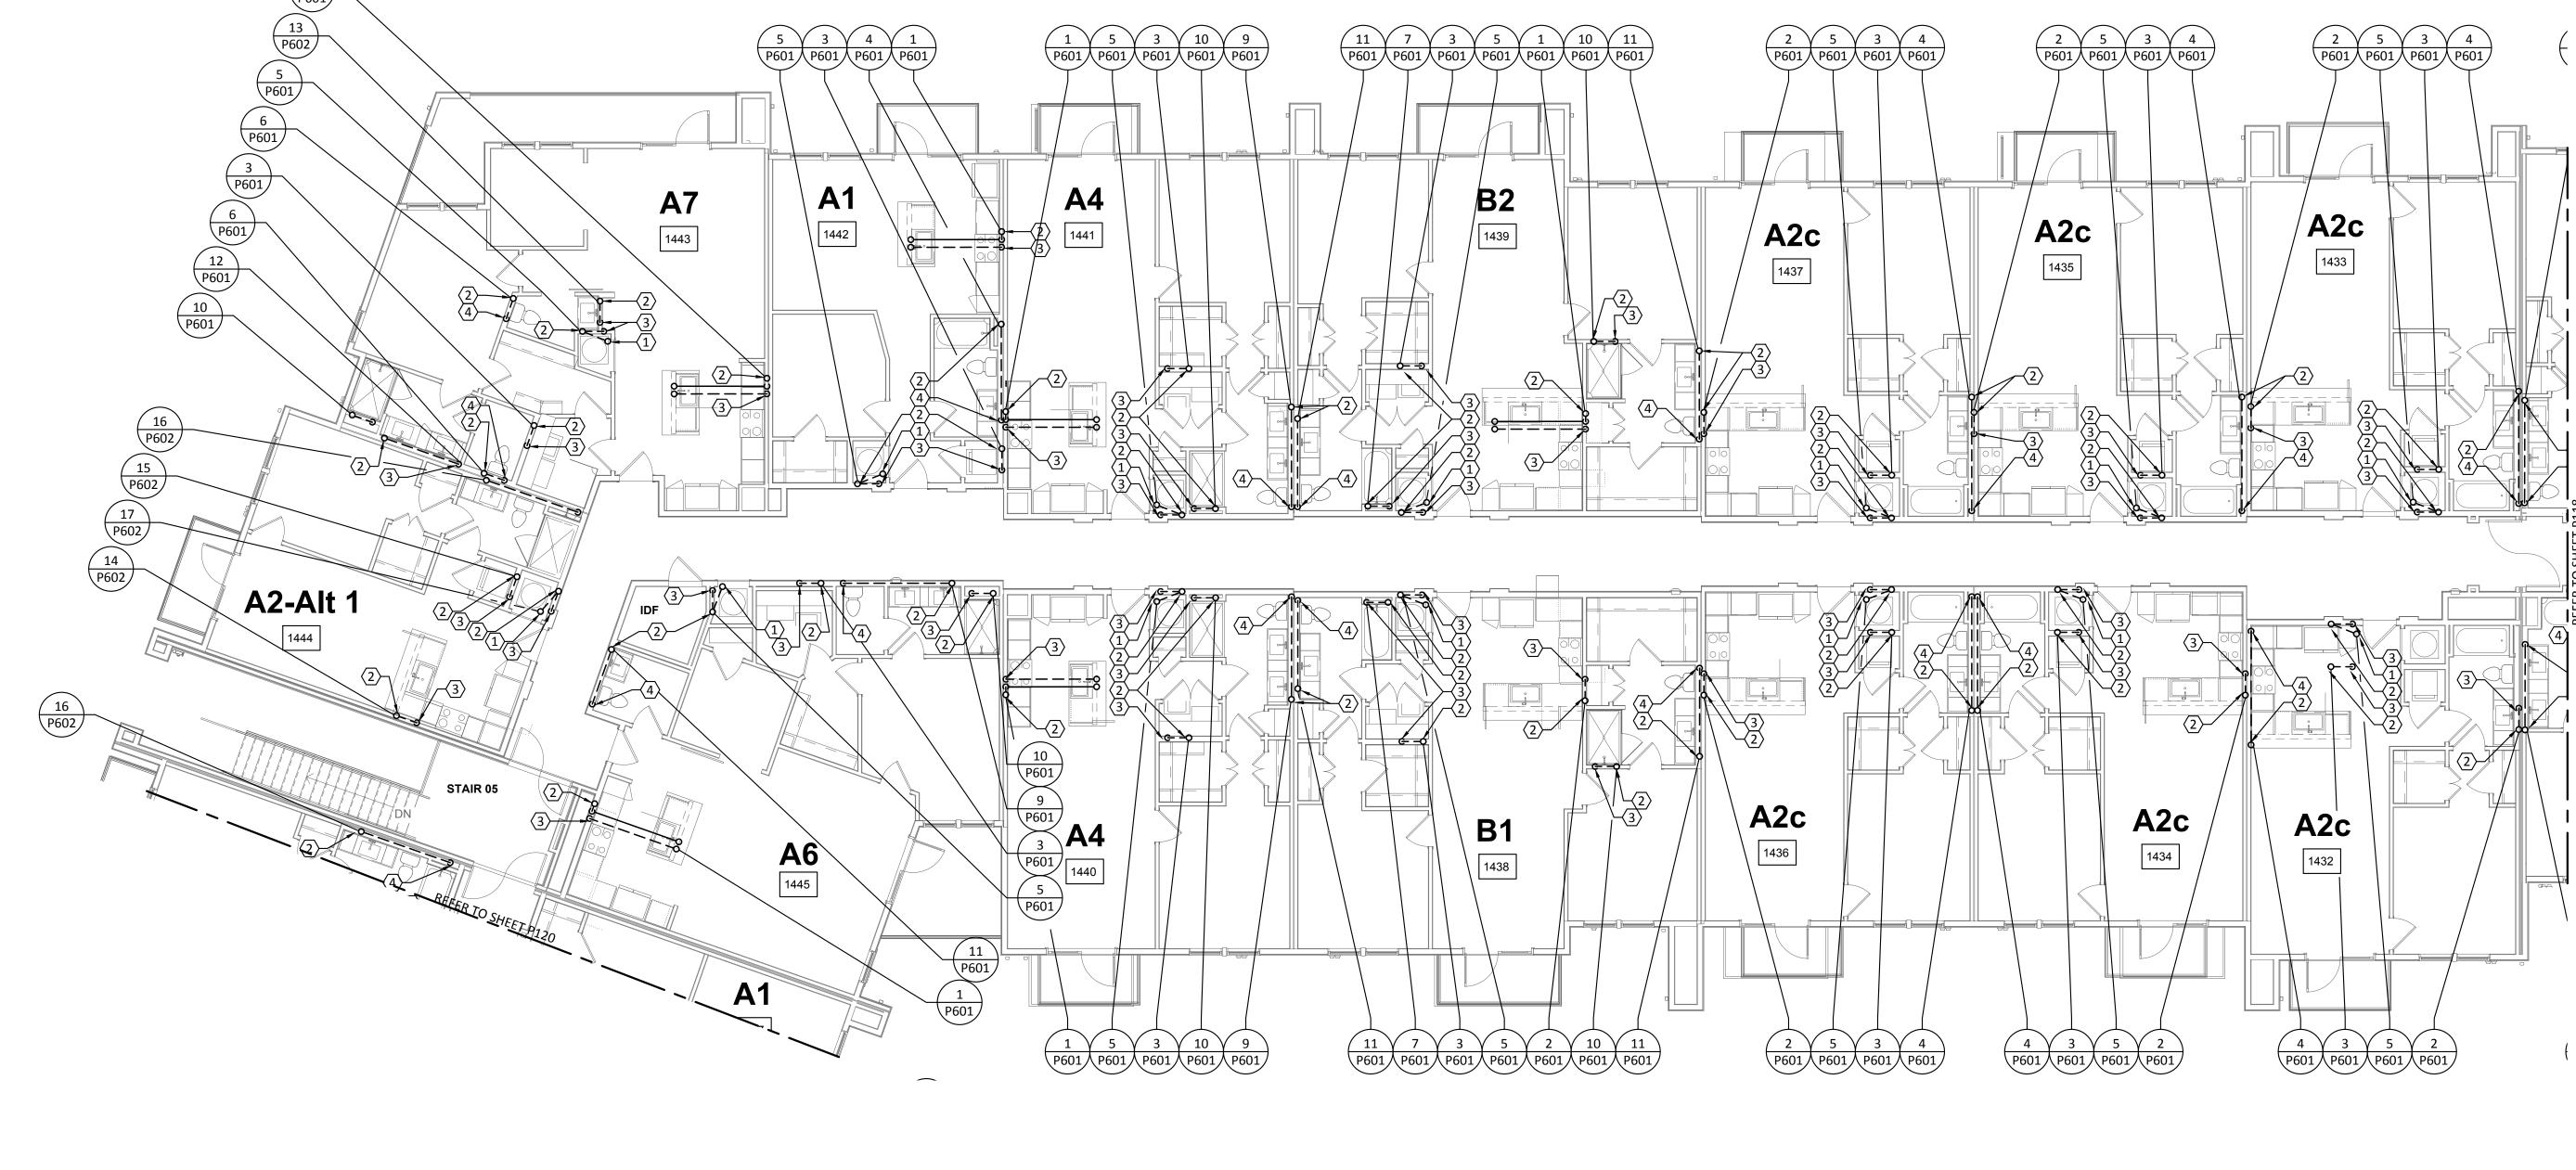

PLUMBING WASTEWATER - BUILDING Id - LEVEL 4

SCALE: 1/8"=1'-0"



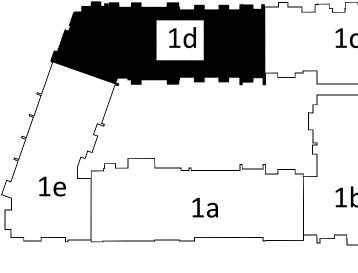

KEY PLAN





Structural Engineer:

VIEWTECH INC. 4205 Beltway Dr. Addison, TX 75001 Victor Lisiak III 972.661.8187

MEP Engineer:

ENCOTECH 8500 Bluffstone Cove, Austin, TX. 78759 Tessa Roberts 512.338.1101

Civil Engineer:

MBC & Associates, Inc 1035 Central Pkwy N, San Antonio, TX 78732 David Allen 210.545.1122

Landscape Architect:

LEE & Associates, Inc. 9020 N Capital of Texas Hwy, Austin, TX. 78759 Amber Rothwell 512.345.8477

Interior Designer:

SJL Design Group 921 N. Riverfront Blvd. Suite 100, Dallas, TX 75207 Cassie Farley 214.443.9090

ISSUANCES			
	01	SCHEMATIC DESIGN	09.10.18
	02	DEVELOPMENT DESIGN	11.09.18
	03	PERMIT SET	01.28.19

REVISION




a multifamily project for NRP Group

West Cevallos
San Antonio, Texas

PLUMBING WASTEWATER BUILDING Id LEVEL 4

Project Number	18054
Date	01/14/2018
Drawn By	TLR
Checked By	EEC

P119

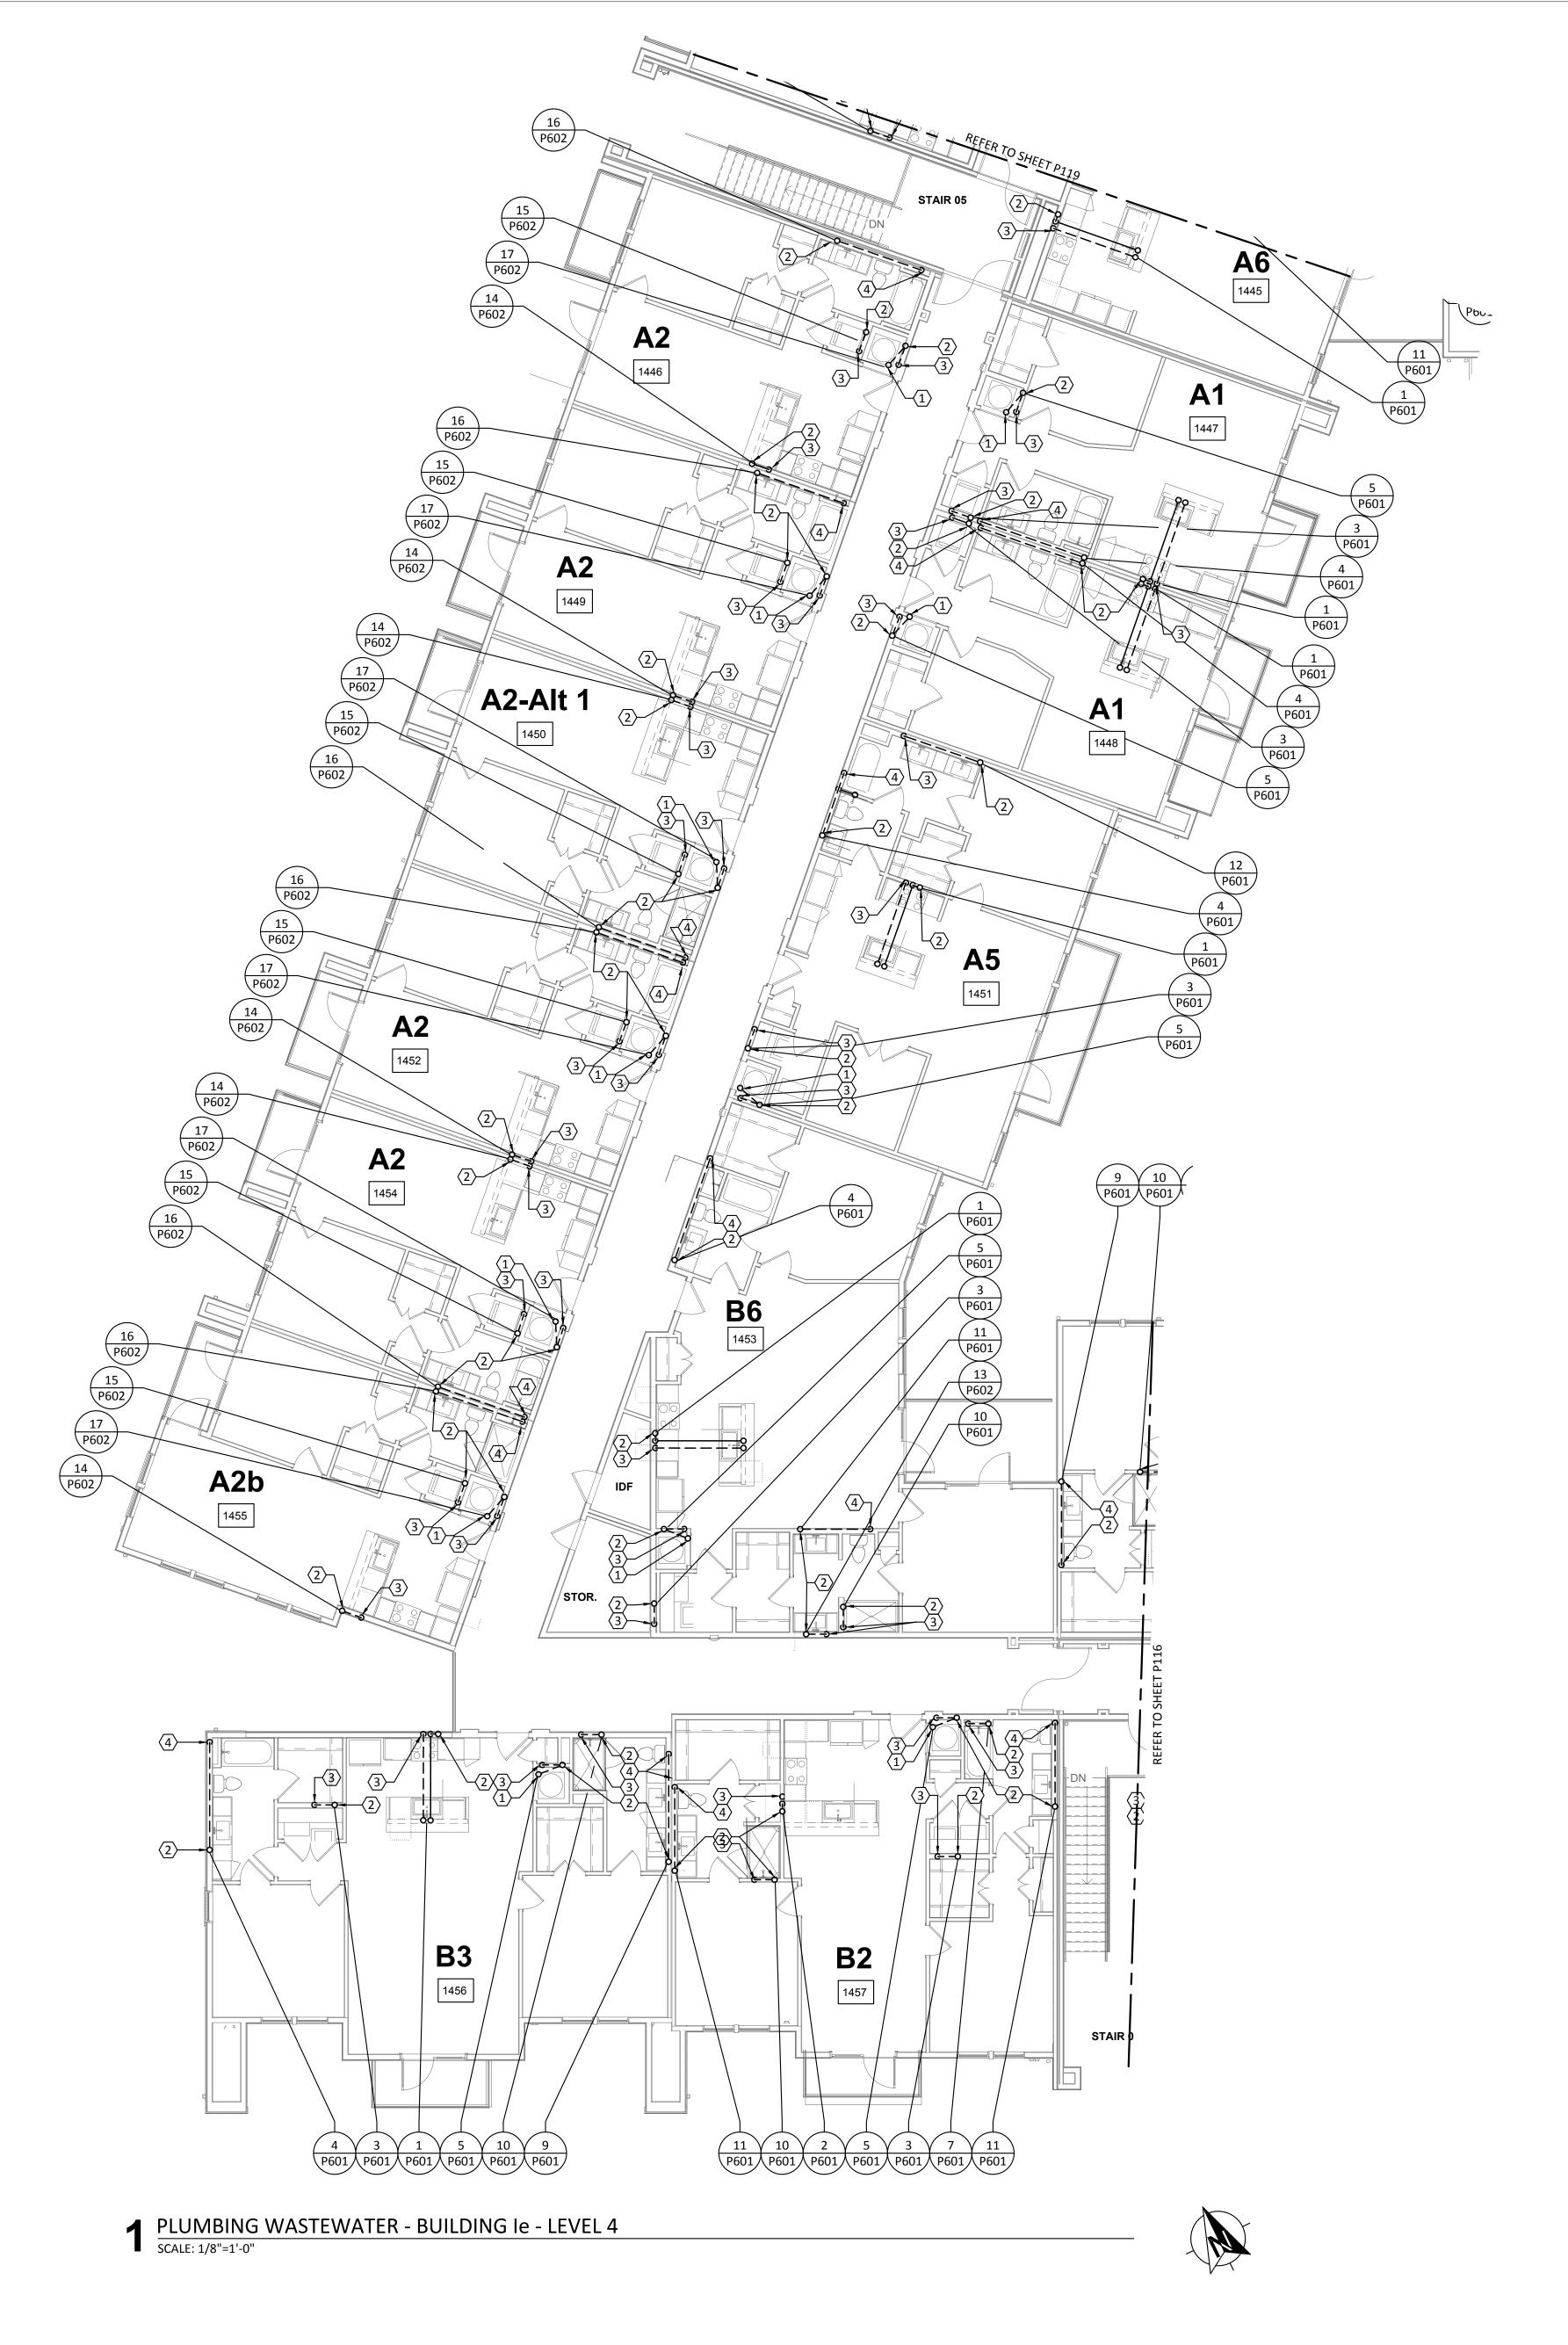

A. REFER TO SHEET P000 FOR ADDITIONAL INFORMATION.

PROVIDE TRAP PRIMER FOR ALL HUB DRAINS AND FLOOR DRAINS. EXTND 1/2" DOMESTIC WATER TO TRAP PRIMER.

KEYED NOTES:

2" HUB DRAIN "HB-1" LOCATED IN FRONT OF MECHANICAL CLOSET FOR ACCESSIBILITY.

VENT TO FLOOR ABOVE. REFER TO WASTEWATER RISER DIAGRAMS FOR VENT PIPE SIZES.

2" WASTEWATER TO FLOOR BELOW.

4" WASTEWATER TO FLOOR BELOW.



Structural Engineer:

VIEWTECH INC. 4205 Beltway Dr. Addison, TX 75001 Victor Lisiak III

MEP Engineer:

972.661.8187

ENCOTECH 8500 Bluffstone Cove, Austin, TX. 78759 Tessa Roberts 512.338.1101

Civil Engineer:

MBC & Associates, Inc 1035 Central Pkwy N, San Antonio, TX 78732 David Allen

Landscape Architect:

210.545.1122

LEE & Associates, Inc. 9020 N Capital of Texas Hwy, Austin, TX. 78759 Amber Rothwell


Interior Designer:

512.345.8477

SJL Design Group 921 N. Riverfront Blvd. Suite 100, Dallas, TX 75207 Cassie Farley 214.443.9090

ISSUANCES		
01	SCHEMATIC DESIGN	09.10.18
02	DEVELOPMENT DESIGN	11.09.18
03	PERMIT SET	01.28.19

REVISIONS

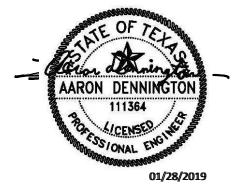

a multifamily project for NRP Group

West Cevallos
San Antonio, Texas

PLUMBING WASTEWATER BUILDING 1e LEVEL 4

Project Number 18054

Date 01/14/2018


Drawn By TLR

Checked By EEC


P120

TBPE Firm 1141 8500 Bluffstone Cove, Suite B-103 Austin, Texas 78759 | 512.338.1101 Project No.: 18054.MS.AUS

KEY PLAN
N.T.S.

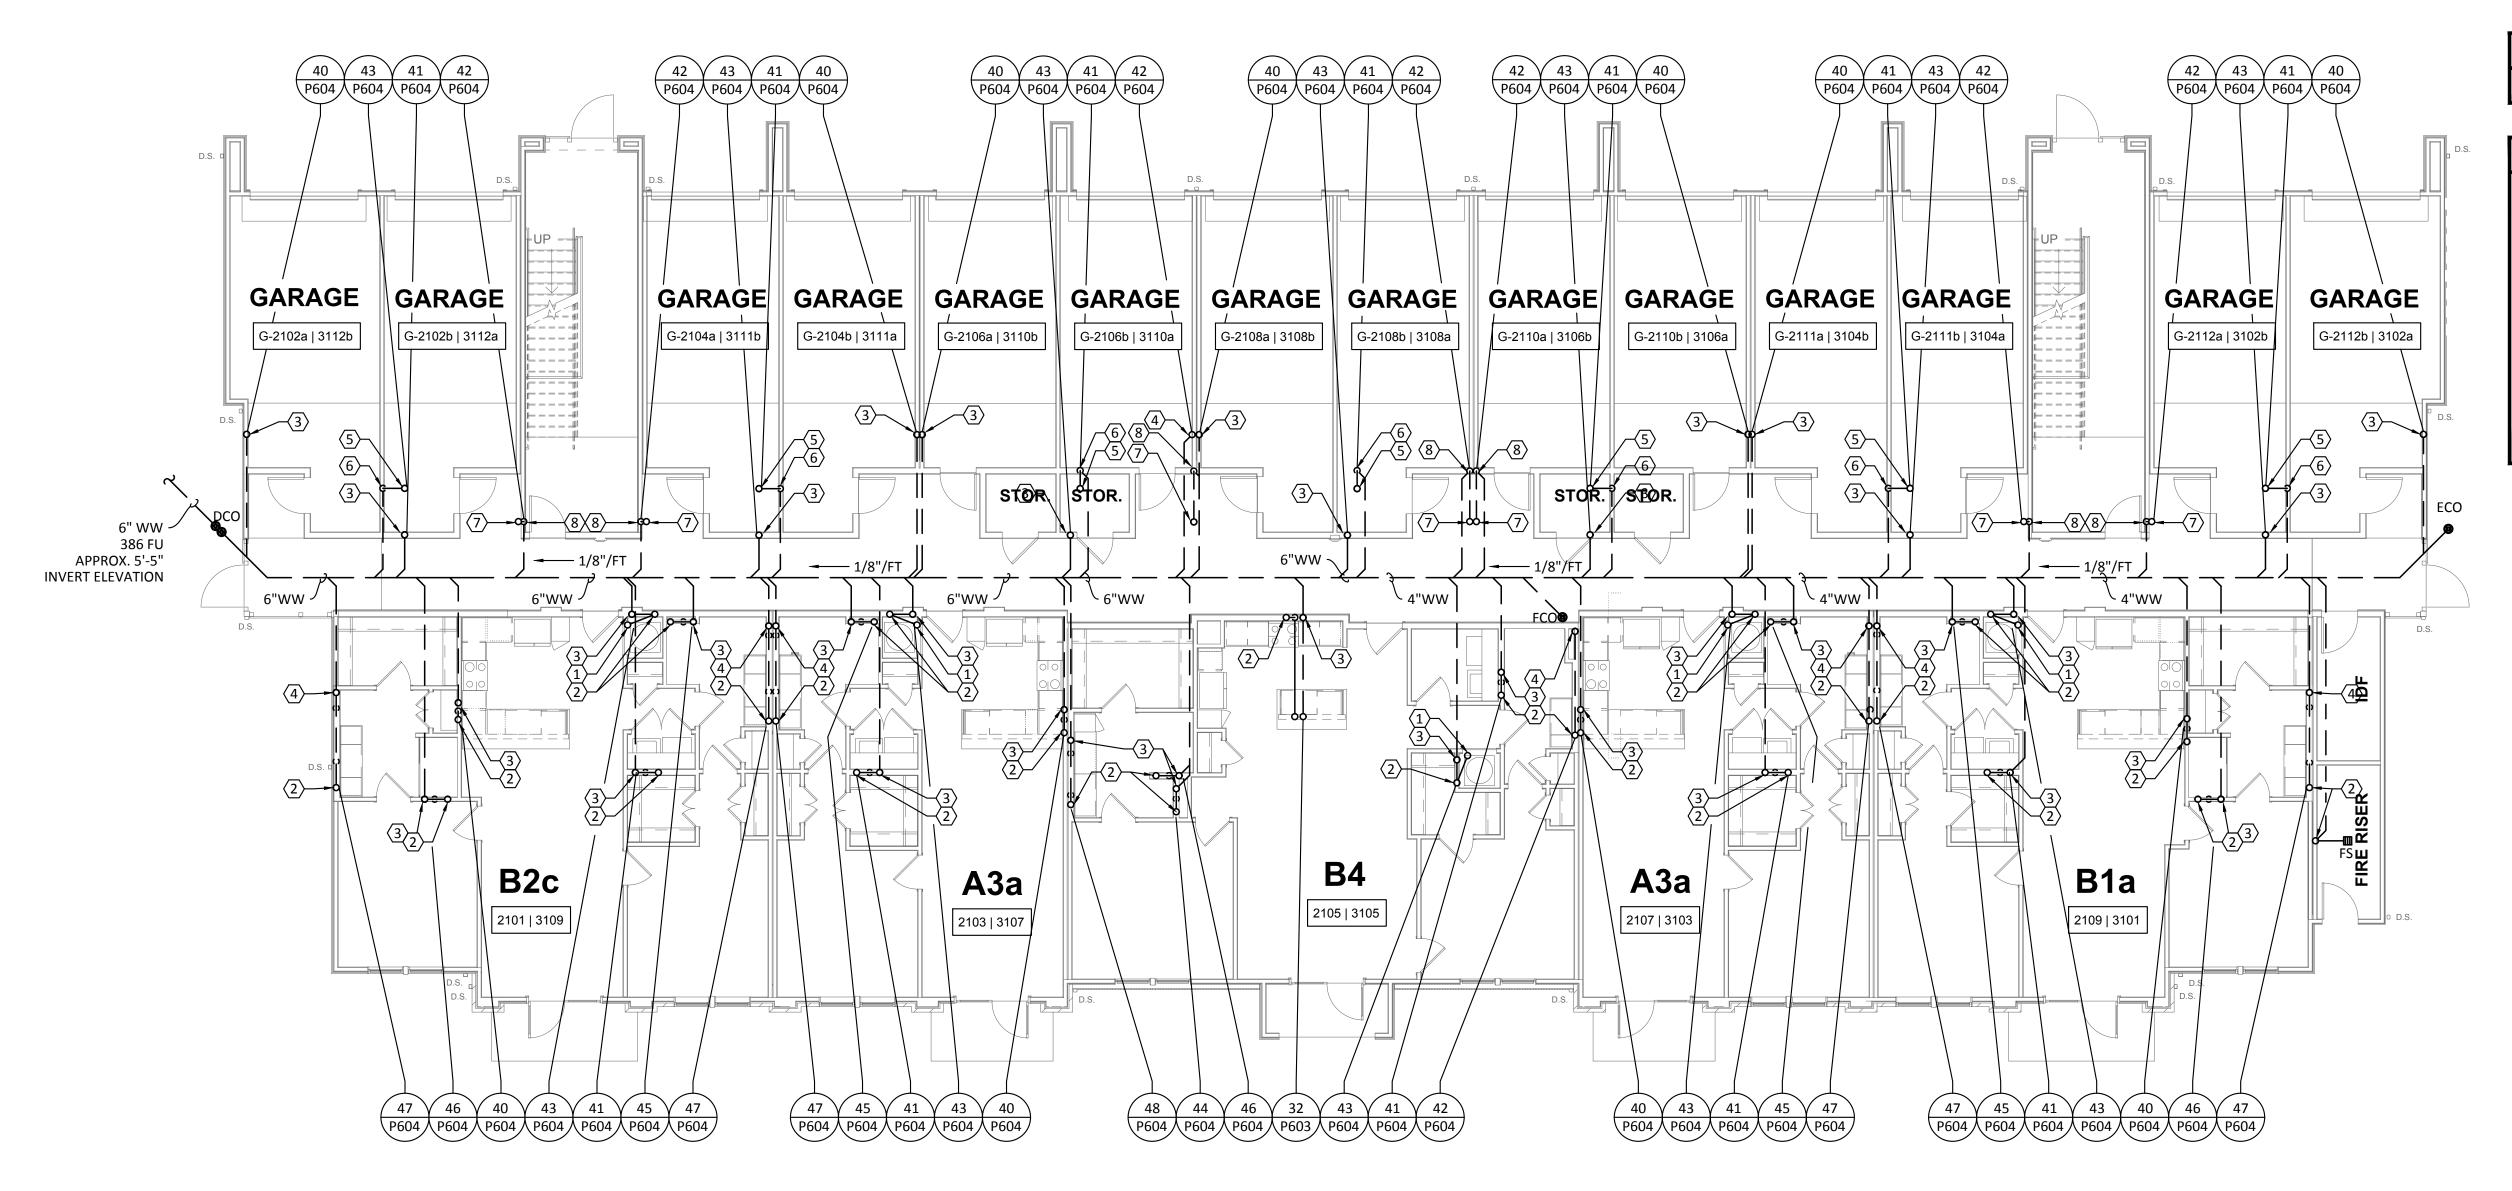

✓ PLUMBING WASTEWATER - BUILDING II (#2) - LEVEL 1

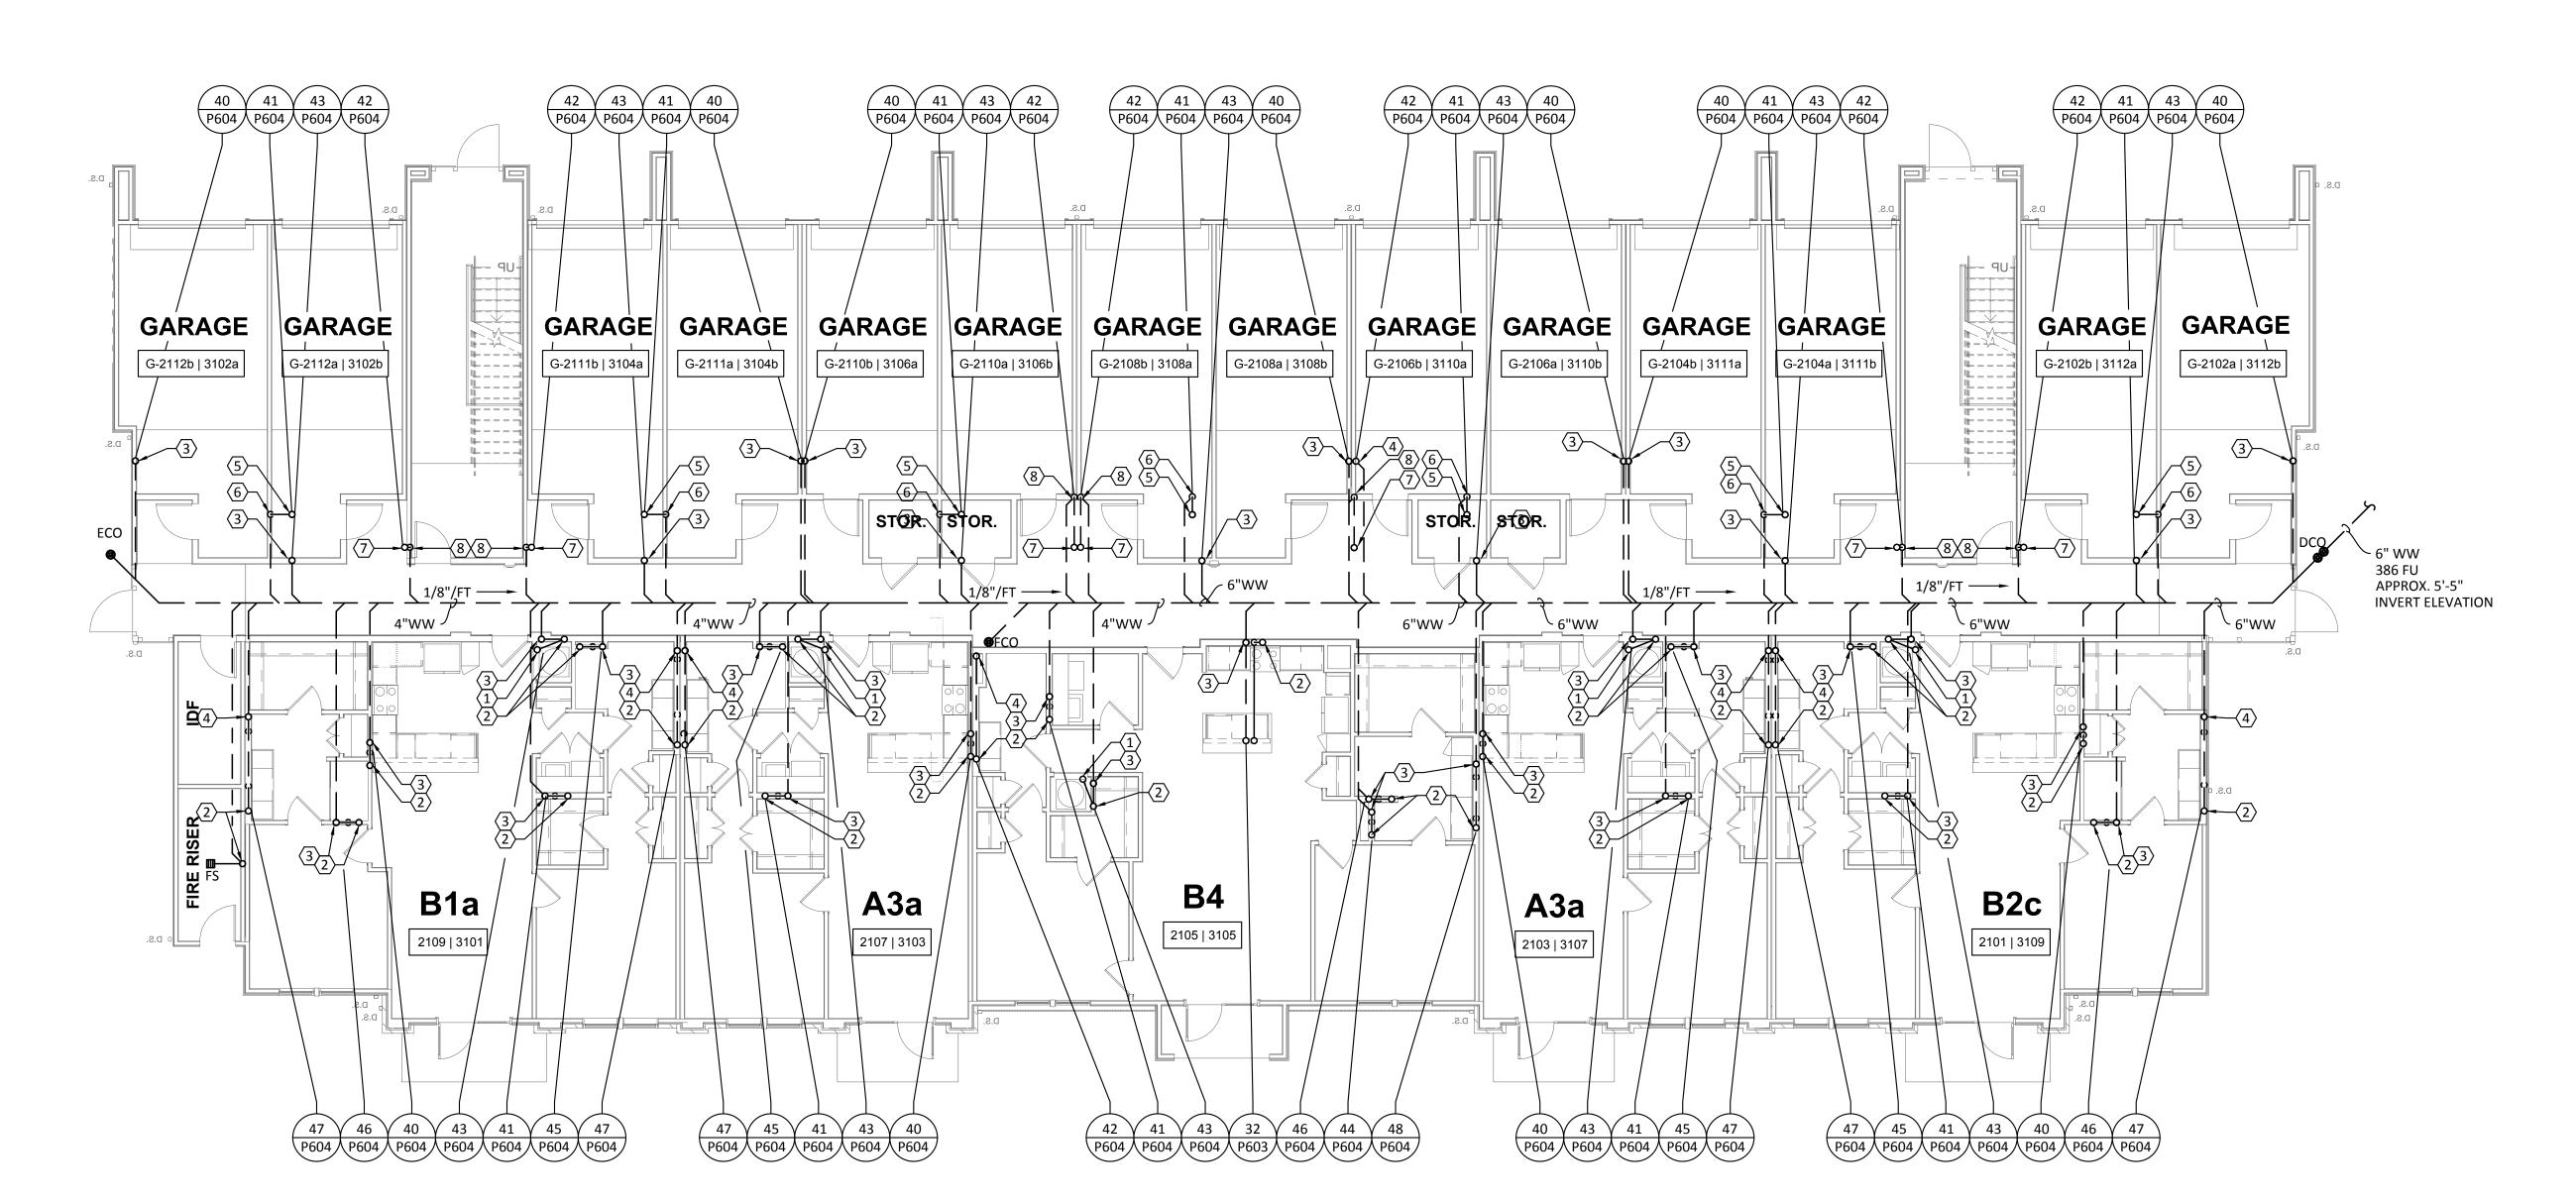

ENCOTECH ENGINEERING CONSULTANTS TBPE Firm 8500 Bluffstone Cove, Suite B-103 1141 Austin, Texas 78759 512.338.1101 Project No.: 18054.MS.AUS



REFER TO SHEET P000 FOR ADDITIONAL INFORMATION.

KEYED NOTES:

- 2" HUB DRAIN "HB-1" LOCATED IN FRONT OF MECHANICAL CLOSET FOR ACCESSIBILITY.
- 2" VENT UP TO FLOOR ABOVE.
- 2" WASTEWATER FROM FLOOR ABOVE TO BELOW SLAB.
- 4" WASTEWATER FROM FLOOR ABOVE TO BELOW SLAB.
- 2" WASTEWATER FROM FLOOR ABOVE.
- 2" WASTEWATER TO BELOW SLAB.
- 4" WASTEWATER FROM FLOOR ABOVE.
- 4" WASTEWATER TO BELOW SLAB.

DAVIES

Structural Engineer:

VIEWTECH INC. 4205 Beltway Dr. Addison, TX 75001 Victor Lisiak III 972.661.8187

MEP Engineer:

ENCOTECH 8500 Bluffstone Cove, Austin, TX. 78759 Tessa Roberts

Civil Engineer:

512.338.1101

MBC & Associates, Inc 1035 Central Pkwy N, San Antonio, TX 78732 David Allen 210.545.1122

Landscape Architect:

LEE & Associates, Inc. 9020 N Capital of Texas Hwy, Austin, TX. 78759 Amber Rothwell 512.345.8477

Interior Designer:

SJL Design Group 921 N. Riverfront Blvd. Suite 100, Dallas, TX 75207 Cassie Farley 214.443.9090

ISSUANCES

01	SCHEMATIC DESIGN	09.10.18
02	DEVELOPMENT DESIGN	11.09.18
03	PERMIT SET	01.28.19




a multifamily project for NRP Group

West Cevallos San Antonio, Texas

PLUMBING WASTEWATER BLDG II (#2 & #3) LEVEL 1


		,
F	Project Number	18054
	Pate	01/14/2018
	Orawn By	TLR
C	Checked By	EEC

P126

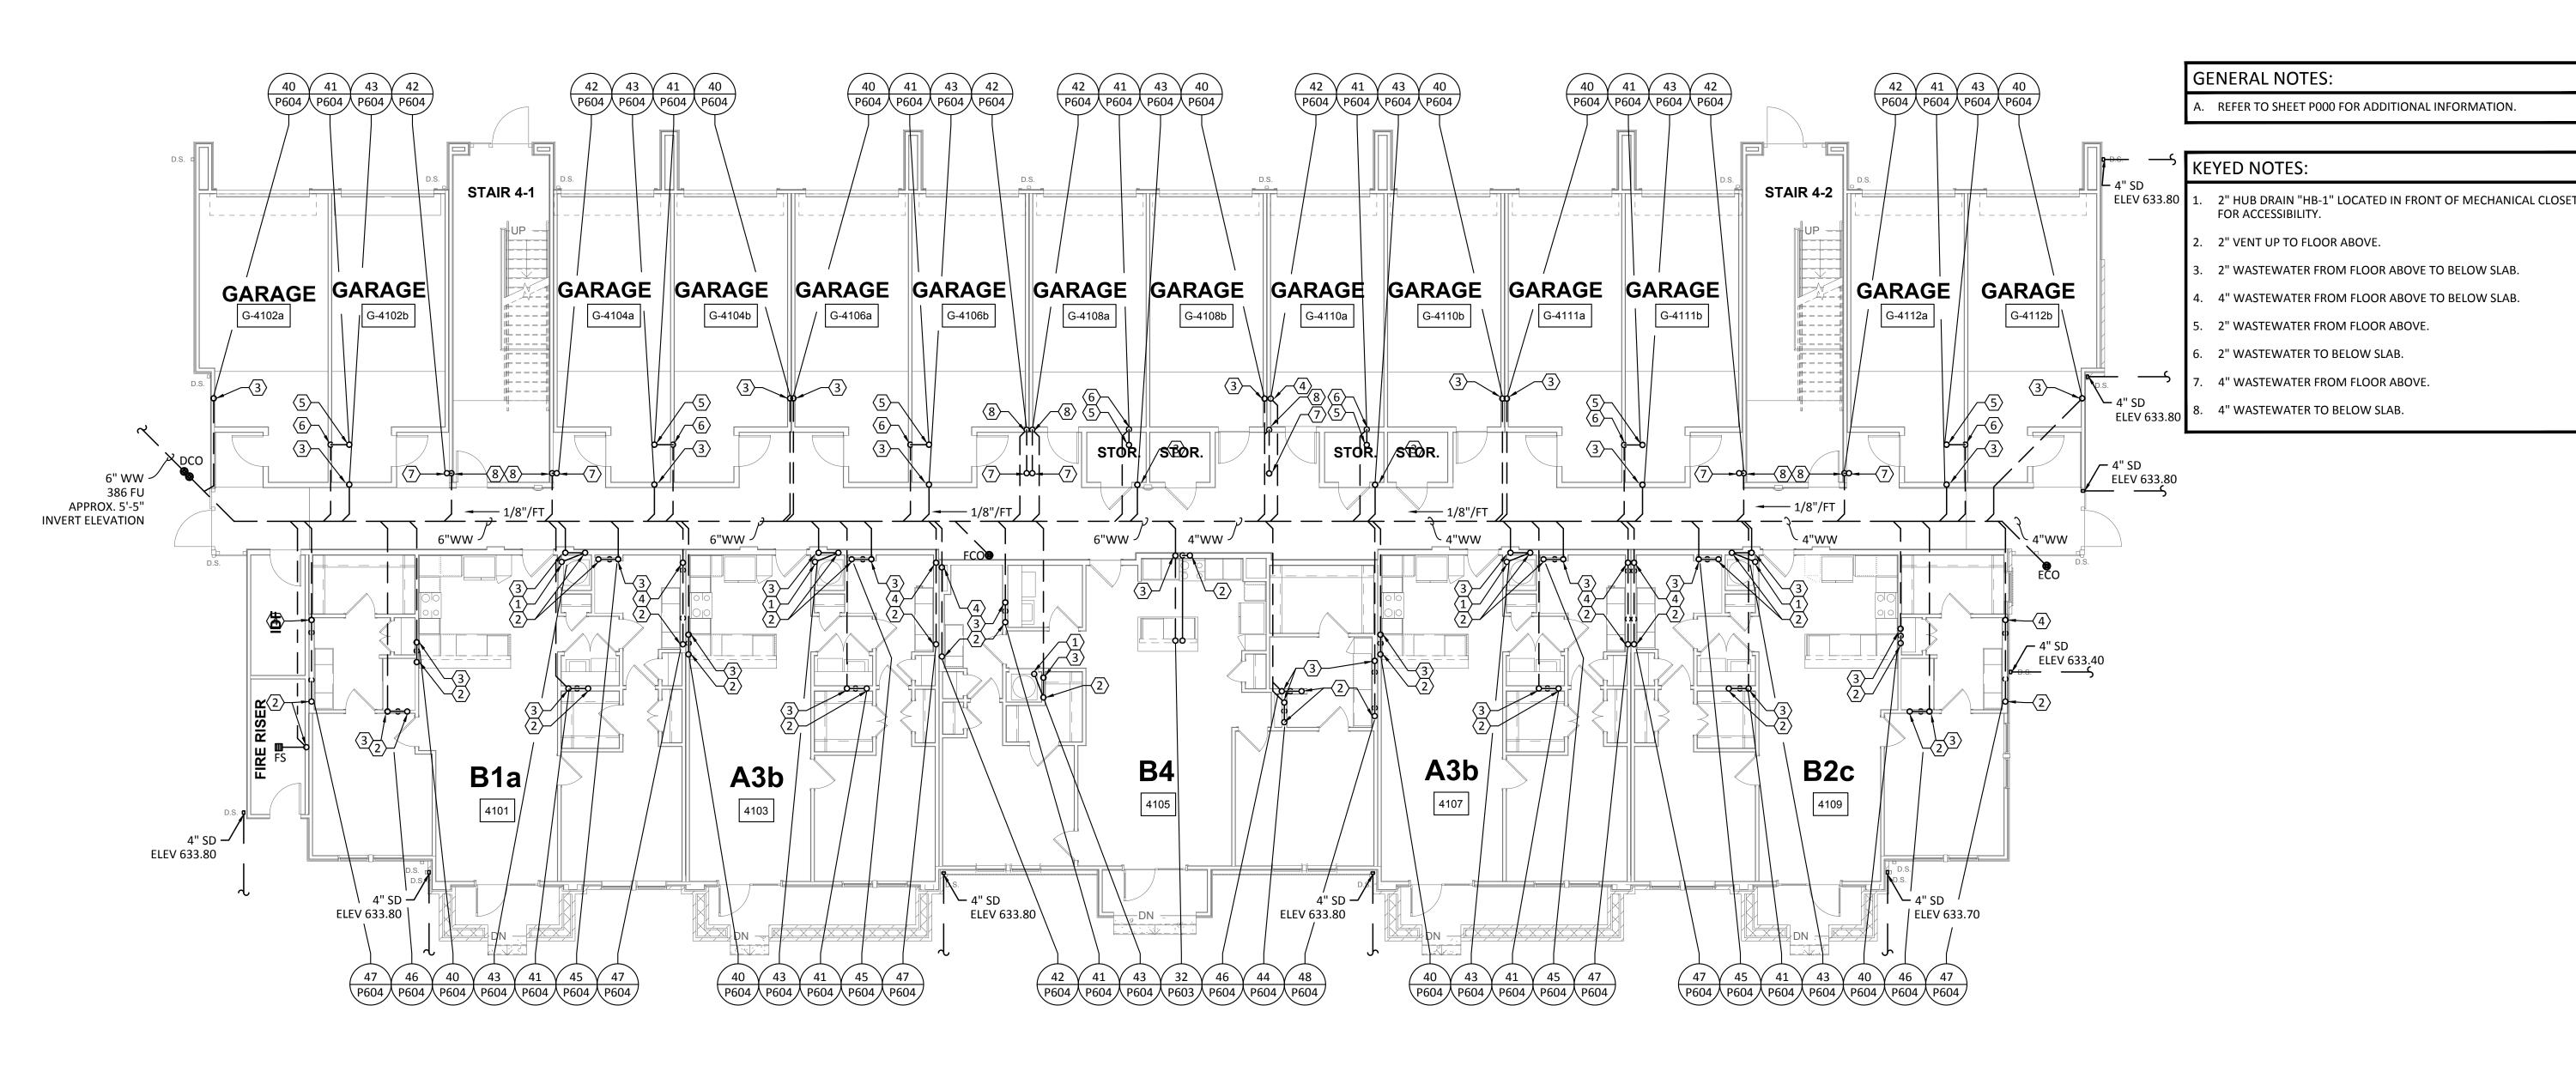

PLUMBING WASTEWATER - BUILDING II (#4) - LEVEL 1

SCALE: 1/8"=1'-0"

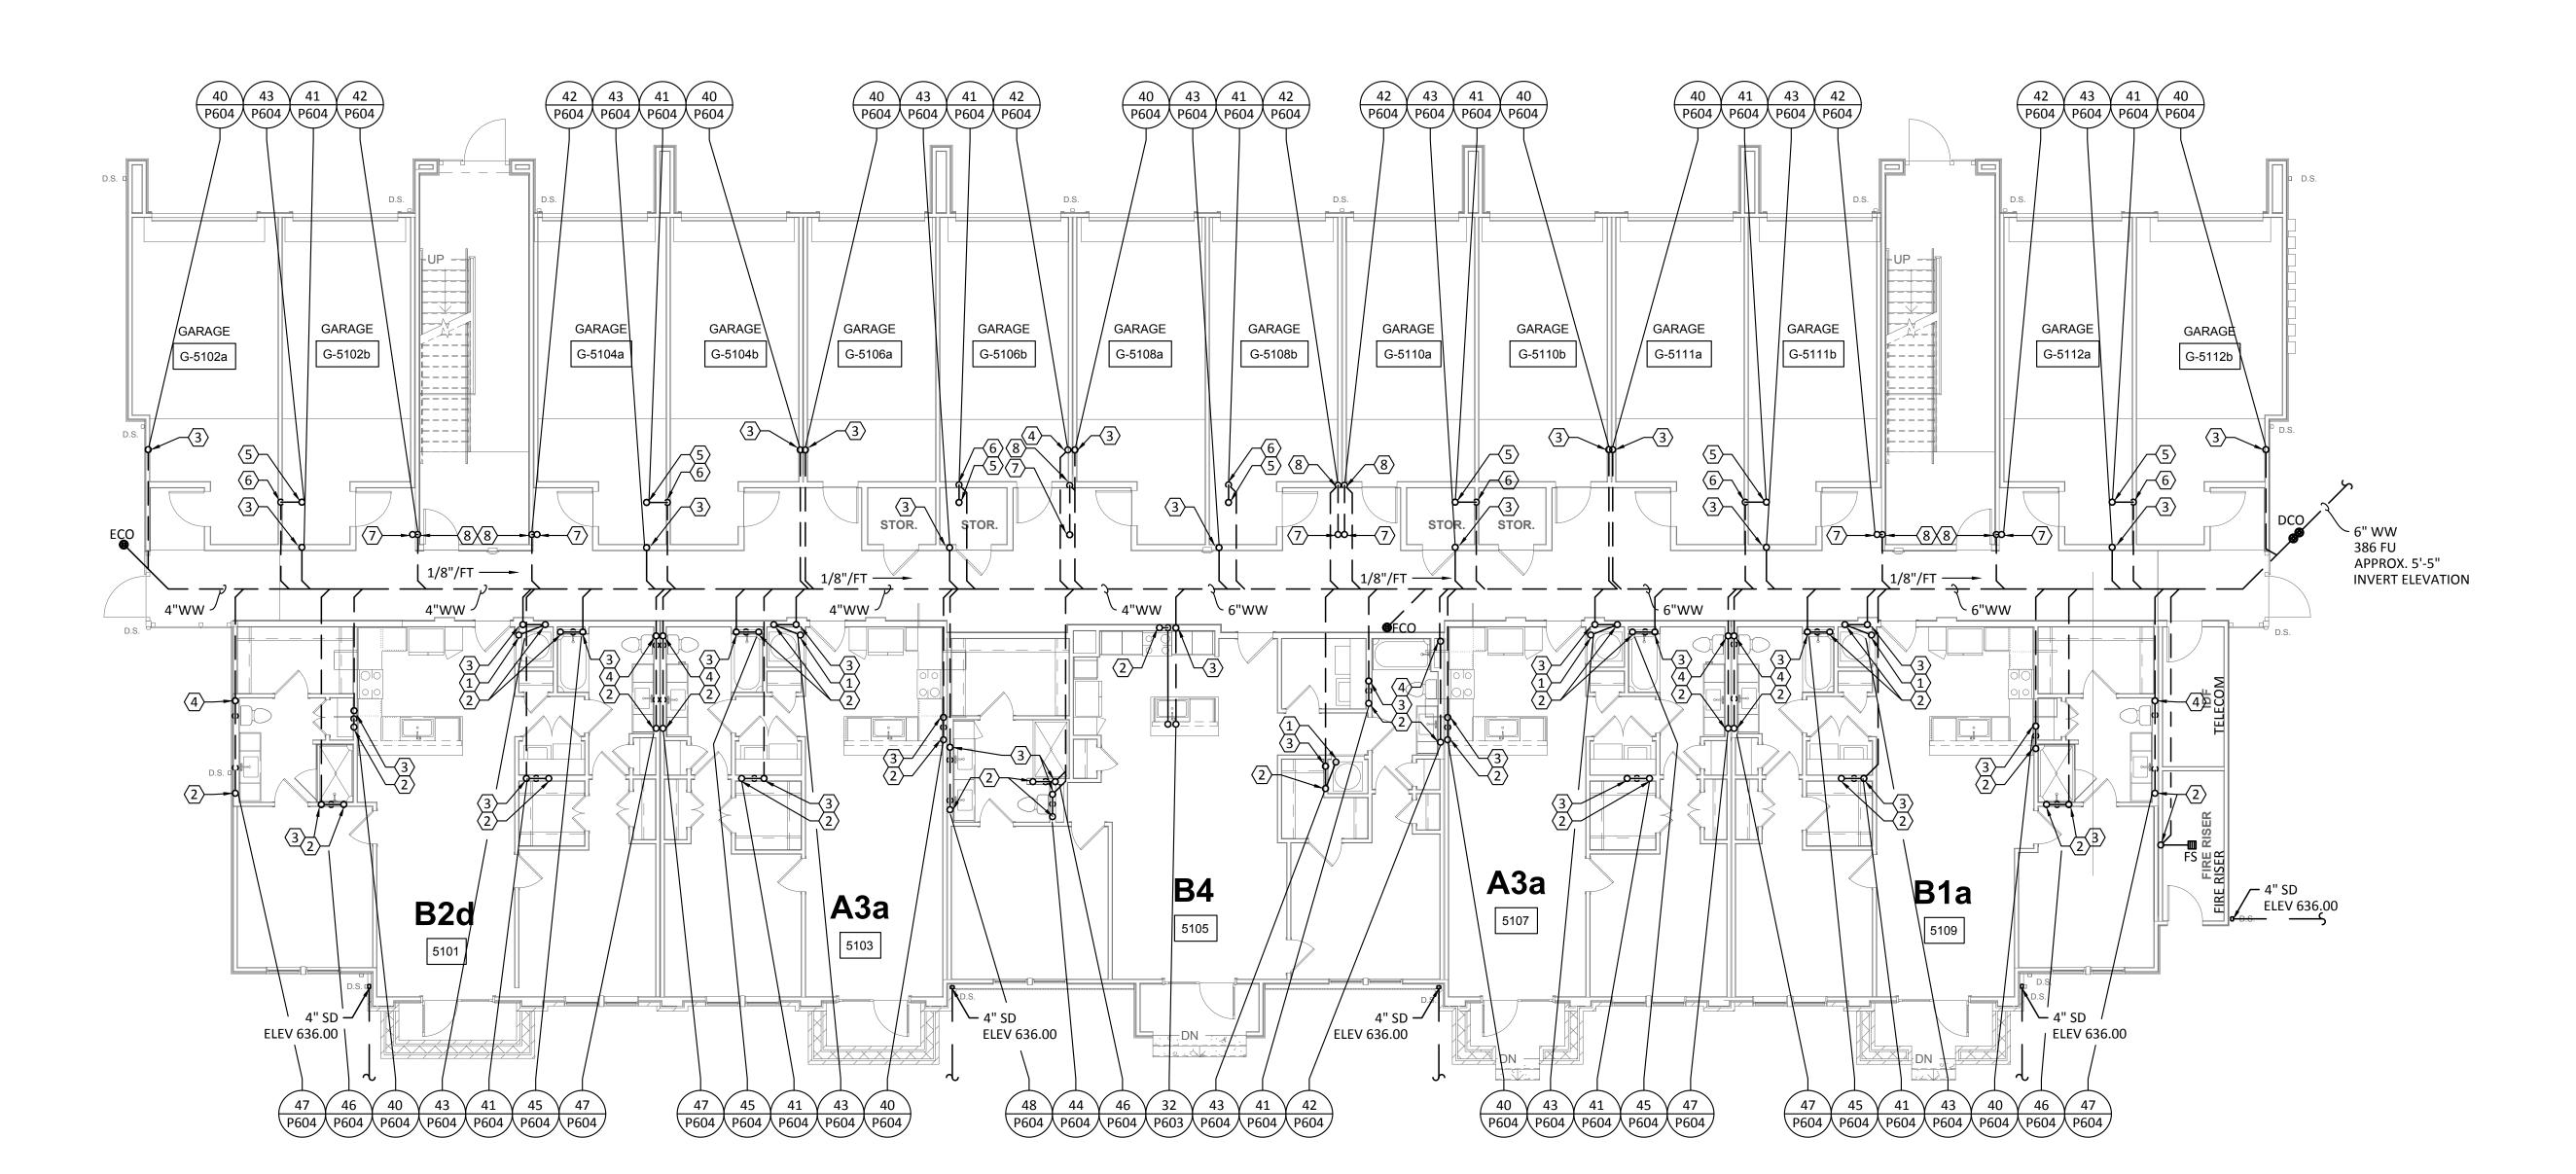





Structural Engineer:

VIEWTECH INC. 4205 Beltway Dr. Addison, TX 75001 Victor Lisiak III 972.661.8187

MEP Engineer:

ENCOTECH 8500 Bluffstone Cove, Austin, TX. 78759 Tessa Roberts

Civil Engineer:

512.338.1101

MBC & Associates, Inc 1035 Central Pkwy N, San Antonio, TX 78732 David Allen 210.545.1122

Landscape Architect:


LEE & Associates, Inc. 9020 N Capital of Texas Hwy, Austin, TX. 78759 Amber Rothwell 512.345.8477

Interior Designer:

SJL Design Group 921 N. Riverfront Blvd. Suite 100, Dallas, TX 75207 Cassie Farley 214.443.9090

ISSUANCES

ISSUANCES	ISSUANCES		
01	SCHEMATIC DESIGN	09.10.18	
02	DEVELOPMENT DESIGN	11.09.18	
03	PERMIT SET	01.28.19	

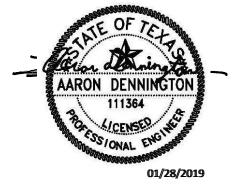


a multifamily project for NRP Group

West Cevallos San Antonio, Texas


PLUMBING WASTEWATER BLDG II (#4 & #5) LEVEL 1

18054 Project Number 01/14/2018 TLR Drawn By Checked By EEC

P127

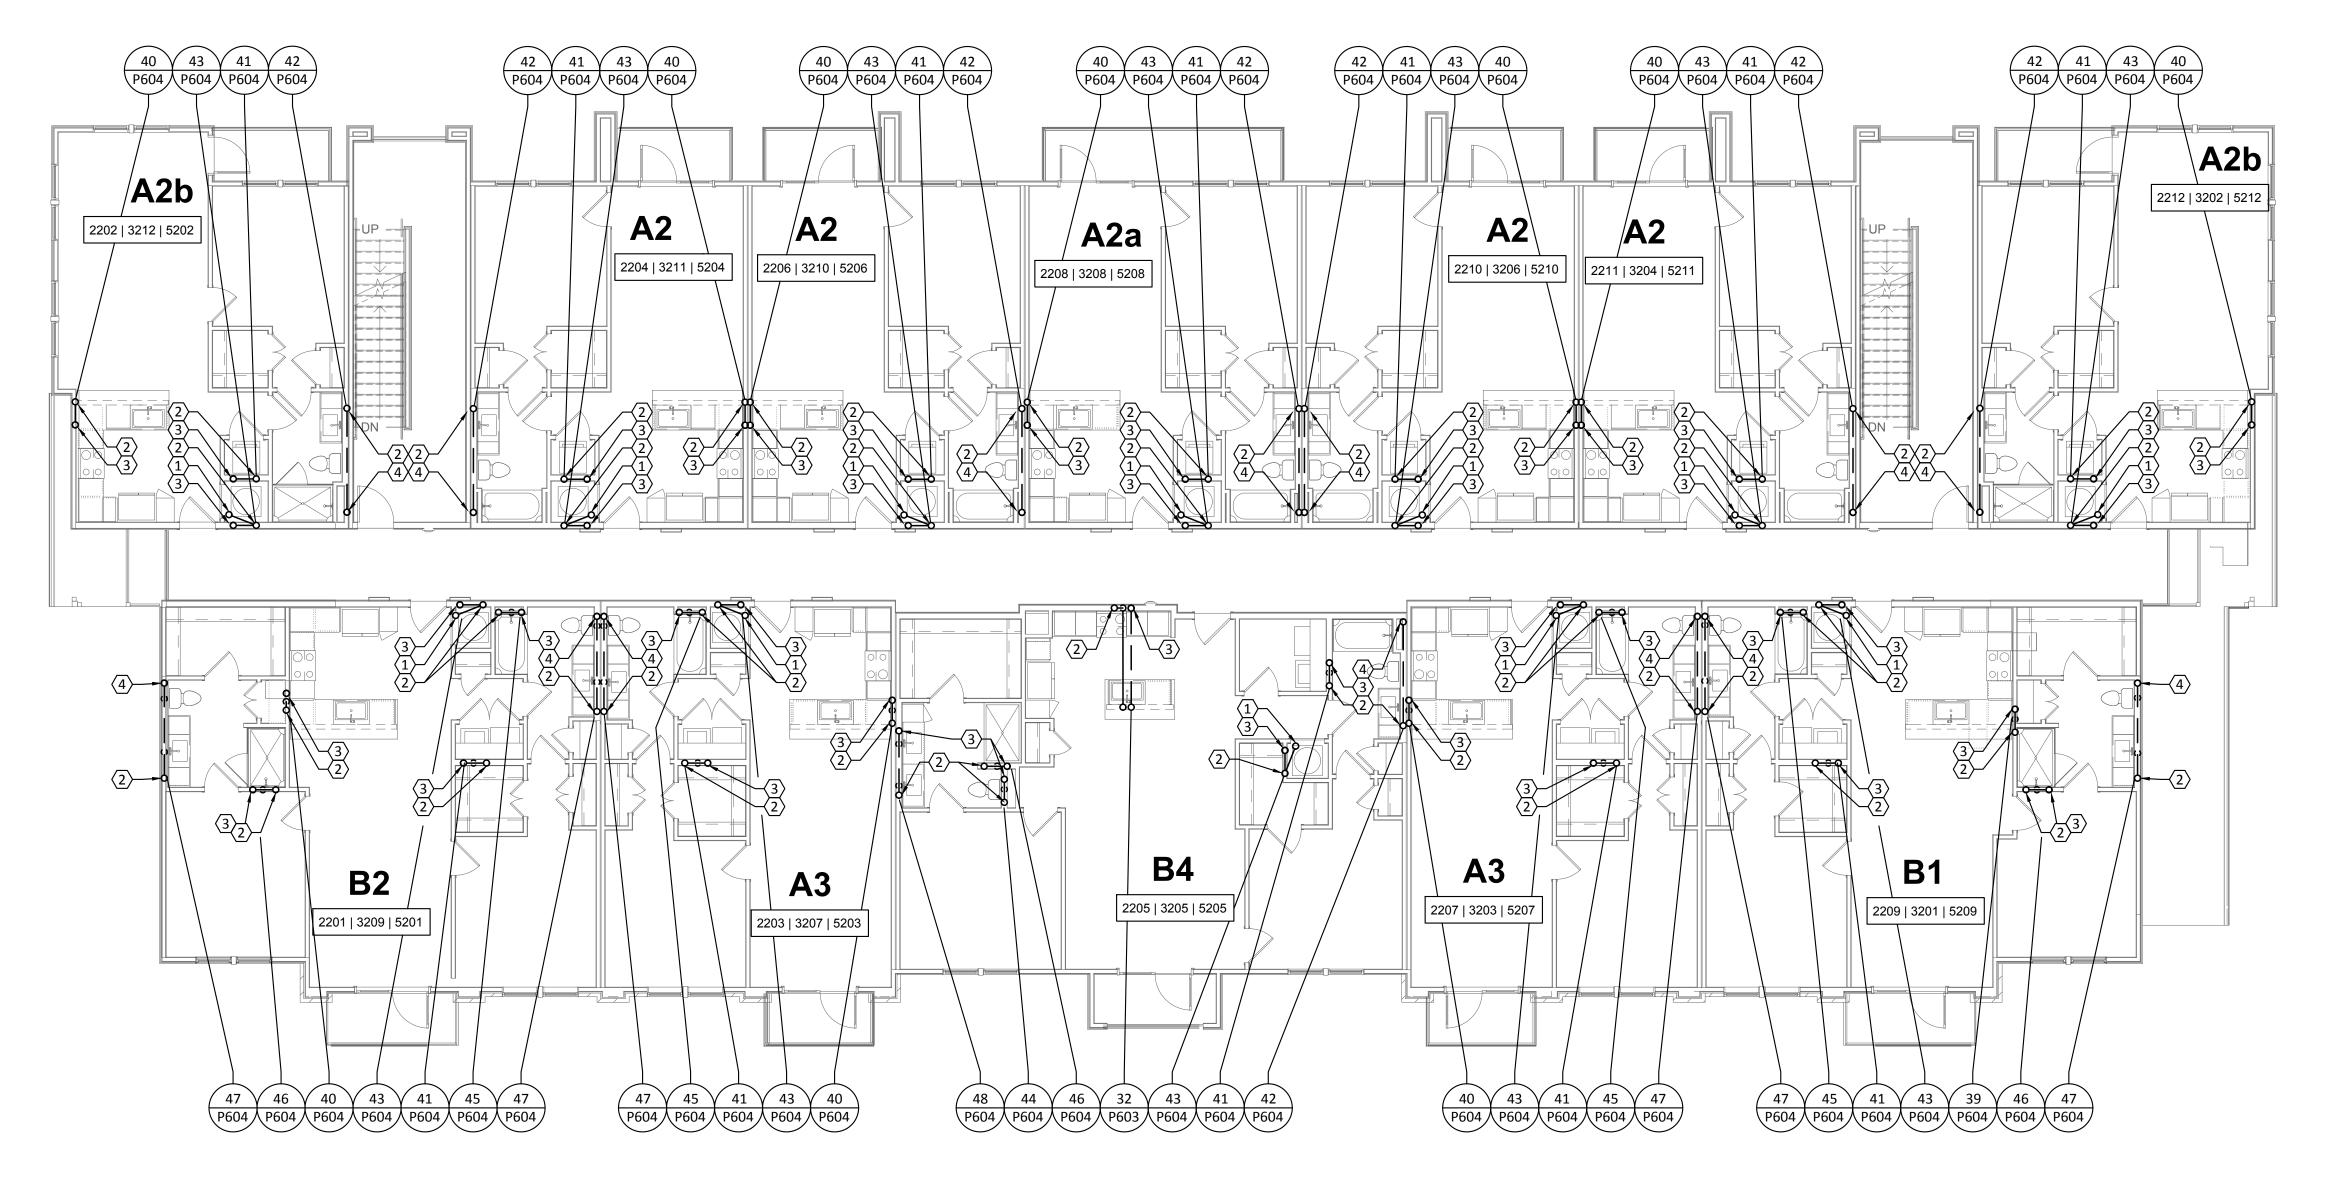

✓ PLUMBING WASTEWATER - BUILDING II (#2 & #5) - LEVEL 2

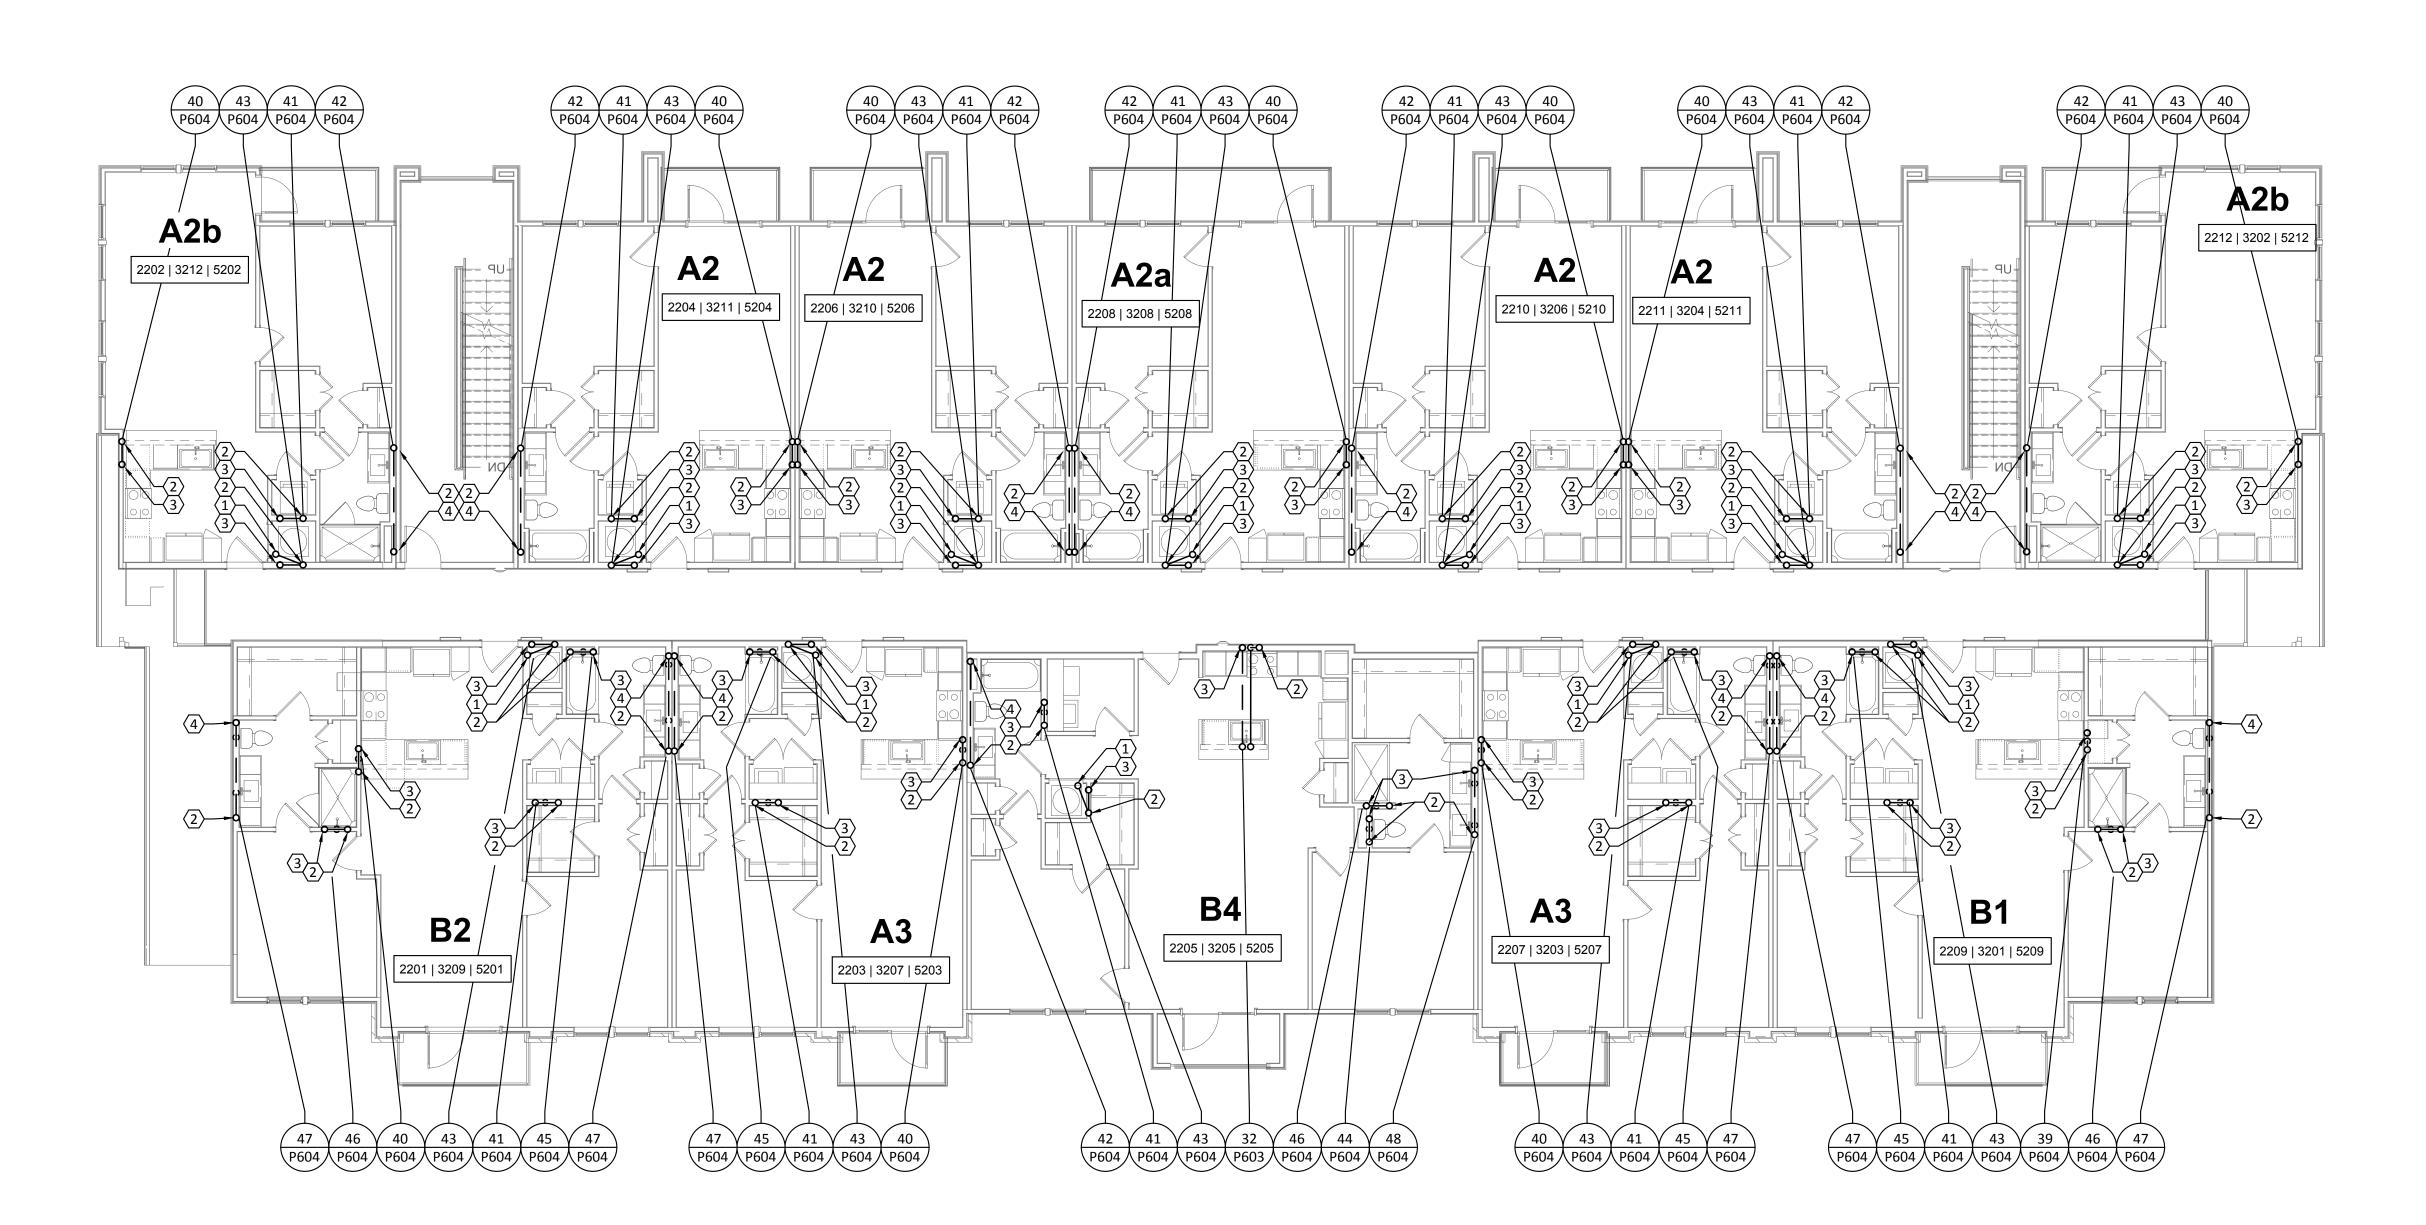

DAVIES 2" HUB DRAIN "HB-1" LOCATED IN FRONT OF MECHANICAL CLOSET

GENERAL NOTES:

KEYED NOTES:

FOR ACCESSIBILITY.

REFER TO SHEET P000 FOR ADDITIONAL INFORMATION.

2" VENT FROM FLOOR BELOW TO FLOOR ABOVE.

2" WASTEWATER FROM FLOOR ABOVE TO FLOOR BELOW.

4" WASTEWATER FROM FLOOR ABOVE TO FLOOR BELOW.

Structural Engineer:

VIEWTECH INC. 4205 Beltway Dr. Addison, TX 75001

Victor Lisiak III 972.661.8187

MEP Engineer:

ENCOTECH 8500 Bluffstone Cove, Austin, TX. 78759 Tessa Roberts 512.338.1101

Civil Engineer:

MBC & Associates, Inc 1035 Central Pkwy N, San Antonio, TX 78732 David Allen 210.545.1122


Landscape Architect:

LEE & Associates, Inc. 9020 N Capital of Texas Hwy, Austin, TX. 78759 Amber Rothwell 512.345.8477

Interior Designer:

SJL Design Group 921 N. Riverfront Blvd. Suite 100, Dallas, TX 75207 Cassie Farley 214.443.9090

	ISSUANCES		
	01	SCHEMATIC DESIGN	09.10.18
	02	DEVELOPMENT DESIGN	11.09.18
	03	PERMIT SET	01.28.19

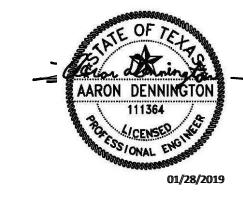

a multifamily project for NRP Group

West Cevallos San Antonio, Texas

PLUMBING WASTEWATER BLDG II (#2, #3 & #5) LEVEL 2

Project Number 01/14/2018 TLR Drawn By Checked By EEC

P128

ENGINEERING CONSULTANTS TBPE Firm 8500 Bluffstone Cove, Suite B-103 1141 Austin, Texas 78759 512.338.1101 Project No.: 18054.MS.AUS

REFER TO SHEET P000 FOR ADDITIONAL INFORMATION.

KEYED NOTES:

- 2" HUB DRAIN "HB-1" LOCATED IN FRONT OF MECHANICAL CLOSET FOR ACCESSIBILITY.
- 2" VENT FROM FLOOR BELOW TO FLOOR ABOVE.
- 2" WASTEWATER FROM FLOOR ABOVE TO FLOOR BELOW.
- 4. 4" WASTEWATER FROM FLOOR ABOVE TO FLOOR BELOW.



Structural Engineer:

VIEWTECH INC. 4205 Beltway Dr. Addison, TX 75001 Victor Lisiak III 972.661.8187

MEP Engineer:

ENCOTECH 8500 Bluffstone Cove, Austin, TX. 78759 Tessa Roberts 512.338.1101

Civil Engineer:

MBC & Associates, Inc 1035 Central Pkwy N, San Antonio, TX 78732 David Allen 210.545.1122

Landscape Architect:

LEE & Associates, Inc. 9020 N Capital of Texas Hwy, Austin, TX. 78759 Amber Rothwell 512.345.8477

Interior Designer:

SJL Design Group 921 N. Riverfront Blvd. Suite 100, Dallas, TX 75207 Cassie Farley 214.443.9090

ISSUANCES		
01	SCHEMATIC DESIGN	09.10.18
02	DEVELOPMENT DESIGN	11.09.18
03	PERMIT SET	01.28.19

REVISIONS



a multifamily project for NRP Group

West Cevallos
San Antonio, Texas

PLUMBING WASTEWATER BLDG II (#4) LEVEL 2


Project Number 18054

Date 01/14/2018

Drawn By TLR

Checked By EEC


P129

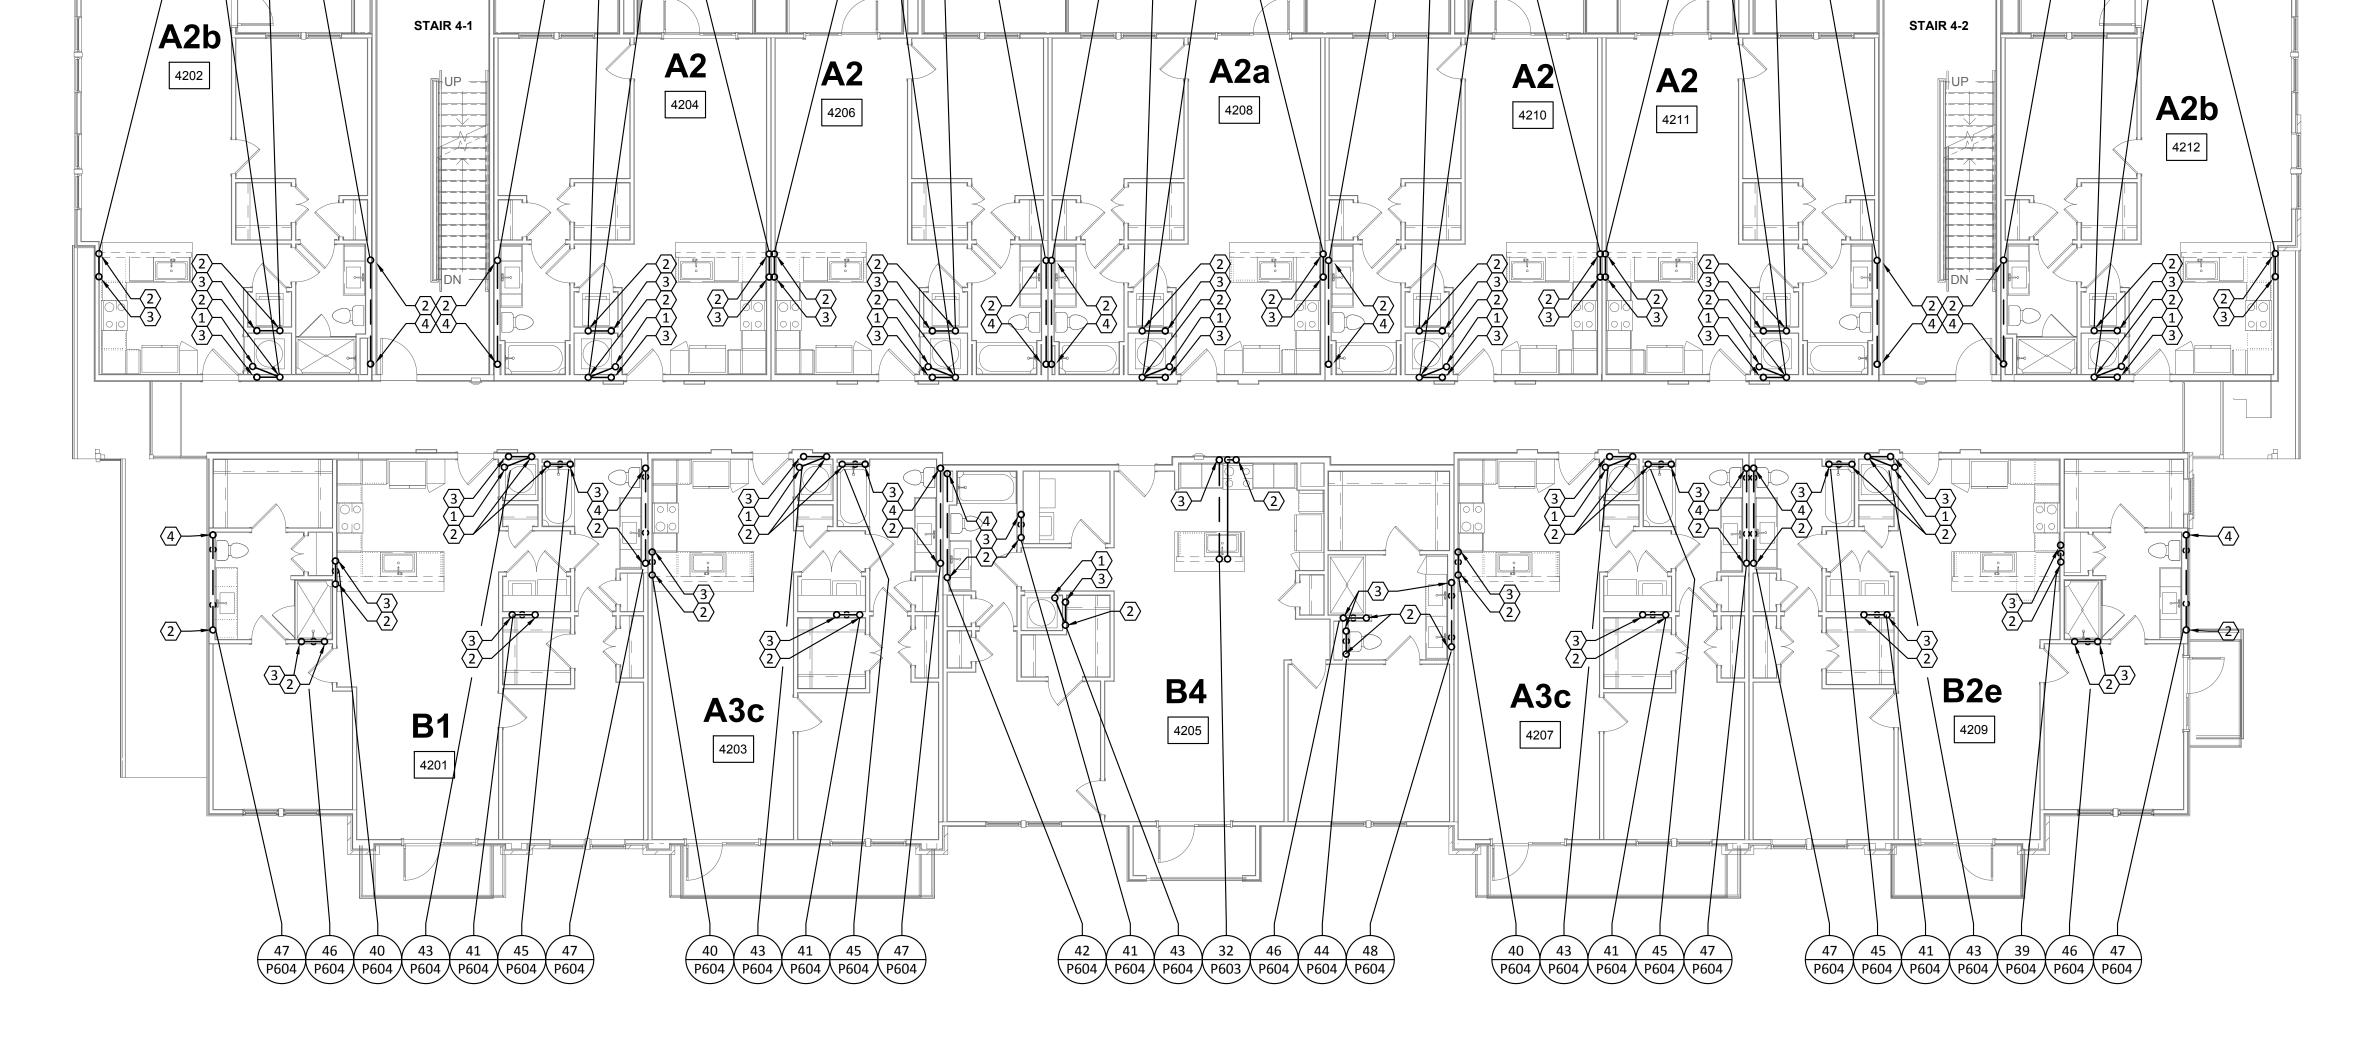

PLUMBING WASTEWATER - BUILDING II (#4) - LEVEL 2


SCALE: 1/8"=1



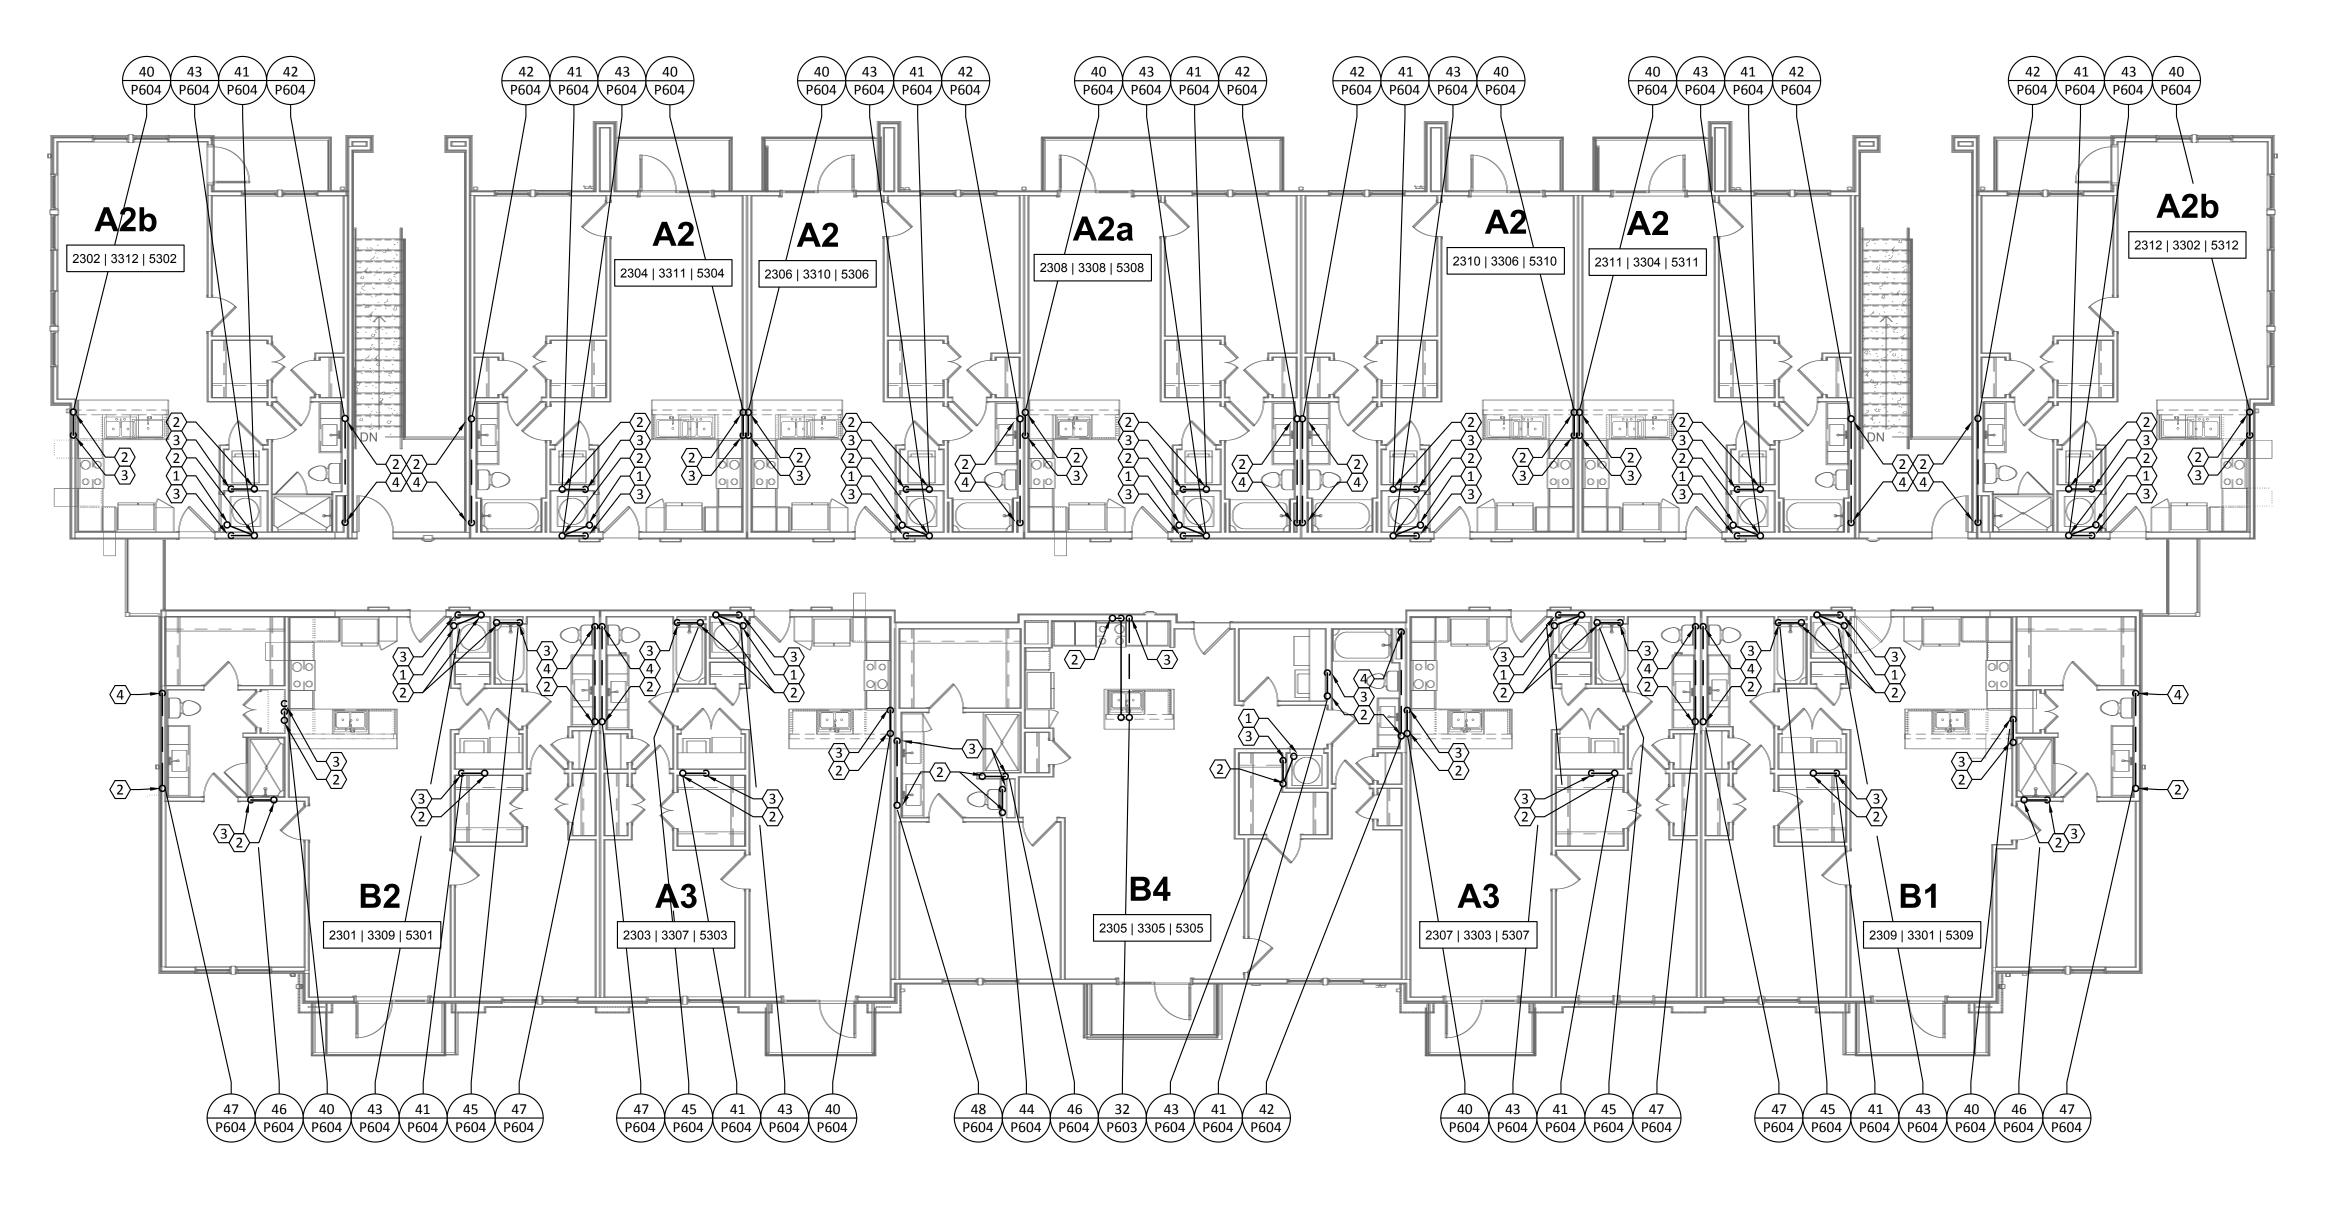

PLUMBING WASTEWATER - BUILDING II (#2 & #5) - LEVEL 3

SCALE: 1/8"=1'-0"

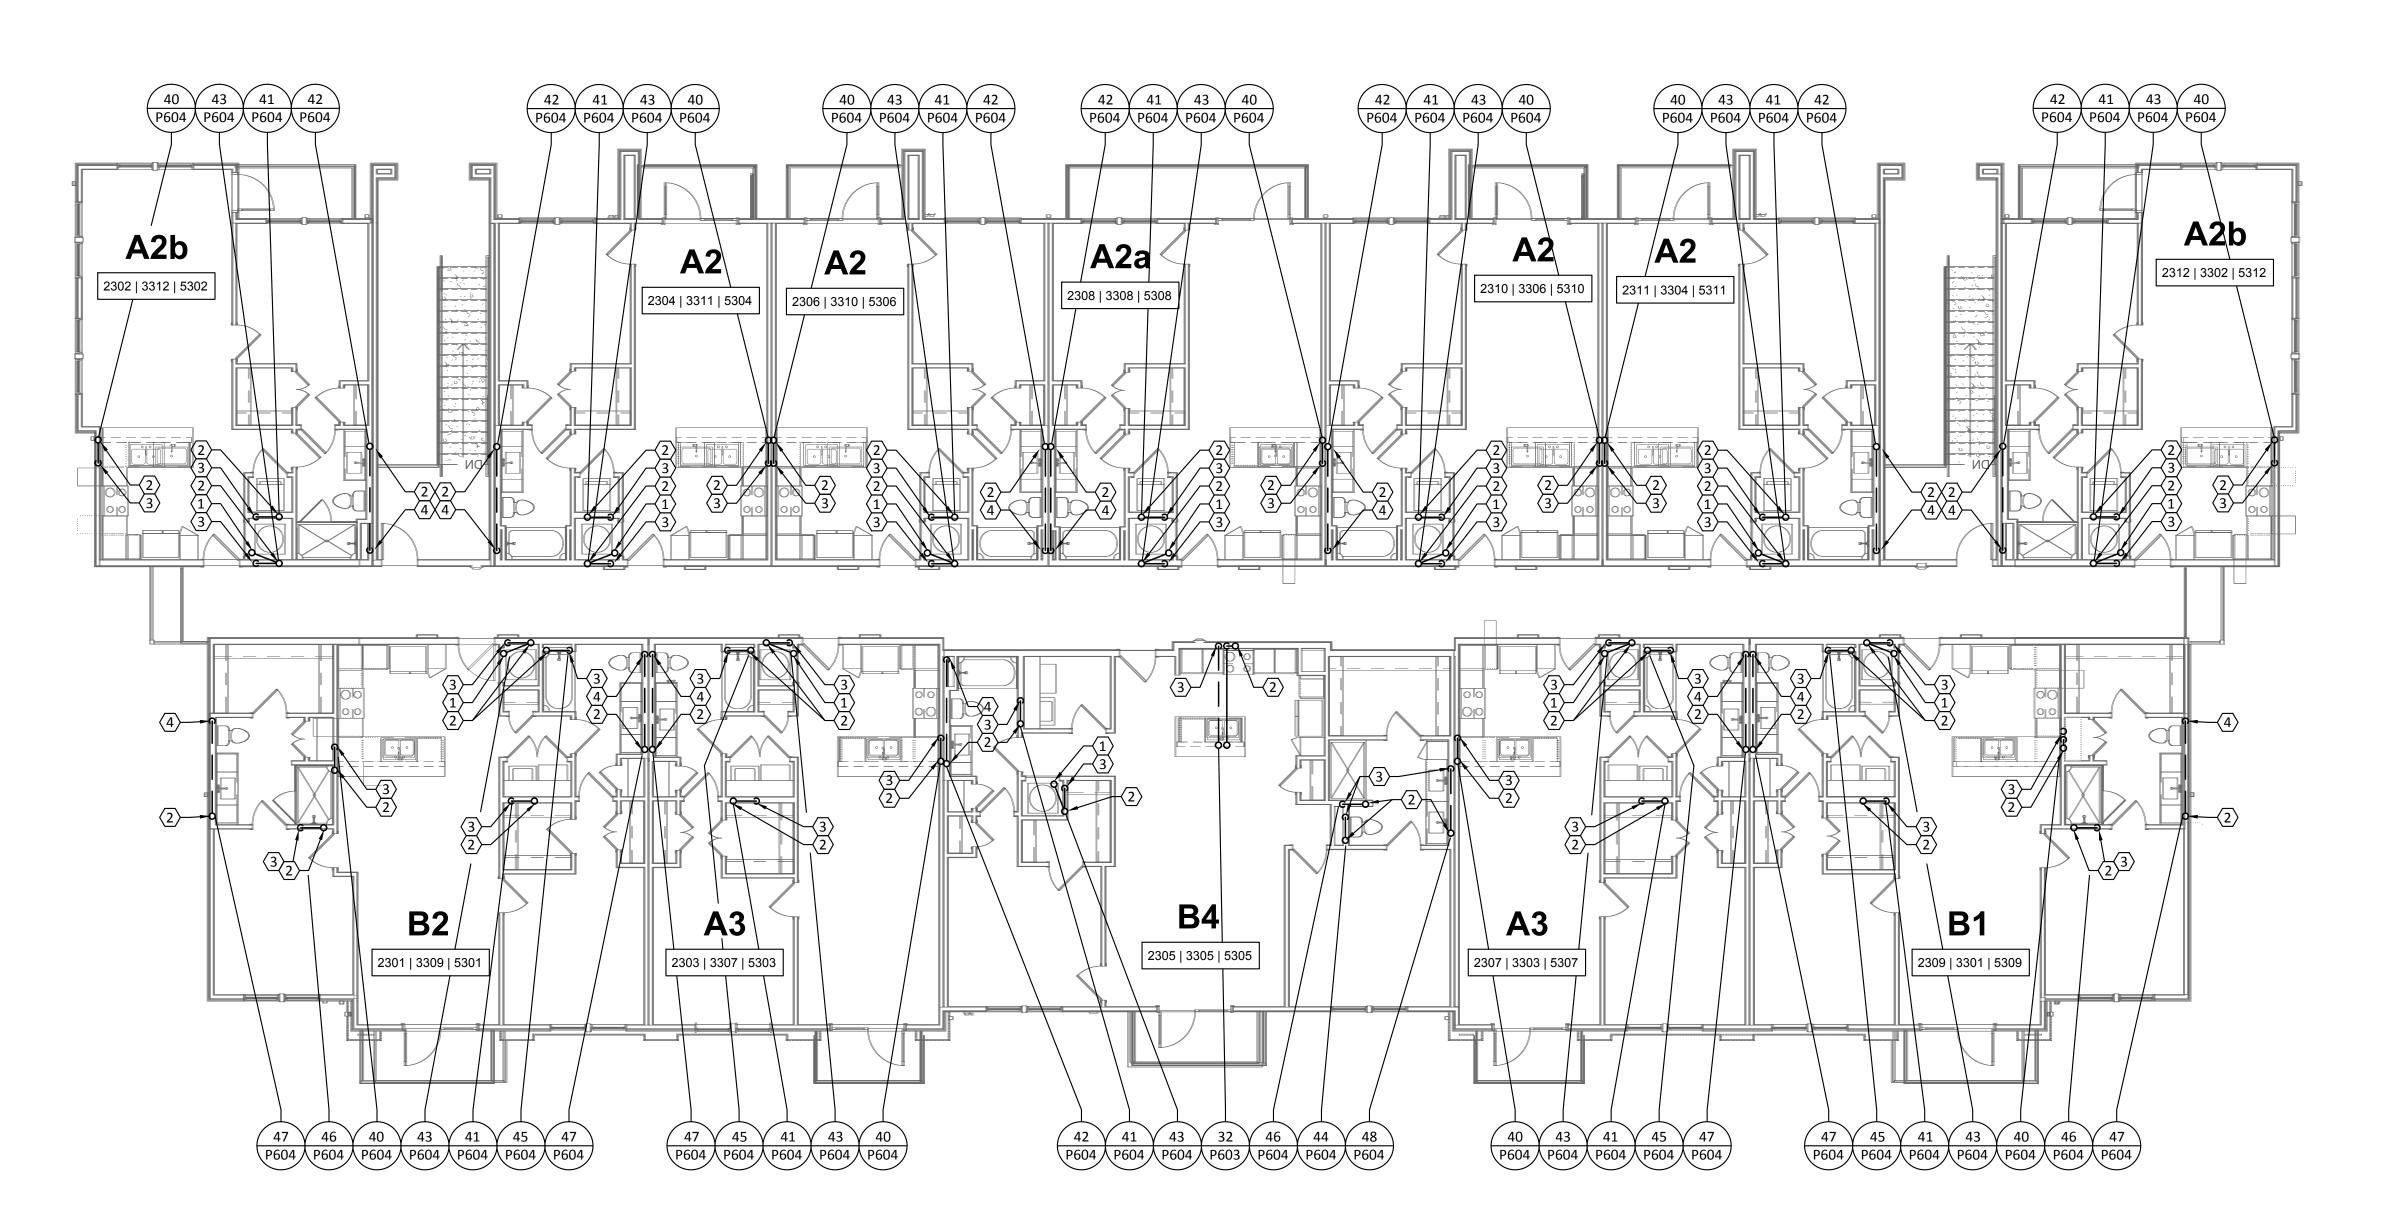

ENCOTECH ENGINEERING CONSULTANTS TBPE Firm 8500 Bluffstone Cove, Suite B-103 1141 Austin, Texas 78759 512.338.1101

Project No.: 18054.MS.AUS

GENERAL NOTES:

A. REFER TO SHEET P000 FOR ADDITIONAL INFORMATION.

KEYED NOTES:

2" HUB DRAIN "HB-1" LOCATED IN FRONT OF MECHANICAL CLOSET FOR ACCESSIBILITY.

- 2. 2" VENT UP THRU ROOF.
- 2" WASTEWATER TO FLOOR BELOW.
- 4. 4" WASTEWATER TO FLOOR BELOW.

DAVIES COLLABORATIVE

Structural Engineer:

VIEWTECH INC. 4205 Beltway Dr. Addison, TX 75001 Victor Lisiak III

MEP Engineer:

972.661.8187

ENCOTECH

8500 Bluffstone Cove, Austin, TX. 78759 Tessa Roberts 512.338.1101

Civil Engineer:

MBC & Associates, Inc 1035 Central Pkwy N, San Antonio, TX 78732 David Allen 210.545.1122

Landscape Architect:


LEE & Associates, Inc. 9020 N Capital of Texas Hwy, Austin, TX. 78759 Amber Rothwell 512.345.8477

Interior Designer:

SJL Design Group 921 N. Riverfront Blvd. Suite 100, Dallas, TX 75207 Cassie Farley 214.443.9090

ISSUANCES

01	SCHEMATIC DESIGN	09.10.18
02	DEVELOPMENT DESIGN	11.09.18
03	PERMIT SET	01.28.19

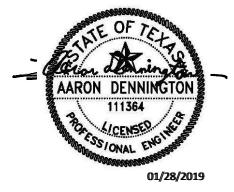


a multifamily project for NRP Group

West Cevallos San Antonio, Texas

PLUMBING WASTEWATER BLDG II (#2, #3 & #5) LEVEL 3

Project Number	18054
Date	01/14/2018
Drawn By	TLR
Checked By	EEC

P130

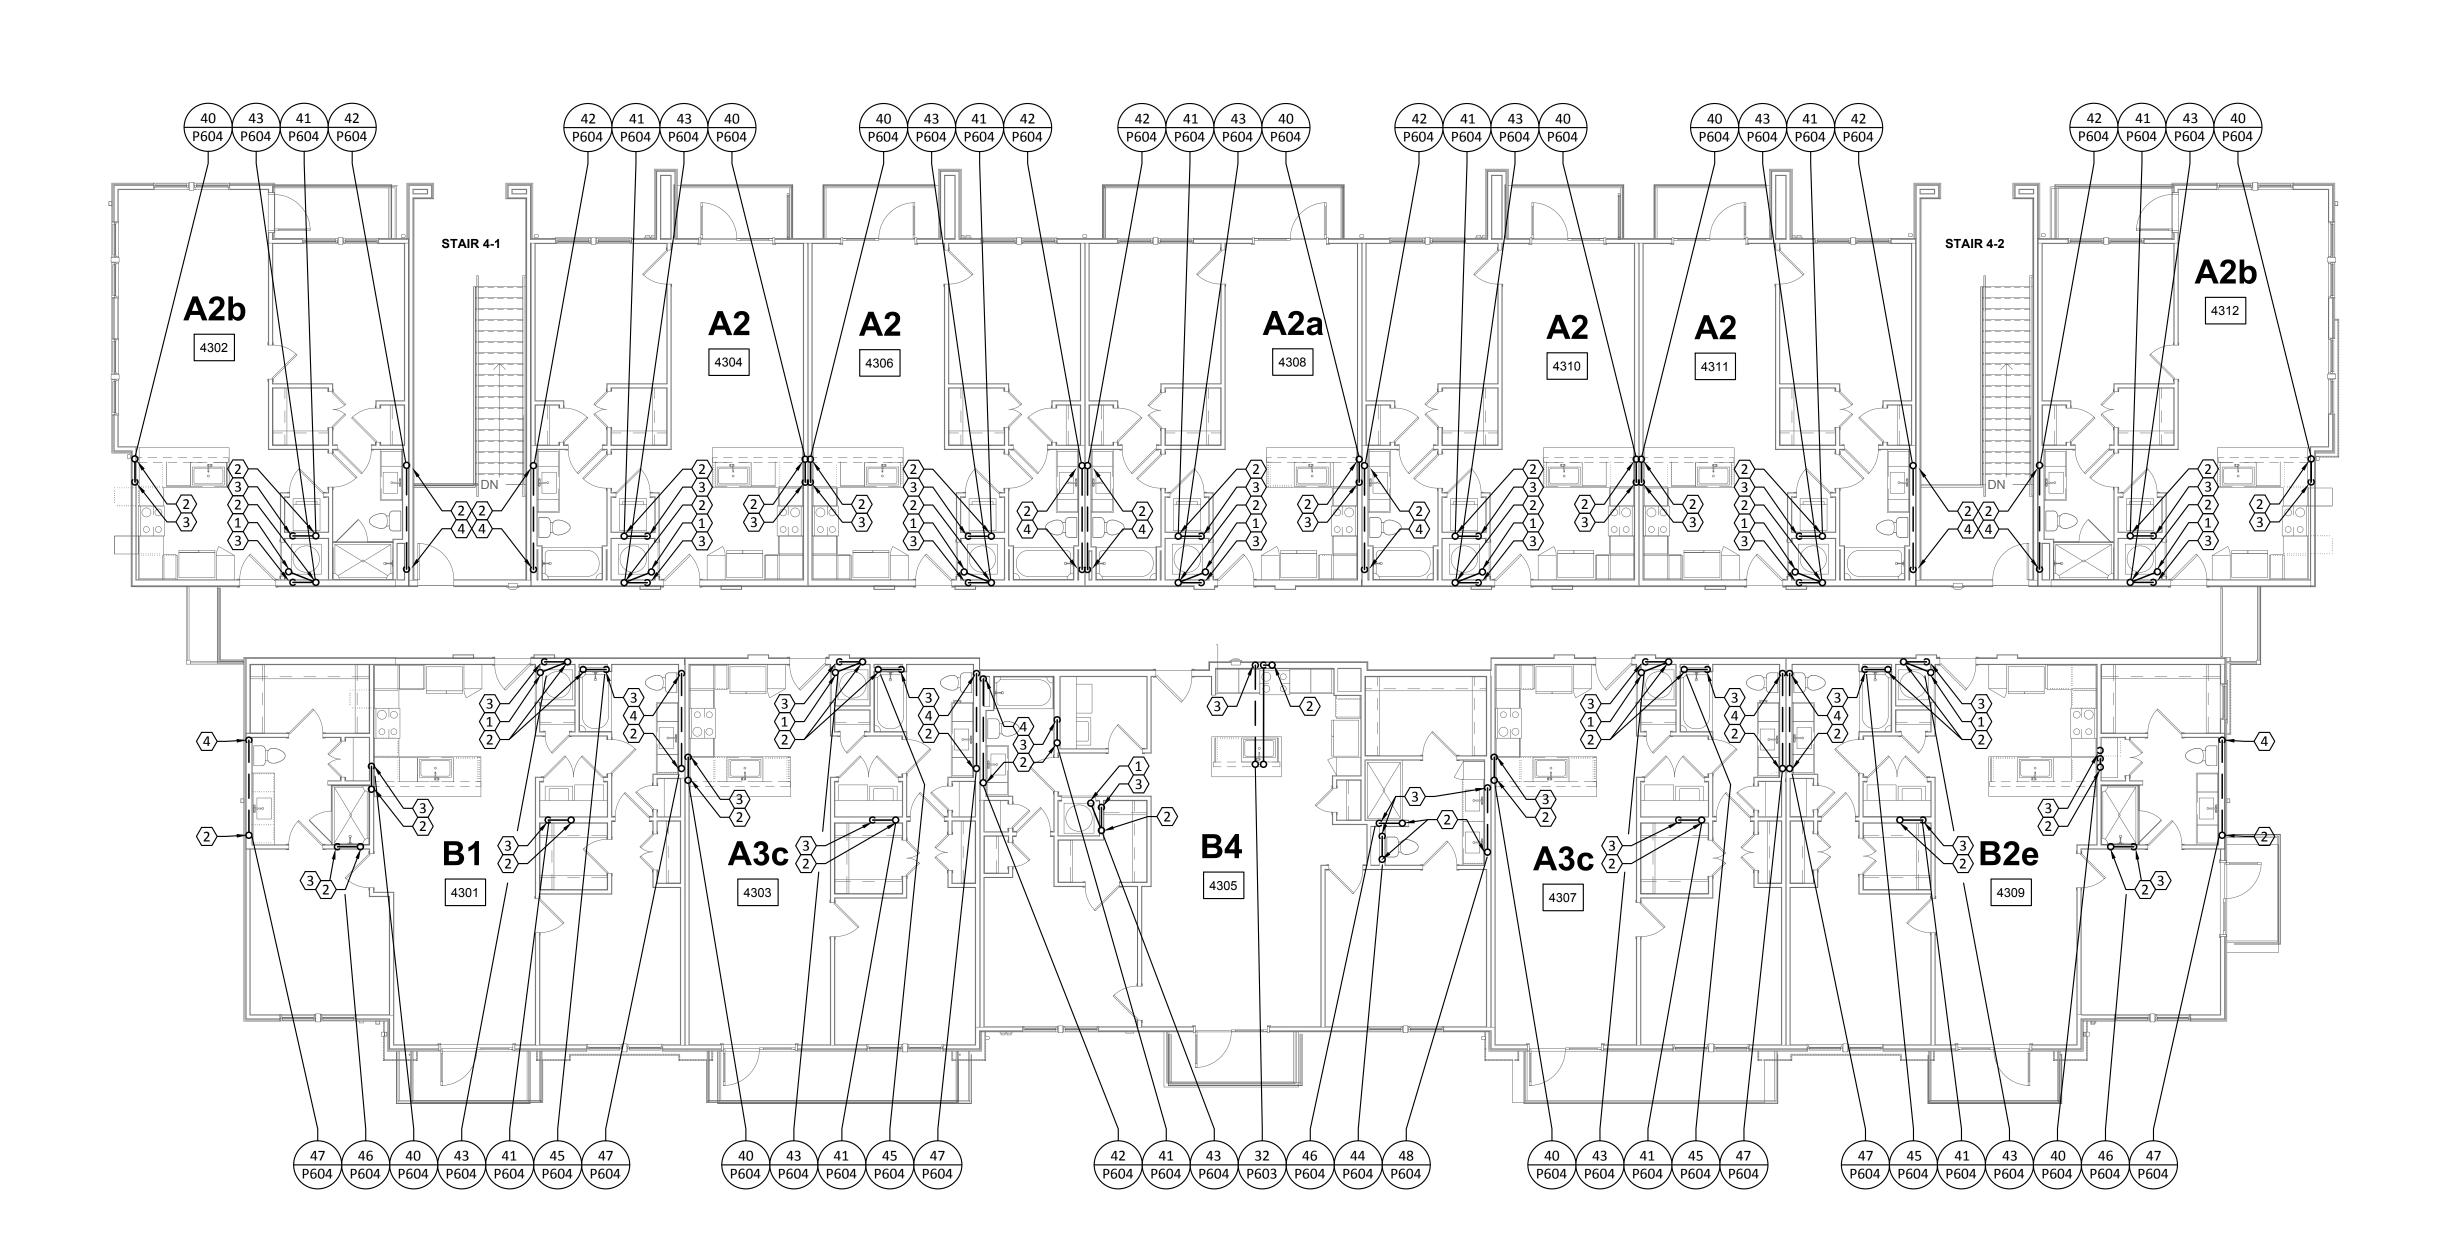

PLUMBING WASTEWATER - BUILDING II (#4) - LEVEL 3

SCALE: 1/8"=1'-0"



GENERAL NOTES:

A. REFER TO SHEET P000 FOR ADDITIONAL INFORMATION.

KEYED NOTES:

2" HUB DRAIN "HB-1" LOCATED IN FRONT OF MECHANICAL CLOSET FOR ACCESSIBILITY.

- 2. 2" VENT UP THRU ROOF.
- Z VENT OF THINO ROOF.
- . 2" WASTEWATER TO FLOOR BELOW.
- 4. 4" WASTEWATER TO FLOOR BELOW.



Structural Engineer:

VIEWTECH INC. 4205 Beltway Dr. Addison, TX 75001 Victor Lisiak III 972.661.8187

MEP Engineer:

ENCOTECH 8500 Bluffstone Cove, Austin, TX. 78759 Tessa Roberts

Civil Engineer:

210.545.1122

512.338.1101

MBC & Associates, Inc 1035 Central Pkwy N, San Antonio, TX 78732 David Allen

Landscape Architect:


LEE & Associates, Inc. 9020 N Capital of Texas Hwy, Austin, TX. 78759 Amber Rothwell 512.345.8477

Interior Designer:

SJL Design Group 921 N. Riverfront Blvd. Suite 100, Dallas, TX 75207 Cassie Farley 214.443.9090

ISSUANCES		
01	SCHEMATIC DESIGN	09.10.18
02	DEVELOPMENT DESIGN	11.09.18
03	PERMIT SET	01.28.19

REVISION

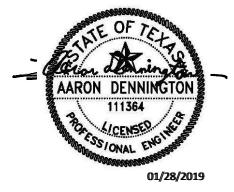

a multifamily project for NRP Group

West Cevallos
San Antonio, Texas

PLUMBING WASTEWATER BLDG II (#4) LEVEL 3

·· (<i>·</i> · ·) —— · —— ·	
Project Number	18054
Date	01/14/2018
Drawn By	TLR
Checked By	EEC


P131

- A. REFER TO SHEET P000 FOR GENERAL NOTES, LEGENDS, & ABBREVIATIONS.
- 3. ALL DOMESTIC WATER PIPING SHALL BE INSTALLED ABOVE CONDITIONED SPACE.
 ANY PIPING OUTSIDE THE CONDITIONED ENVELOPE SHALL BE INSULATED PER CODE.
- C. DO NOT ROUTE PIPING OVER ELECTRICAL PANELS.
- D. REFER TO WATER HEATER DETAILS FOR PIPING ROUTE, VALVES, AND ACCESSORIES.
- ALL VALVES MUST BE ACCESSIBLE.
- INSULATE ANY WATER PIPING LOCATED IN EXTERIOR OR CORRIDOR WALLS.
- PLUMBING CONTRACTOR SHALL REFER TO SITE PLAN FOR EXACT ORIENTATION OF BUILDING AND LOCATION OF SPRINKLER CLOSET AND TELECOM ROOM.

KEYED NOTES:

- DOMESTIC WATER RISER TO FLOOR ABOVE. REFER TO ENLARGED UNIT PLANS FOR DWELLING UNIT PIPE DISTRIBUTION. REFER TO RISER DIAGRAM FOR VERTICAL PIPE SIZES.
- DOMESTIC WATER RISER TO DWELLING UNITS ABOVE. REFER TO UPPER FLOORS FOR CONTINUATION. REFER TO ENLARGED UNIT PLANS FOR DWELLING UNIT PIPE DISTRIBUTION. REFER TO RISER DIAGRAM FOR VERTICAL PIPE SIZES.
- 3. DOMESTIC WATER PIPE DROPPED DOWN TO COMMUNITY CENTER SINK & DISHWASHER.
- . DOMESTIC WATER PIPE DOWN TO RESTROOM GROUP.
- 5. PROVIDE 1/2" DOMESTIC COLD WATER LINE TO DOG WASH.
- 1" DOMESTIC COLD WATER LINE DOWN TO POOL EQUIPMENT ROOM AT 48"



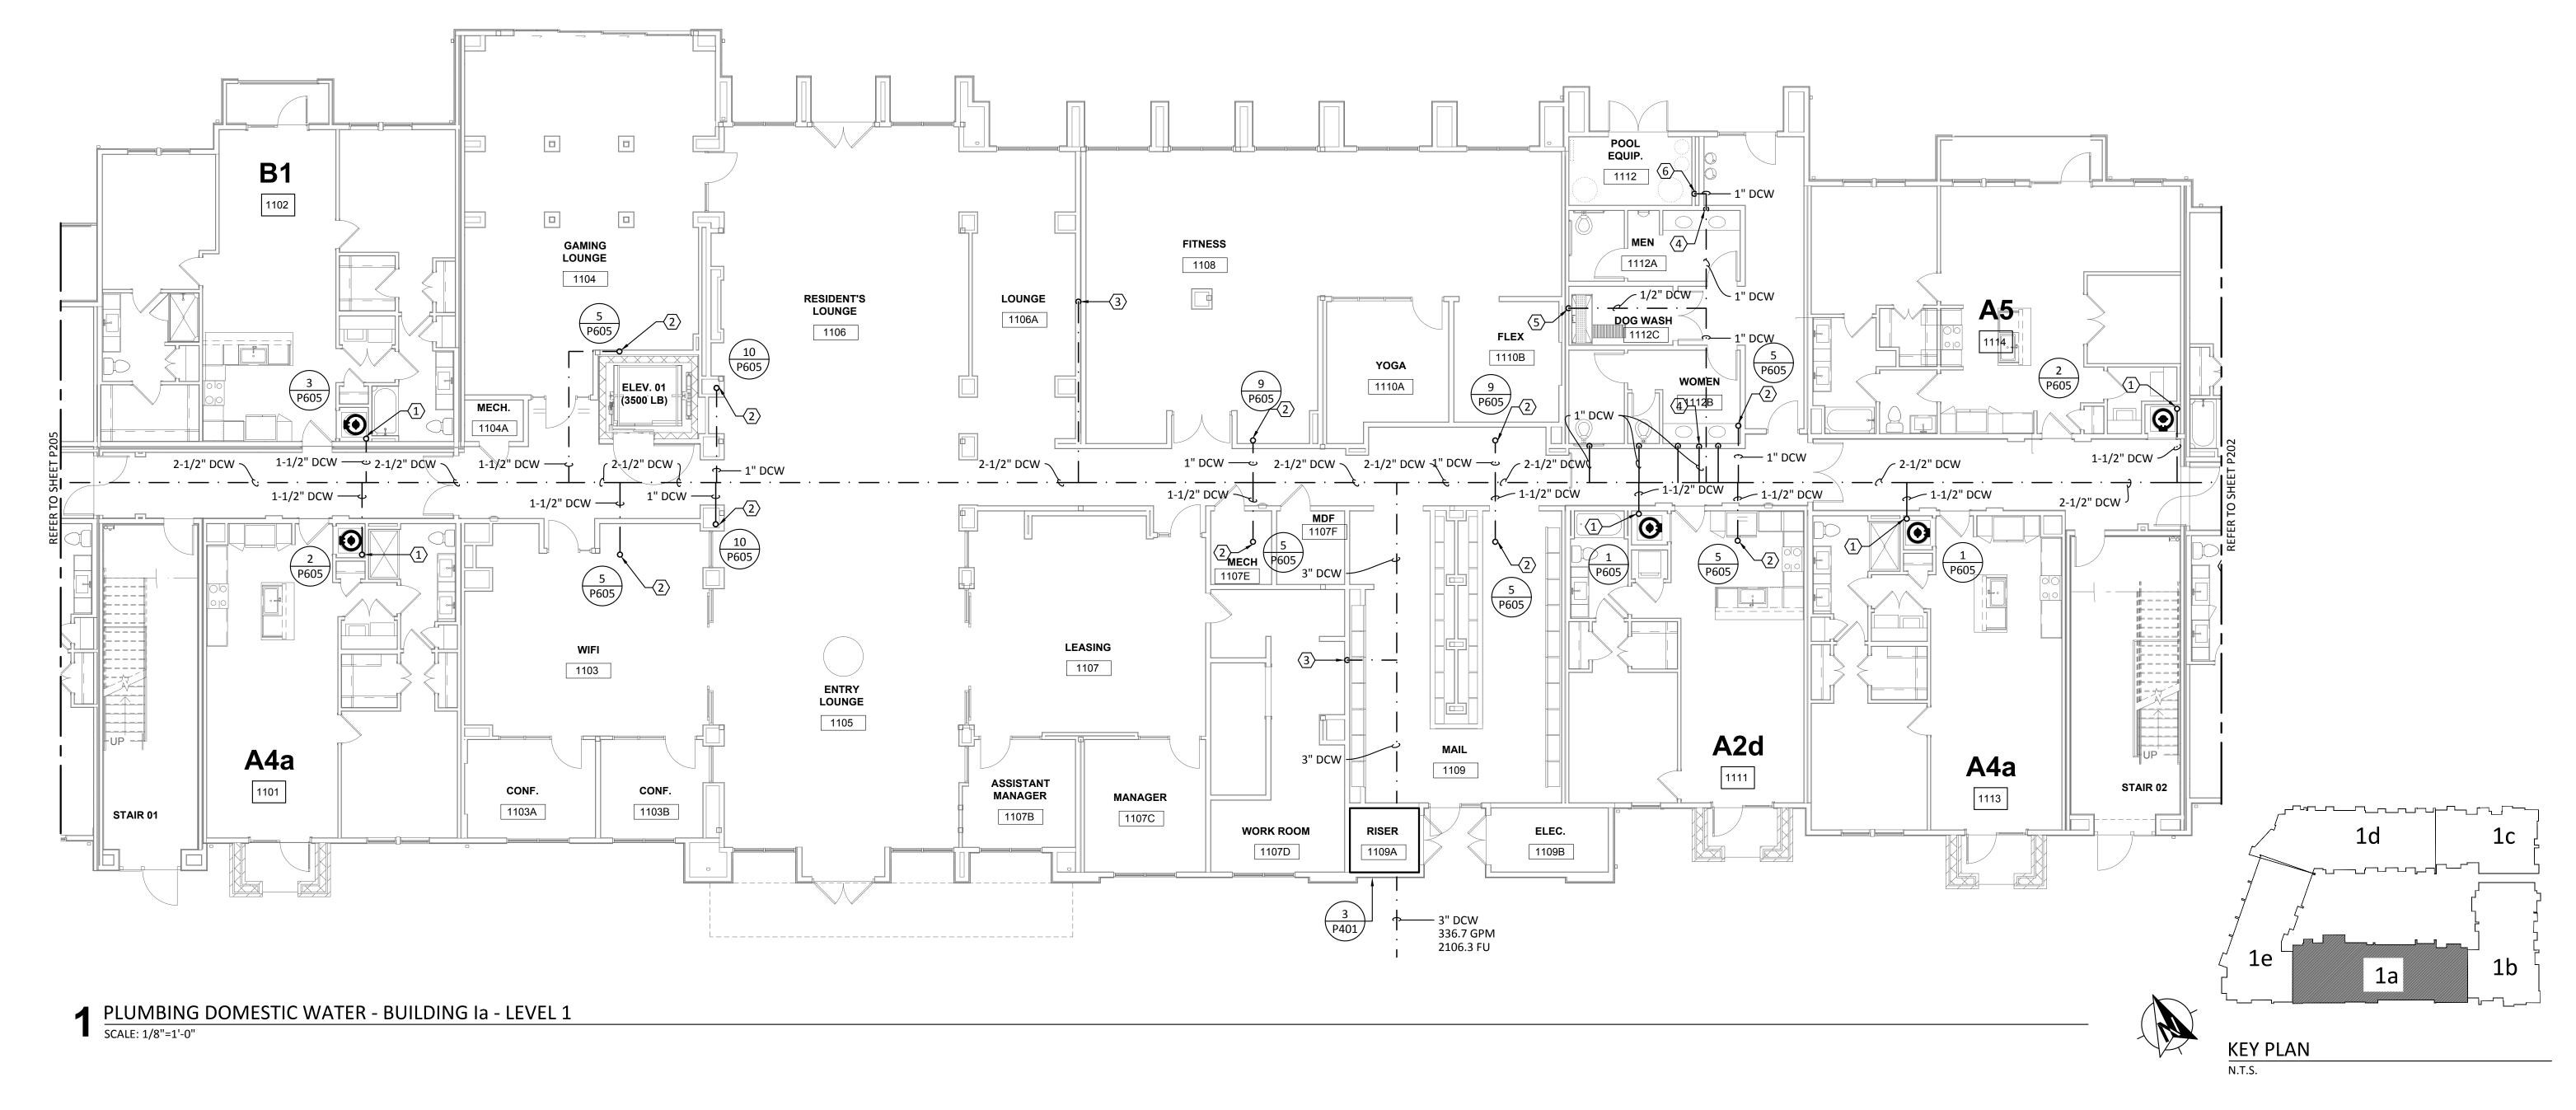





Structural Engineer:

VIEWTECH INC. 4205 Beltway Dr. Addison, TX 75001 Victor Lisiak III 972.661.8187

MEP Engineer:

ENCOTECH 8500 Bluffstone Cove, Austin, TX. 78759 Tessa Roberts 512.338.1101

Civil Engineer:

MBC & Associates, Inc 1035 Central Pkwy N, San Antonio, TX 78732 David Allen 210.545.1122

Landscape Architect:

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Interior Designer:

SJL Design Group 921 N. Riverfront Blvd. Suite 100, Dallas, TX 75207 Cassie Farley 214.443.9090

ISSUANCES		
01	SCHEMATIC DESIGN	09.10.18
02	DEVELOPMENT DESIGN	11.09.18
03	PERMIT SET	01.28.19

REVISIONS




a multifamily project for NRP Group

West Cevallos
San Antonio, Texas

PLUMBING DOMESTIC WATER BUILDING 1a LEVEL 1

Project Number	18054
Date	01/14/2018
Drawn By	TLR
Checked By	EEC

P201

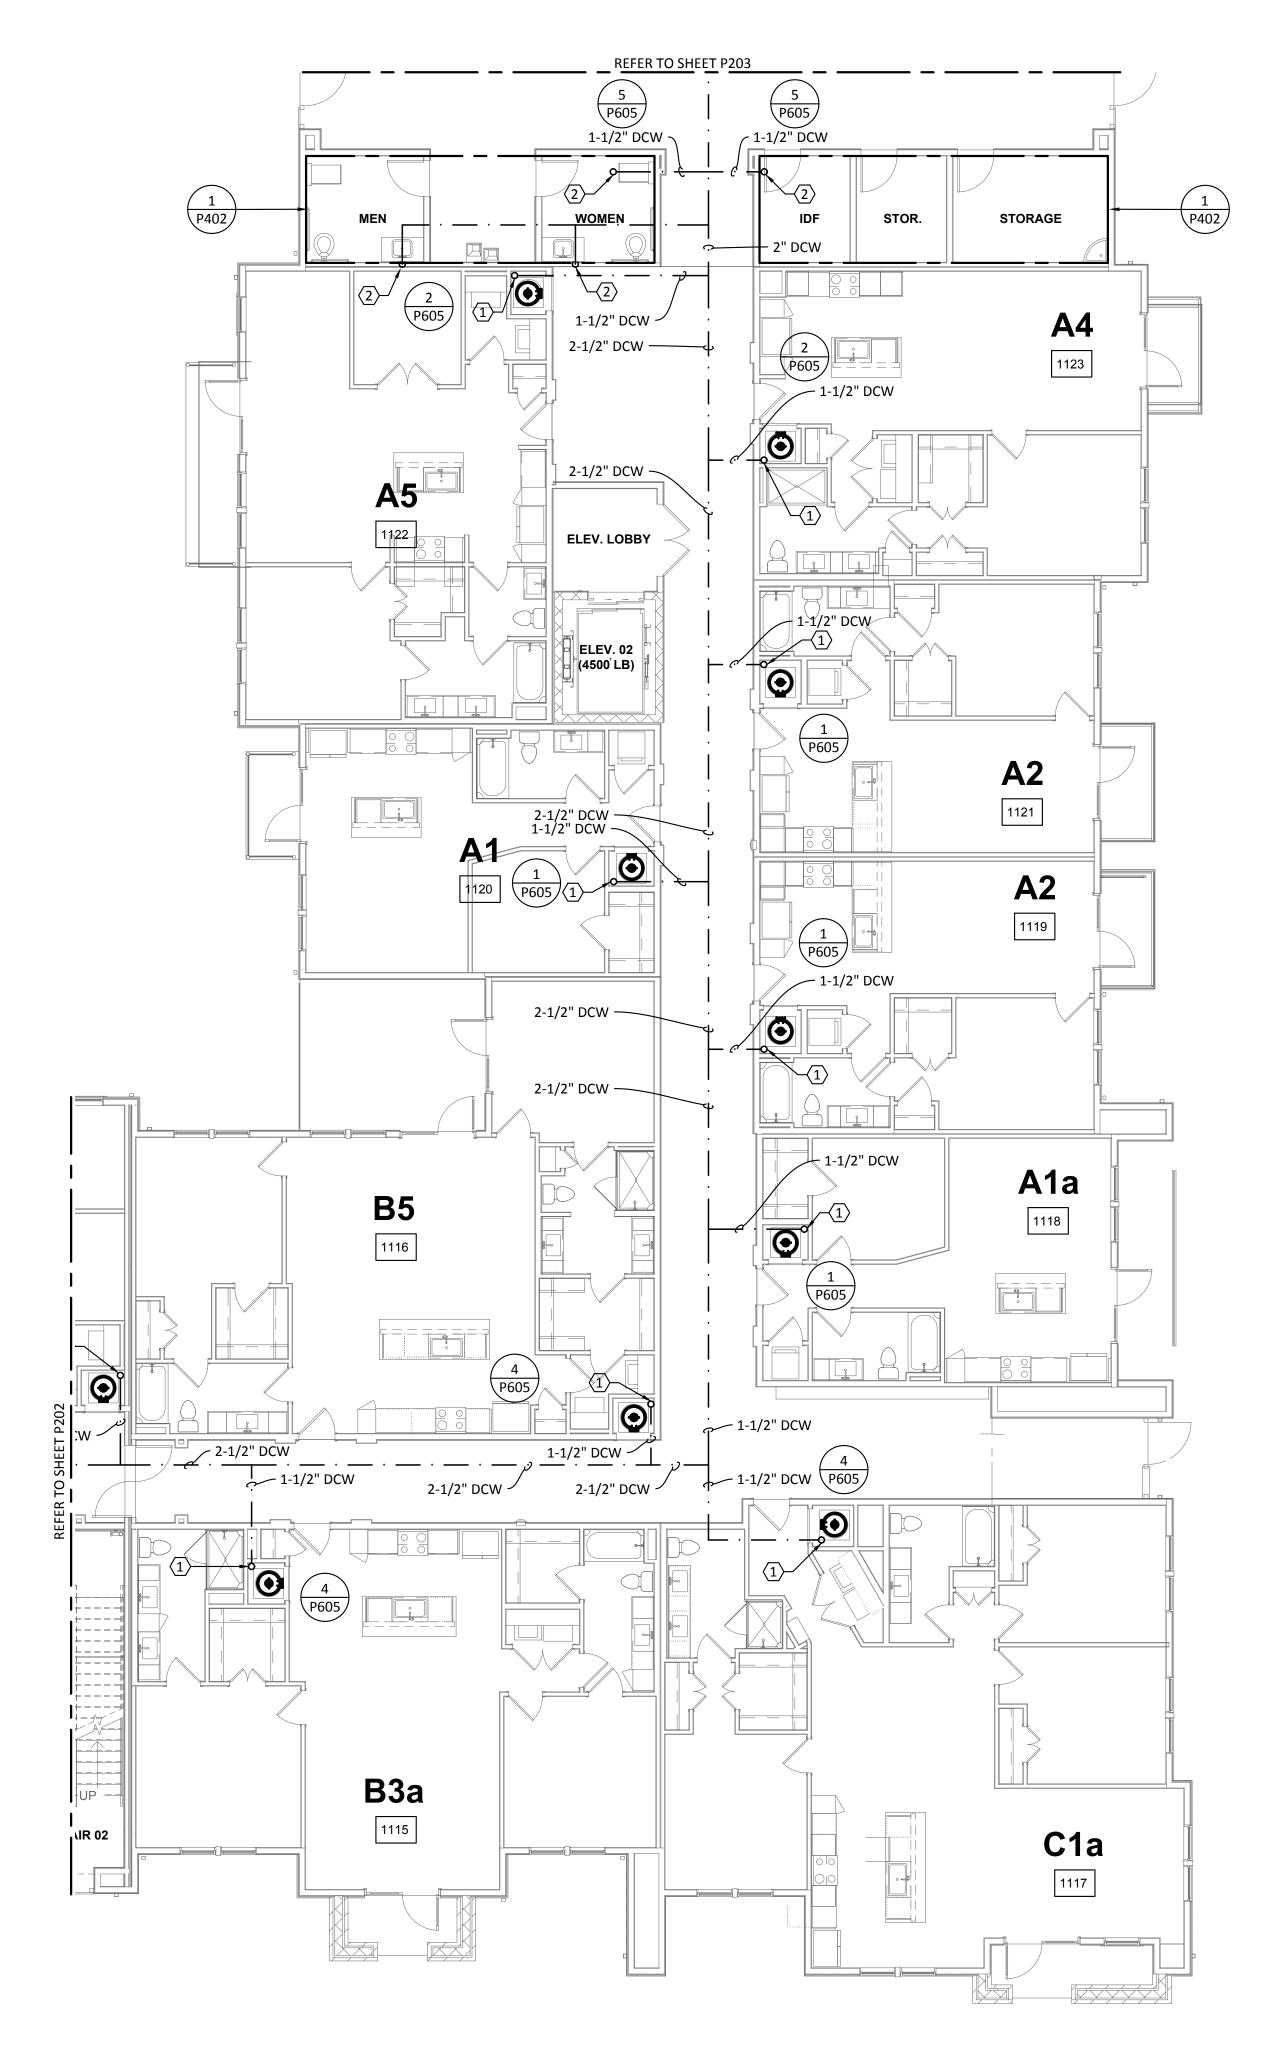

PLUMBING DOMESTIC WATER - BUILDING Ib - LEVEL 1

SCALE: 1/8"=1'-0"



- REFER TO SHEET P000 FOR GENERAL NOTES, LEGENDS, & ABBREVIATIONS.
- B. ALL DOMESTIC WATER PIPING SHALL BE INSTALLED ABOVE CONDITIONED SPACE.

 ANY PIPING OUTSIDE THE CONDITIONED ENVELOPE SHALL BE INSULATED PER CODE.
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KEYED NOTES:

- DOMESTIC WATER RISER FROM TO FLOOR ABOVE. REFER TO ENLARGED UNIT PLANS FOR DWELLING UNIT PIPE DISTRIBUTION. REFER TO RISER DIAGRAM FOR VERTICAL PIPE SIZES.
- DOMESTIC WATER PIPE DOWN TO RESTROOM GROUP. REFER TO SHEET P402 FOR ENLARGED PLAN.



Structural Engineer:

VIEWTECH INC. 4205 Beltway Dr. Addison, TX 75001 Victor Lisiak III 972.661.8187

MEP Engineer:

ENCOTECH 8500 Bluffstone Cove, Austin, TX. 78759 Tessa Roberts 512.338.1101

Civil Engineer:

MBC & Associates, Inc 1035 Central Pkwy N, San Antonio, TX 78732 David Allen 210.545.1122

Landscape Architect:

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Interior Designer:

SJL Design Group 921 N. Riverfront Blvd. Suite 100, Dallas, TX 75207 Cassie Farley 214.443.9090

ISSUANCES		
01	SCHEMATIC DESIGN	09.10.18
02	DEVELOPMENT DESIGN	11.09.18
03	PERMIT SET	01.28.19

REVISIONS



a multifamily project for NRP Group

West Cevallos
San Antonio, Texas

PLUMBING DOMESTIC WATER BUILDING 1b LEVEL 1

Project Number	18054
Date	01/14/2018
Drawn By	TLR
Checked By	EEC

P202


TBPE Firm 1141 8500 Bluffstone Cove, Suite B-103 Austin, Texas 78759 512.338.1101 Project No.: 18054.MS.AUS

KEY PLAN
N.T.S.

PLUMBING DOMESTIC WATER - BUILDING Ic - LEVEL 1

SCALE: 1/8"=1'-0"



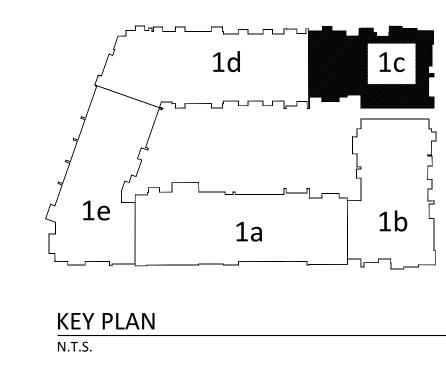



GENERAL NOTES:

- A. REFER TO SHEET P000 FOR GENERAL NOTES, LEGENDS, & ABBREVIATIONS.
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- E. ALL VALVES MUST BE ACCESSIBLE.
- INSULATE ANY WATER PIPING LOCATED IN EXTERIOR OR CORRIDOR WALLS.
- 5. PLUMBING CONTRACTOR SHALL REFER TO SITE PLAN FOR EXACT ORIENTATION OF BUILDING AND LOCATION OF SPRINKLER CLOSET AND TELECOM ROOM.

KEYED NOTES:

- DOMESTIC WATER RISER FROM TO FLOOR ABOVE. REFER TO ENLARGED UNIT PLANS FOR DWELLING UNIT PIPE DISTRIBUTION. REFER TO RISER DIAGRAM FOR VERTICAL PIPE SIZES.
- DOMESTIC WATER PIPE DOWN TO RESTROOM GROUP. REFER TO SHEET P402 FOR ENLARGED PLAN.

COLLABORATIVE 3607 S Lamar Blvd, Suite 103 Austin, Texas 78704 512.852.4310

Structural Engineer:

VIEWTECH INC. 4205 Beltway Dr. Addison, TX 75001 Victor Lisiak III 972.661.8187

MEP Engineer:

ENCOTECH 8500 Bluffstone Cove, Austin, TX. 78759 Tessa Roberts 512.338.1101

Civil Engineer:

MBC & Associates, Inc 1035 Central Pkwy N, San Antonio, TX 78732 David Allen 210.545.1122

Landscape Architect:

LEE & Associates, Inc. 9020 N Capital of Texas Hwy, Austin, TX. 78759 Amber Rothwell


Interior Designer:

512.345.8477

SJL Design Group 921 N. Riverfront Blvd. Suite 100, Dallas, TX 75207 Cassie Farley 214.443.9090

ISSUANCES		
01	SCHEMATIC DESIGN	09.10.18
02	DEVELOPMENT DESIGN	11.09.18
03	PERMIT SET	01.28.19

REVISIONS

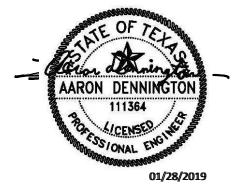

a multifamily project for NRP Group

West Cevallos
San Antonio, Texas

PLUMBING DOMESTIC WATER BUILDING 1c LEVEL 1

Project Number	18054
Date	01/14/2018
Drawn By	TLR
Checked By	EEC


P203

- A. REFER TO SHEET P000 FOR GENERAL NOTES, LEGENDS, & ABBREVIATIONS.
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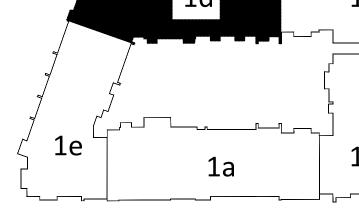
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- DOMESTIC WATER PIPE DOWN TO RESTROOM GROUP. REFER TO SHEET P402 FOR ENLARGED PLAN.



PLUMBING DOMESTIC WATER - BUILDING Id - LEVEL 1

SCALE: 1/8"=1'-0"

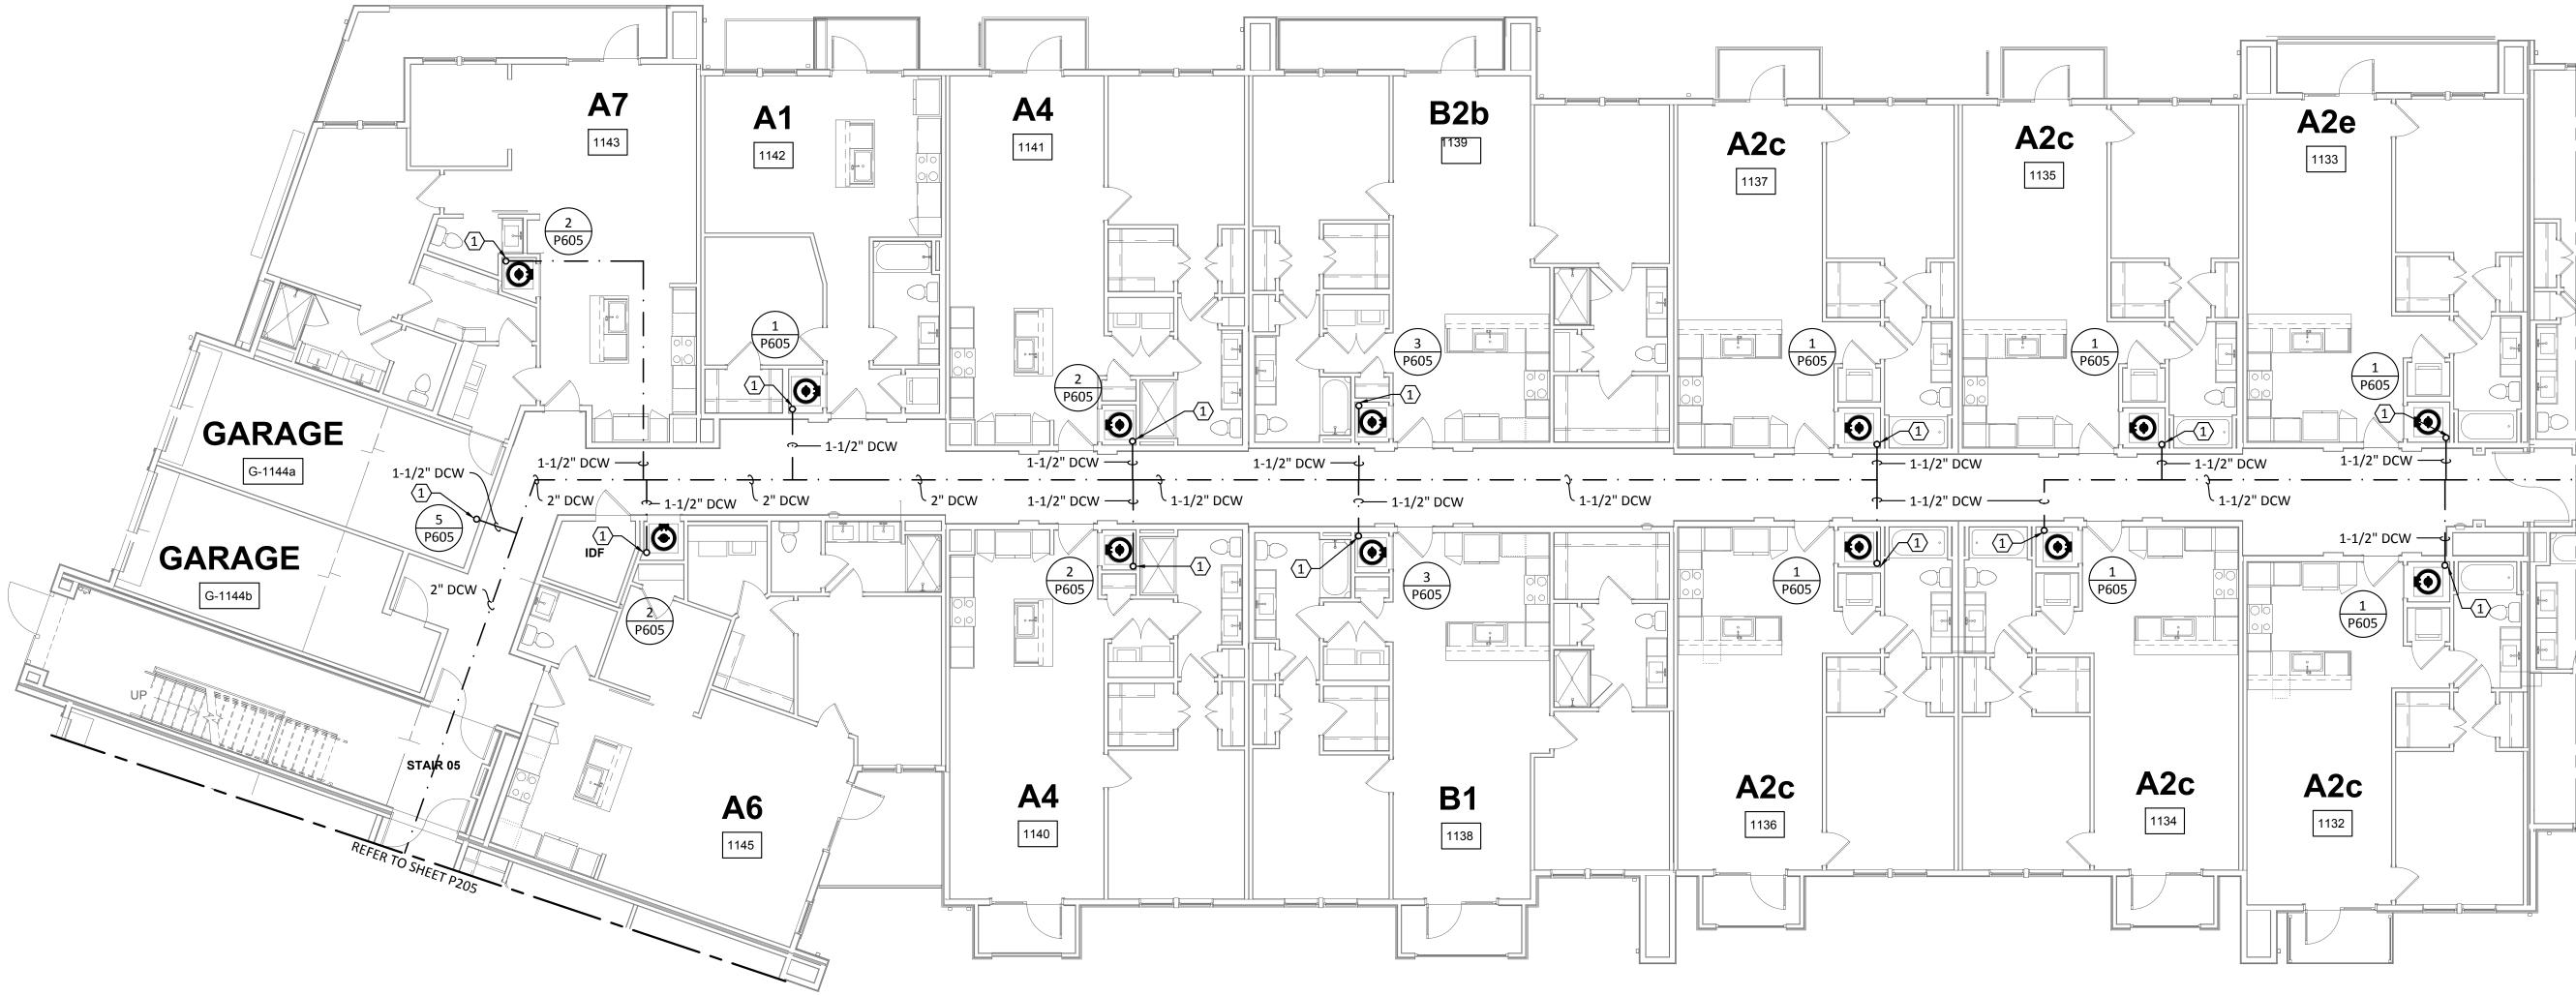

KEY PLAN
N.T.S.

ENCOTECH ENGINEERING CONSULTANTS TBPE Firm 8500 Bluffstone Cove, Suite B-103 1141 Austin, Texas 78759 | 512.338.1101 Project No.: 18054.MS.AUS



Structural Engineer:

VIEWTECH INC. 4205 Beltway Dr. Addison, TX 75001 Victor Lisiak III 972.661.8187

MEP Engineer:

ENCOTECH 8500 Bluffstone Cove, Austin, TX. 78759 Tessa Roberts 512.338.1101

Civil Engineer:

MBC & Associates, Inc 1035 Central Pkwy N, San Antonio, TX 78732 David Allen

Landscape Architect:

210.545.1122


LEE & Associates, Inc. 9020 N Capital of Texas Hwy, Austin, TX. 78759 Amber Rothwell

Interior Designer:

512.345.8477

SJL Design Group 921 N. Riverfront Blvd. Suite 100, Dallas, TX 75207 Cassie Farley 214.443.9090

ISSUANCES		
01	SCHEMATIC DESIGN	09.10.18
02	DEVELOPMENT DESIGN	11.09.18
03	PERMIT SET	01.28.19

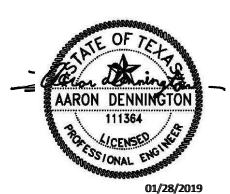


a multifamily project for NRP Group

West Cevallos San Antonio, Texas

PLUMBING DOMESTIC WATER BUILDING 1d LEVEL 1

Project Number	18054
Date	01/14/2018
Drawn By	TLR
Checked By	EEC

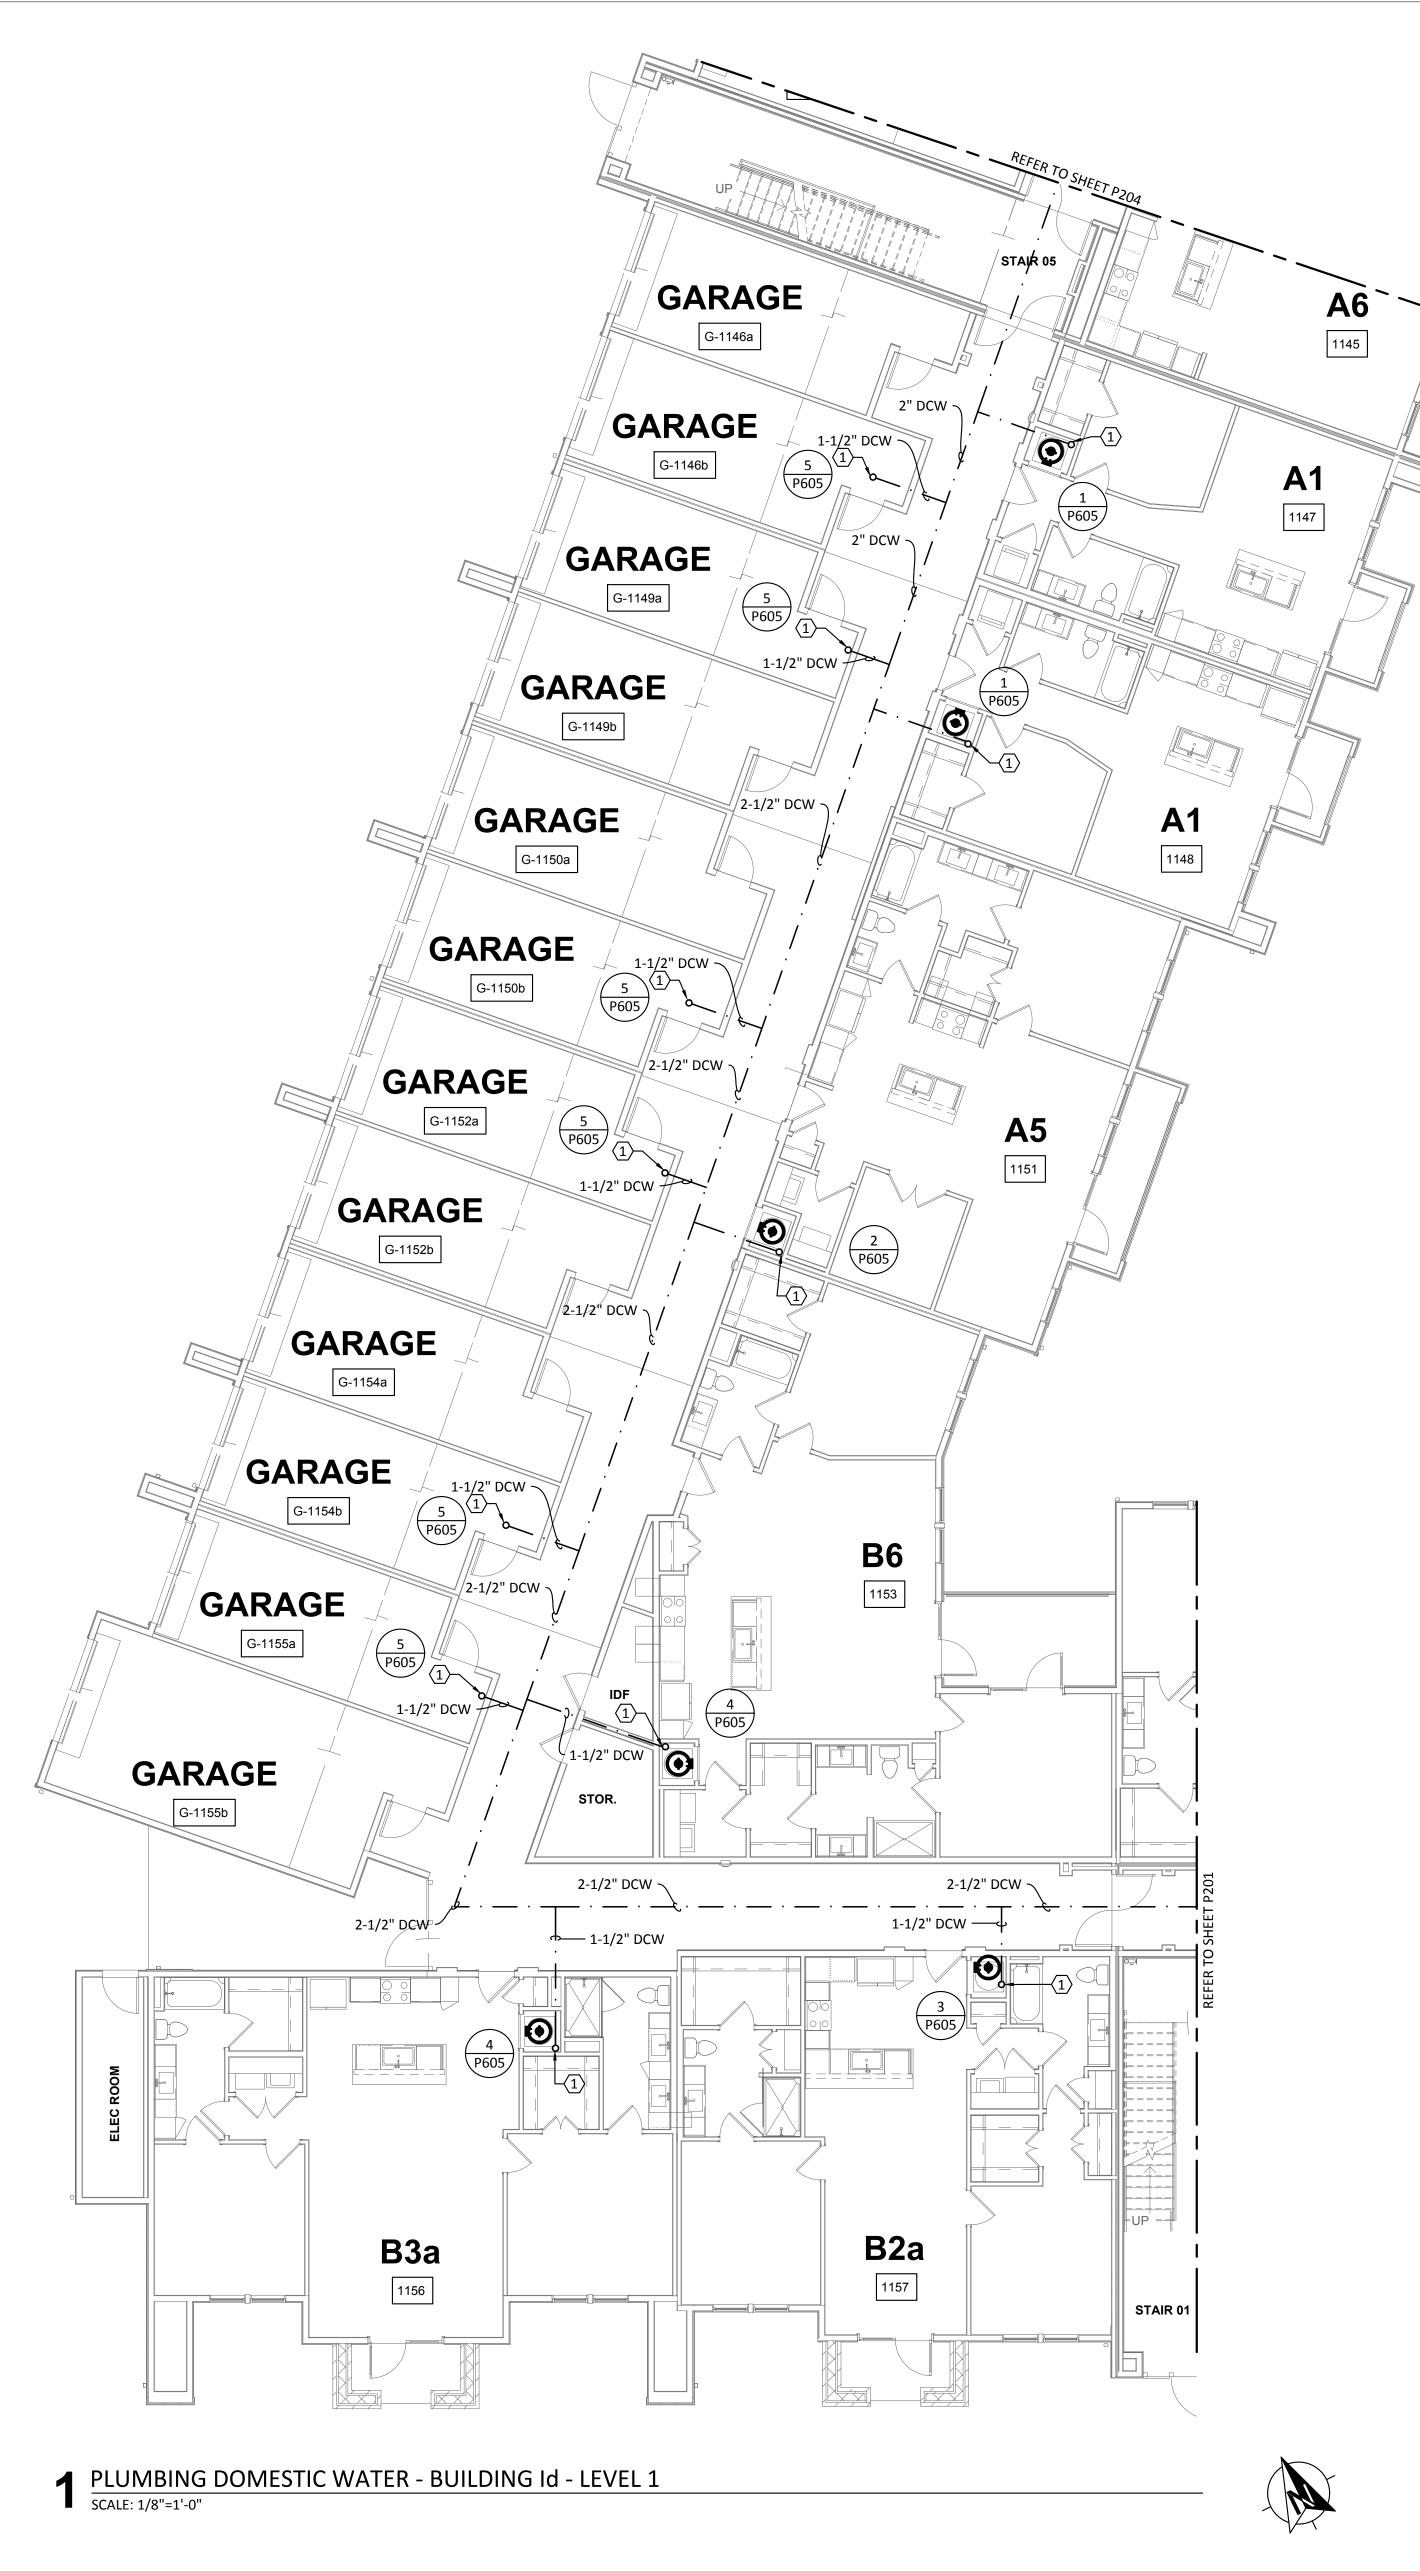



- REFER TO SHEET POOD FOR GENERAL NOTES, LEGENDS, & ABBREVIATIONS.
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Structural Engineer:

VIEWTECH INC. 4205 Beltway Dr. Addison, TX 75001 Victor Lisiak III 972.661.8187

MEP Engineer:

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Civil Engineer:

MBC & Associates, Inc 1035 Central Pkwy N, San Antonio, TX 78732 David Allen 210.545.1122


Landscape Architect:

LEE & Associates, Inc. 9020 N Capital of Texas Hwy, Austin, TX. 78759 Amber Rothwell 512.345.8477

Interior Designer:

SJL Design Group 921 N. Riverfront Blvd. Suite 100, Dallas, TX 75207 Cassie Farley 214.443.9090

ISSUANCES		
01	SCHEMATIC DESIGN	09.10.18
02	DEVELOPMENT DESIGN	11.09.18
0.3	PERMIT SET	01 28 19

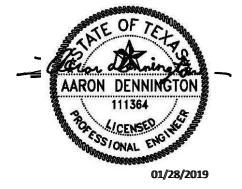

a multifamily project for NRP Group

West Cevallos San Antonio, Texas

PLUMBING DOMESTIC WATER BUILDING 1e LEVEL 1

Project Number	18054
Date	01/14/2018
Drawn By	TLR
Checked By	EEC

TBPE Firm 8500 Bluffstone Cove, Suite B-103 1141 Austin, Texas 78759 | 512.338.1101 Project No.: 18054.MS.AUS


KEY PLAN



- A. REFER TO SHEET P000 FOR GENERAL NOTES, LEGENDS, & ABBREVIATIONS.
- B. DO NOT ROUTE PIPING OVER ELECTRICAL PANELS.
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KEYED NOTES:

DOMESTIC WATER RISER FROM FLOOR BELOW. REFER TO ENLARGED UNIT PLANS FOR DWELLING UNIT PIPE DISTRIBUTION. REFER TO RISER DIAGRAM FOR VERTICAL PIPE SIZES.

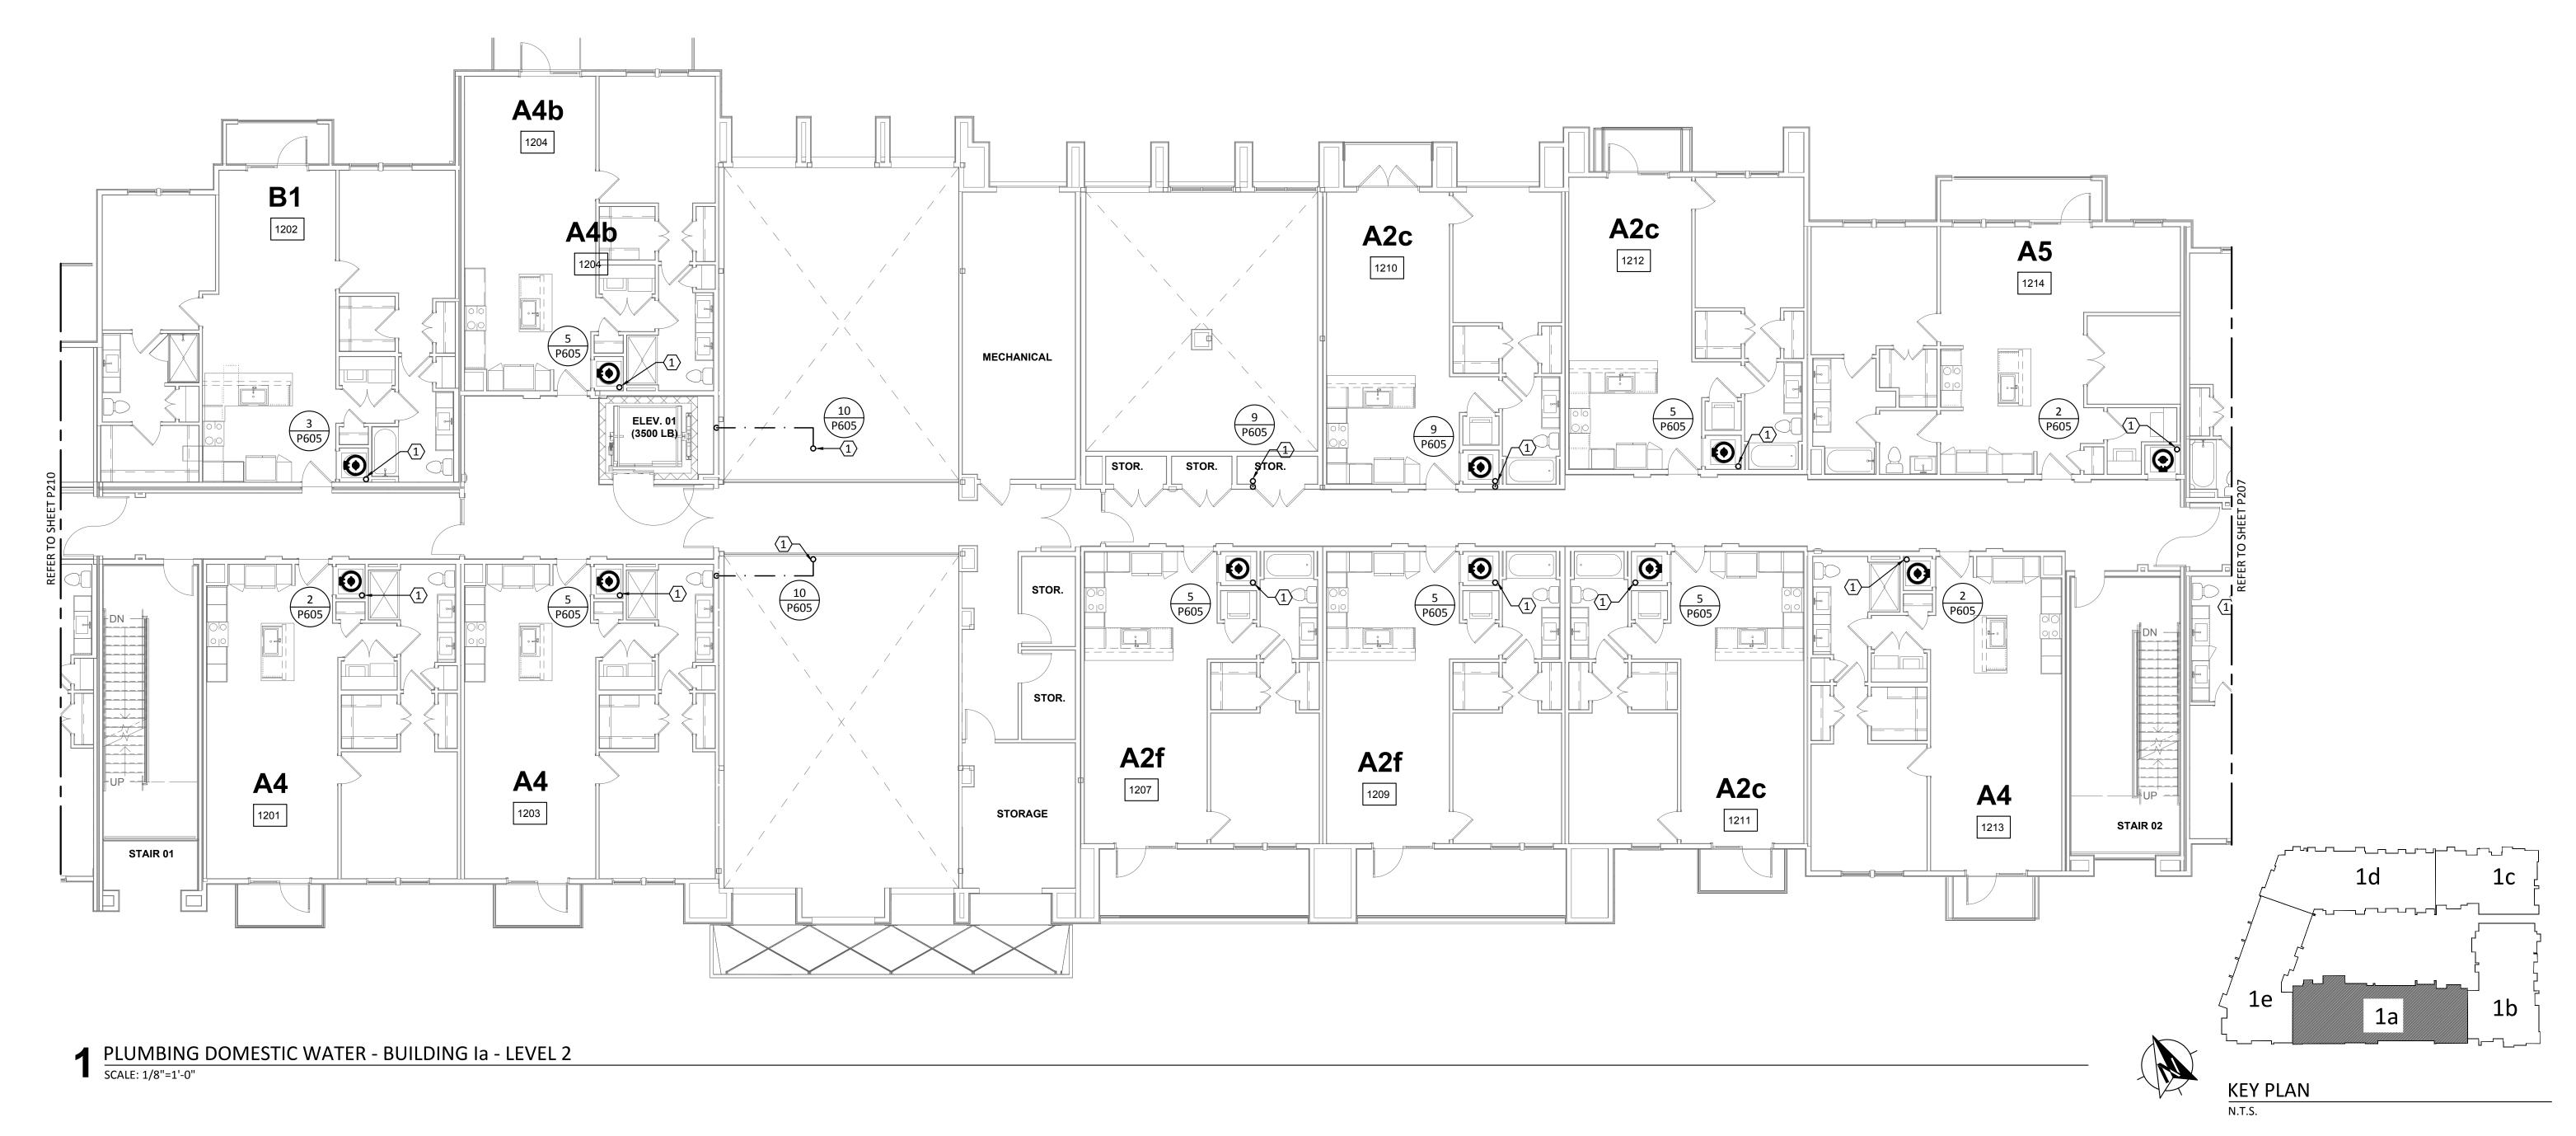

TBPE Firm 1141 8500 Bluffstone Cove, Suite B-103 Austin, Texas 78759 | 512.338.1101 Project No.: 18054.MS.AUS



Structural Engineer:

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MEP Engineer:

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Civil Engineer:

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Landscape Architect:

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Interior Designer:

SJL Design Group 921 N. Riverfront Blvd. Suite 100, Dallas, TX 75207 Cassie Farley 214.443.9090

ISSUANCES		
01	SCHEMATIC DESIGN	09.10.18
02	DEVELOPMENT DESIGN	11.09.18
03	PERMIT SET	01.28.19

REVISIONS




a multifamily project for NRP Group

West Cevallos
San Antonio, Texas

PLUMBING DOMESTIC WATER BUILDING 1a LEVEL 2

Project Number	18054
Date	01/14/2018
Drawn By	TLR
Checked By	EEC

P206

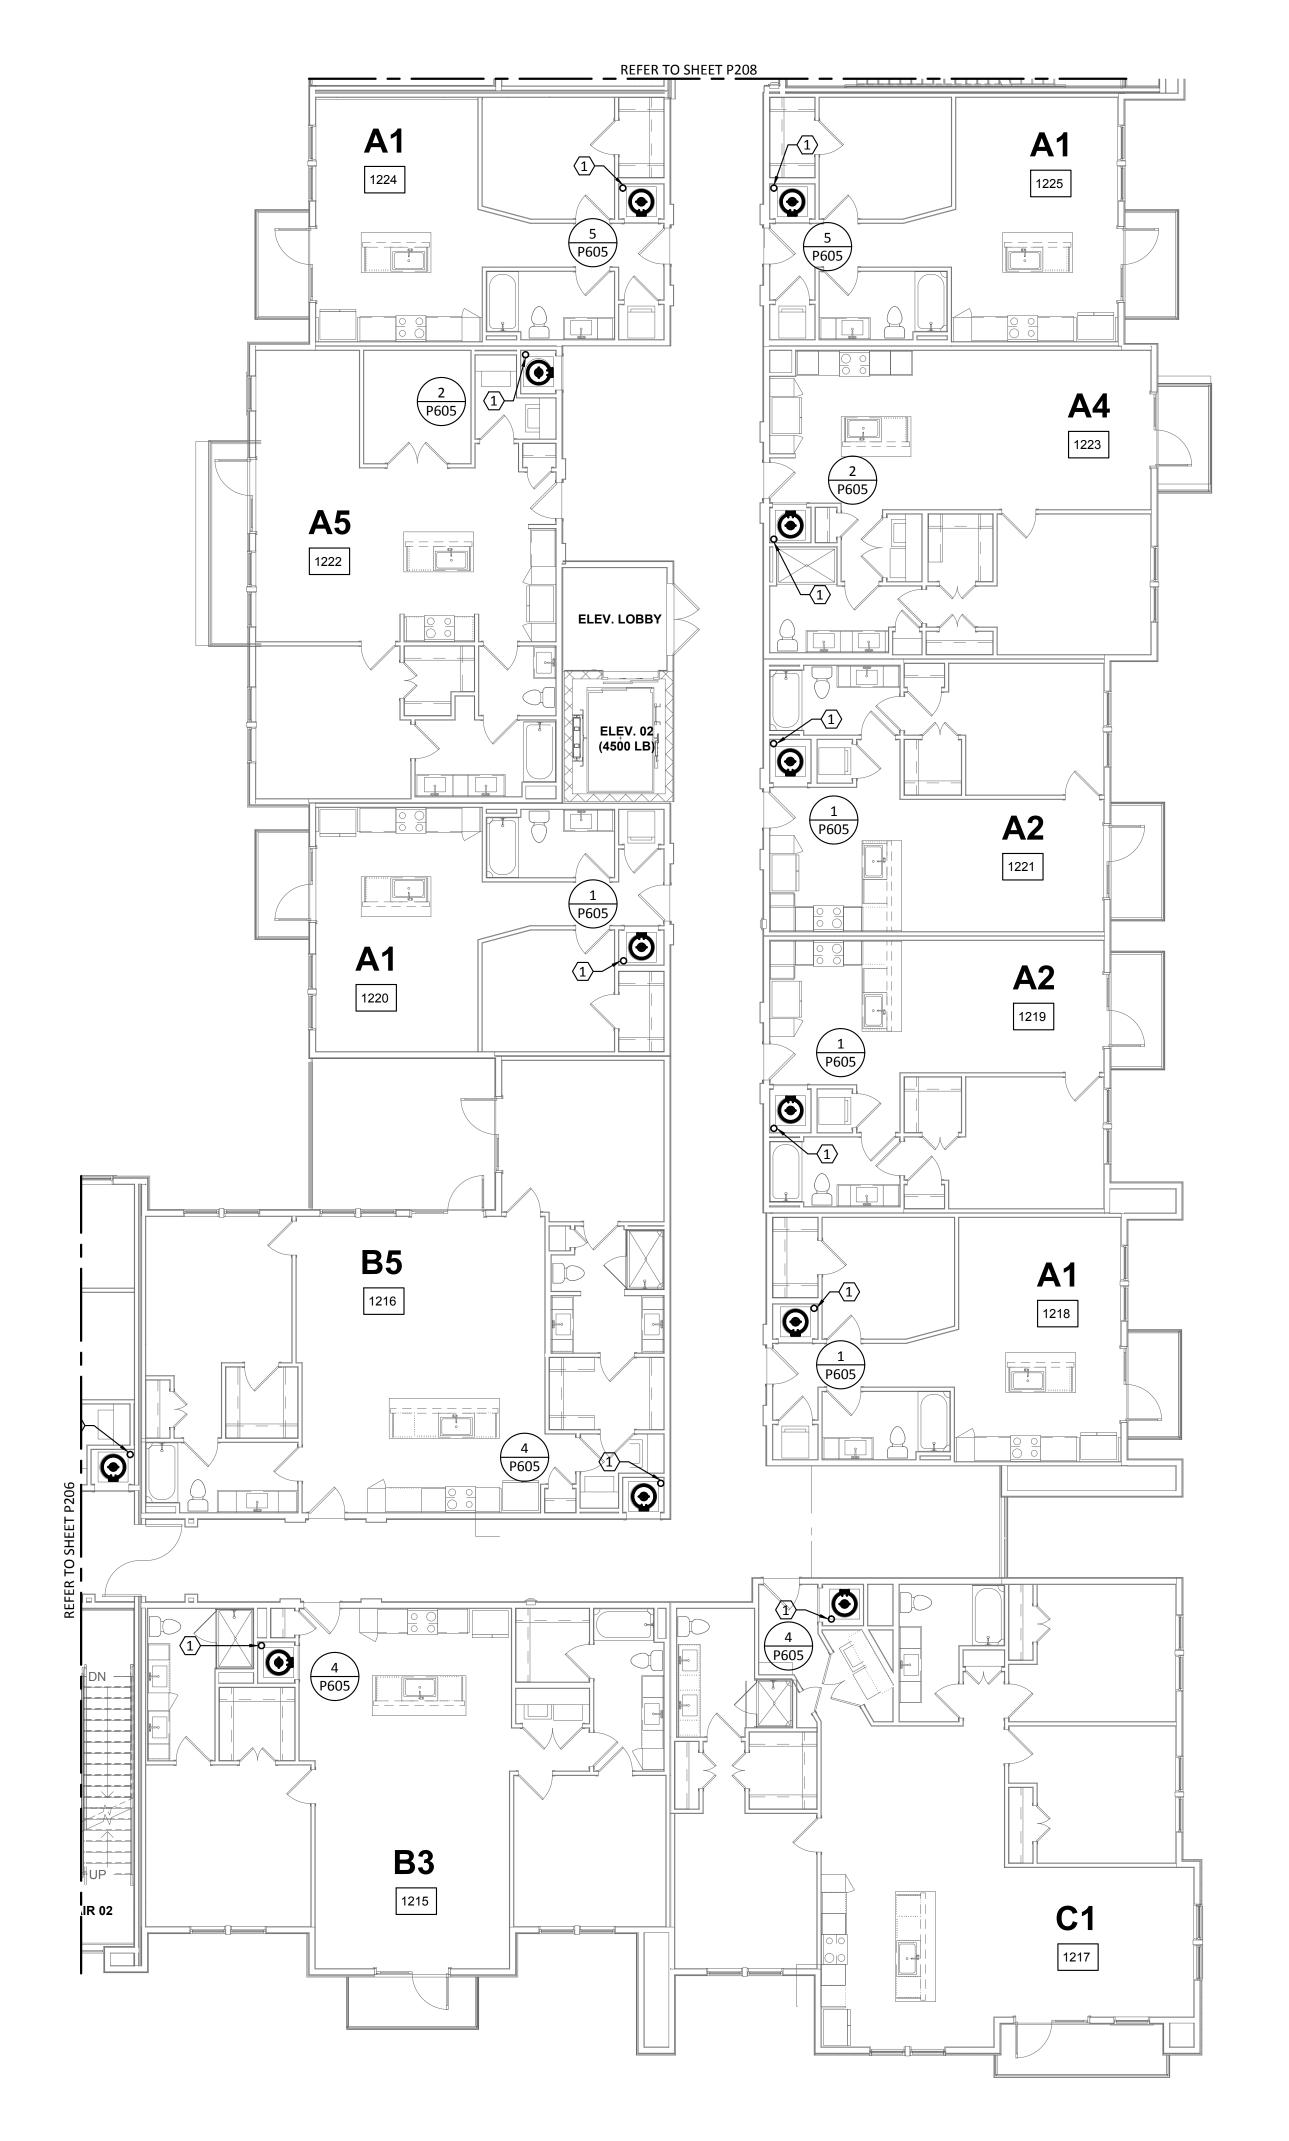

PLUMBING DOMESTIC WATER - BUILDING Ib - LEVEL 2

SCALE: 1/8"=1'-0"



- A. REFER TO SHEET POOD FOR GENERAL NOTES, LEGENDS, & ABBREVIATIONS.
- B. DO NOT ROUTE PIPING OVER ELECTRICAL PANELS.
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KEYED NOTES:

DOMESTIC WATER RISER FROM FLOOR BELOW. REFER TO ENLARGED UNIT PLANS FOR DWELLING UNIT PIPE DISTRIBUTION. REFER TO RISER DIAGRAM FOR VERTICAL PIPE SIZES.



Structural Engineer:

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MEP Engineer:

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Civil Engineer:

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Interior Designer:

512.345.8477

SJL Design Group 921 N. Riverfront Blvd. Suite 100, Dallas, TX 75207 Cassie Farley 214.443.9090

ISSUANCES		
01	SCHEMATIC DESIGN	09.10.18
02	DEVELOPMENT DESIGN	11.09.18
03	PERMIT SET	01.28.19



a multifamily project for NRP Group

West Cevallos San Antonio, Texas

PLUMBING DOMESTIC WATER BUILDING 1b LEVEL 2

Project Number 01/14/2018 TLR Drawn By Checked By EEC



KEY PLAN
N.T.S.




ER TO SHEET P000 F

GENERAL NOTES:

- A. REFER TO SHEET P000 FOR GENERAL NOTES, LEGENDS, & ABBREVIATIONS.
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KEYED NOTES:


DOMESTIC WATER RISER FROM FLOOR BELOW. REFER TO ENLARGED UNIT PLANS FOR DWELLING UNIT PIPE DISTRIBUTION. REFER TO RISER DIAGRAM FOR VERTICAL PIPE SIZES.

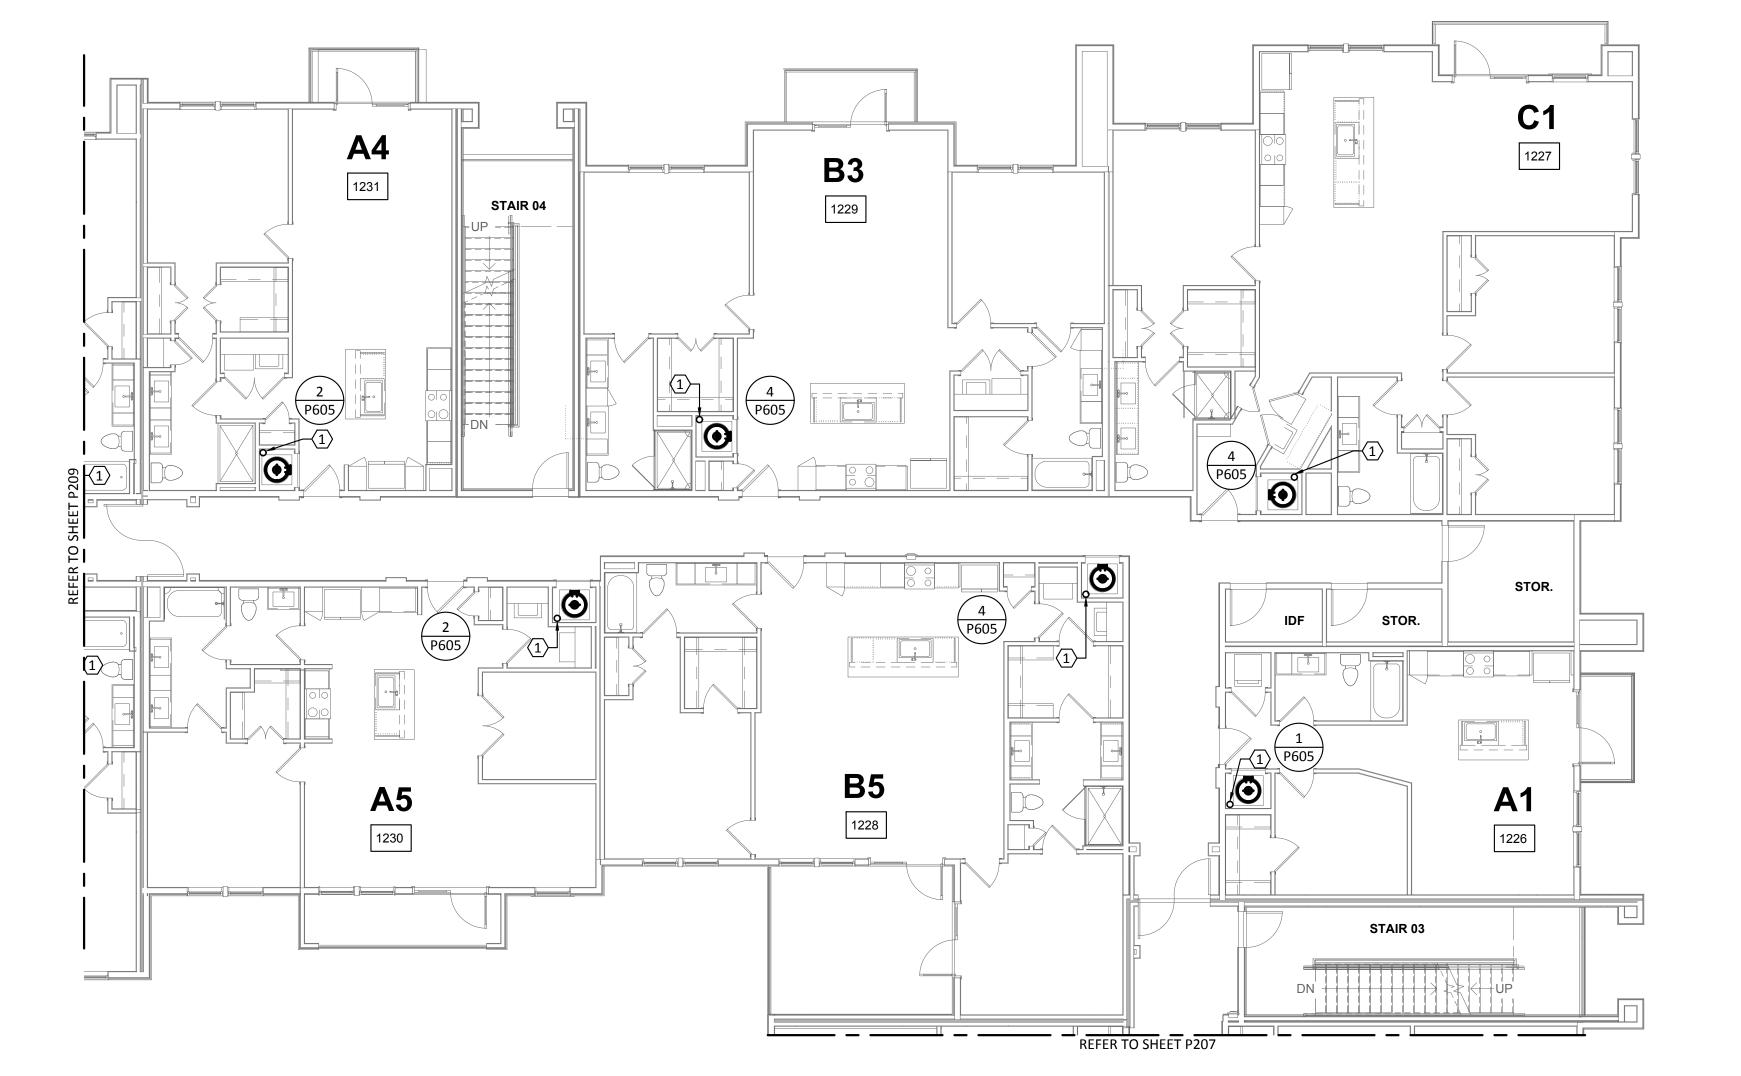

PLUMBING DOMESTIC WATER BUILDING Ic - LEVEL 2

SCALE: 1/8"=1'-0"



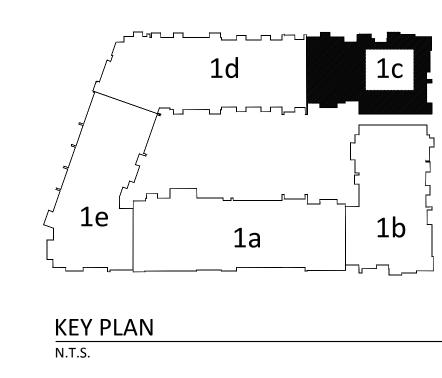





Structural Engineer:

VIEWTECH INC. 4205 Beltway Dr. Addison, TX 75001 Victor Lisiak III 972.661.8187

MEP Engineer:

ENCOTECH 8500 Bluffstone Cove, Austin, TX. 78759 Tessa Roberts 512.338.1101

Civil Engineer:

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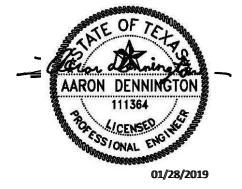
Interior Designer:

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ISSUANCES		
01	SCHEMATIC DESIGN	09.10.18
02	DEVELOPMENT DESIGN	11.09.18
03	PERMIT SET	01.28.19

REVISION



a multifamily project for NRP Group

West Cevallos
San Antonio, Texas

PLUMBING DOMESTIC WATER BUILDING 1c LEVEL 2


Project Number	18054
Date	01/14/2018
Drawn By	TLR
Checked By	EEC

P208

- A. REFER TO SHEET P000 FOR GENERAL NOTES, LEGENDS, & ABBREVIATIONS.
- B. DO NOT ROUTE PIPING OVER ELECTRICAL PANELS.
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KEYED NOTES:


DOMESTIC WATER RISER FROM FLOOR BELOW. REFER TO ENLARGED UNIT PLANS FOR DWELLING UNIT PIPE DISTRIBUTION. REFER TO RISER DIAGRAM FOR VERTICAL PIPE SIZES.

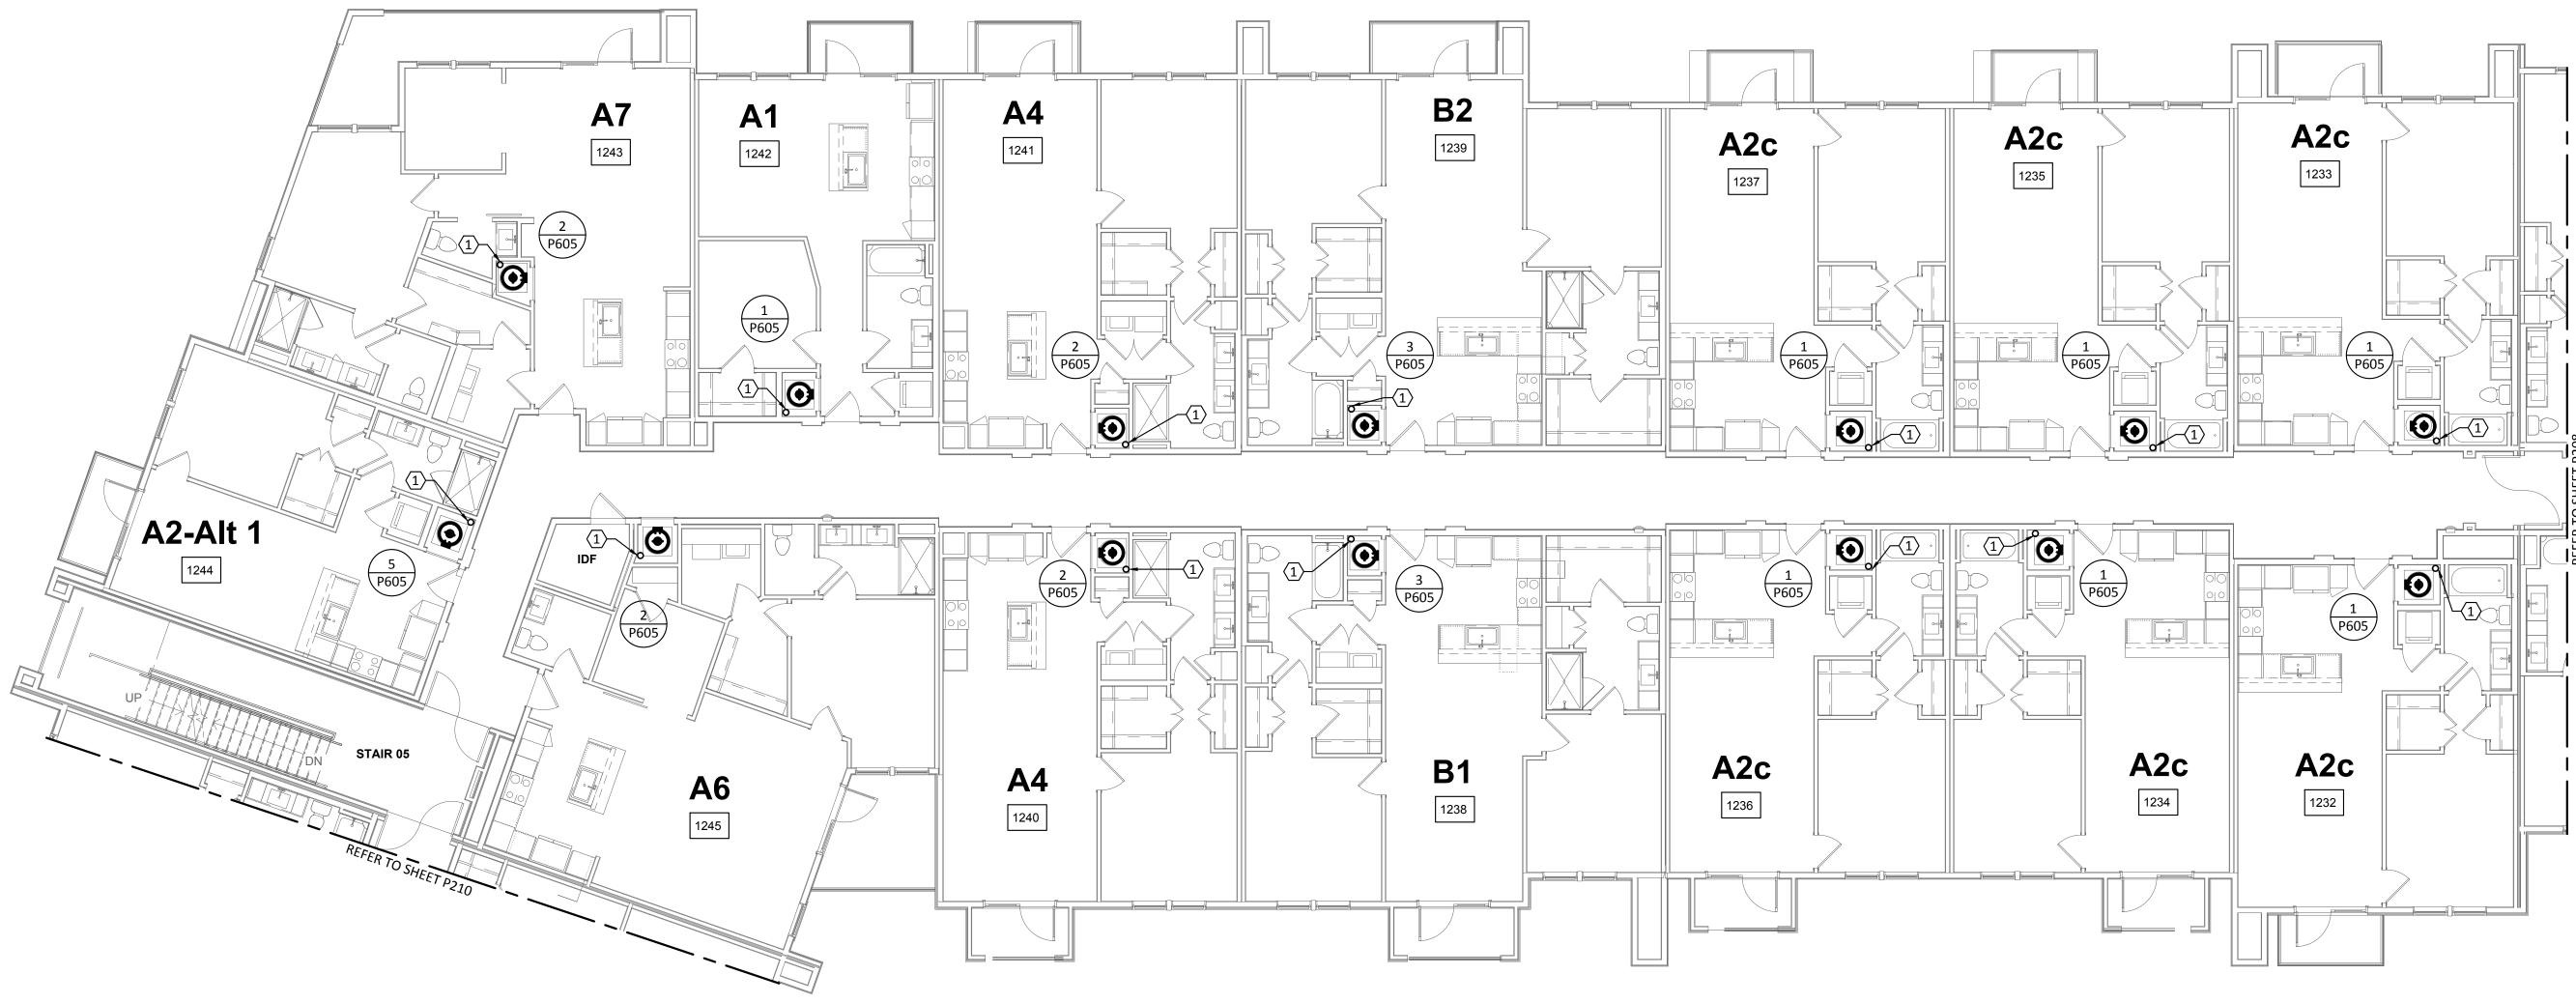

PLUMBING DOMESTIC WATER - BUILDING Id - LEVEL 2

SCALE: 1/8"=1'-0"



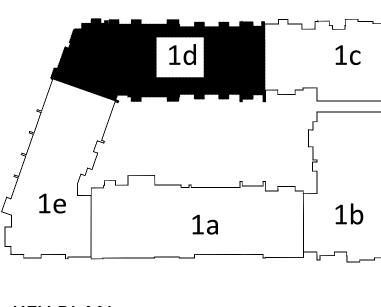

KEY PLAN
N.T.S.





Structural Engineer:

VIEWTECH INC. 4205 Beltway Dr. Addison, TX 75001 Victor Lisiak III 972.661.8187

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ISSUANCES		
01	SCHEMATIC DESIGN	09.10.18
02	DEVELOPMENT DESIGN	11.09.18
03	PERMIT SET	01.28.19

REVISION



a multifamily project for NRP Group

West Cevallos
San Antonio, Texas

PLUMBING DOMESTIC WATER BUILDING 1d LEVEL 2


Project Number 18054

Date 01/14/2018

Drawn By TLR

Checked By EEC

P209

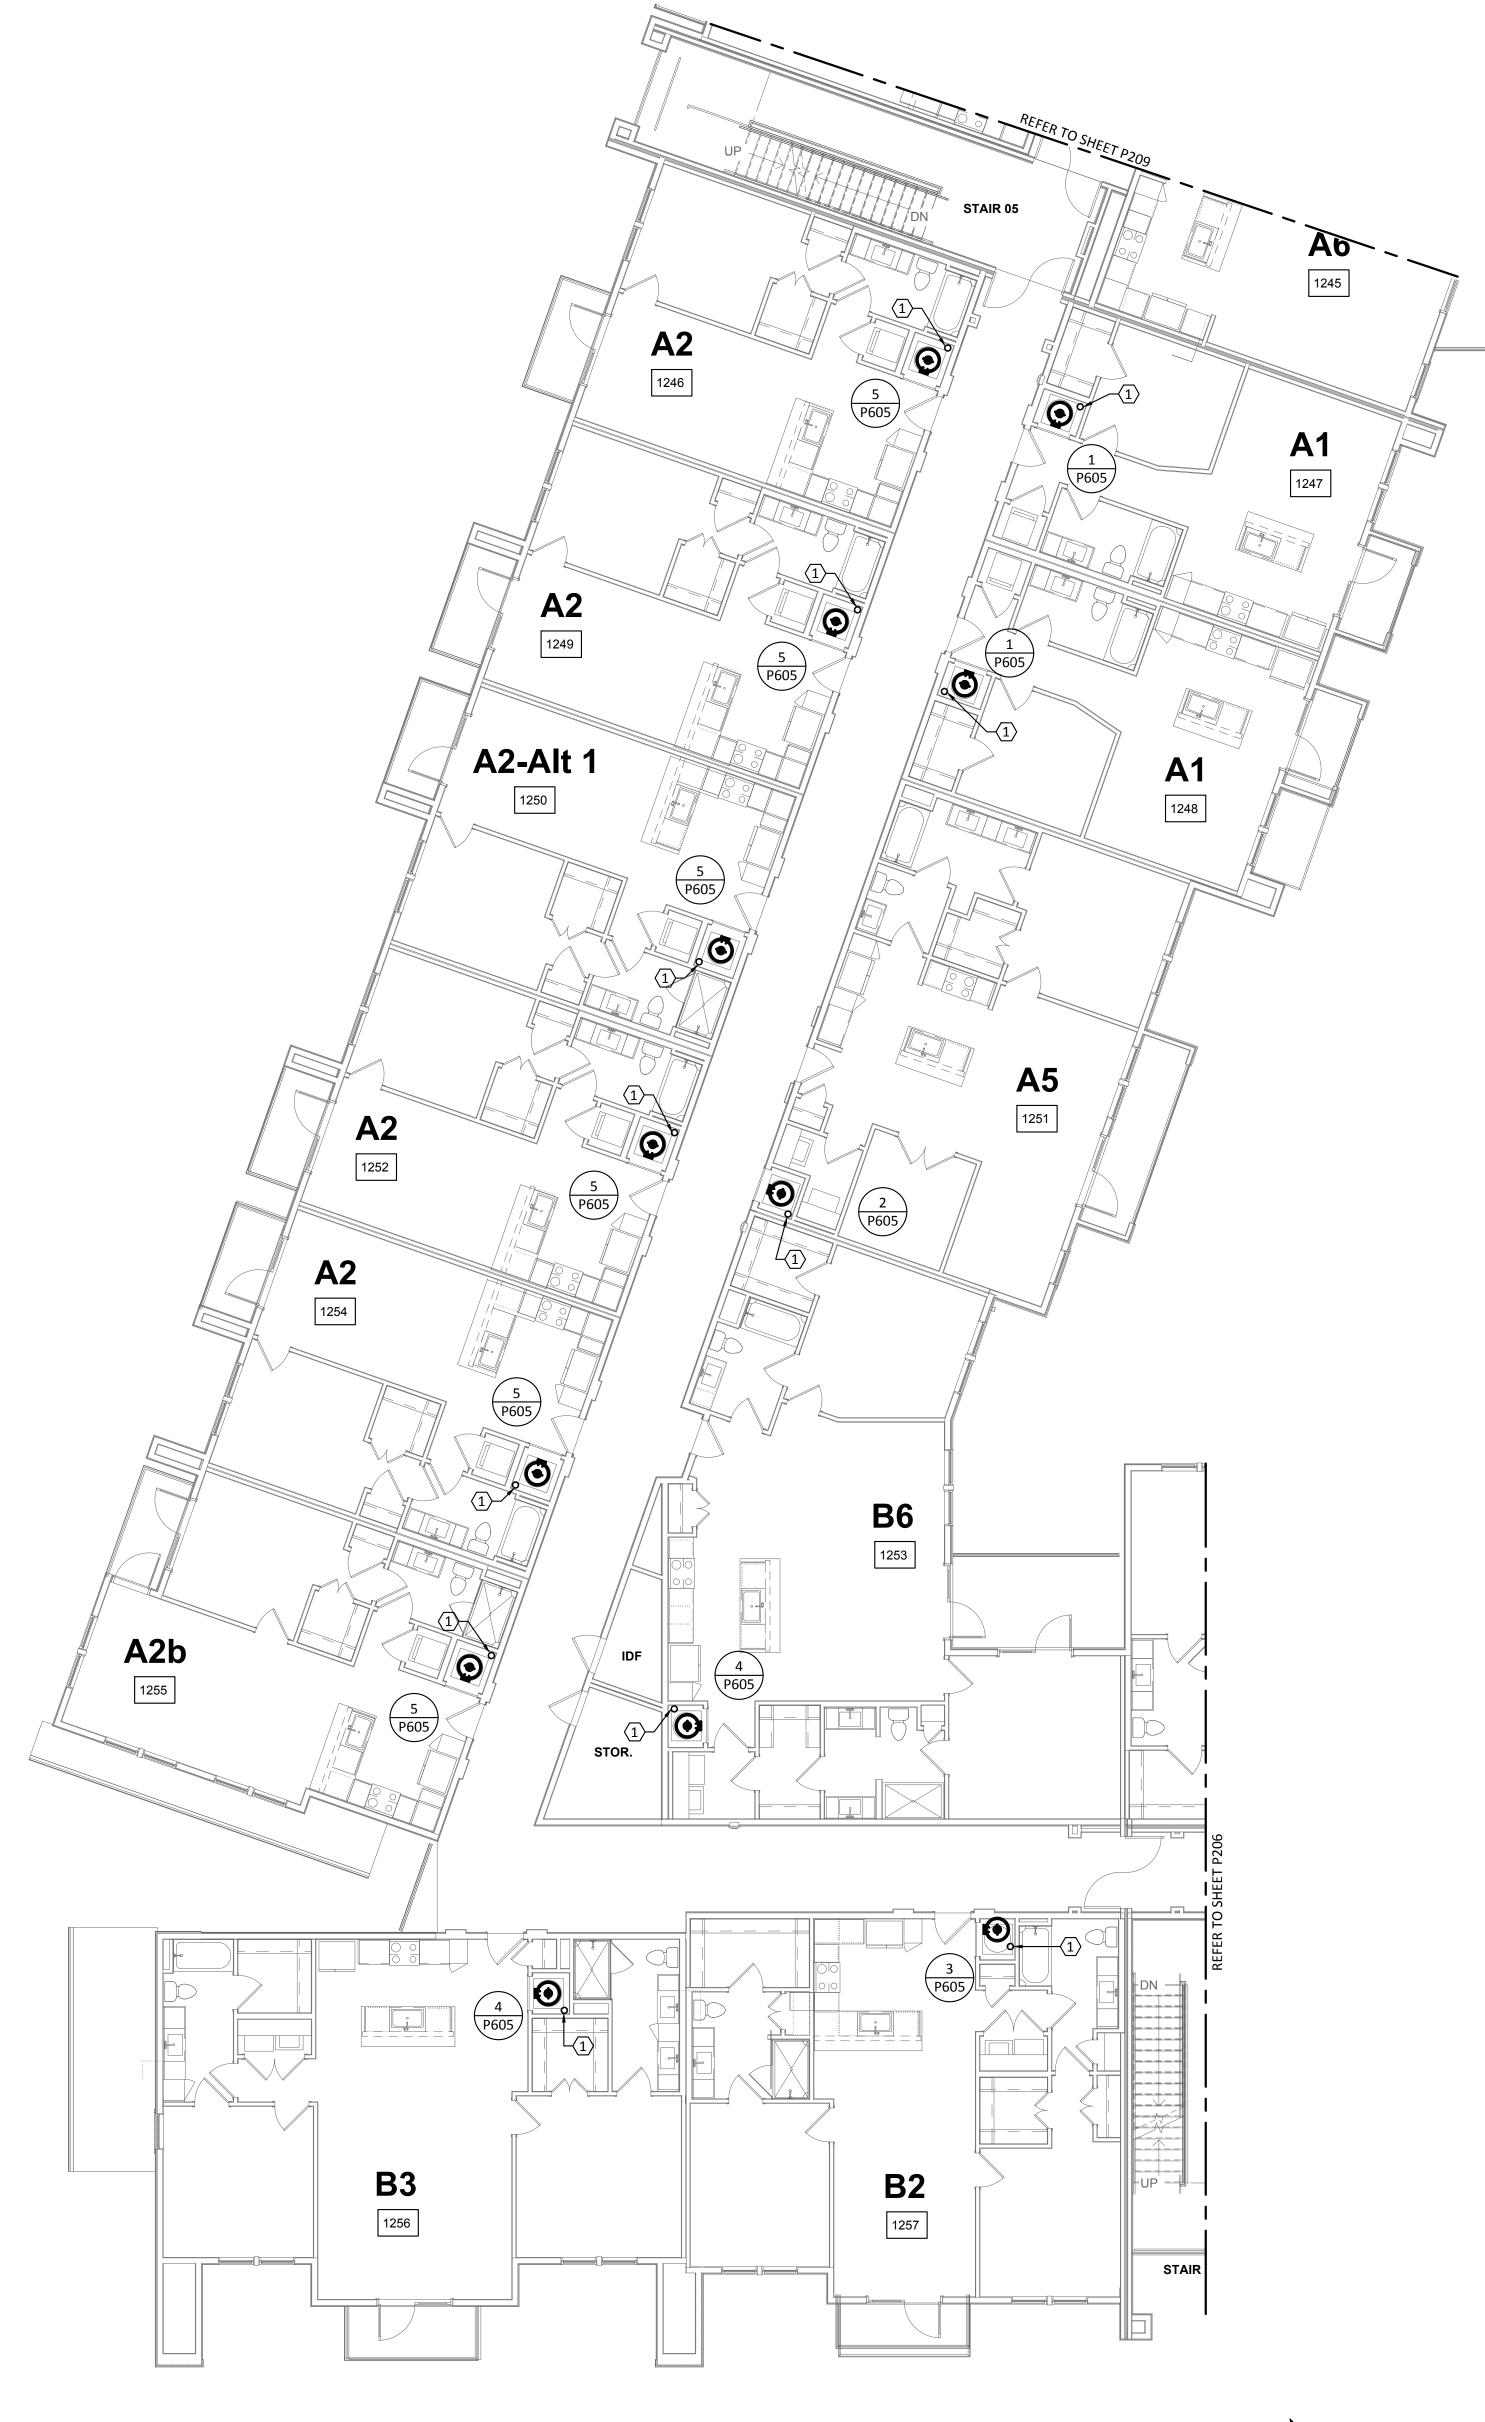

✓ PLUMBING DOMESTIC WATER - BUILDING Ie - LEVEL 2 SCALE: 1/8"=1'-0"



GENERAL NOTES:

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Structural Engineer:

VIEWTECH INC. 4205 Beltway Dr. Addison, TX 75001 Victor Lisiak III 972.661.8187

MEP Engineer:

ENCOTECH 8500 Bluffstone Cove, Austin, TX. 78759 Tessa Roberts 512.338.1101

Civil Engineer:

MBC & Associates, Inc 1035 Central Pkwy N, San Antonio, TX 78732 David Allen

Landscape Architect:

210.545.1122


LEE & Associates, Inc. 9020 N Capital of Texas Hwy, Austin, TX. 78759 Amber Rothwell

Interior Designer:

512.345.8477

SJL Design Group 921 N. Riverfront Blvd. Suite 100, Dallas, TX 75207 Cassie Farley 214.443.9090

ISSUANCES		
SCHEMATIC DESIGN	09.10.18	
DEVELOPMENT DESIGN	11.09.18	
PERMIT SET	01.28.19	
	DEVELOPMENT DESIGN	

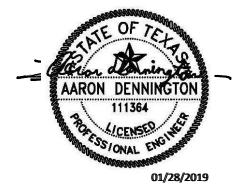

a multifamily project for NRP Group

West Cevallos San Antonio, Texas

PLUMBING DOMESTIC WATER BUILDING 1e LEVEL 2

Project Number 01/14/2018 Drawn By Checked By EEC

ENCOTECH ENGINEERING CONSULTANTS TBPE Firm | 8500 Bluffstone Cove, Suite B-103 1141 | Austin, Texas 78759 | 512.338.1101 Project No.: 18054.MS.AUS


KEY PLAN

- A. REFER TO SHEET P000 FOR GENERAL NOTES, LEGENDS, & ABBREVIATIONS.
- B. DO NOT ROUTE PIPING OVER ELECTRICAL PANELS.
- C. REFER TO WATER HEATER DETAILS FOR PIPING ROUTE, VALVES, AND ACCESSORIES.
- . ALL VALVES MUST BE ACCESSIBLE.
- INSULATE ANY WATER PIPING LOCATED IN EXTERIOR OR CORRIDOR WALLS.
- F. PLUMBING CONTRACTOR SHALL REFER TO SITE PLAN FOR EXACT ORIENTATION OF BUILDING AND LOCATION OF SPRINKLER CLOSET AND TELECOM ROOM.

KEYED NOTES:

DOMESTIC WATER RISER FROM FLOOR BELOW. REFER TO ENLARGED UNIT PLANS FOR DWELLING UNIT PIPE DISTRIBUTION. REFER TO RISER DIAGRAM FOR VERTICAL PIPE SIZES.



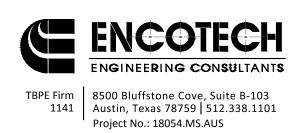



Structural Engineer:

VIEWTECH INC. 4205 Beltway Dr. Addison, TX 75001 Victor Lisiak III 972.661.8187

MEP Engineer:

ENCOTECH 8500 Bluffstone Cove, Austin, TX. 78759 Tessa Roberts 512.338.1101

Civil Engineer:

MBC & Associates, Inc 1035 Central Pkwy N, San Antonio, TX 78732 David Allen 210.545.1122

Landscape Architect:


LEE & Associates, Inc. 9020 N Capital of Texas Hwy, Austin, TX. 78759 Amber Rothwell 512.345.8477

Interior Designer:

SJL Design Group 921 N. Riverfront Blvd. Suite 100, Dallas, TX 75207 Cassie Farley 214.443.9090

ISSUANCES		
01	SCHEMATIC DESIGN	09.10.18
02	DEVELOPMENT DESIGN	11.09.18
03	PERMIT SET	01.28.19

REVISIONS

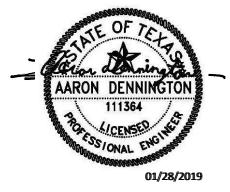

a multifamily project for NRP Group

West Cevallos
San Antonio, Texas

PLUMBING DOMESTIC WATER BUILDING 1a LEVEL 3


Project Number 18054

Date 01/14/2018

Drawn By TLR

Checked By EEC

P211

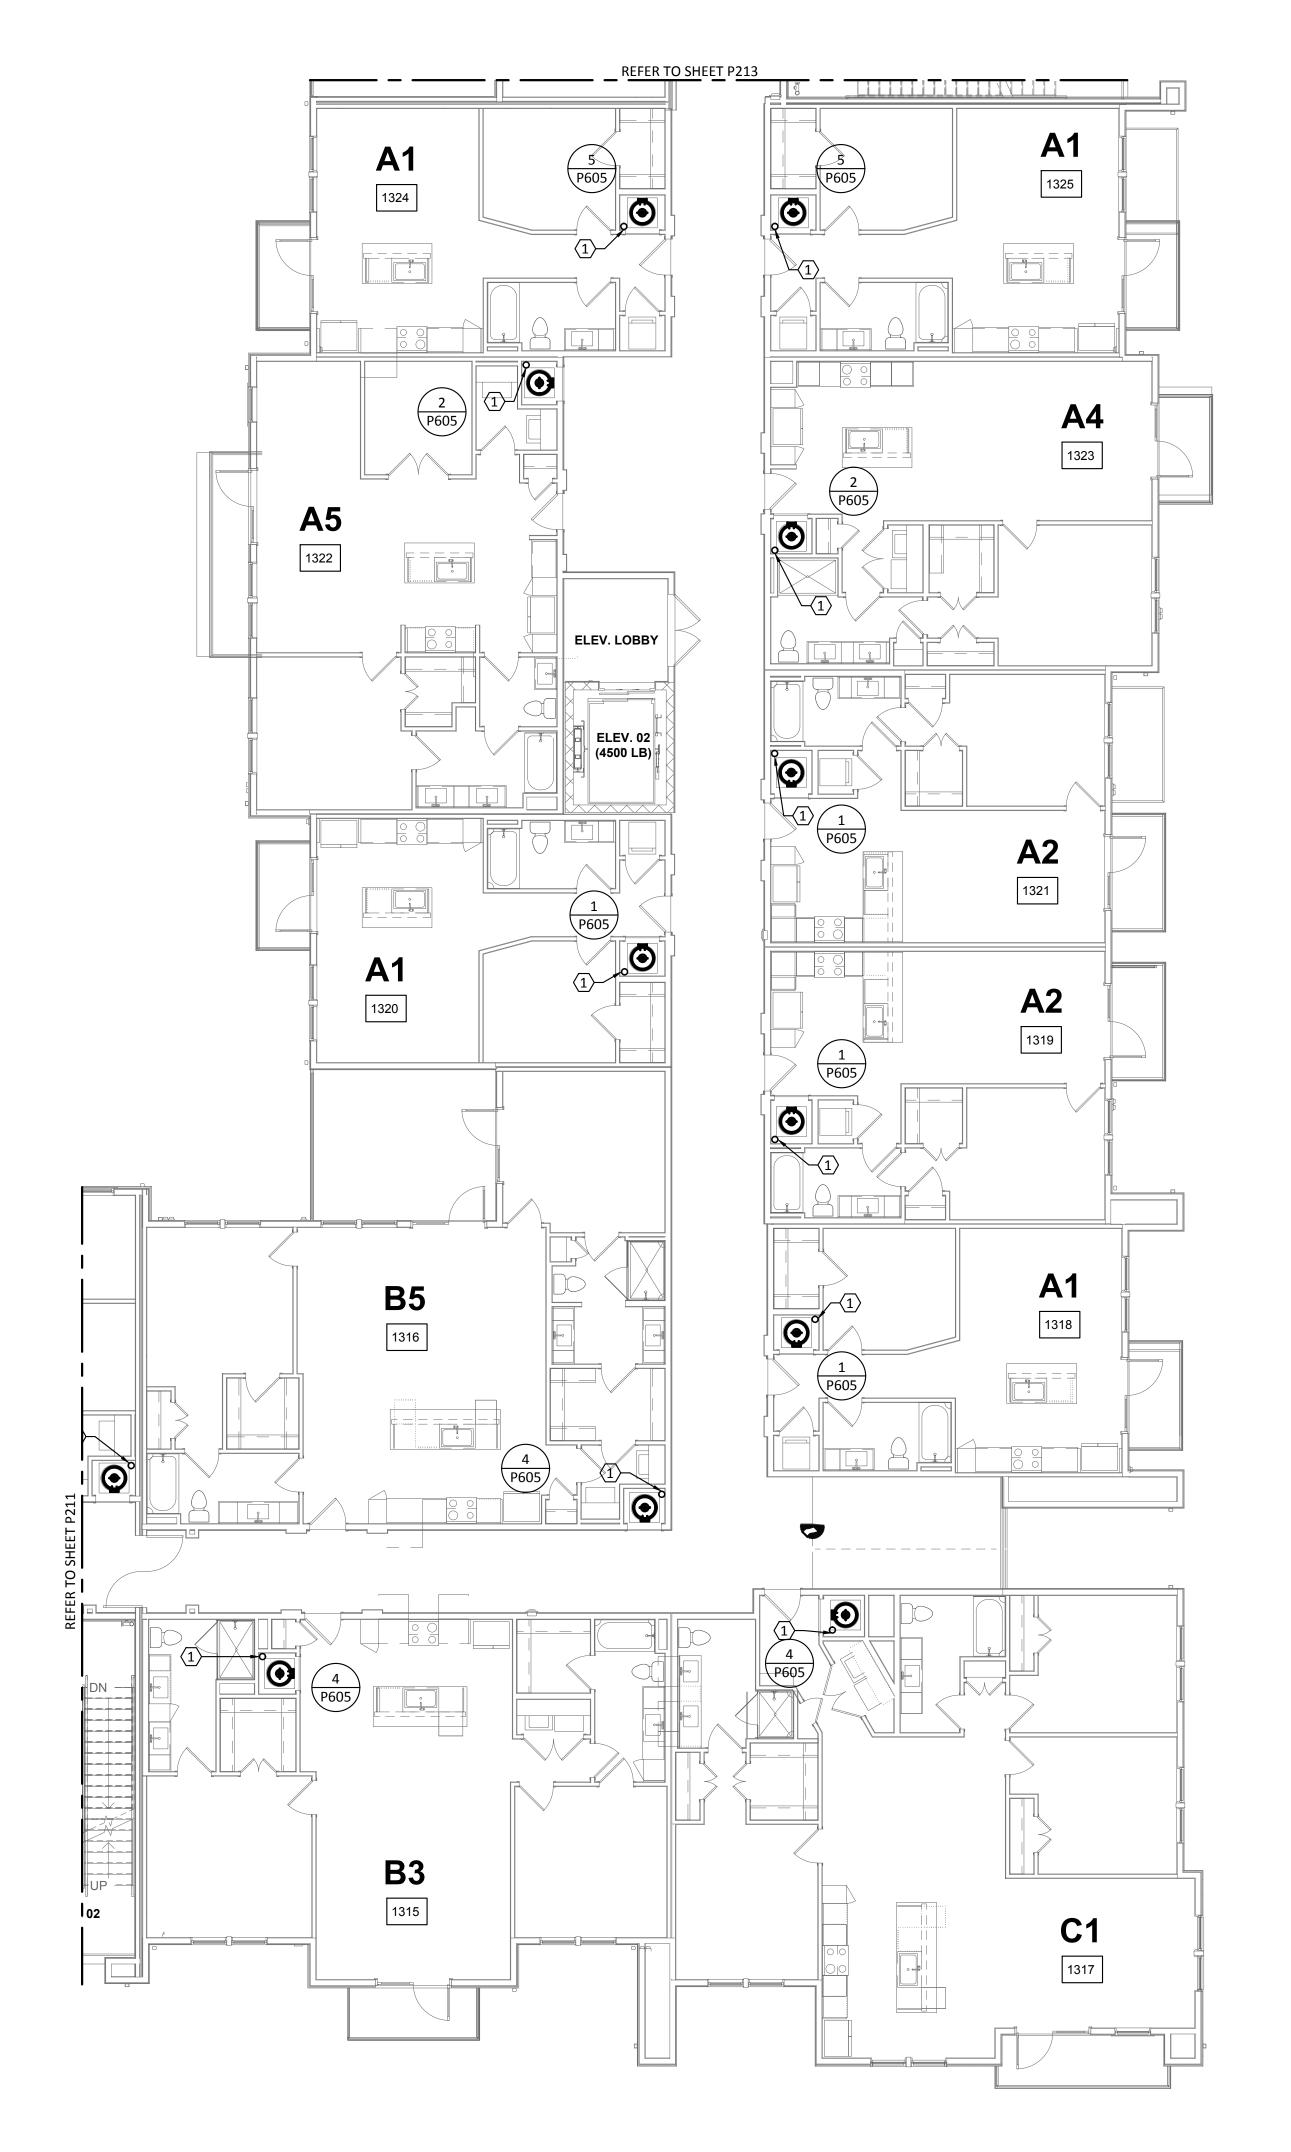

PLUMBING DOMESTIC WATER - BUILDING Ib - LEVEL 3

SCALE: 1/8"=1'-0"



- A. REFER TO SHEET POOD FOR GENERAL NOTES, LEGENDS, & ABBREVIATIONS.
- B. DO NOT ROUTE PIPING OVER ELECTRICAL PANELS.
- REFER TO WATER HEATER DETAILS FOR PIPING ROUTE, VALVES, AND ACCESSORIES.
- ALL VALVES MUST BE ACCESSIBLE.
- INSULATE ANY WATER PIPING LOCATED IN EXTERIOR OR CORRIDOR WALLS.
- PLUMBING CONTRACTOR SHALL REFER TO SITE PLAN FOR EXACT ORIENTATION OF BUILDING AND LOCATION OF SPRINKLER CLOSET AND TELECOM ROOM.

KEYED NOTES:

DOMESTIC WATER RISER FROM FLOOR BELOW. REFER TO ENLARGED UNIT PLANS FOR DWELLING UNIT PIPE DISTRIBUTION. REFER TO RISER DIAGRAM FOR VERTICAL PIPE SIZES.

DAVIES

Structural Engineer:

VIEWTECH INC. 4205 Beltway Dr. Addison, TX 75001 Victor Lisiak III 972.661.8187

MEP Engineer:

ENCOTECH 8500 Bluffstone Cove, Austin, TX. 78759 Tessa Roberts 512.338.1101

Civil Engineer:

MBC & Associates, Inc 1035 Central Pkwy N, San Antonio, TX 78732 David Allen 210.545.1122


Landscape Architect:

LEE & Associates, Inc. 9020 N Capital of Texas Hwy, Austin, TX. 78759 Amber Rothwell 512.345.8477

Interior Designer:

SJL Design Group 921 N. Riverfront Blvd. Suite 100, Dallas, TX 75207 Cassie Farley 214.443.9090

ISSUANCES		
01	SCHEMATIC DESIGN	09.10.18
02	DEVELOPMENT DESIGN	11.09.18
03	PERMIT SET	01.28.19

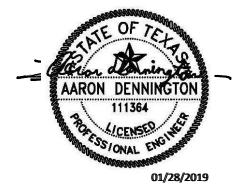

a multifamily project for NRP Group

West Cevallos San Antonio, Texas

PLUMBING DOMESTIC WATER BUILDING 1b LEVEL 3

Project Number 01/14/2018 TLR Drawn By Checked By EEC

TBPE Firm | 8500 Bluffstone Cove, Suite B-103 1141 | Austin, Texas 78759 | 512.338.1101 Project No.: 18054.MS.AUS

KEY PLAN
N.T.S.



C1 1331 **B**3 1329 **B5 A5 A1** 1326

REFER TO SHEET P212

✓ PLUMBING DOMESTIC WATER - BUILDING Ic - LEVEL 3 SCALE: 1/8"=1'-0"



GENERAL NOTES:

KEYED NOTES:

VERTICAL PIPE SIZES.

A. REFER TO SHEET P000 FOR GENERAL NOTES, LEGENDS, & ABBREVIATIONS.

REFER TO WATER HEATER DETAILS FOR PIPING ROUTE, VALVES, AND ACCESSORIES.

PLUMBING CONTRACTOR SHALL REFER TO SITE PLAN FOR EXACT ORIENTATION OF

DOMESTIC WATER RISER FROM FLOOR BELOW. REFER TO ENLARGED UNIT PLANS


INSULATE ANY WATER PIPING LOCATED IN EXTERIOR OR CORRIDOR WALLS.

BUILDING AND LOCATION OF SPRINKLER CLOSET AND TELECOM ROOM.

FOR DWELLING UNIT PIPE DISTRIBUTION. REFER TO RISER DIAGRAM FOR

B. DO NOT ROUTE PIPING OVER ELECTRICAL PANELS.

. ALL VALVES MUST BE ACCESSIBLE.

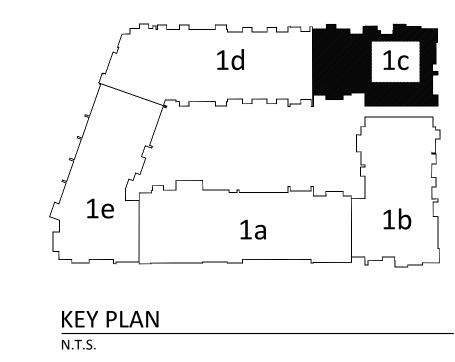



COLLABORATIVE 3607 S Lamar Blvd, Suite 103 Austin, Texas 78704 512.852.4310

Structural Engineer:

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MEP Engineer:

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Civil Engineer:

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MBC & Associates, Inc 1035 Central Pkwy N, San Antonio, TX 78732 David Allen

Landscape Architect:


LEE & Associates, Inc. 9020 N Capital of Texas Hwy, Austin, TX. 78759 Amber Rothwell

Interior Designer:

512.345.8477

SJL Design Group 921 N. Riverfront Blvd. Suite 100, Dallas, TX 75207 Cassie Farley 214.443.9090

ISSUANCES		
01	SCHEMATIC DESIGN	09.10.18
02	DEVELOPMENT DESIGN	11.09.18
03	PERMIT SET	01.28.19

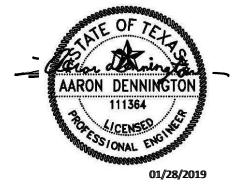

a multifamily project for NRP Group

West Cevallos San Antonio, Texas


PLUMBING DOMESTIC WATER BUILDING 1c LEVEL 3

Project Number 01/14/2018 Drawn By TLR Checked By EEC

- A. REFER TO SHEET P000 FOR GENERAL NOTES, LEGENDS, & ABBREVIATIONS.
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- PLUMBING CONTRACTOR SHALL REFER TO SITE PLAN FOR EXACT ORIENTATION OF BUILDING AND LOCATION OF SPRINKLER CLOSET AND TELECOM ROOM.


KEYED NOTES:

DOMESTIC WATER RISER FROM FLOOR BELOW. REFER TO ENLARGED UNIT PLANS FOR DWELLING UNIT PIPE DISTRIBUTION. REFER TO RISER DIAGRAM FOR VERTICAL PIPE SIZES.

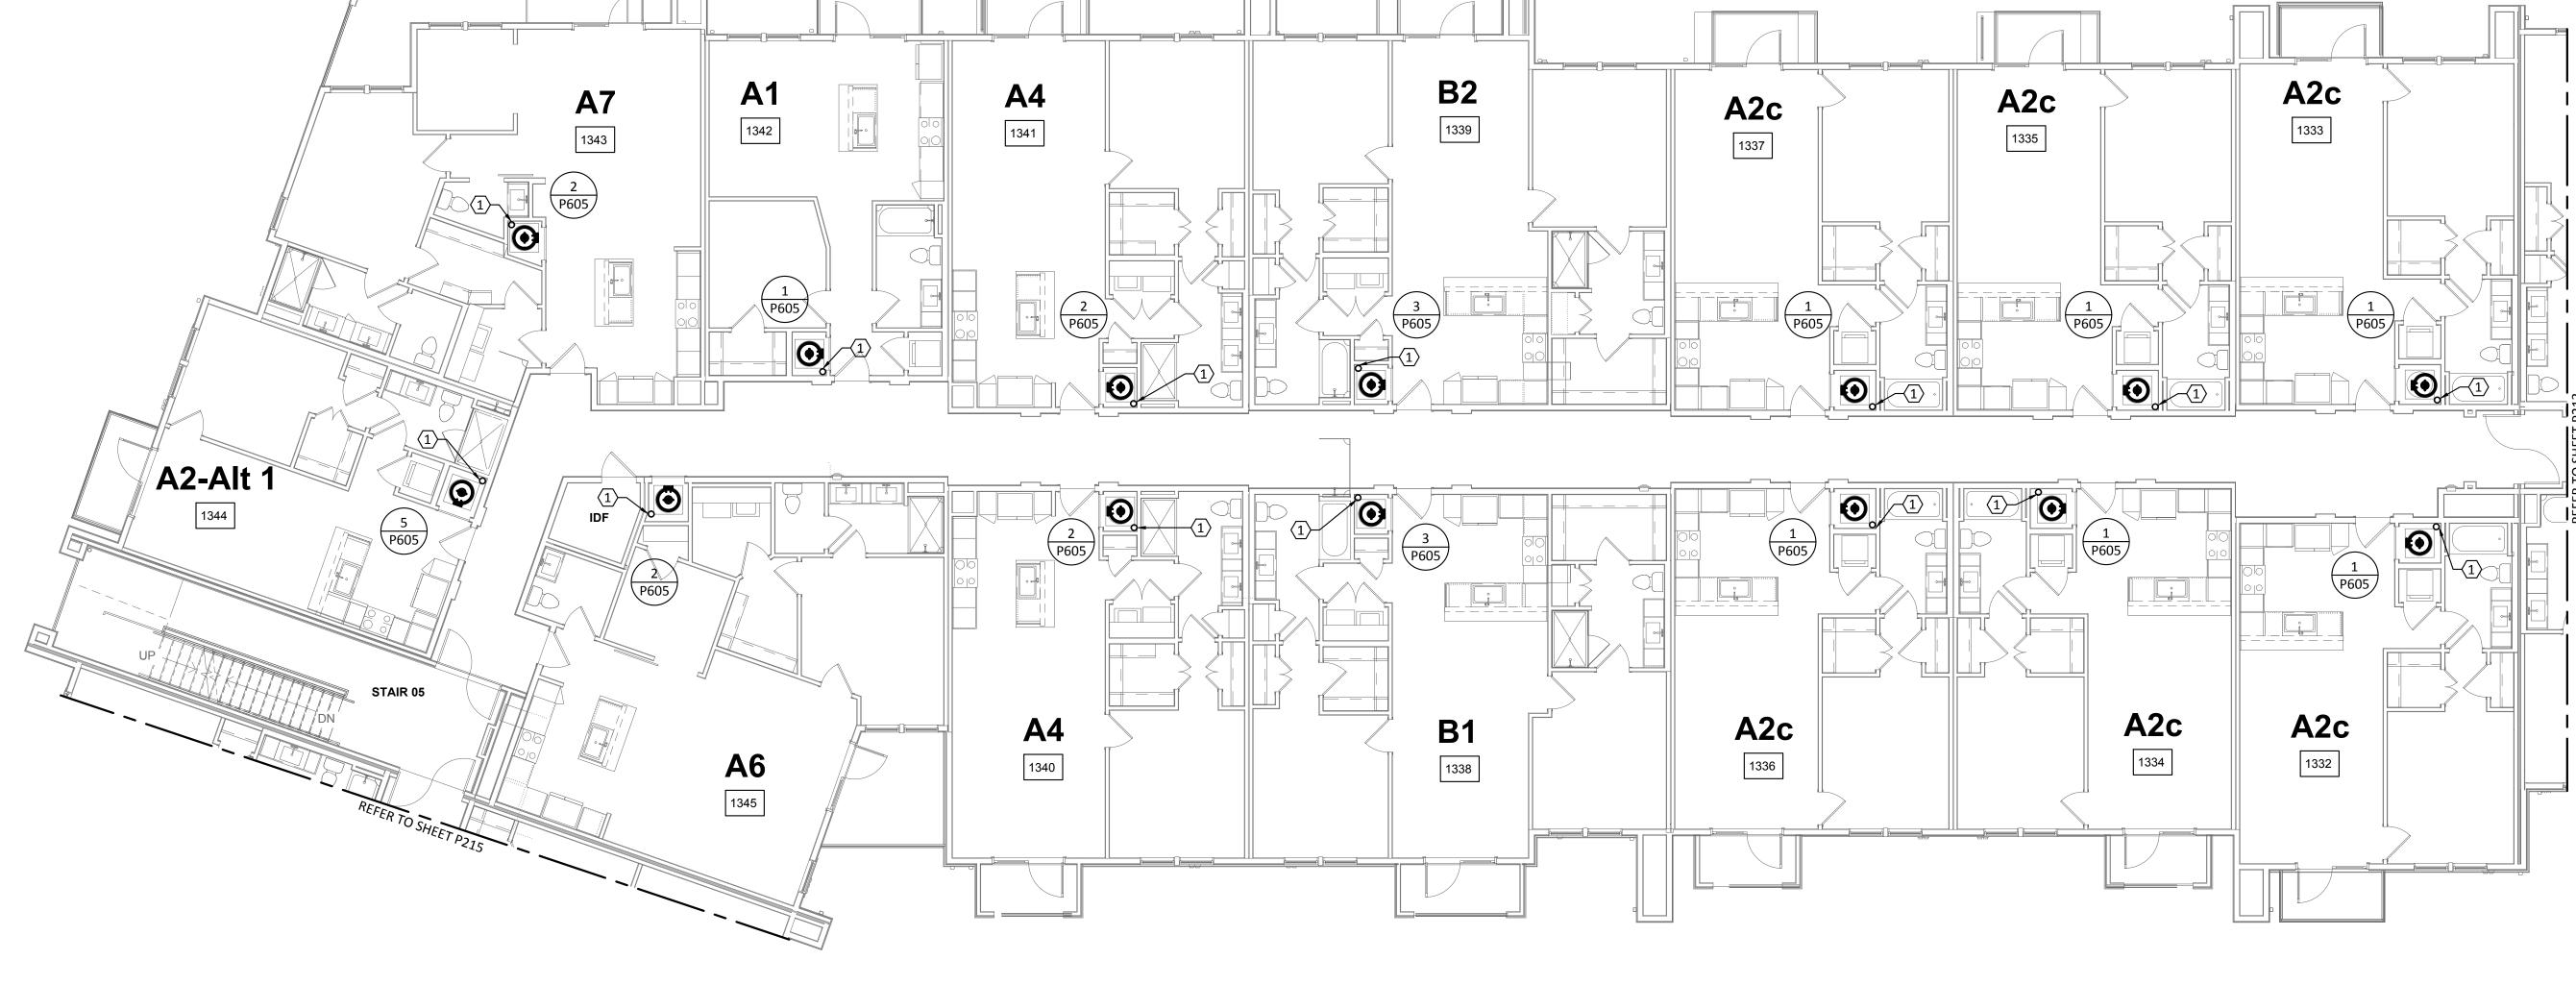

PLUMBING DOMESTIC WATER - BUILDING Id - LEVEL 3

SCALE: 1/8"=1'-0"

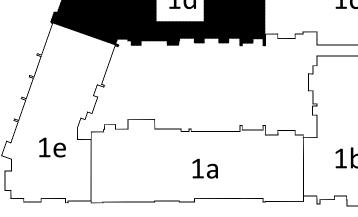

KEY PLAN
N.T.S.





Structural Engineer:

VIEWTECH INC. 4205 Beltway Dr. Addison, TX 75001 Victor Lisiak III 972.661.8187

MEP Engineer:

ENCOTECH 8500 Bluffstone Cove, Austin, TX. 78759 Tessa Roberts 512.338.1101

Civil Engineer:

MBC & Associates, Inc 1035 Central Pkwy N, San Antonio, TX 78732 David Allen 210.545.1122


Landscape Architect:

LEE & Associates, Inc. 9020 N Capital of Texas Hwy, Austin, TX. 78759 Amber Rothwell 512.345.8477

Interior Designer:

SJL Design Group 921 N. Riverfront Blvd. Suite 100, Dallas, TX 75207 Cassie Farley 214.443.9090

ISSUANCES		
01	SCHEMATIC DESIGN	09.10.18
02	DEVELOPMENT DESIGN	11.09.18
03	PERMIT SET	01.28.19

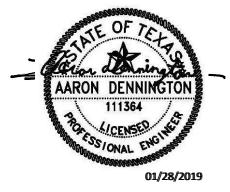


a multifamily project for NRP Group

West Cevallos San Antonio, Texas

PLUMBING DOMESTIC WATER BUILDING 1d LEVEL 3

Project Number	18054
Date	01/14/2018
Drawn By	TLR
Checked By	EEC

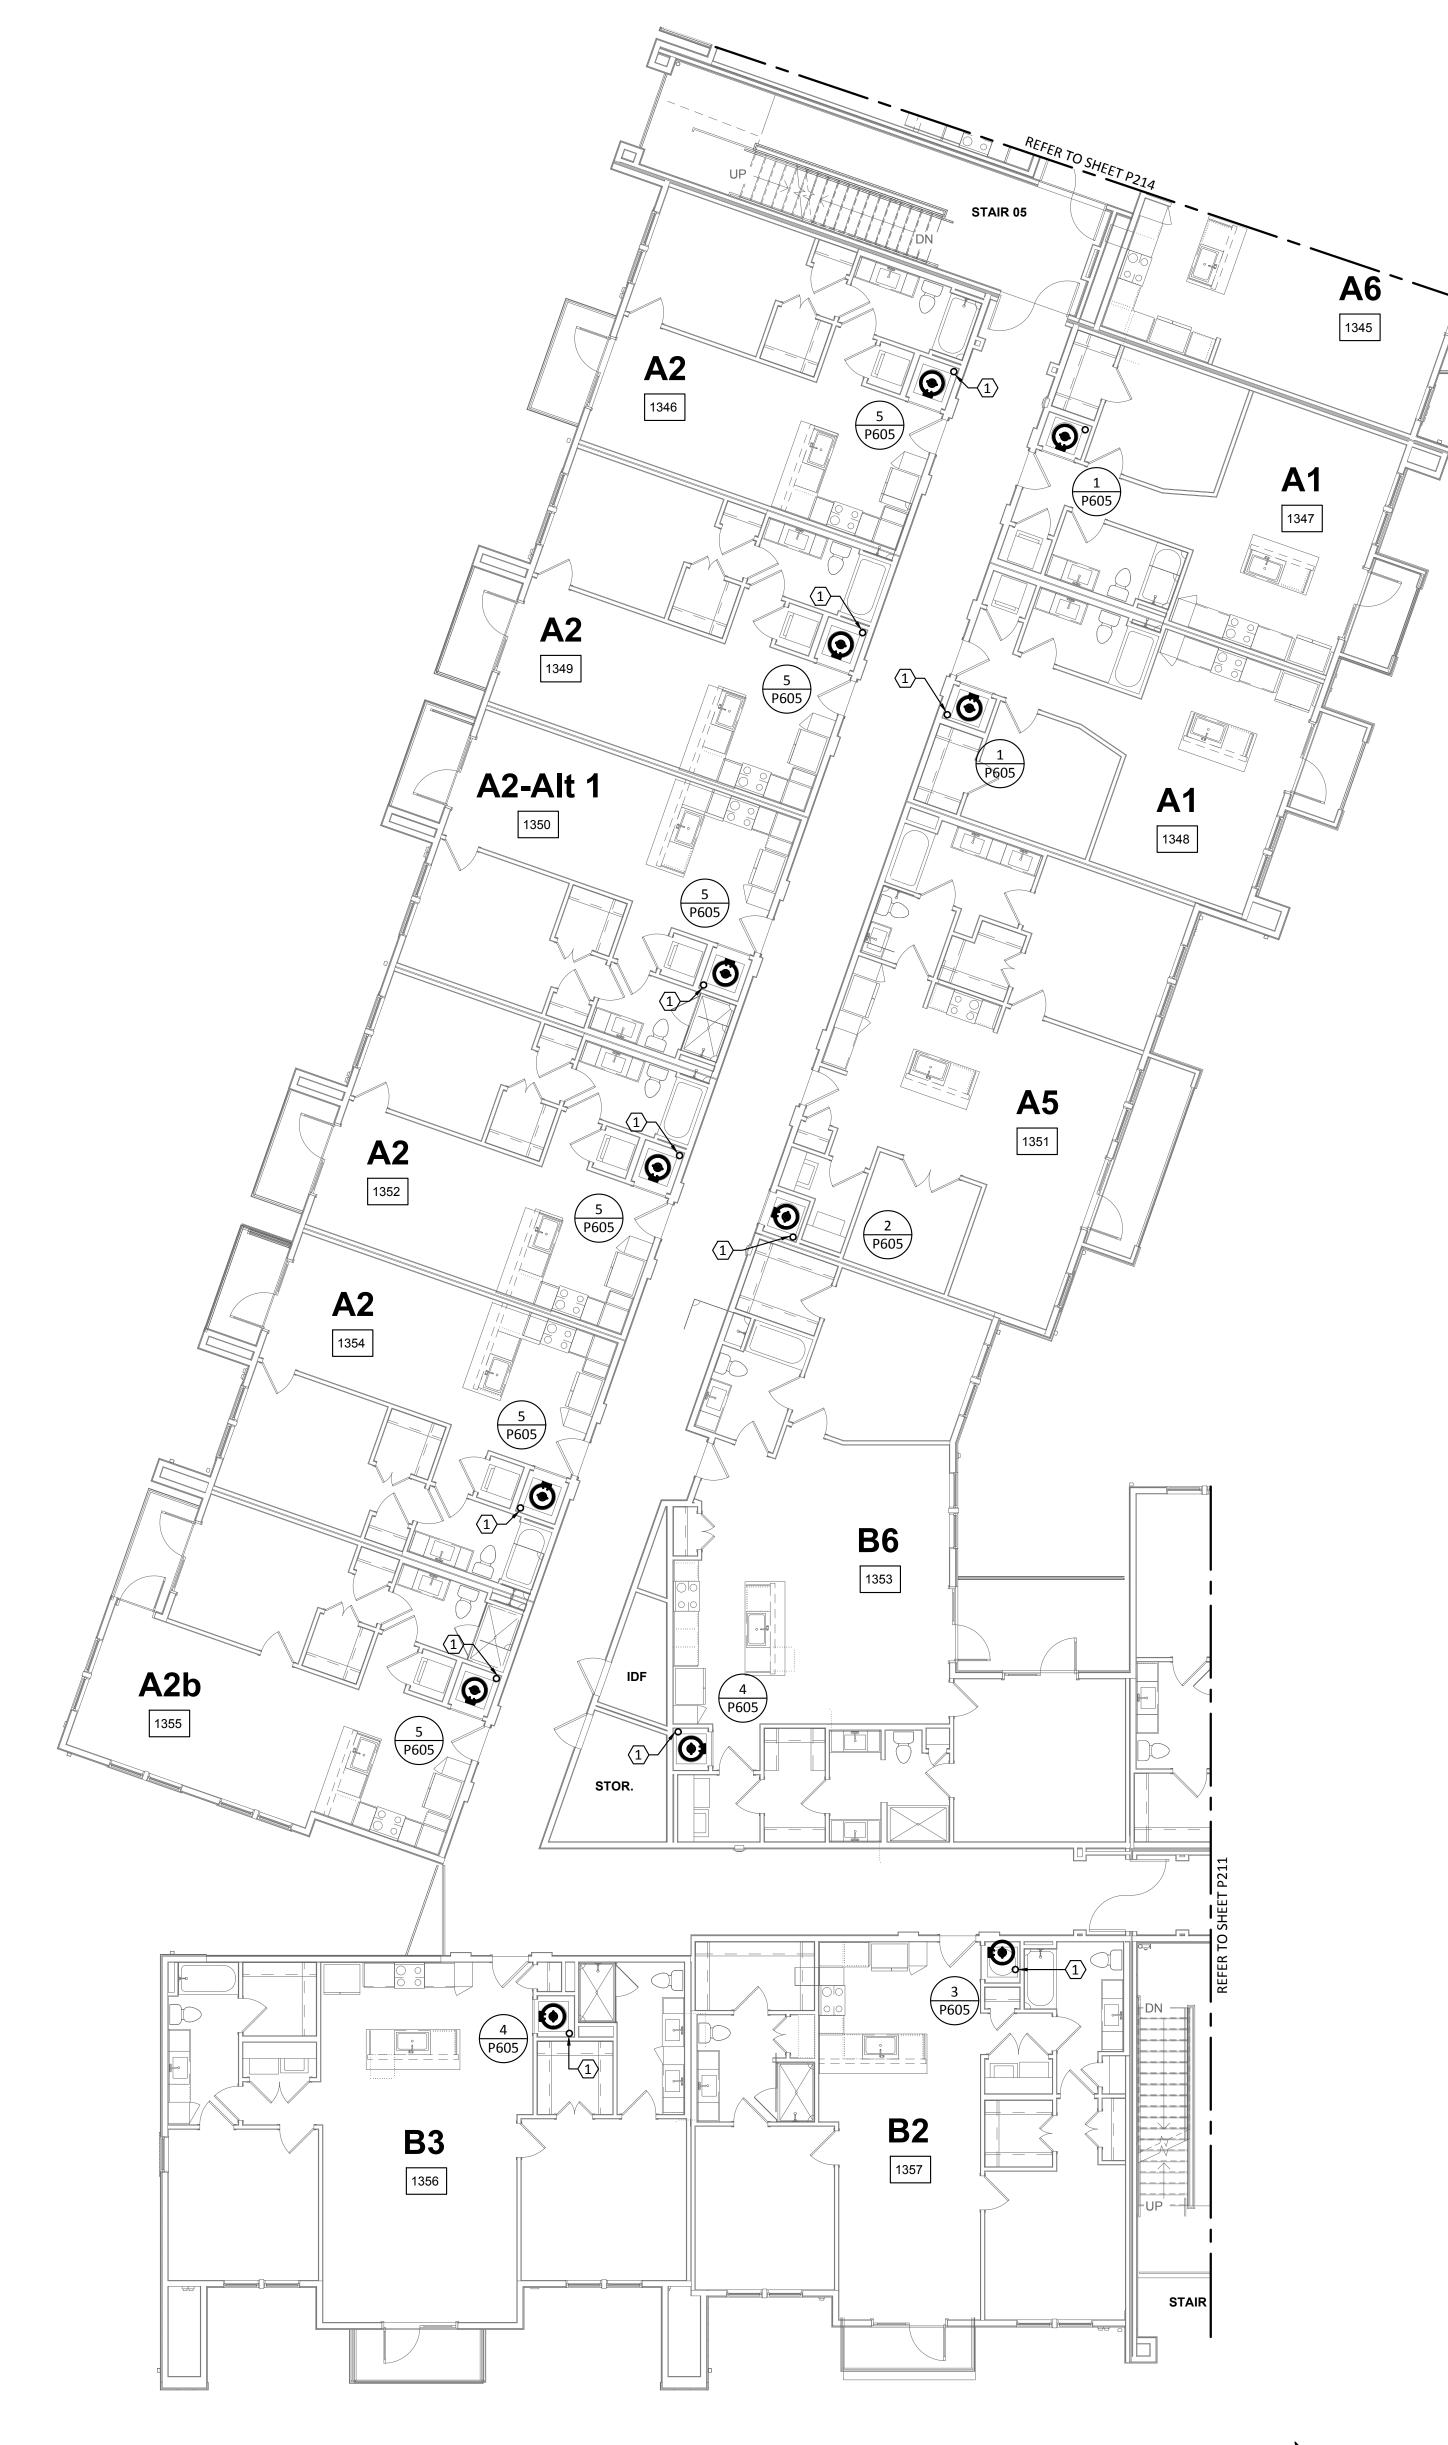

PLUMBING DOMESTIC WATER - BUILDING le - LEVEL 3

SCALE: 1/8"=1'-0"



GENERAL NOTES:

- A. REFER TO SHEET P000 FOR GENERAL NOTES, LEGENDS, & ABBREVIATIONS.
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- C. REFER TO WATER HEATER DETAILS FOR PIPING ROUTE, VALVES, AND ACCESSORIES.
- . ALL VALVES MUST BE ACCESSIBLE.
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KEYED NOTES:

DOMESTIC WATER RISER FROM FLOOR BELOW. REFER TO ENLARGED UNIT PLANS FOR DWELLING UNIT PIPE DISTRIBUTION. REFER TO RISER DIAGRAM FOR VERTICAL PIPE SIZES.

NOTES, LEGENDS, & ABBREVIATIONS.

COLLABORATIVE 2027 S Lange Plad Suite 402

Or 3 Lamar Blvd, Suite 103 Austin, Texas 70704

Structural Engineer:

VIEWTECH INC. 4205 Beltway Dr. Addison, TX 75001 Victor Lisiak III 972.661.8187

MEP Engineer:

ENCOTECH 8500 Bluffstone Cove, Austin, TX. 78759 Tessa Roberts 512.338.1101

Civil Engineer:

210.545.1122

MBC & Associates, Inc 1035 Central Pkwy N, San Antonio, TX 78732 David Allen

Landscape Architect:

LEE & Associates, Inc. 9020 N Capital of Texas Hwy, Austin, TX. 78759 Amber Rothwell

Interior Designer:

512.345.8477

SJL Design Group 921 N. Riverfront Blvd. Suite 100, Dallas, TX 75207 Cassie Farley 214.443.9090

ISSUANCES		
01	SCHEMATIC DESIGN	09.10.18
02	DEVELOPMENT DESIGN	11.09.18
03	PERMIT SET	01.28.19

REVISIONS



a multifamily project for NRP Group

West Cevallos
San Antonio, Texas

PLUMBING DOMESTIC WATER BUILDING 1e LEVEL 3

Project Number 18054

Date 01/14/2018

Drawn By TLR

Checked By EEC

P215


TBPE Firm 1141 8500 Bluffstone Cove, Suite B-103 Austin, Texas 78759 512.338.1101 Project No.: 18054.MS.AUS

KEY PLAN

- A. REFER TO SHEET P000 FOR GENERAL NOTES, LEGENDS, & ABBREVIATIONS.
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DOMESTIC WATER RISER FROM FLOOR BELOW. REFER TO ENLARGED UNIT PLANS FOR DWELLING UNIT PIPE DISTRIBUTION. REFER TO RISER DIAGRAM FOR VERTICAL PIPE SIZES.



TBPE Firm 1141 8500 Bluffstone Cove, Suite B-103 Austin, Texas 78759 | 512.338.1101 Project No.: 18054.MS.AUS

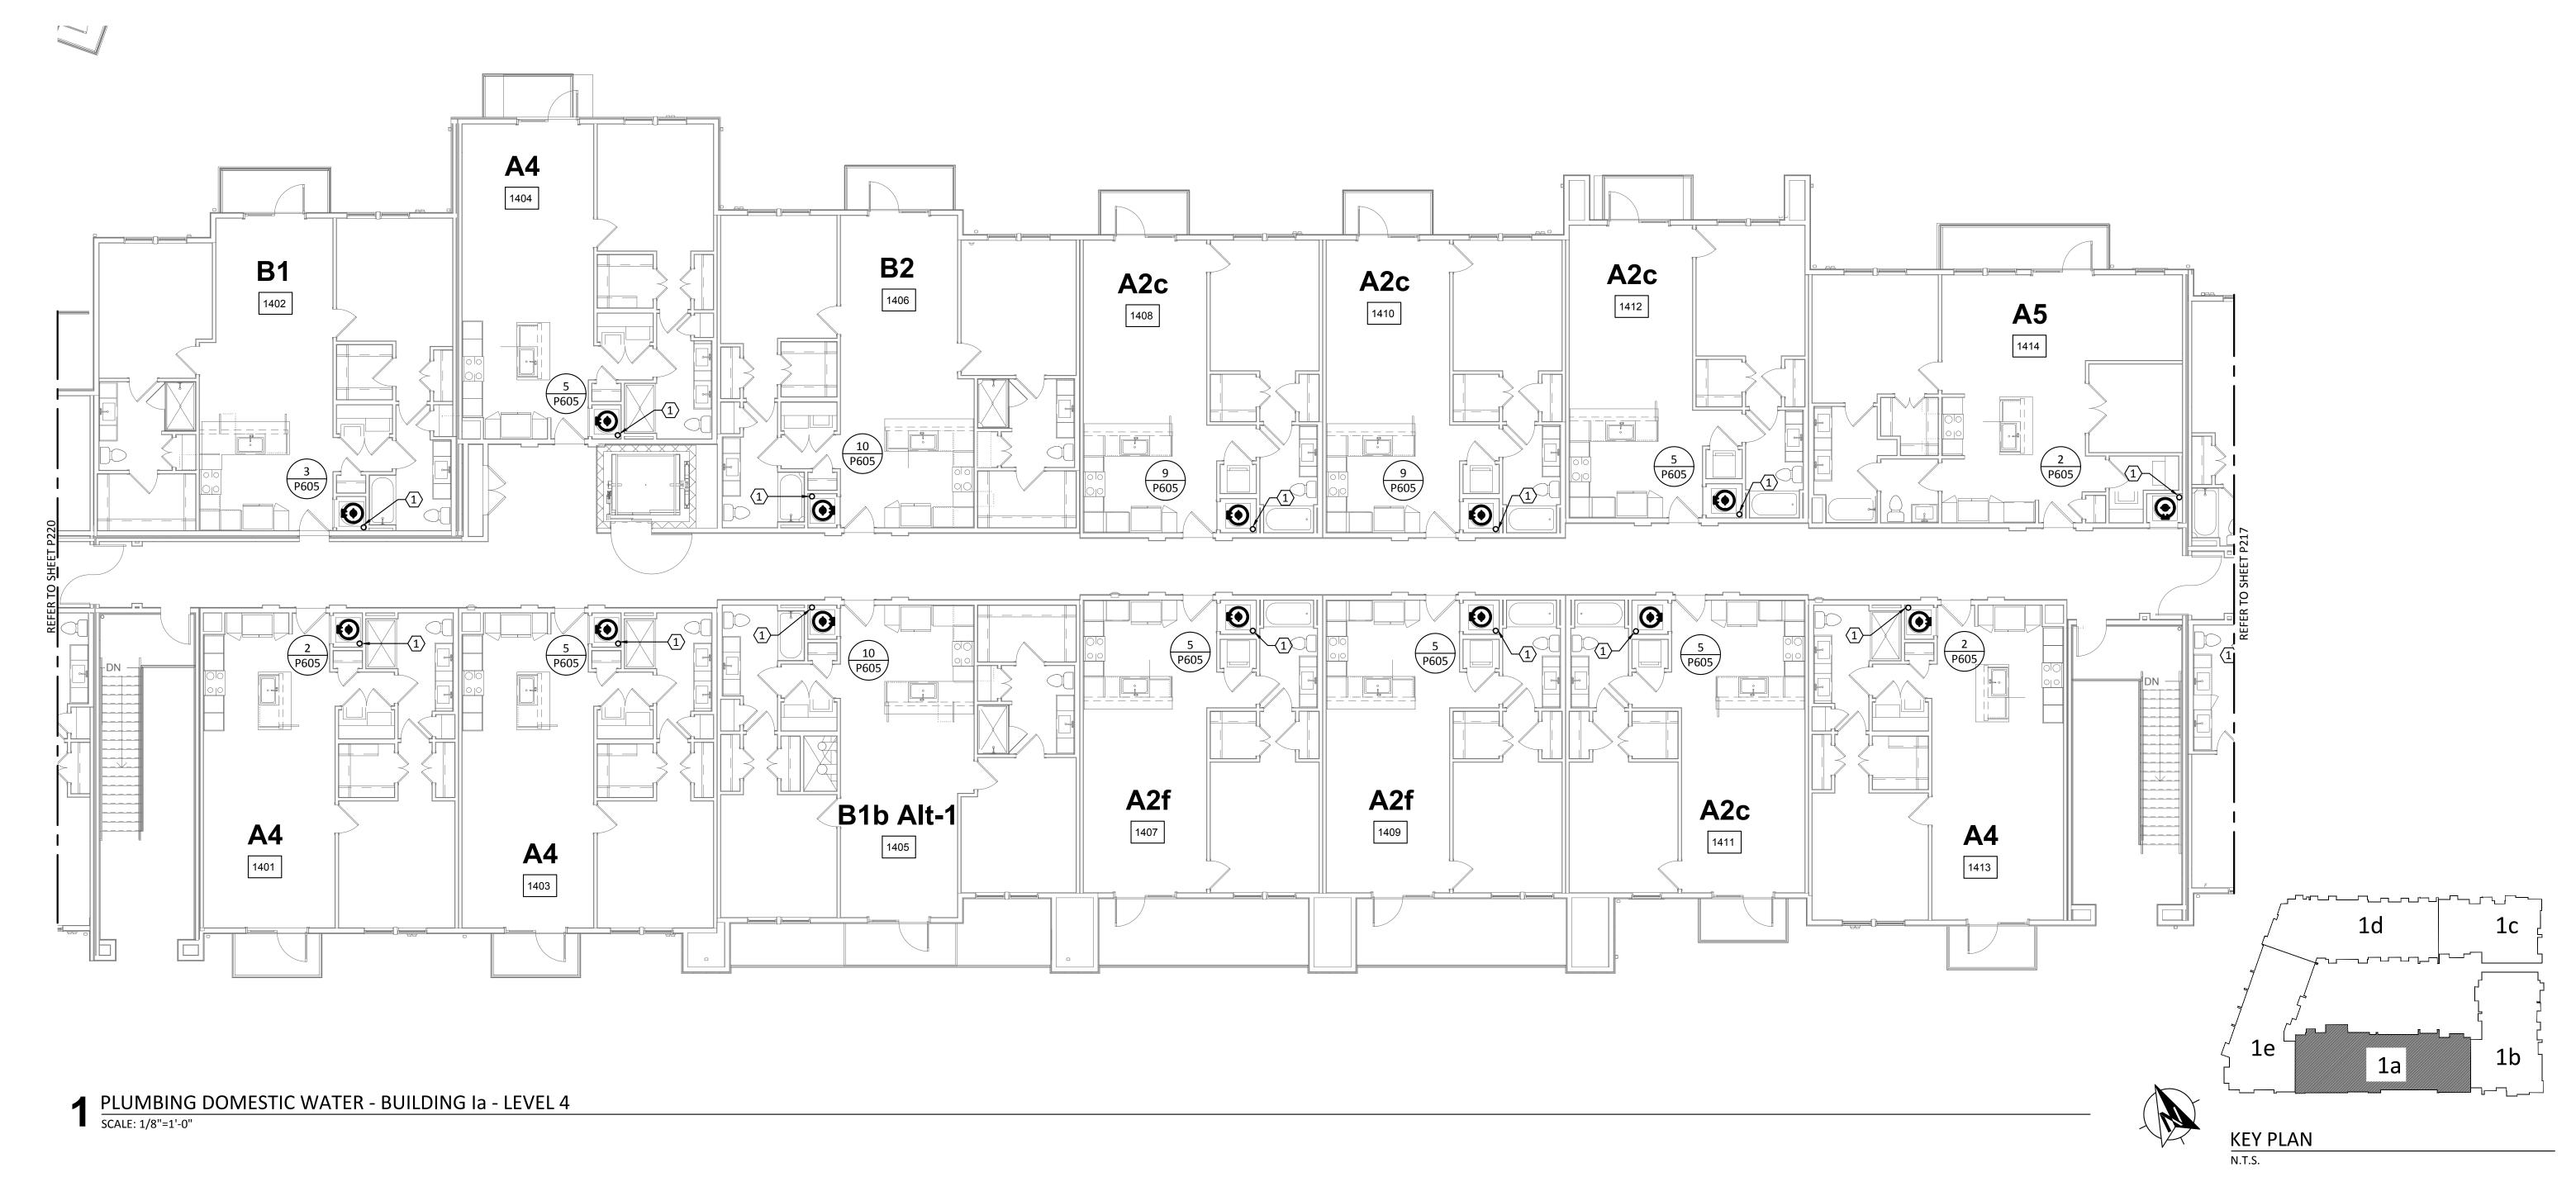

Structural Engineer:

VIEWTECH INC. 4205 Beltway Dr. Addison, TX 75001 Victor Lisiak III 972.661.8187

MEP Engineer:

ENCOTECH 8500 Bluffstone Cove, Austin, TX. 78759 Tessa Roberts 512.338.1101

Civil Engineer:

MBC & Associates, Inc 1035 Central Pkwy N, San Antonio, TX 78732 David Allen 210.545.1122

Landscape Architect:

LEE & Associates, Inc. 9020 N Capital of Texas Hwy, Austin, TX. 78759 Amber Rothwell 512.345.8477

Interior Designer:

SJL Design Group 921 N. Riverfront Blvd. Suite 100, Dallas, TX 75207 Cassie Farley 214.443.9090

ISSUANCES		
01	SCHEMATIC DESIGN	09.10.18
02	DEVELOPMENT DESIGN	11.09.18
03	PERMIT SET	01.28.19

REVISIONS




a multifamily project for NRP Group

West Cevallos
San Antonio, Texas

PLUMBING DOMESTIC WATER BUILDING 1a LEVEL 4

Project Number	18054
Date	01/14/2018
Drawn By	TLR
Checked By	EEC

P216

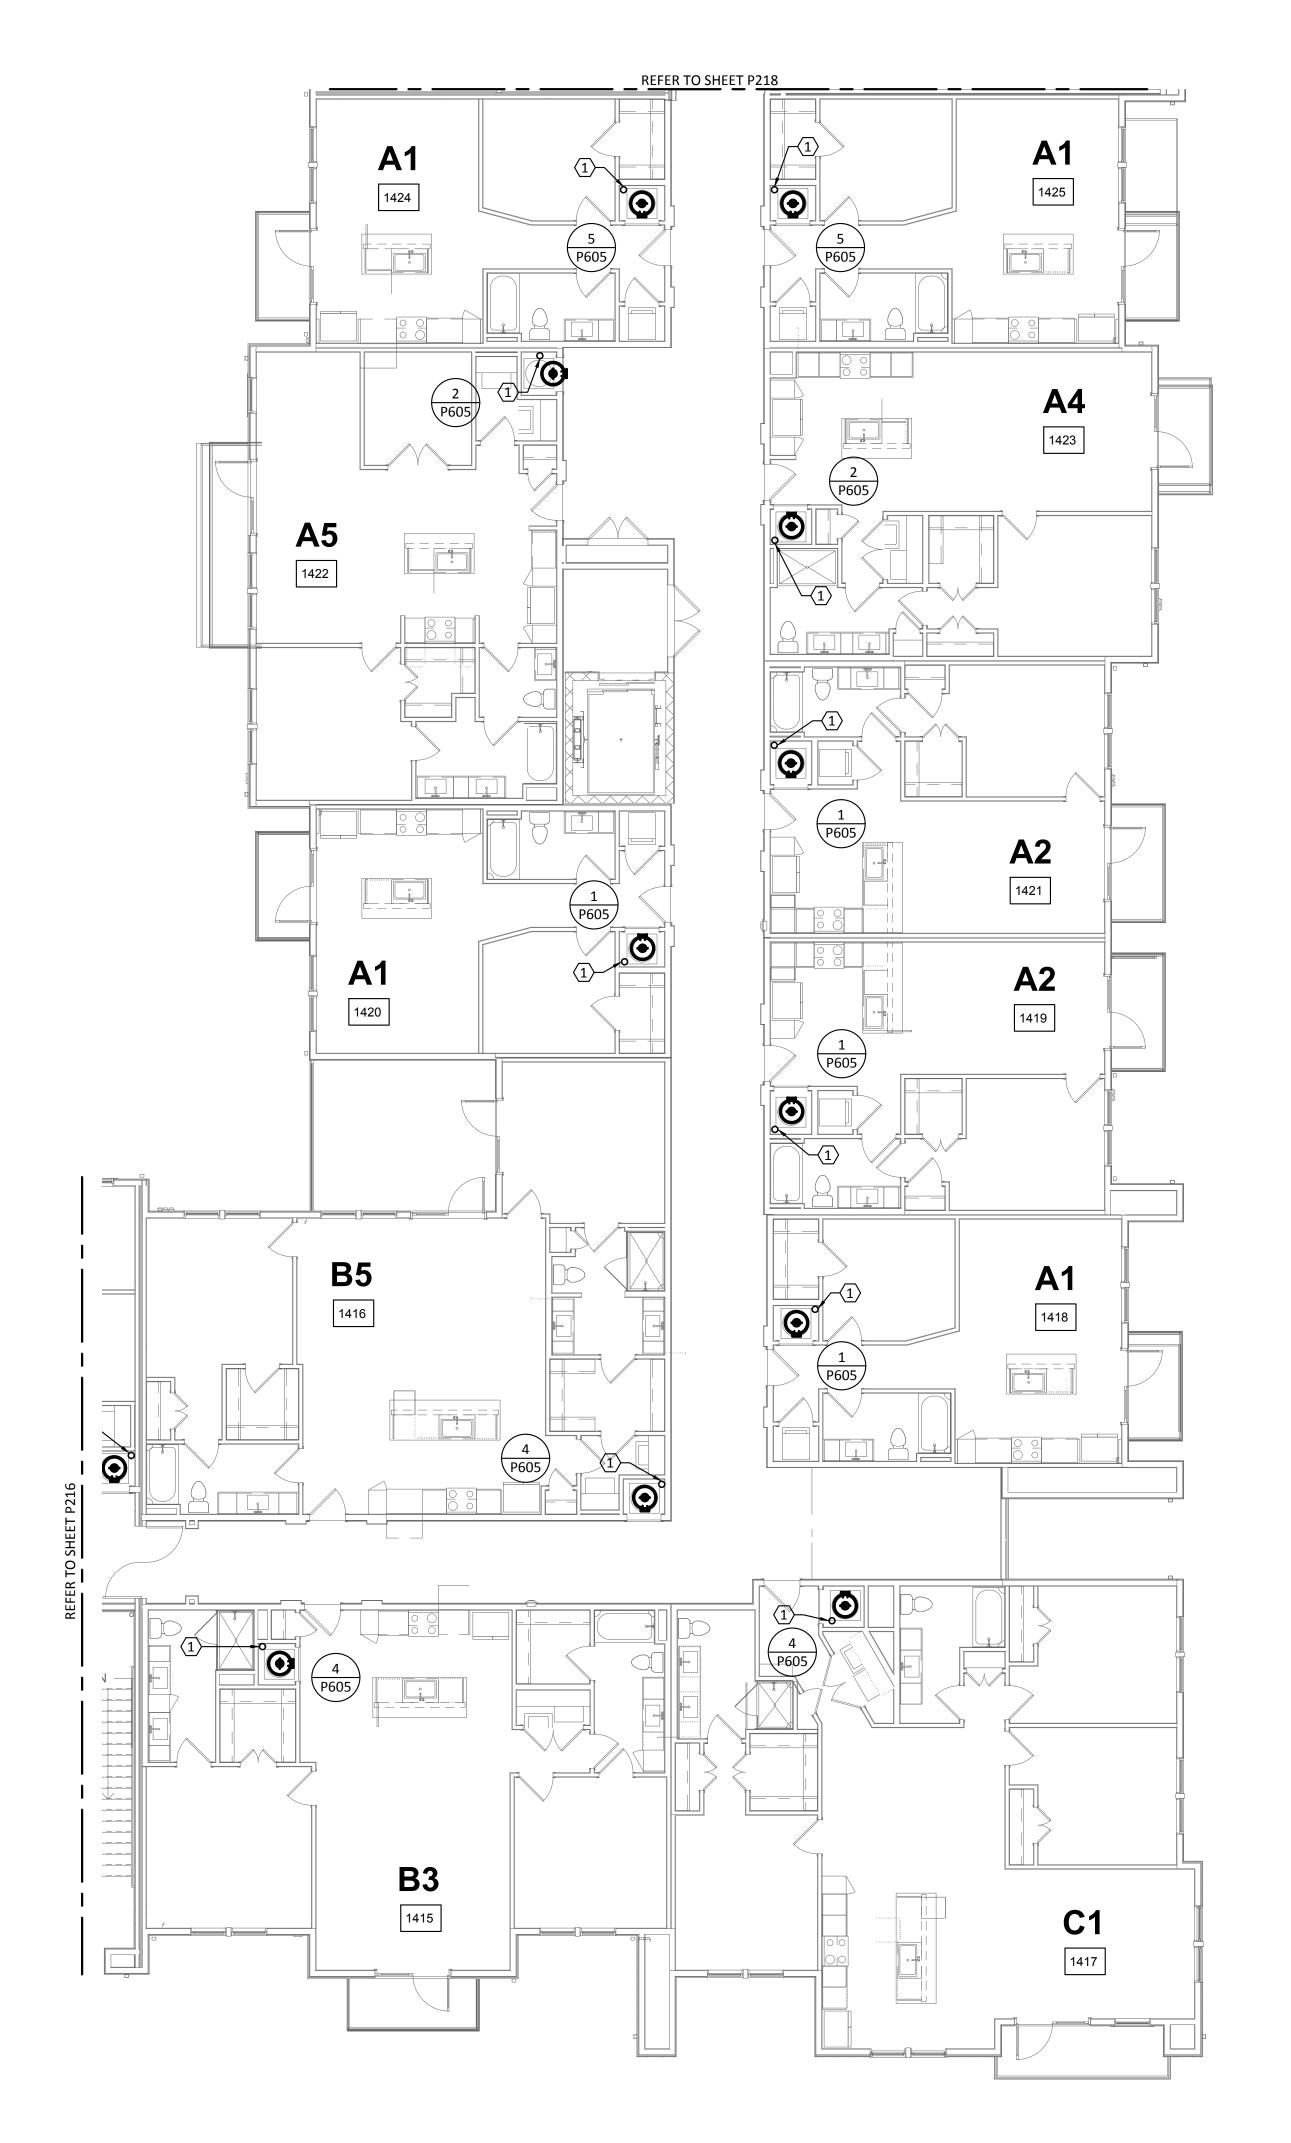

PLUMBING DOMESTIC WATER - BUILDING Ib - LEVEL 4

SCALE: 1/8"=1'-0"



GENERAL NOTES:

A. REFER TO SHEET P000 FOR GENERAL NOTES, LEGENDS, & ABBREVIATIONS.

B. DO NOT ROUTE PIPING OVER ELECTRICAL PANELS.

- REFER TO WATER HEATER DETAILS FOR PIPING ROUTE, VALVES, AND ACCESSORIES.
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- PLUMBING CONTRACTOR SHALL REFER TO SITE PLAN FOR EXACT ORIENTATION OF BUILDING AND LOCATION OF SPRINKLER CLOSET AND TELECOM ROOM.

KEYED NOTES:

DOMESTIC WATER RISER FROM FLOOR BELOW. REFER TO ENLARGED UNIT PLANS FOR DWELLING UNIT PIPE DISTRIBUTION. REFER TO RISER DIAGRAM FOR VERTICAL PIPE SIZES.



Structural Engineer:

VIEWTECH INC. 4205 Beltway Dr. Addison, TX 75001 Victor Lisiak III

MEP Engineer:

972.661.8187

ENCOTECH 8500 Bluffstone Cove, Austin, TX. 78759 Tessa Roberts

Civil Engineer:

512.338.1101

MBC & Associates, Inc 1035 Central Pkwy N, San Antonio, TX 78732 David Allen 210.545.1122

Landscape Architect:


LEE & Associates, Inc. 9020 N Capital of Texas Hwy, Austin, TX. 78759 Amber Rothwell

Interior Designer:

512.345.8477

SJL Design Group 921 N. Riverfront Blvd. Suite 100, Dallas, TX 75207 Cassie Farley 214.443.9090

	ISSUANCES		
	01	SCHEMATIC DESIGN	09.10.18
	02	DEVELOPMENT DESIGN	11.09.18
	03	PERMIT SET	01.28.19
•			

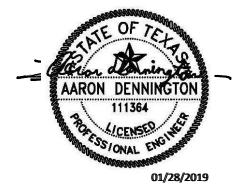

a multifamily project for NRP Group

West Cevallos San Antonio, Texas

PLUMBING DOMESTIC WATER BUILDING 1b LEVEL 4

Project Number 01/14/2018 TLR Drawn By Checked By EEC




KEY PLAN
N.T.S.



- A. REFER TO SHEET P000 FOR GENERAL NOTES, LEGENDS, & ABBREVIATIONS.
- B. DO NOT ROUTE PIPING OVER ELECTRICAL PANELS.
- C. REFER TO WATER HEATER DETAILS FOR PIPING ROUTE, VALVES, AND ACCESSORIES.
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- INSULATE ANY WATER PIPING LOCATED IN EXTERIOR OR CORRIDOR WALLS.
- F. PLUMBING CONTRACTOR SHALL REFER TO SITE PLAN FOR EXACT ORIENTATION OF BUILDING AND LOCATION OF SPRINKLER CLOSET AND TELECOM ROOM.

KEYED NOTES:


 DOMESTIC WATER RISER FROM FLOOR BELOW. REFER TO ENLARGED UNIT PLANS FOR DWELLING UNIT PIPE DISTRIBUTION. REFER TO RISER DIAGRAM FOR VERTICAL PIPE SIZES.

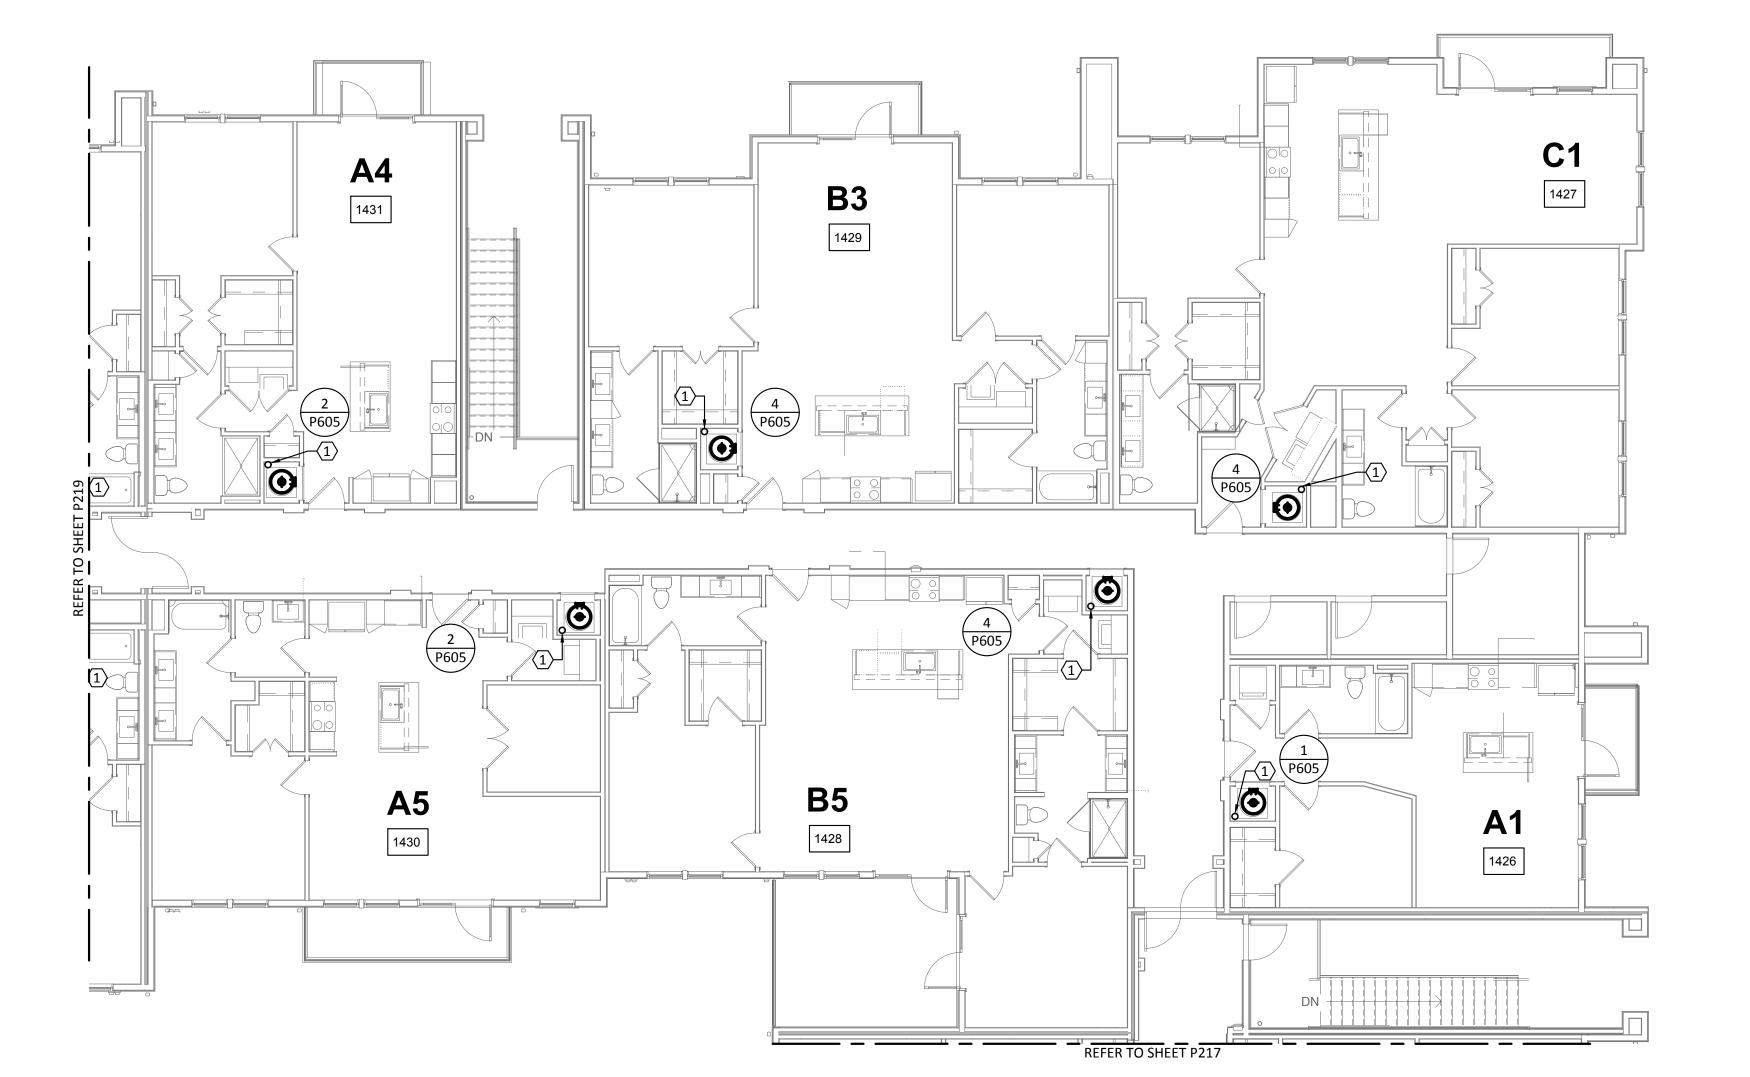

PLUMBING DOMESTIC WATER - BUILDING Ic - LEVEL 4

SCALE: 1/8"=1'-0"



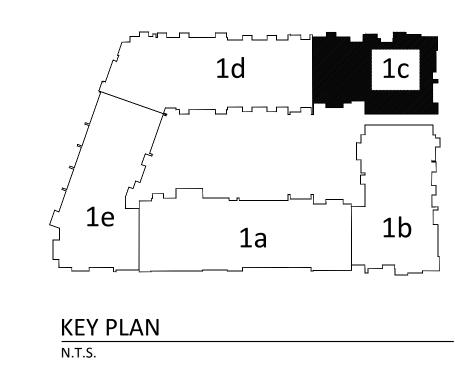



COLLABORATIVE 3607 S Lamar Blvd, Suite 103 Austin, Texas 78704 512.852.4310

Structural Engineer:

VIEWTECH INC. 4205 Beltway Dr. Addison, TX 75001 Victor Lisiak III 972.661.8187

MEP Engineer:

ENCOTECH 8500 Bluffstone Cove, Austin, TX. 78759 Tessa Roberts 512.338.1101

Civil Engineer:

210.545.1122

MBC & Associates, Inc 1035 Central Pkwy N, San Antonio, TX 78732 David Allen

Landscape Architect:

LEE & Associates, Inc. 9020 N Capital of Texas Hwy, Austin, TX. 78759 Amber Rothwell

Interior Designer:

512.345.8477

SJL Design Group 921 N. Riverfront Blvd. Suite 100, Dallas, TX 75207 Cassie Farley 214.443.9090

	ISSUANCES		
	01	SCHEMATIC DESIGN	09.10.18
	02	DEVELOPMENT DESIGN	11.09.18
	03	PERMIT SET	01.28.19
•			

REVISIONS



a multifamily project for NRP Group

West Cevallos
San Antonio, Texas

PLUMBING DOMESTIC WATER BUILDING 1c LEVEL 4

18054
01/14/2018
TLR
EEC


P218

A. REFER TO SHEET P000 FOR GENERAL NOTES, LEGENDS, & ABBREVIATIONS.


- B. DO NOT ROUTE PIPING OVER ELECTRICAL PANELS.
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- . ALL VALVES MUST BE ACCESSIBLE.
- INSULATE ANY WATER PIPING LOCATED IN EXTERIOR OR CORRIDOR WALLS.
- PLUMBING CONTRACTOR SHALL REFER TO SITE PLAN FOR EXACT ORIENTATION OF BUILDING AND LOCATION OF SPRINKLER CLOSET AND TELECOM ROOM.

KEYED NOTES:

DOMESTIC WATER RISER FROM FLOOR BELOW. REFER TO ENLARGED UNIT PLANS FOR DWELLING UNIT PIPE DISTRIBUTION. REFER TO RISER DIAGRAM FOR VERTICAL PIPE SIZES.

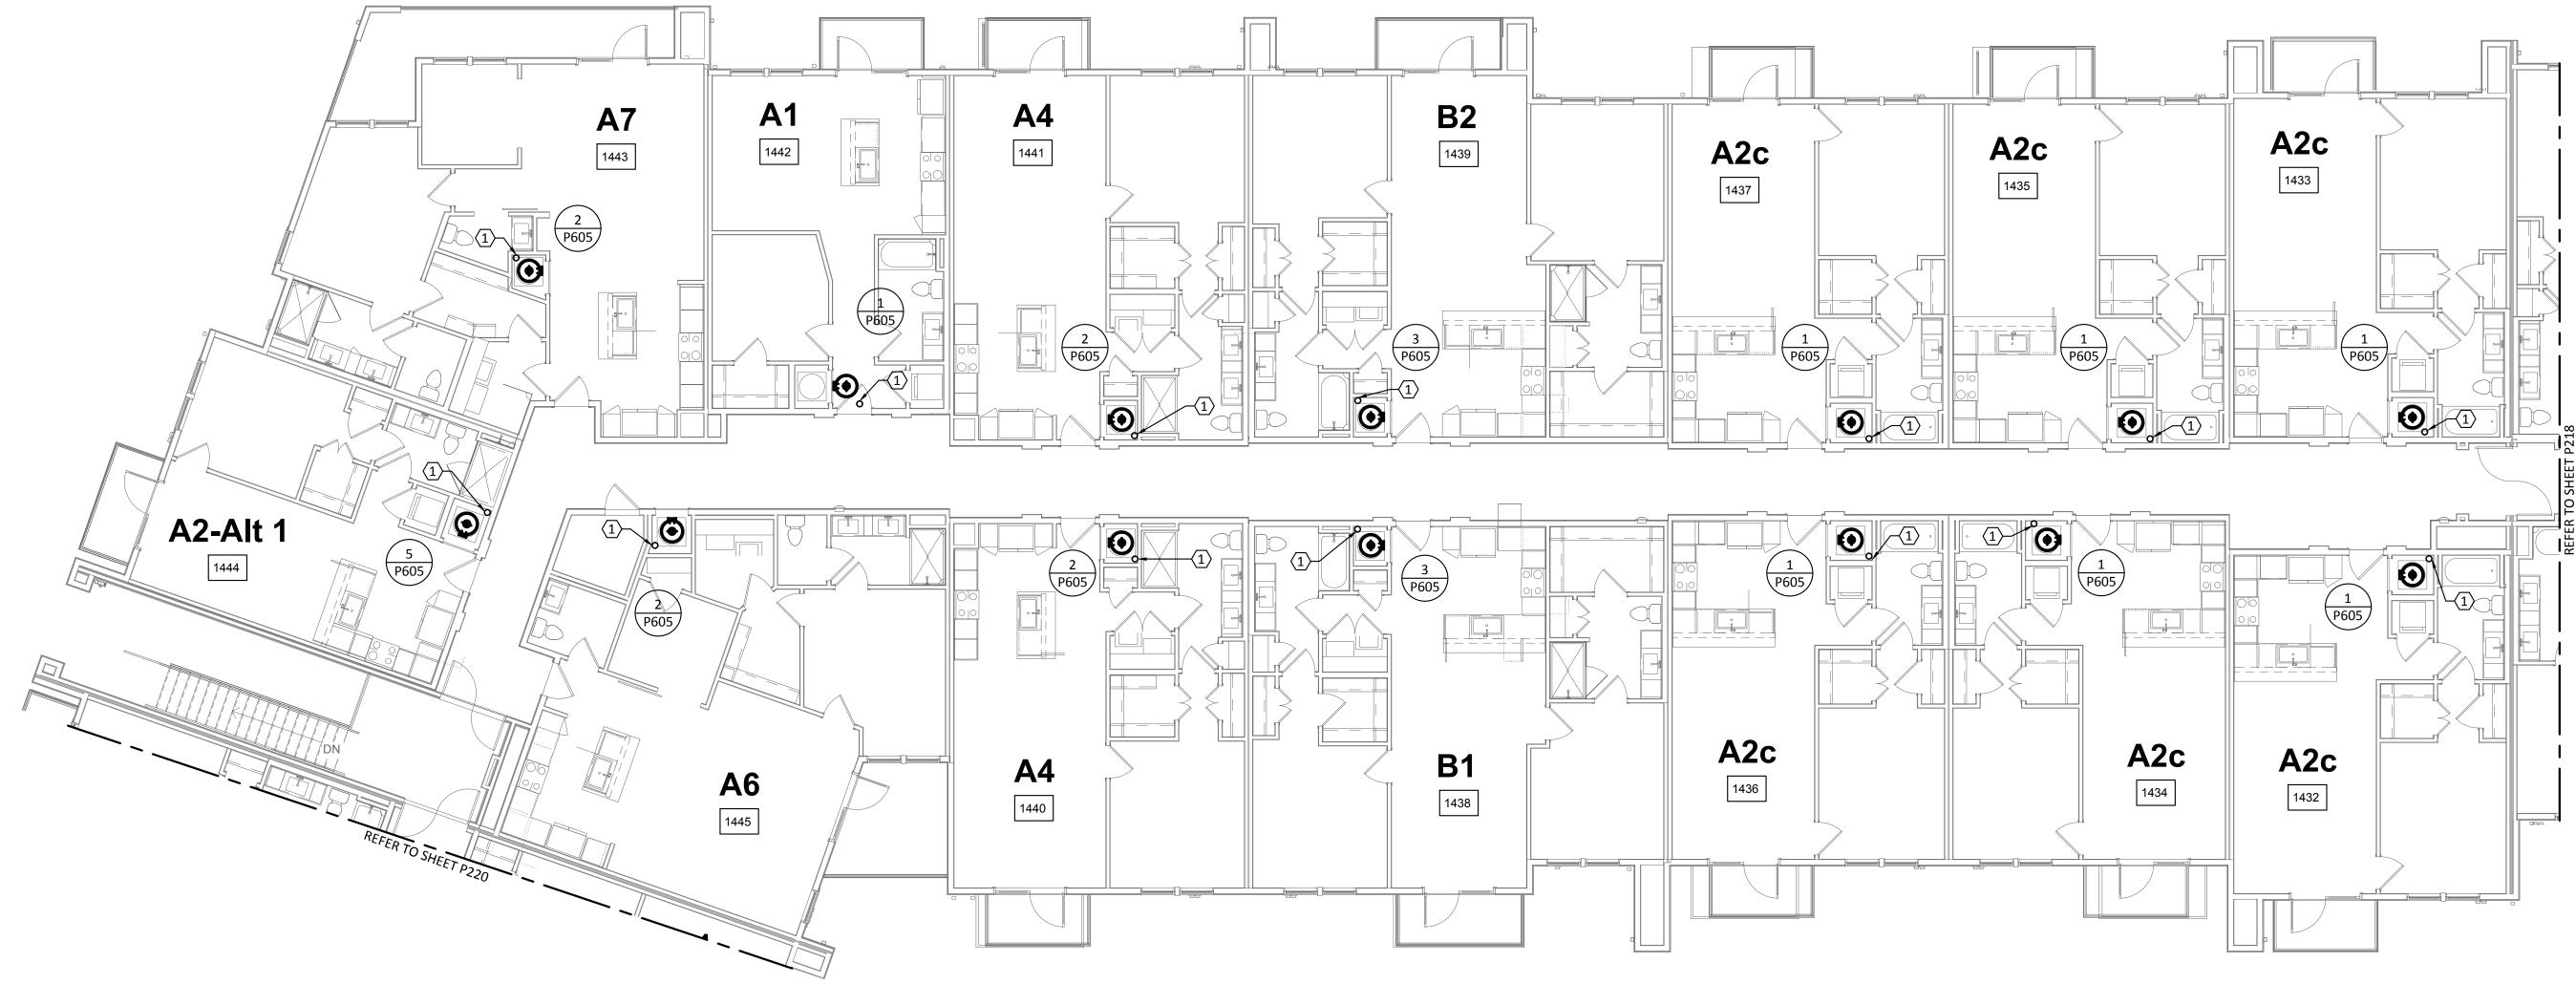

1 PLUMBING DOMESTIC WATER - BUILDING Id - LEVEL 4
SCALE: 1/8"=1'-0"

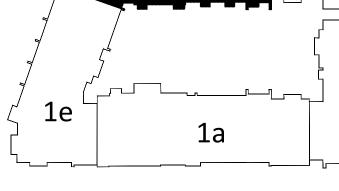

KEY PLAN





Structural Engineer:

VIEWTECH INC. 4205 Beltway Dr. Addison, TX 75001 Victor Lisiak III 972.661.8187

MEP Engineer:

ENCOTECH 8500 Bluffstone Cove, Austin, TX. 78759 Tessa Roberts 512.338.1101

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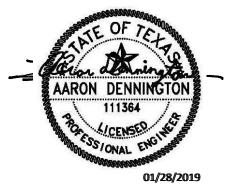
Landscape Architect:

LEE & Associates, Inc. 9020 N Capital of Texas Hwy, Austin, TX. 78759 Amber Rothwell 512.345.8477

Interior Designer:

SJL Design Group 921 N. Riverfront Blvd. Suite 100, Dallas, TX 75207 Cassie Farley 214.443.9090

ISSUANCES		
01	SCHEMATIC DESIGN	09.10.18
02	DEVELOPMENT DESIGN	11.09.18
03	PERMIT SET	01.28.19




a multifamily project for NRP Group

West Cevallos San Antonio, Texas

PLUMBING DOMESTIC WATER BUILDING Id LEVEL 4

Project Number	18054
Date	01/14/2018
Drawn By	TLR
Checked By	EEC

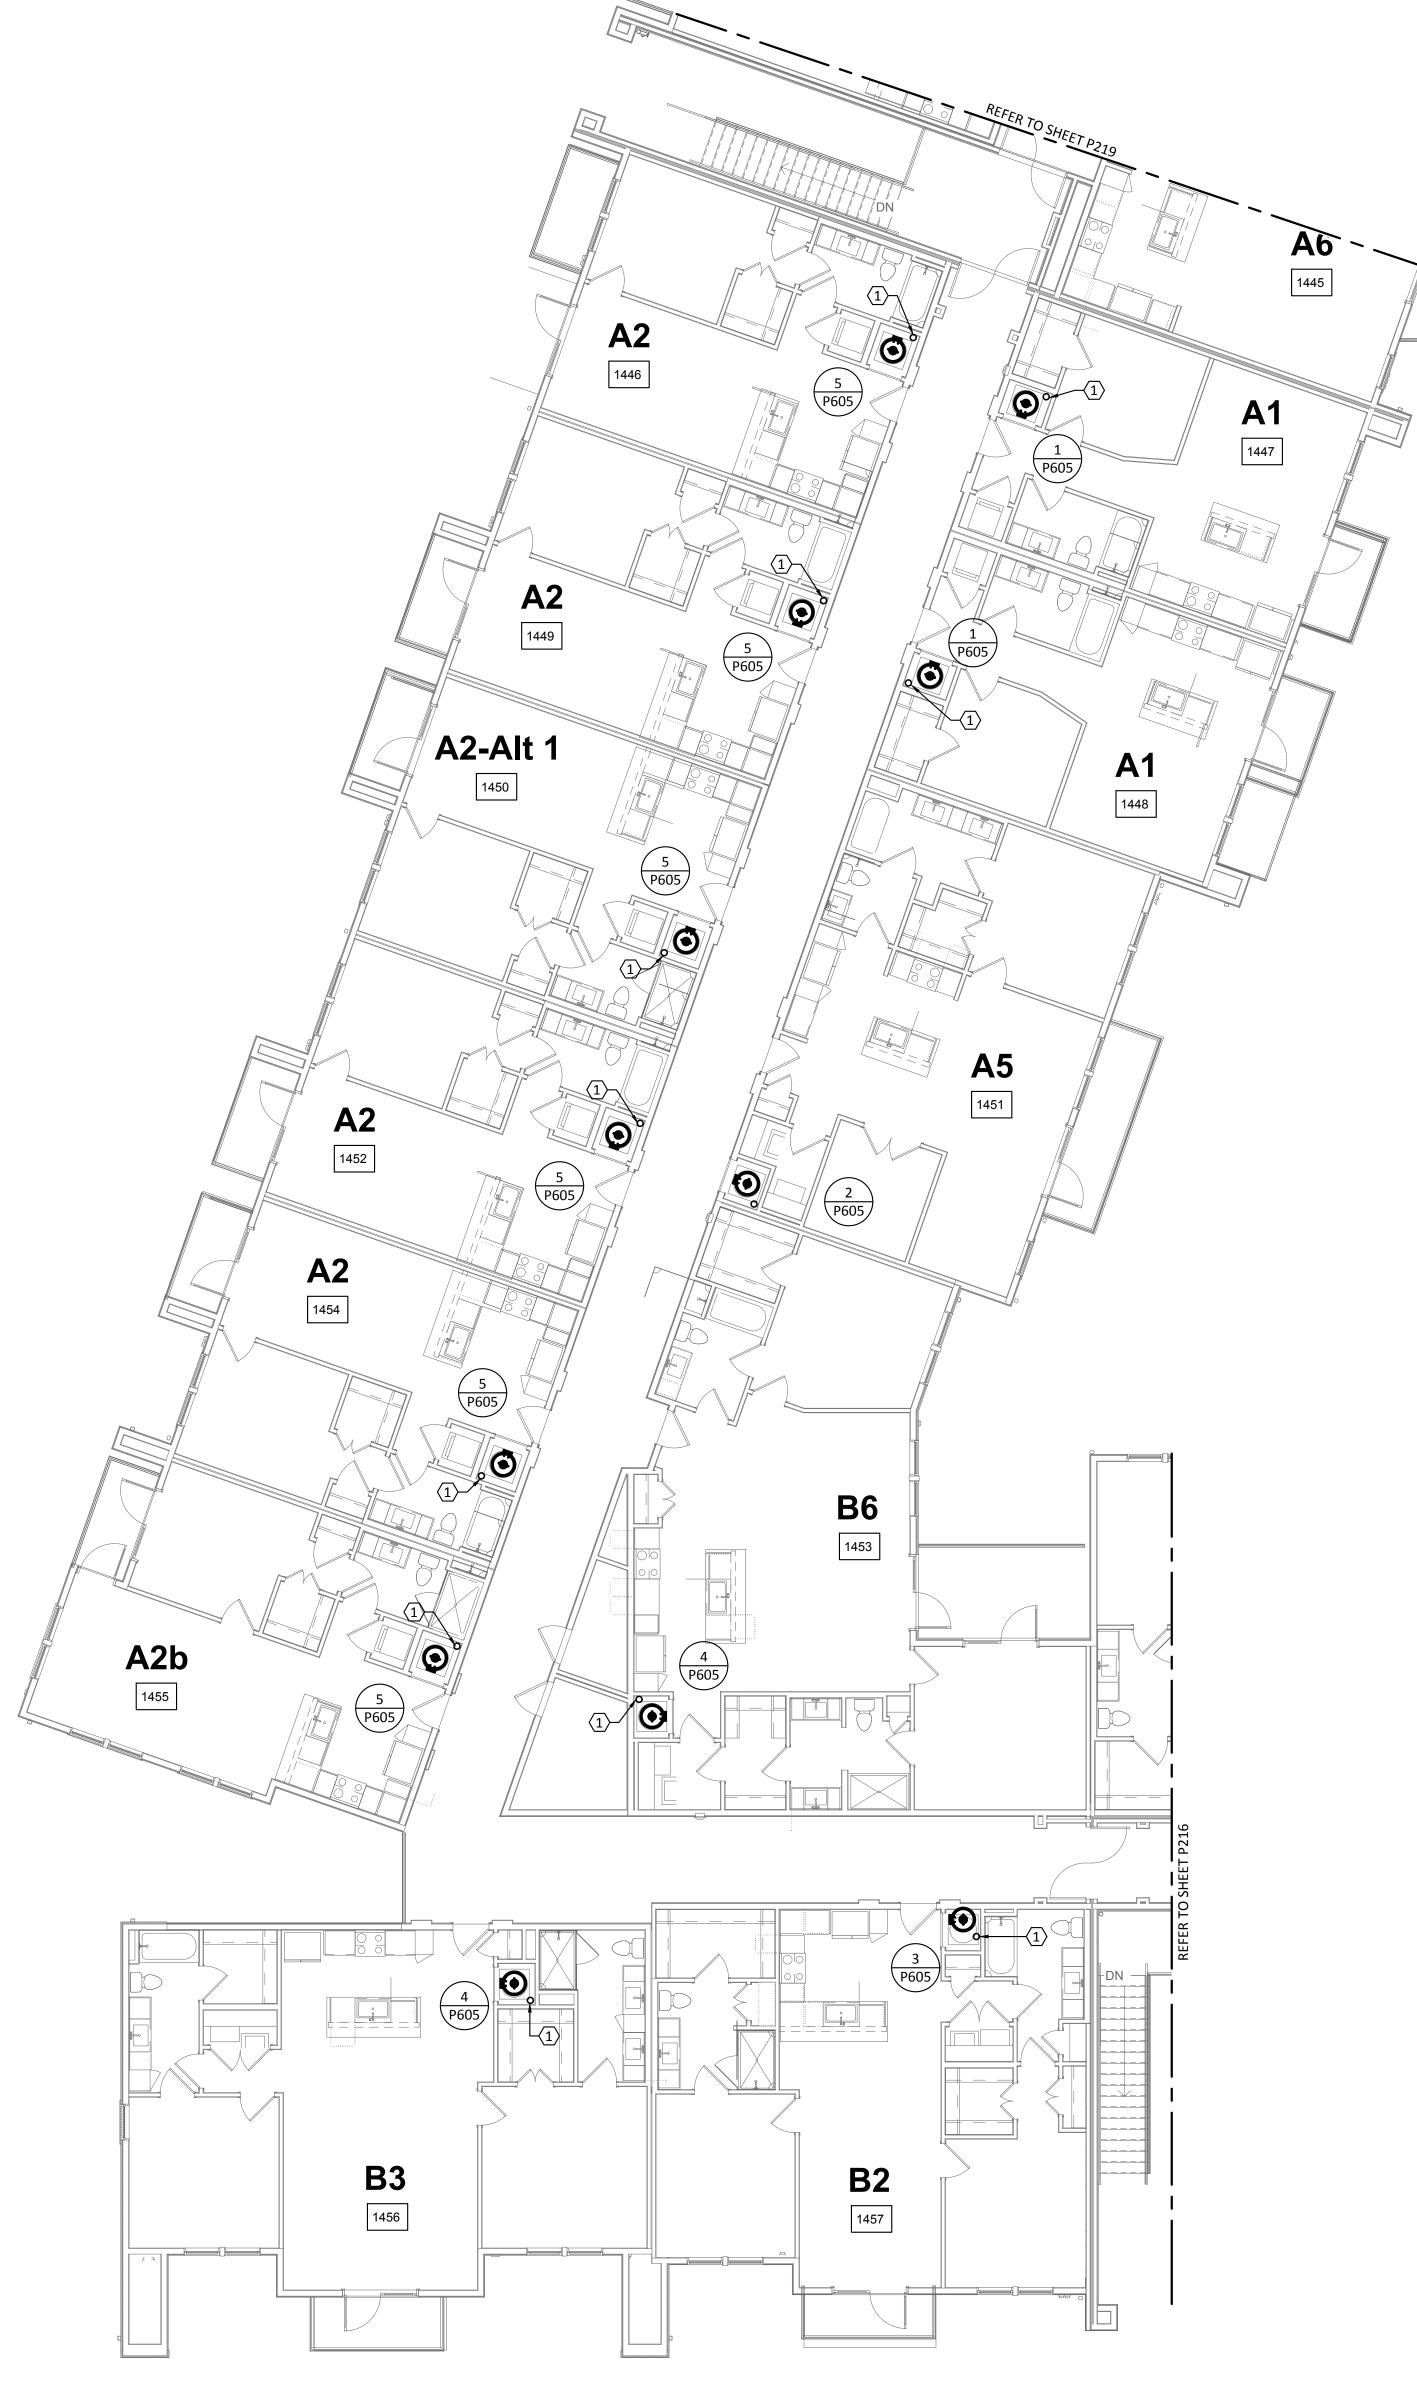

PLUMBING DOMESTIC WATER - BUILDING le - LEVEL 4

SCALE: 1/8"=1'-0"



GENERAL NOTES:

- A. REFER TO SHEET P000 FOR GENERAL NOTES, LEGENDS, & ABBREVIATIONS.
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- PLUMBING CONTRACTOR SHALL REFER TO SITE PLAN FOR EXACT ORIENTATION OF BUILDING AND LOCATION OF SPRINKLER CLOSET AND TELECOM ROOM.

KEYED NOTES:

DOMESTIC WATER RISER FROM FLOOR BELOW. REFER TO ENLARGED UNIT PLANS FOR DWELLING UNIT PIPE DISTRIBUTION. REFER TO RISER DIAGRAM FOR VERTICAL PIPE SIZES.



07 S Lamar Blvd, Suite 103 Austin, Texas 78704

Structural Engineer:

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MEP Engineer:

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Civil Engineer:

210.545.1122

MBC & Associates, Inc 1035 Central Pkwy N, San Antonio, TX 78732 David Allen

Landscape Architect:

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Interior Designer:

512.345.8477

SJL Design Group 921 N. Riverfront Blvd. Suite 100, Dallas, TX 75207 Cassie Farley 214.443.9090

ISSUANCES		
01	SCHEMATIC DESIGN	09.10.18
02	DEVELOPMENT DESIGN	11.09.18
03	PERMIT SET	01.28.19

REVISIONS



a multifamily project for NRP Group

West Cevallos
San Antonio, Texas

PLUMBING WASTEWATER BUILDING 1e LEVEL 4

Project Number 18054

Date 01/14/2018


Drawn By TLR

Checked By EEC

P220


TBPE Firm 1141 8500 Bluffstone Cove, Suite B-103 Austin, Texas 78759 512.338.1101 Project No.: 18054.MS.AUS

KEY PLAN

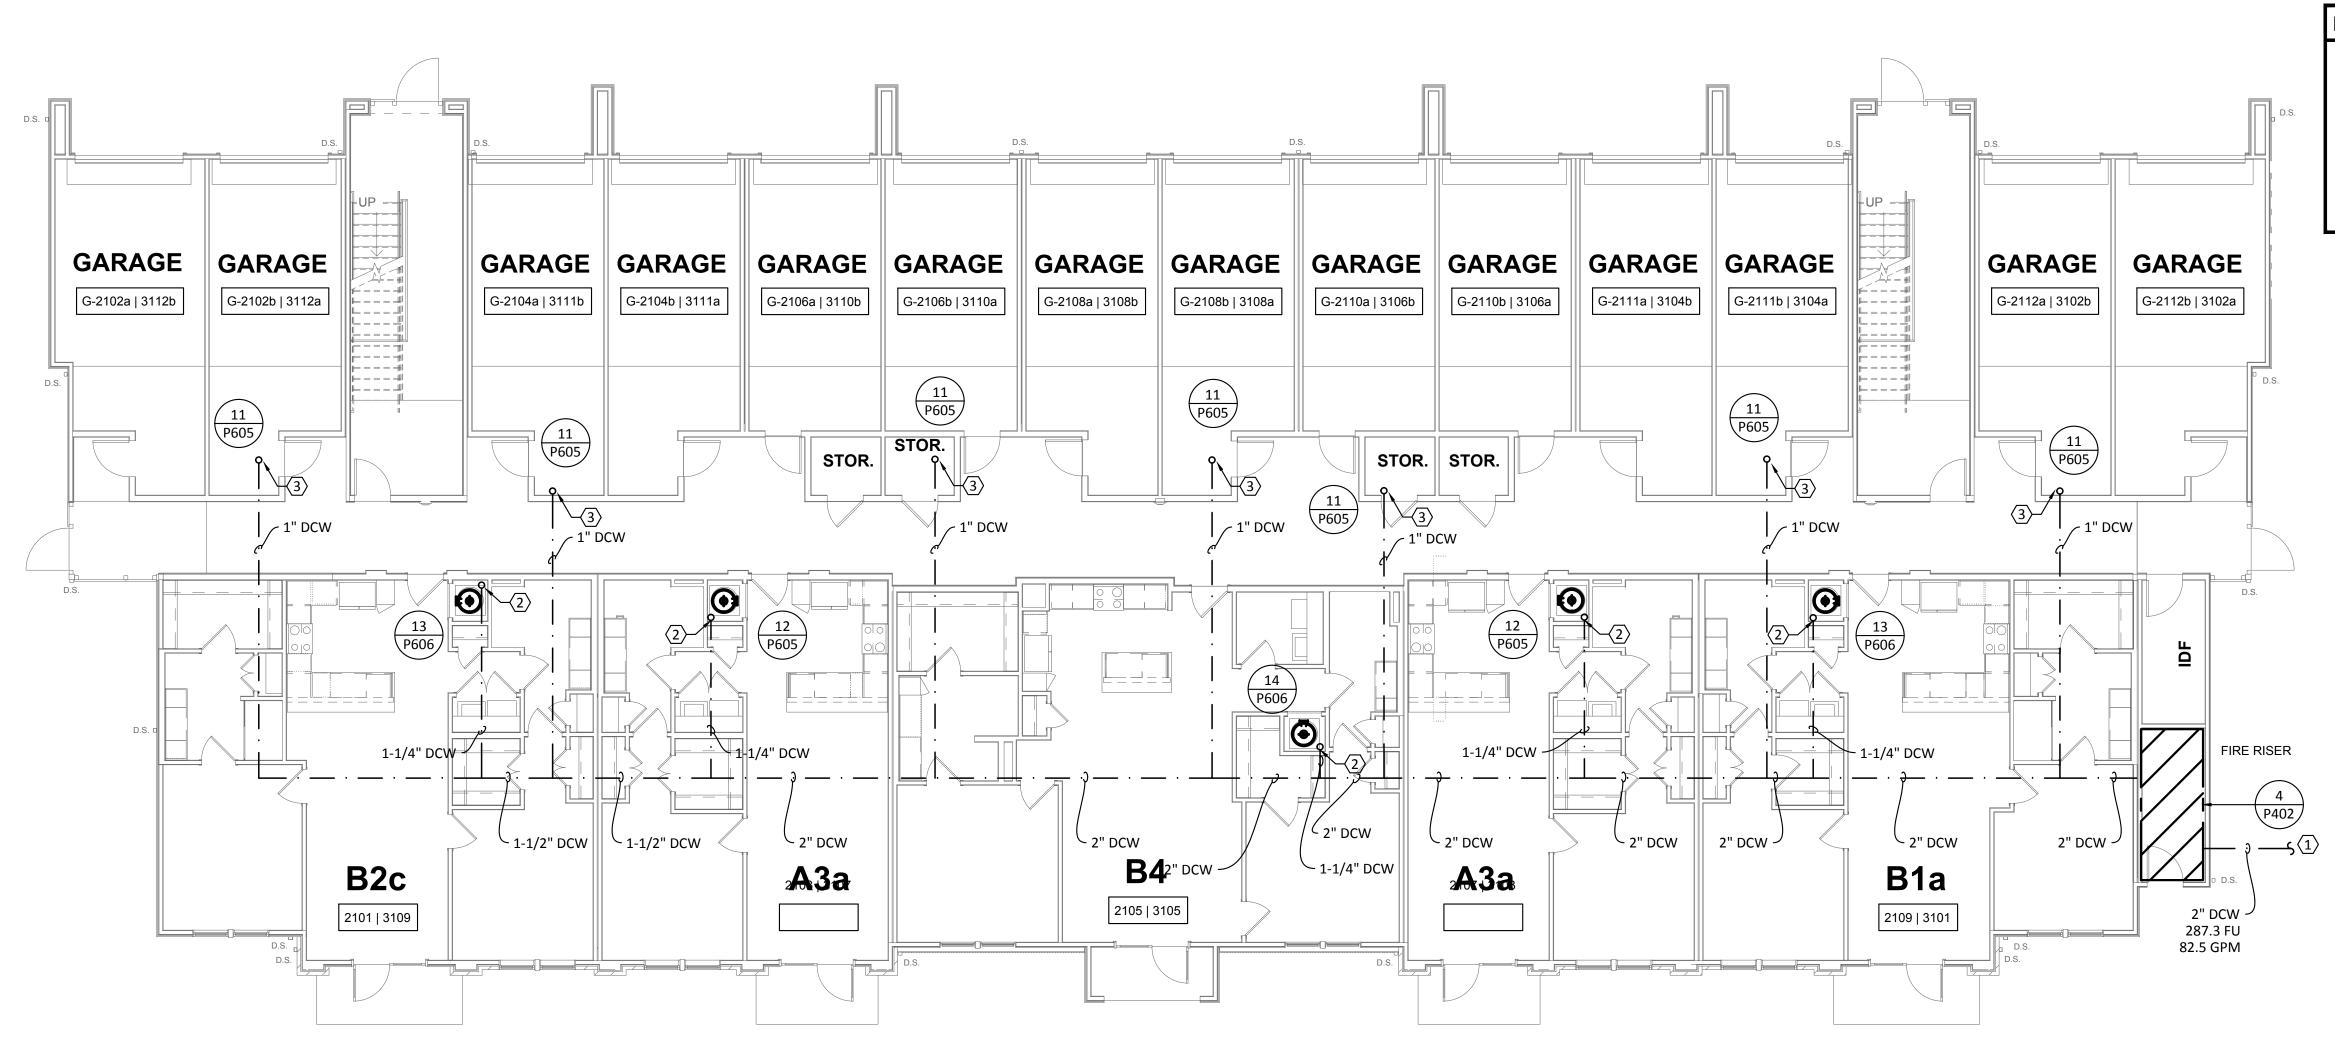

PLUMBING DOMESTIC WATER - BUILDING II (#2) - LEVEL 1

SCALE: 1/8"=1'-0"

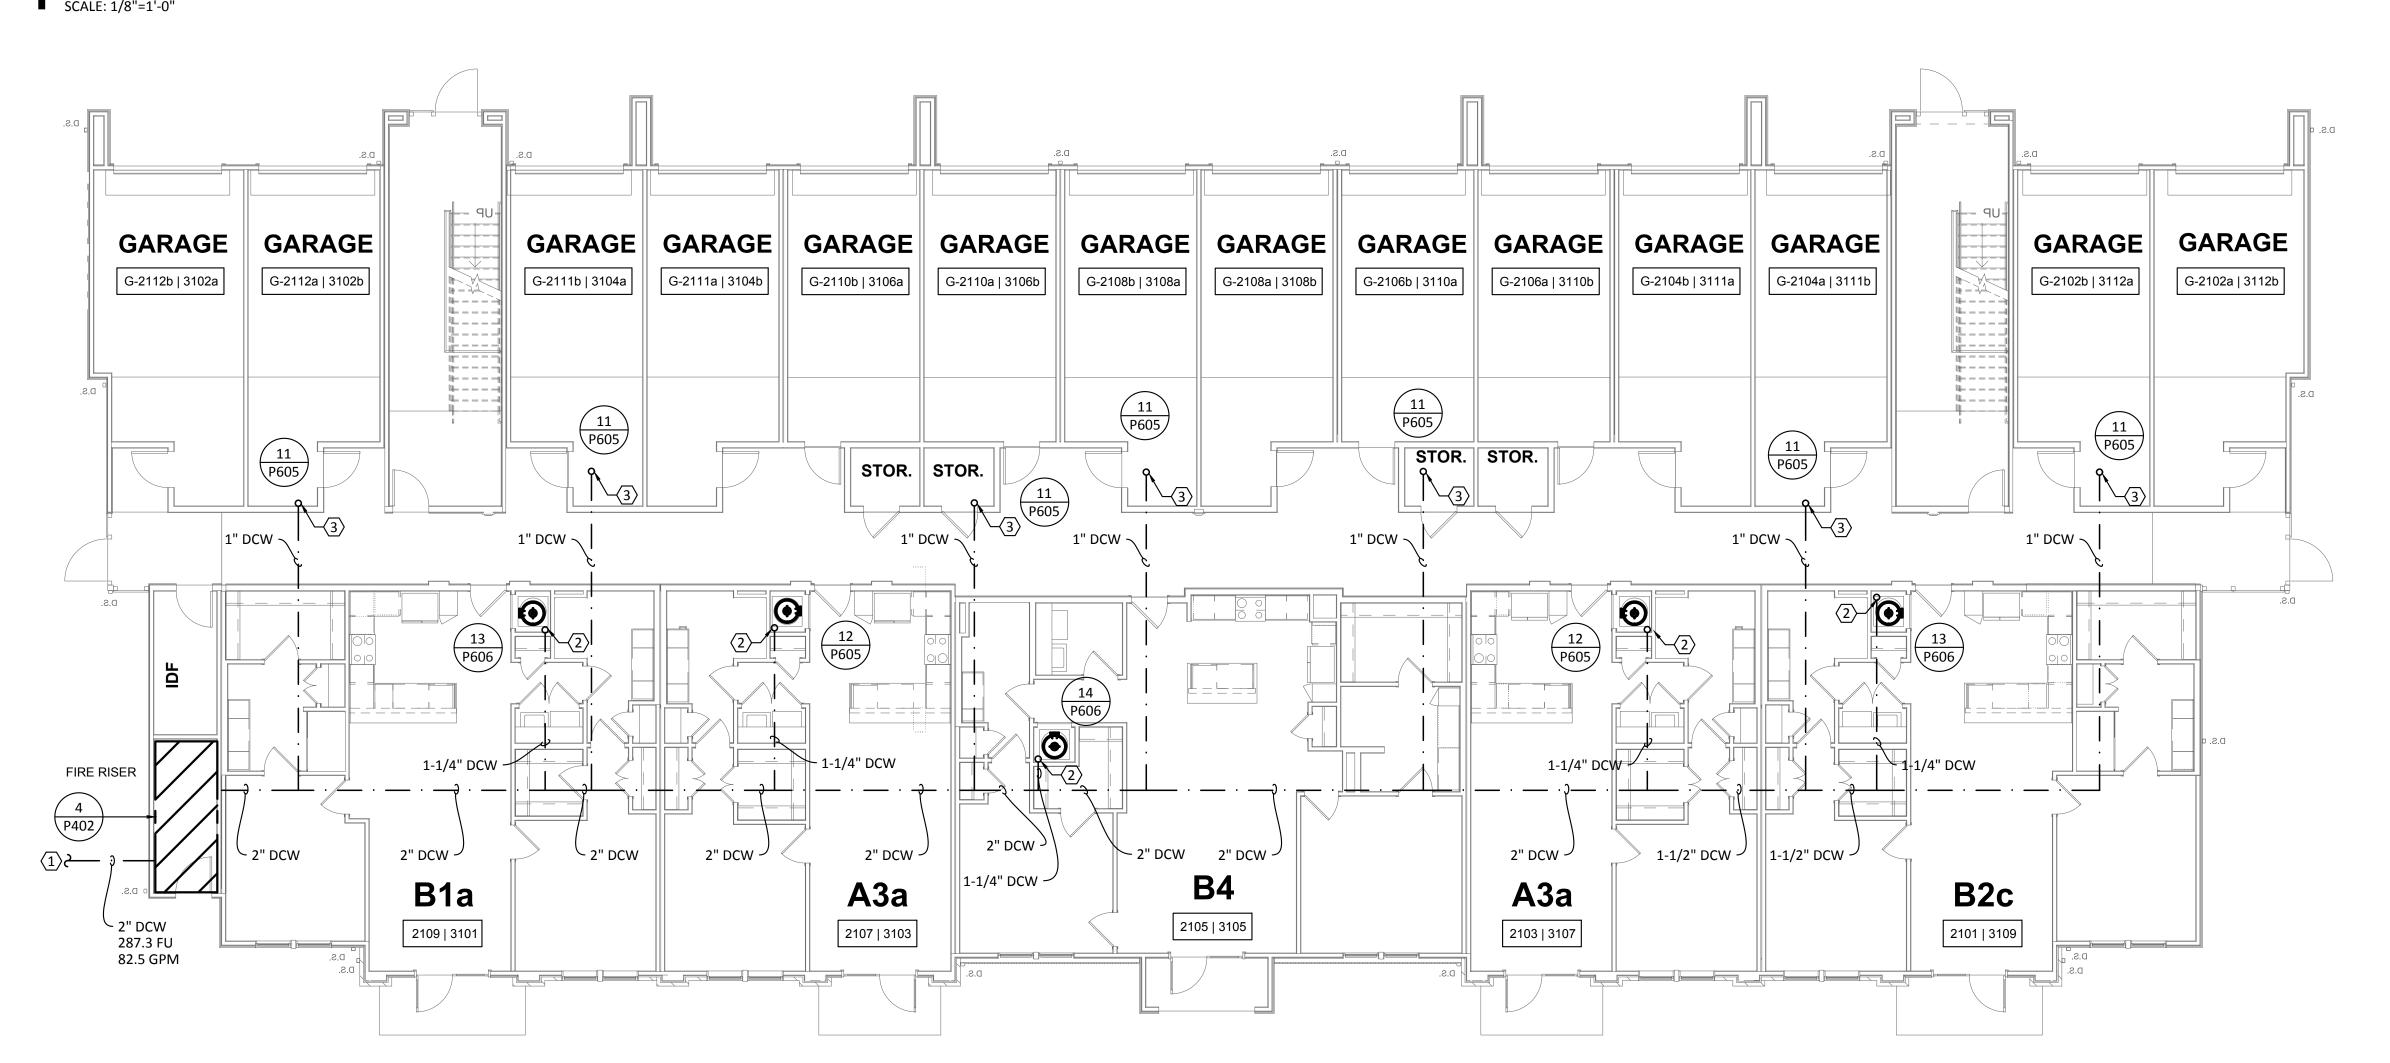

2 PLUMBING DOMESTIC WATER - BUILDING II (#3) - LEVEL 1
SCALE: 1/8"=1'-0"



A. REFER TO SHEET P000 FOR ADDITIONAL INFORMATION.

REFER TO DOMESTIC WATER RISER DIAGRAMS ON SHEETS P605 & P606 FOR VERTICAL PIPE SIZING BETWEEN FLOORS.

KEYED NOTES:

- . REFER TO CIVIL FOR CONTINUATION.
- 2. DOMESTIC WATER RISER TO FLOOR ABOVE. REFER TO ENLARGED UNIT PLANS FOR DWELLING UNIT PIPE DISTRIBUTION. REFER TO RISER DIAGRAM FOR VERTICAL PIPE SIZES.
- DOMESTIC WATER RISER TO DWELLING UNITS ABOVE. REFER TO UPPER FLOORS FOR CONTINUATION. REFER TO ENLARGED UNIT PLANS FOR DWELLING UNIT PIPE DISTRIBUTION. REFER TO RISER DIAGRAM FOR VERTICAL PIPE SIZES.



Structural Engineer:

VIEWTECH INC. 4205 Beltway Dr. Addison, TX 75001 Victor Lisiak III 972.661.8187

MEP Engineer:

ENCOTECH 8500 Bluffstone Cove, Austin, TX. 78759 Tessa Roberts

Civil Engineer:

512.338.1101

MBC & Associates, Inc 1035 Central Pkwy N, San Antonio, TX 78732 David Allen 210.545.1122

Landscape Architect:

LEE & Associates, Inc. 9020 N Capital of Texas Hwy, Austin, TX. 78759 Amber Rothwell 512.345.8477

Interior Designer:

SJL Design Group 921 N. Riverfront Blvd. Suite 100, Dallas, TX 75207 Cassie Farley 214.443.9090

ISSUANCES

	01	SCHEMATIC DESIGN	09.10.18
	02	DEVELOPMENT DESIGN	11.09.18
	03	PERMIT SET	01.28.19

REVISIONS



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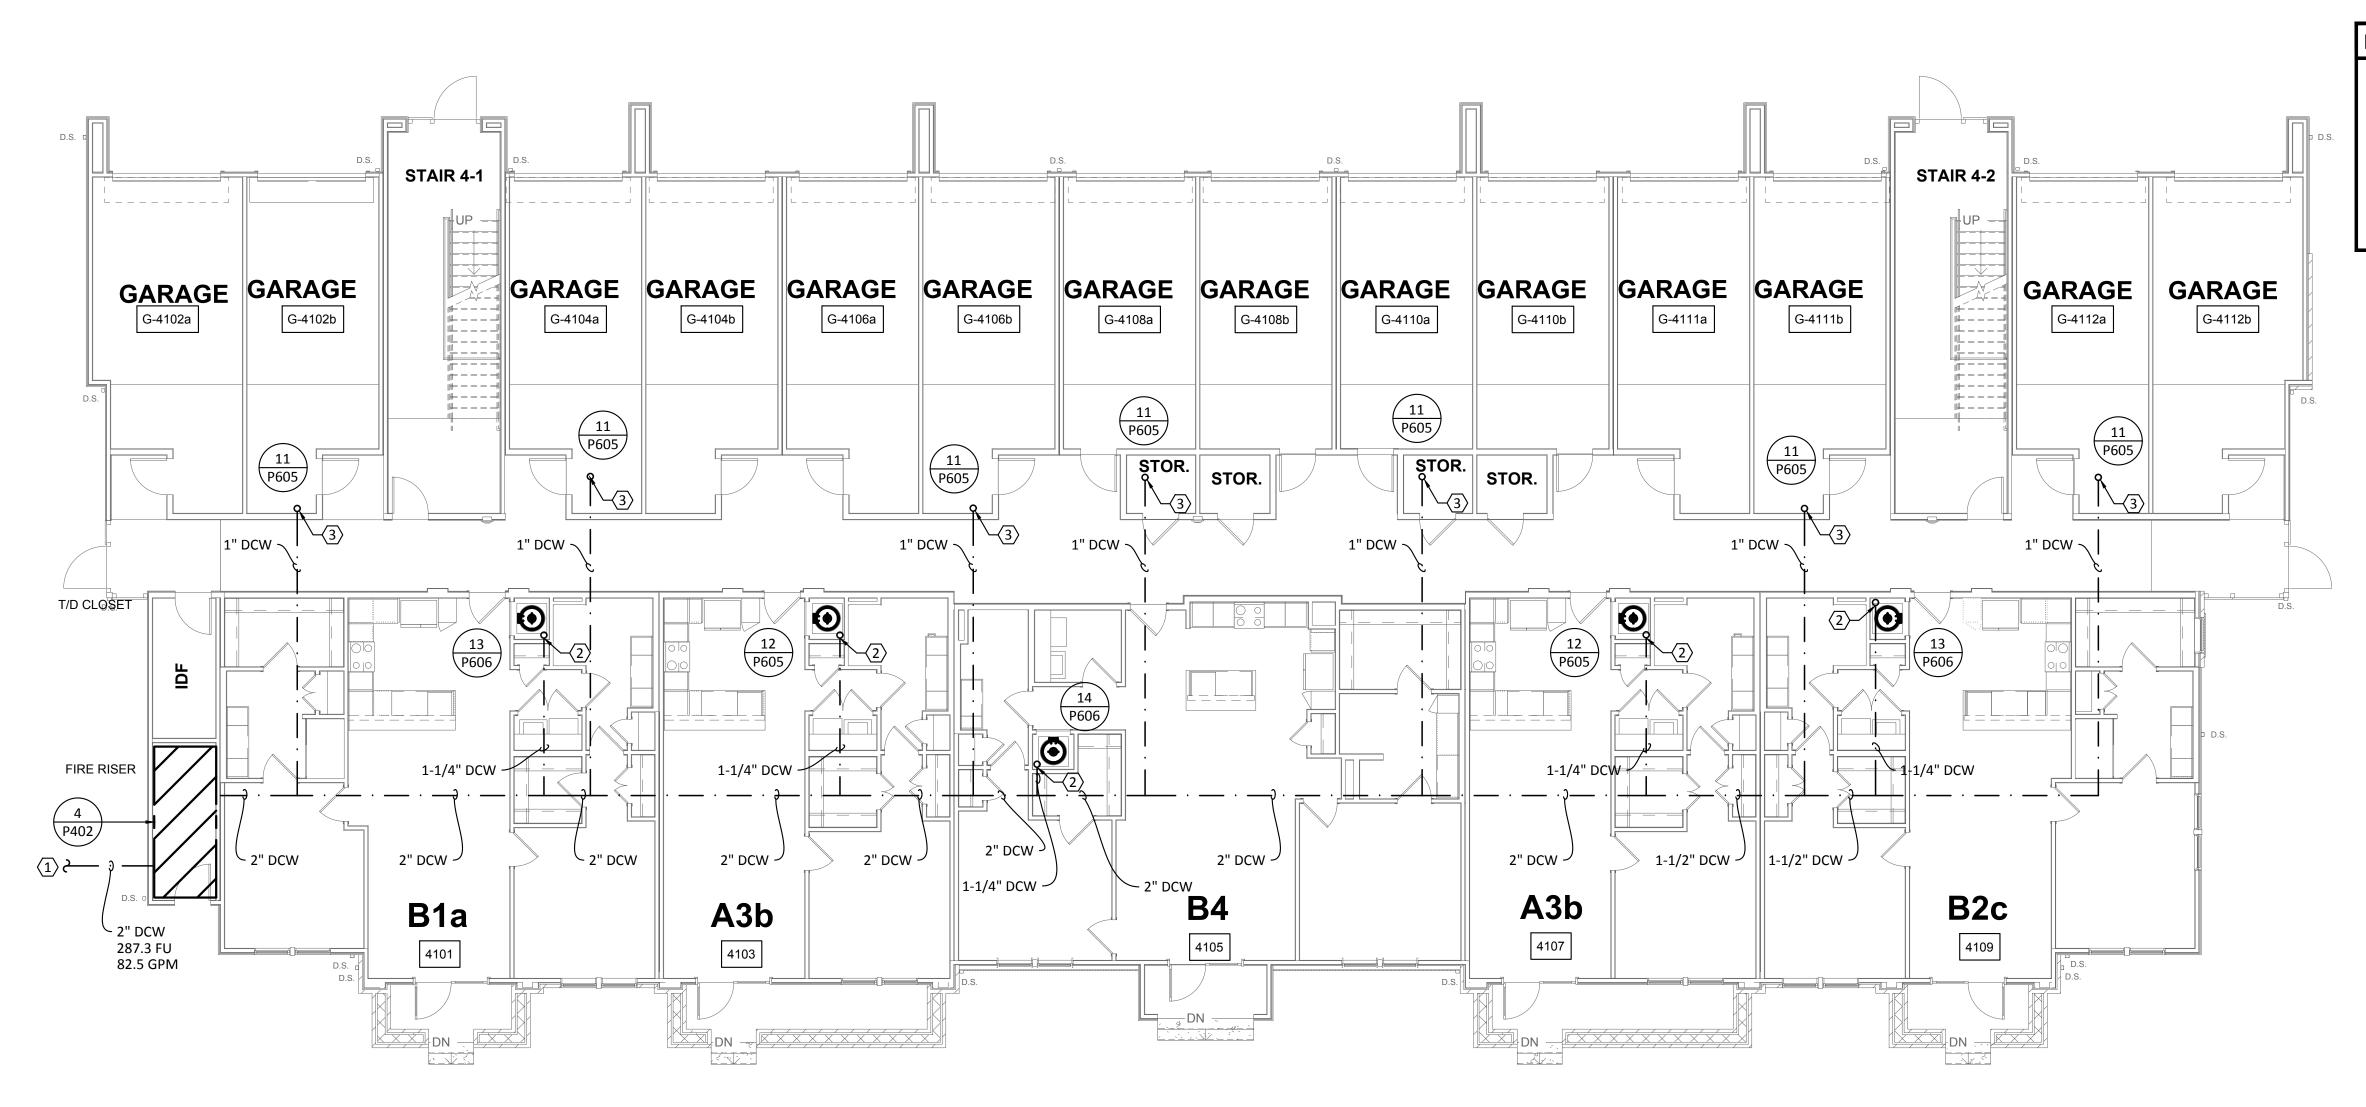
West Cevallos
San Antonio, Texas

PLUMBING DOMESTIC WATER BLDG II (#2 & #3) LEVEL 1

Project Number	18054
Date	01/14/2018
Drawn By	TLR
Checked By	EEC


P221





PLUMBING DOMESTIC WATER - BUILDING II (#4) - LEVEL 1

SCALE: 1/8"=1'-0"

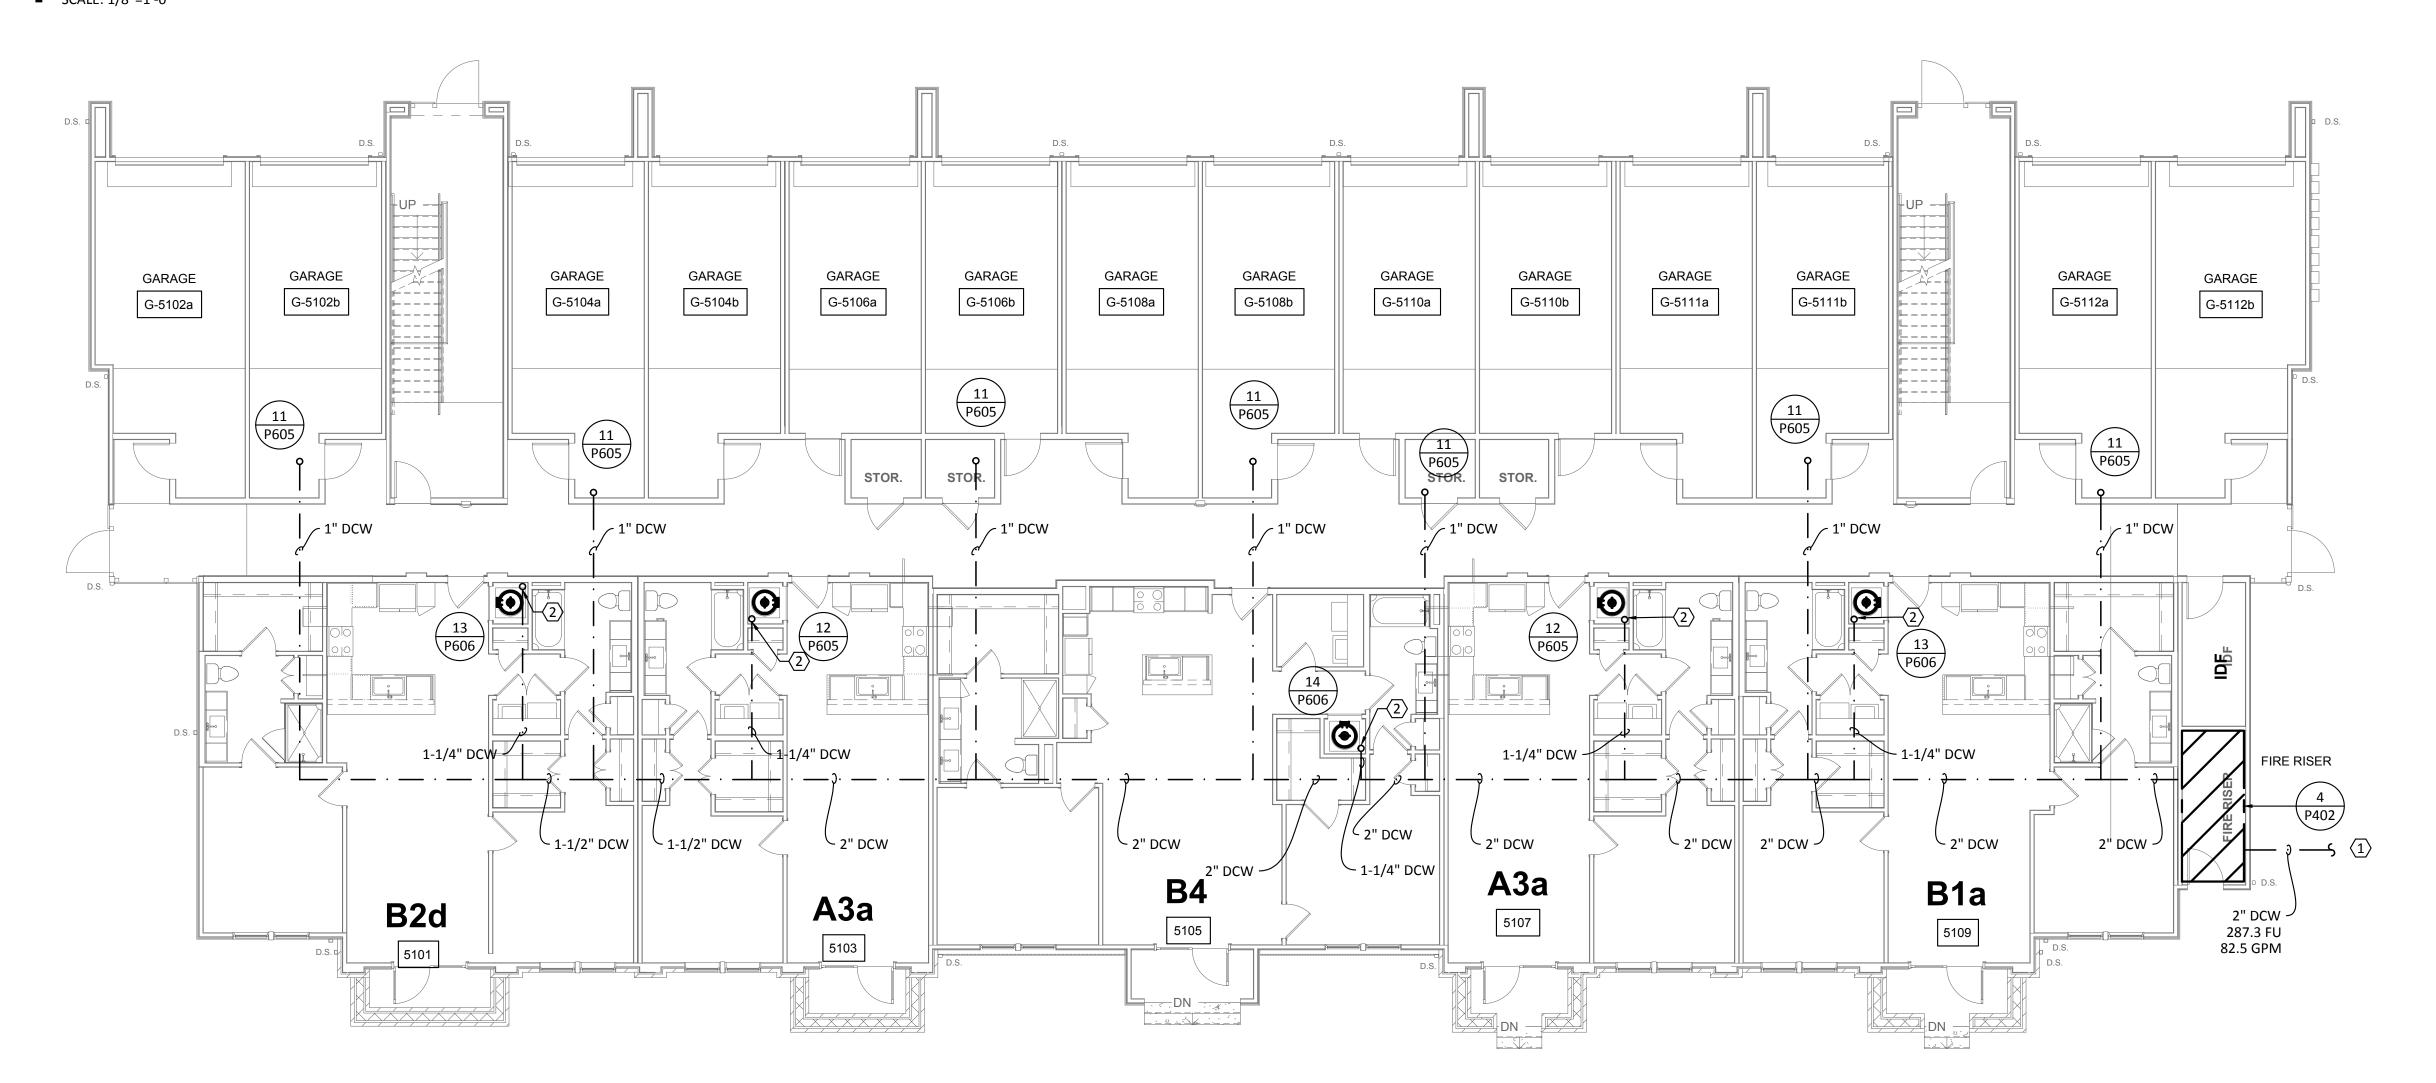

PLUMBING DOMESTIC WATER - BUILDING II (#5) - LEVEL 1

SCALE: 1/8"=1'-0"



. REFER TO SHEET P000 FOR ADDITIONAL INFORMATION.

REFER TO DOMESTIC WATER RISER DIAGRAMS ON SHEETS P605 & P606 FOR VERTICAL PIPE SIZING BETWEEN FLOORS.

KEYED NOTES:

- REFER TO CIVIL FOR CONTINUATION.
- DOMESTIC WATER RISER TO FLOOR ABOVE. REFER TO ENLARGED UNIT PLANS FOR DWELLING UNIT PIPE DISTRIBUTION. REFER TO RISER DIAGRAM FOR VERTICAL PIPE SIZES.
- DOMESTIC WATER RISER TO DWELLING UNITS ABOVE. REFER TO UPPER FLOORS FOR CONTINUATION. REFER TO ENLARGED UNIT PLANS FOR DWELLING UNIT PIPE DISTRIBUTION. REFER TO RISER DIAGRAM FOR VERTICAL PIPE SIZES.



Structural Engineer:

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Civil Engineer:

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Landscape Architect:


LEE & Associates, Inc. 9020 N Capital of Texas Hwy, Austin, TX. 78759 Amber Rothwell 512.345.8477

Interior Designer:

SJL Design Group 921 N. Riverfront Blvd. Suite 100, Dallas, TX 75207 Cassie Farley 214.443.9090

ISSUANCES

01	SCHEMATIC DESIGN	09.10.18
02	DEVELOPMENT DESIGN	11.09.18
03	PERMIT SET	01.28.19
	_	

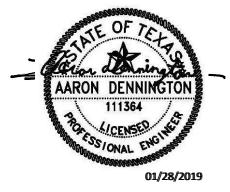

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West Cevallos San Antonio, Texas

PLUMBING DOMESTIC WATER BLDG II (#4 & #5) LEVEL 1

Project Number	18054
Date	01/14/2018
Drawn By	TLR
Checked By	EEC

P222

ENCOTECH ENGINEERING CONSULTANTS TBPE Firm 8500 Bluffstone Cove, Suite B-103 1141 Austin, Texas 78759 512.338.1101 Project No.: 18054.MS.AUS

. REFER TO SHEET P000 FOR ADDITIONAL INFORMATION.

REFER TO DOMESTIC WATER RISER DIAGRAMS ON SHEETS P605 & P606 FOR VERTICAL PIPE SIZING BETWEEN FLOORS.



Structural Engineer:

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ISSUANCES	5	
01	SCHEMATIC DESIGN	09.10.18
02	DEVELOPMENT DESIGN	11.09.18
03	PERMIT SET	01.28.19

REVISION




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West Cevallos
San Antonio, Texas

PLUMBING DOMESTIC WATER BLDG II (#2, #3 & #5) LEVEL 2

Project Number	18054
Date	01/14/2018
Drawn By	TLR
Checked By	EEC

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PLUMBING DOMESTIC WATER - BUILDING II (#2 & #5) - LEVEL 2

SCALE: 1/8"=1'-0"

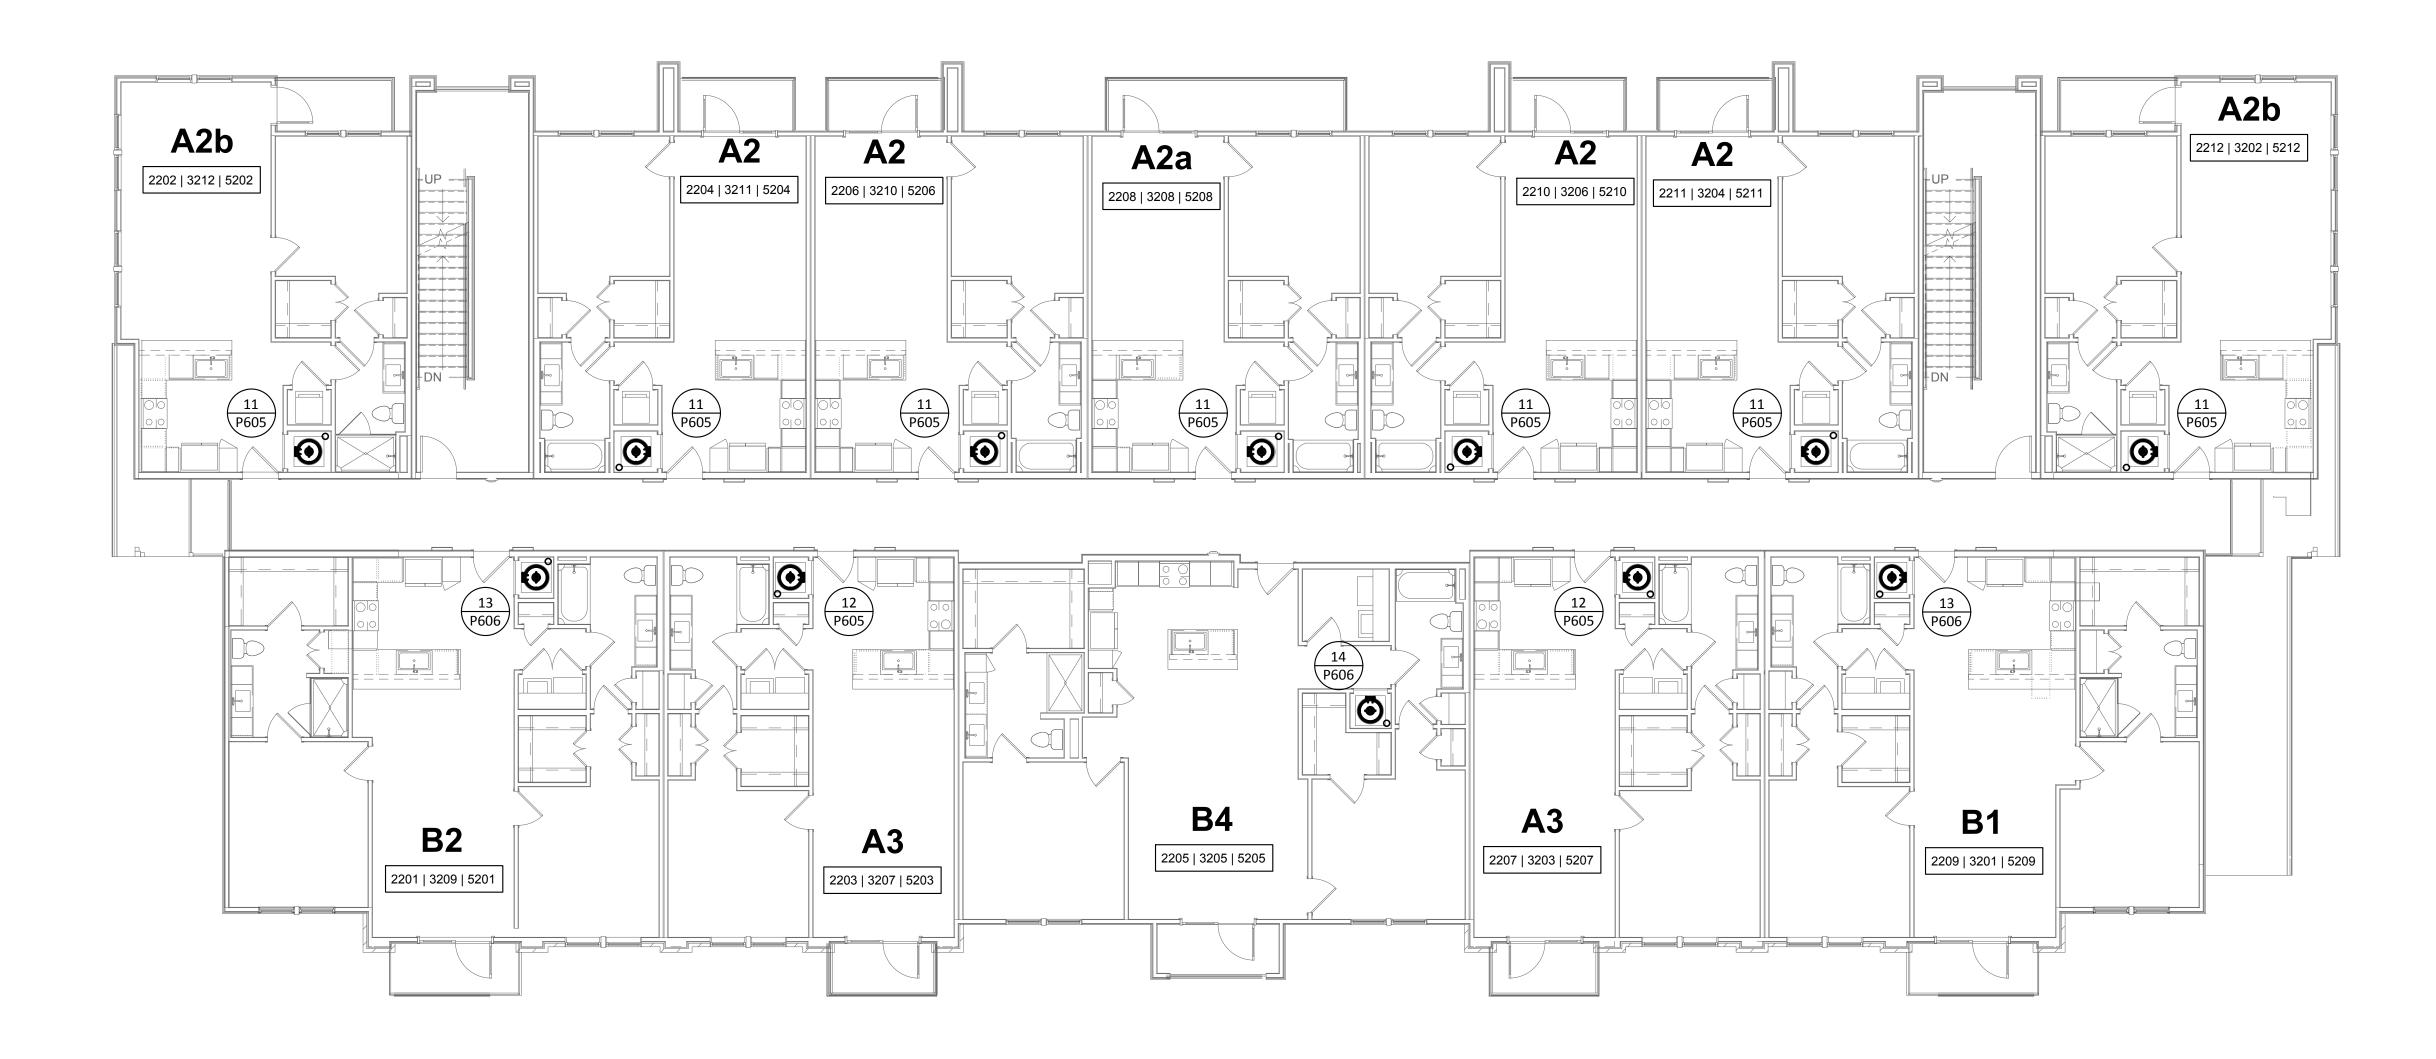A2b A2b 2212 | 3202 | 5212 **A2 A2 A2** A2a 2202 | 3212 | 5202 2206 | 3210 | 5206 2210 | 3206 | 5210 | 2211 | 3204 | 5211 2208 | 3208 | 5208 2204 | 3211 | 5204 **O**. 0 **B4 B1 A3 B2 A3** 2205 | 3205 | 5205 2207 | 3203 | 5207 2209 | 3201 | 5209 2203 | 3207 | 5203 2201 | 3209 | 5201

2 PLUMBING DOMESTIC WATER - BUILDING II (#3) - LEVEL 2

SCALE: 1/8"=1'-0"





A. REFER TO SHEET POOD FOR ADDITIONAL INFORMATION.

. REFER TO DOMESTIC WATER RISER DIAGRAMS ON SHEETS P605 & P606 FOR VERTICAL PIPE SIZING BETWEEN FLOORS.



Structural Engineer:

VIEWTECH INC. 4205 Beltway Dr. Addison, TX 75001 Victor Lisiak III 972.661.8187

MEP Engineer:

ENCOTECH 8500 Bluffstone Cove, Austin, TX. 78759 Tessa Roberts 512.338.1101

Civil Engineer:

MBC & Associates, Inc 1035 Central Pkwy N, San Antonio, TX 78732 David Allen 210.545.1122


Landscape Architect:

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Interior Designer:

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ISSUANCES		
01	SCHEMATIC DESIGN	09.10.18
02	DEVELOPMENT DESIGN	11.09.18
03	PERMIT SET	01.28.19




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West Cevallos San Antonio, Texas

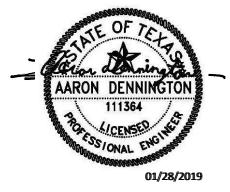PLUMBING DOMESTIC WATER BLDG II (#4) LEVEL 2

Project Number	18054
Date	01/14/2018
Drawn By	TLR
Checked By	EEC

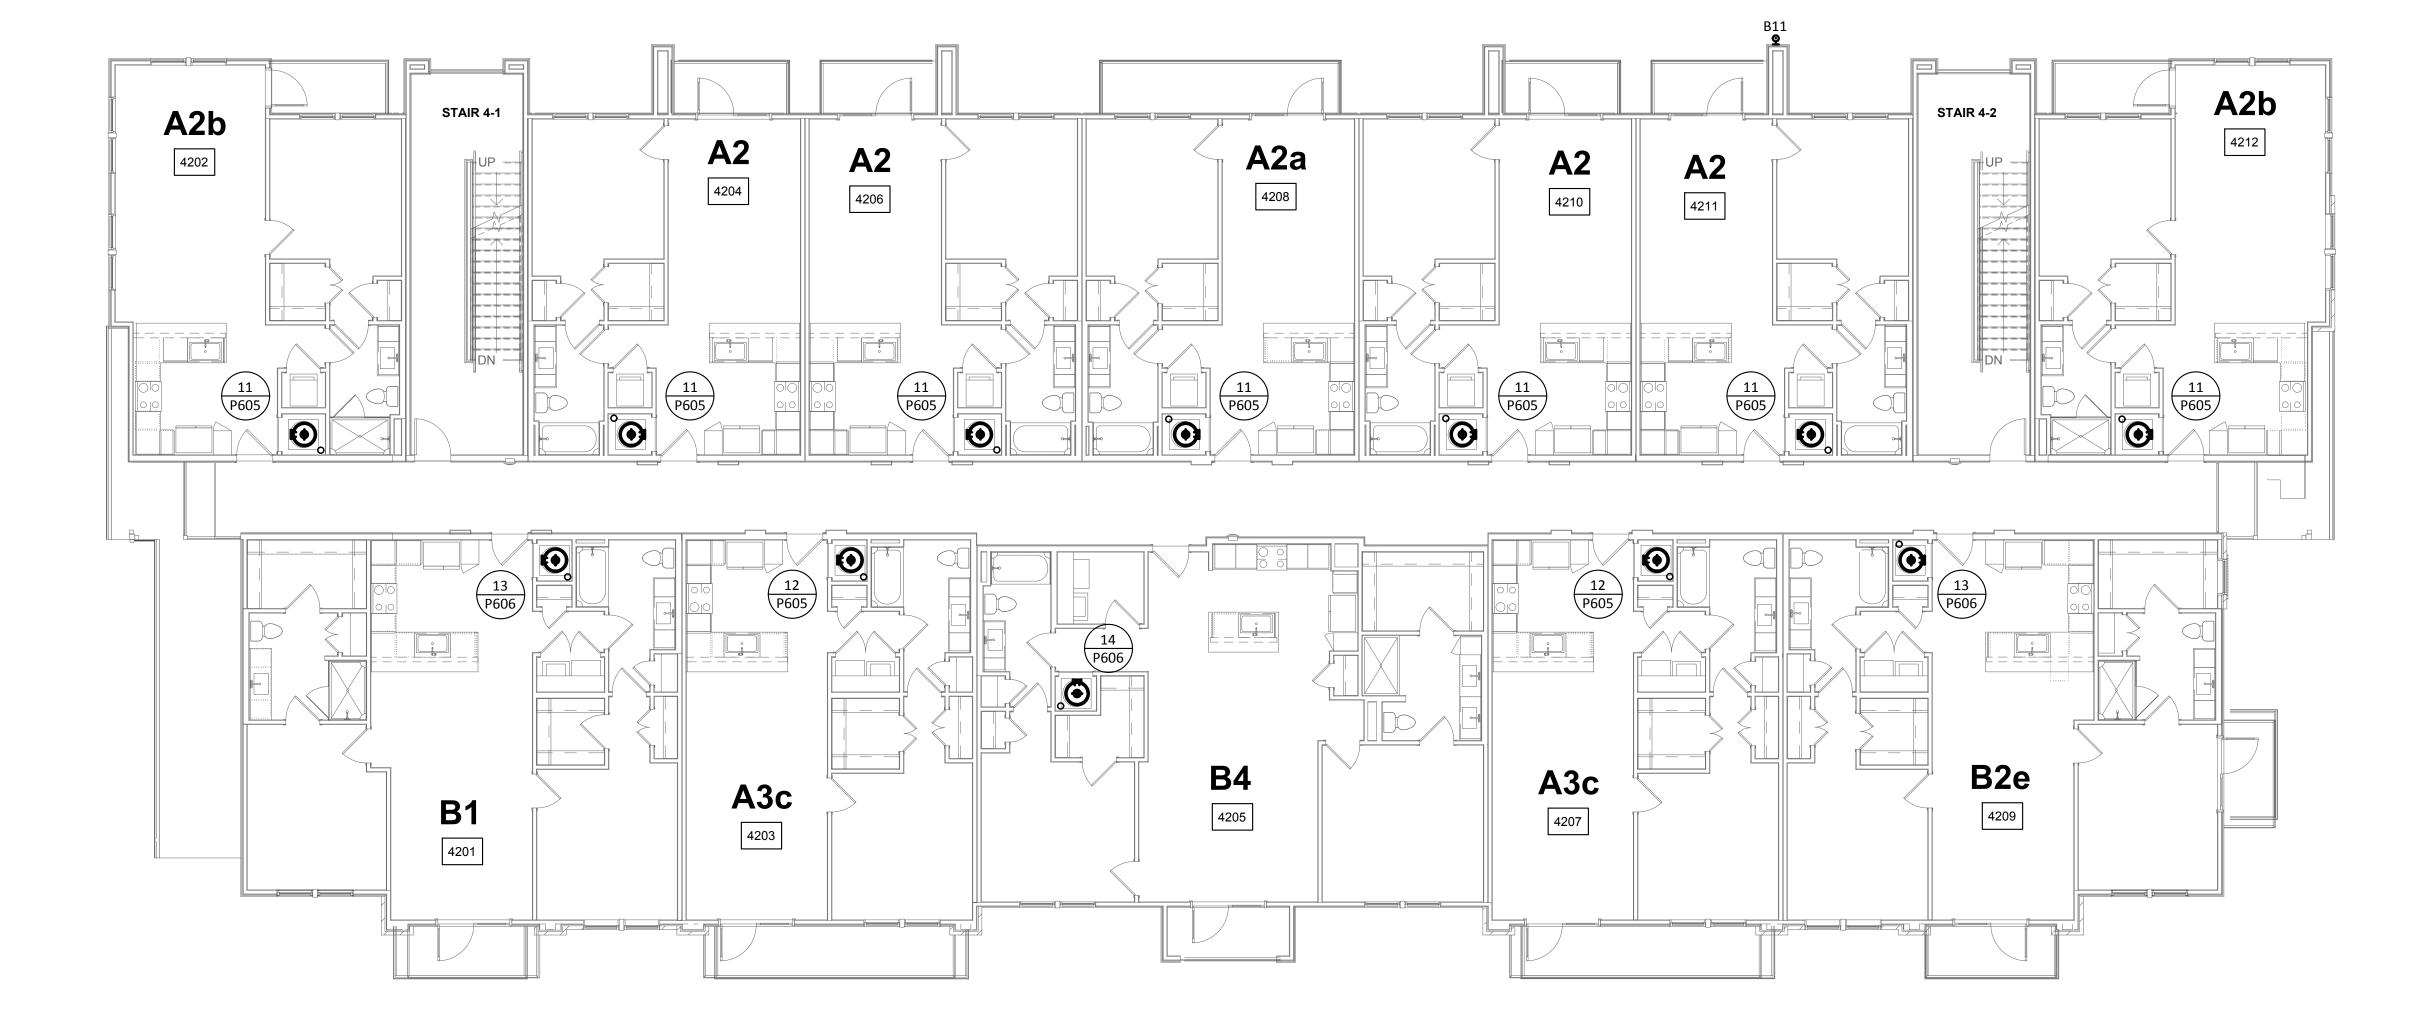

PLUMBING DOMESTIC WATER - BUILDING II (#4) - LEVEL 2

SCALE: 1/8"=1'-0"



. REFER TO SHEET P000 FOR ADDITIONAL INFORMATION.

REFER TO DOMESTIC WATER RISER DIAGRAMS ON SHEETS P605 & P606 FOR VERTICAL PIPE SIZING BETWEEN FLOORS.



Structural Engineer:

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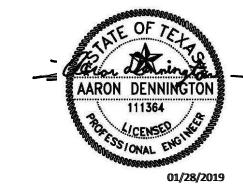
Landscape Architect:

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ISSUANCES		
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02	DEVELOPMENT DESIGN	11.09.18
03	PERMIT SET	01.28.19




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West Cevallos San Antonio, Texas

PLUMBING DOMESTIC WATER BLDG II (#2, #3 & #5) LEVEL 3


18054
01/14/2018
TLR
EEC

P225

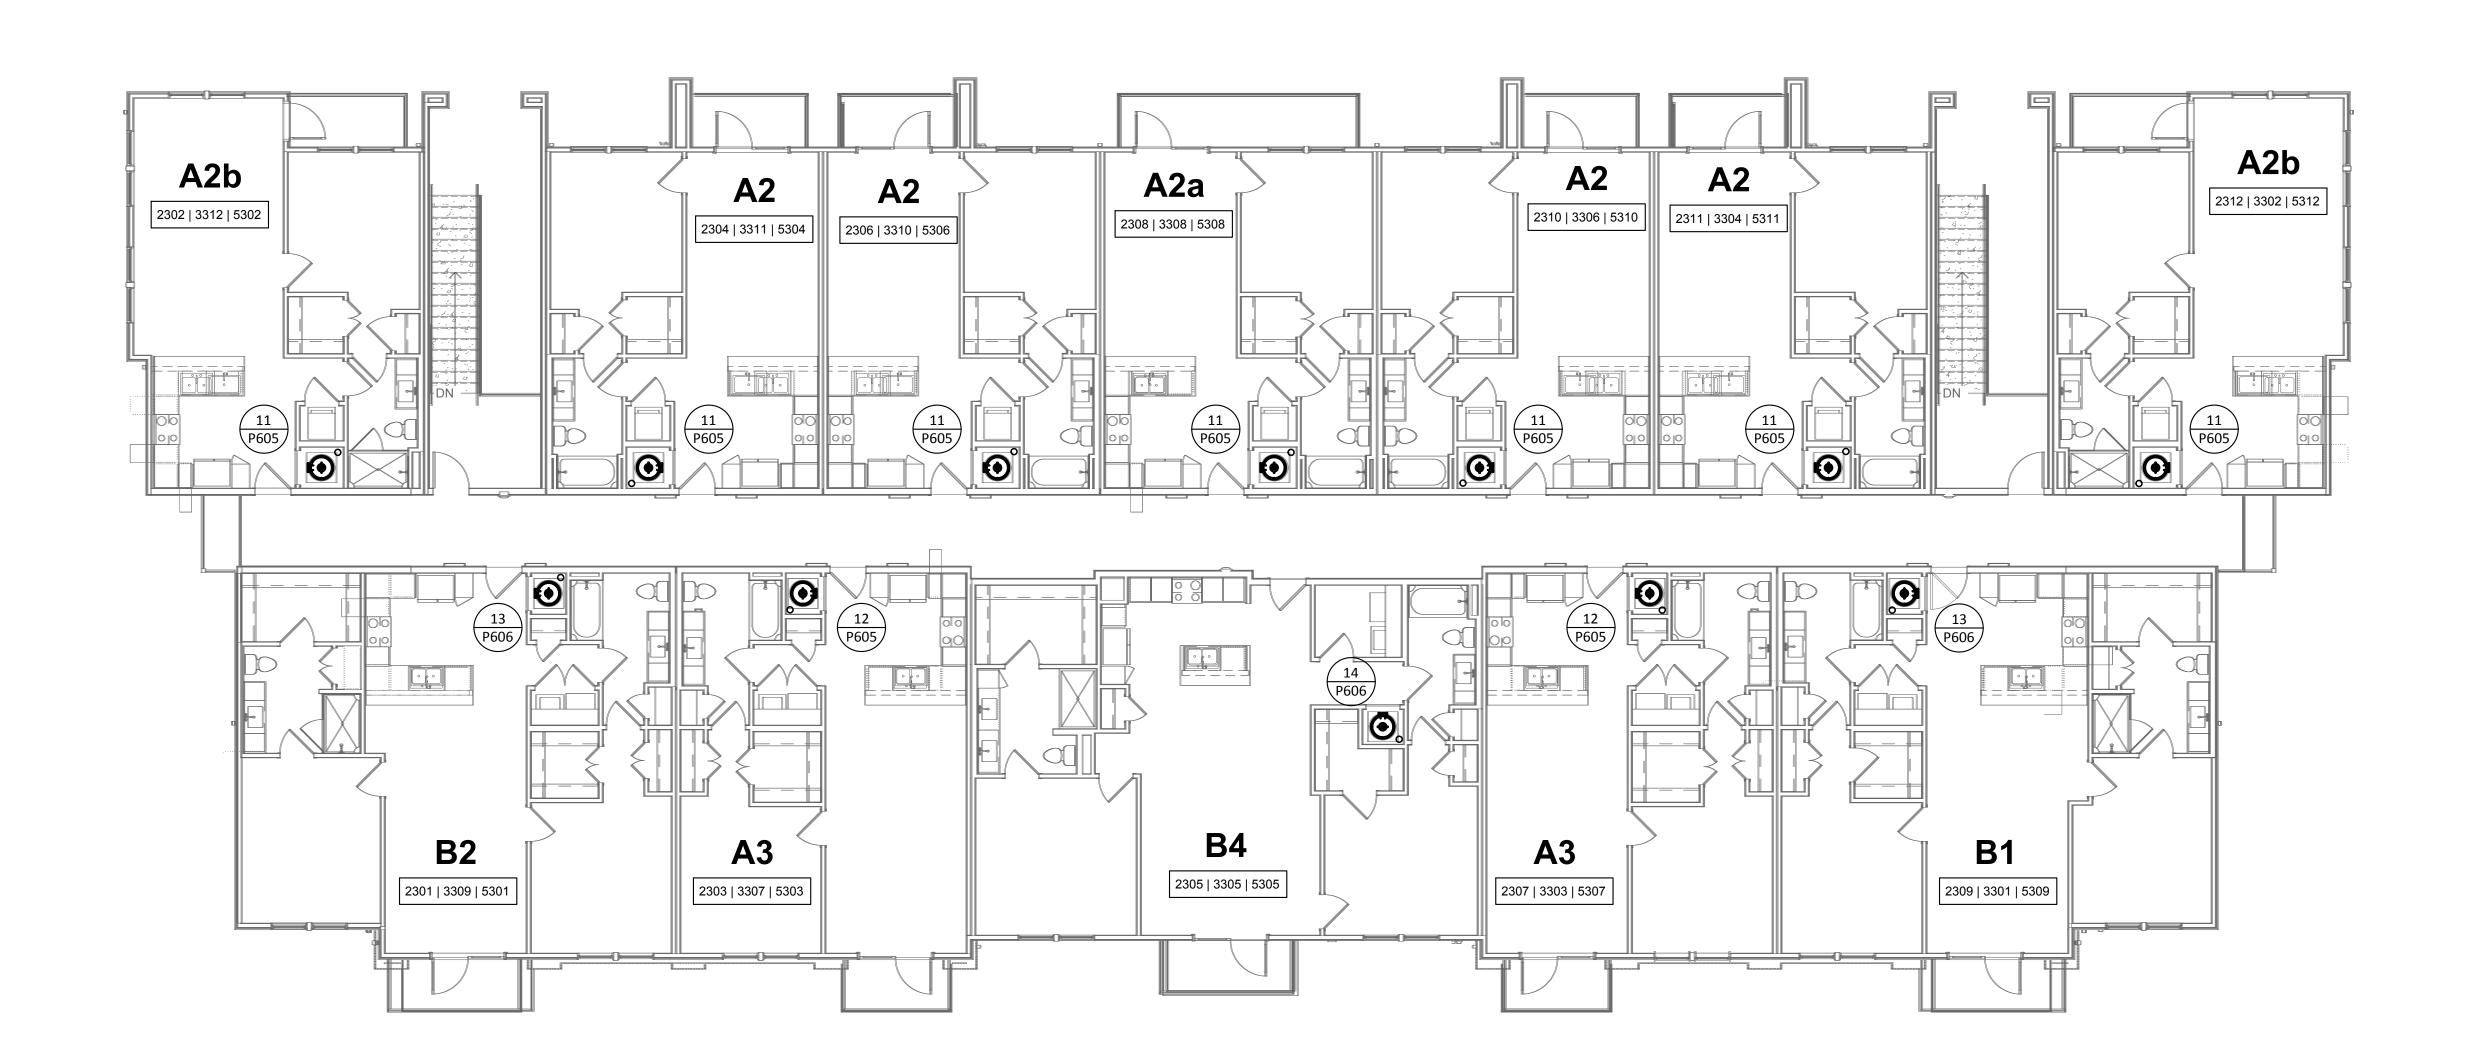

PLUMBING DOMESTIC WATER - BUILDING II (#2 & #5) - LEVEL 3

SCALE: 1/8"=1'-0"

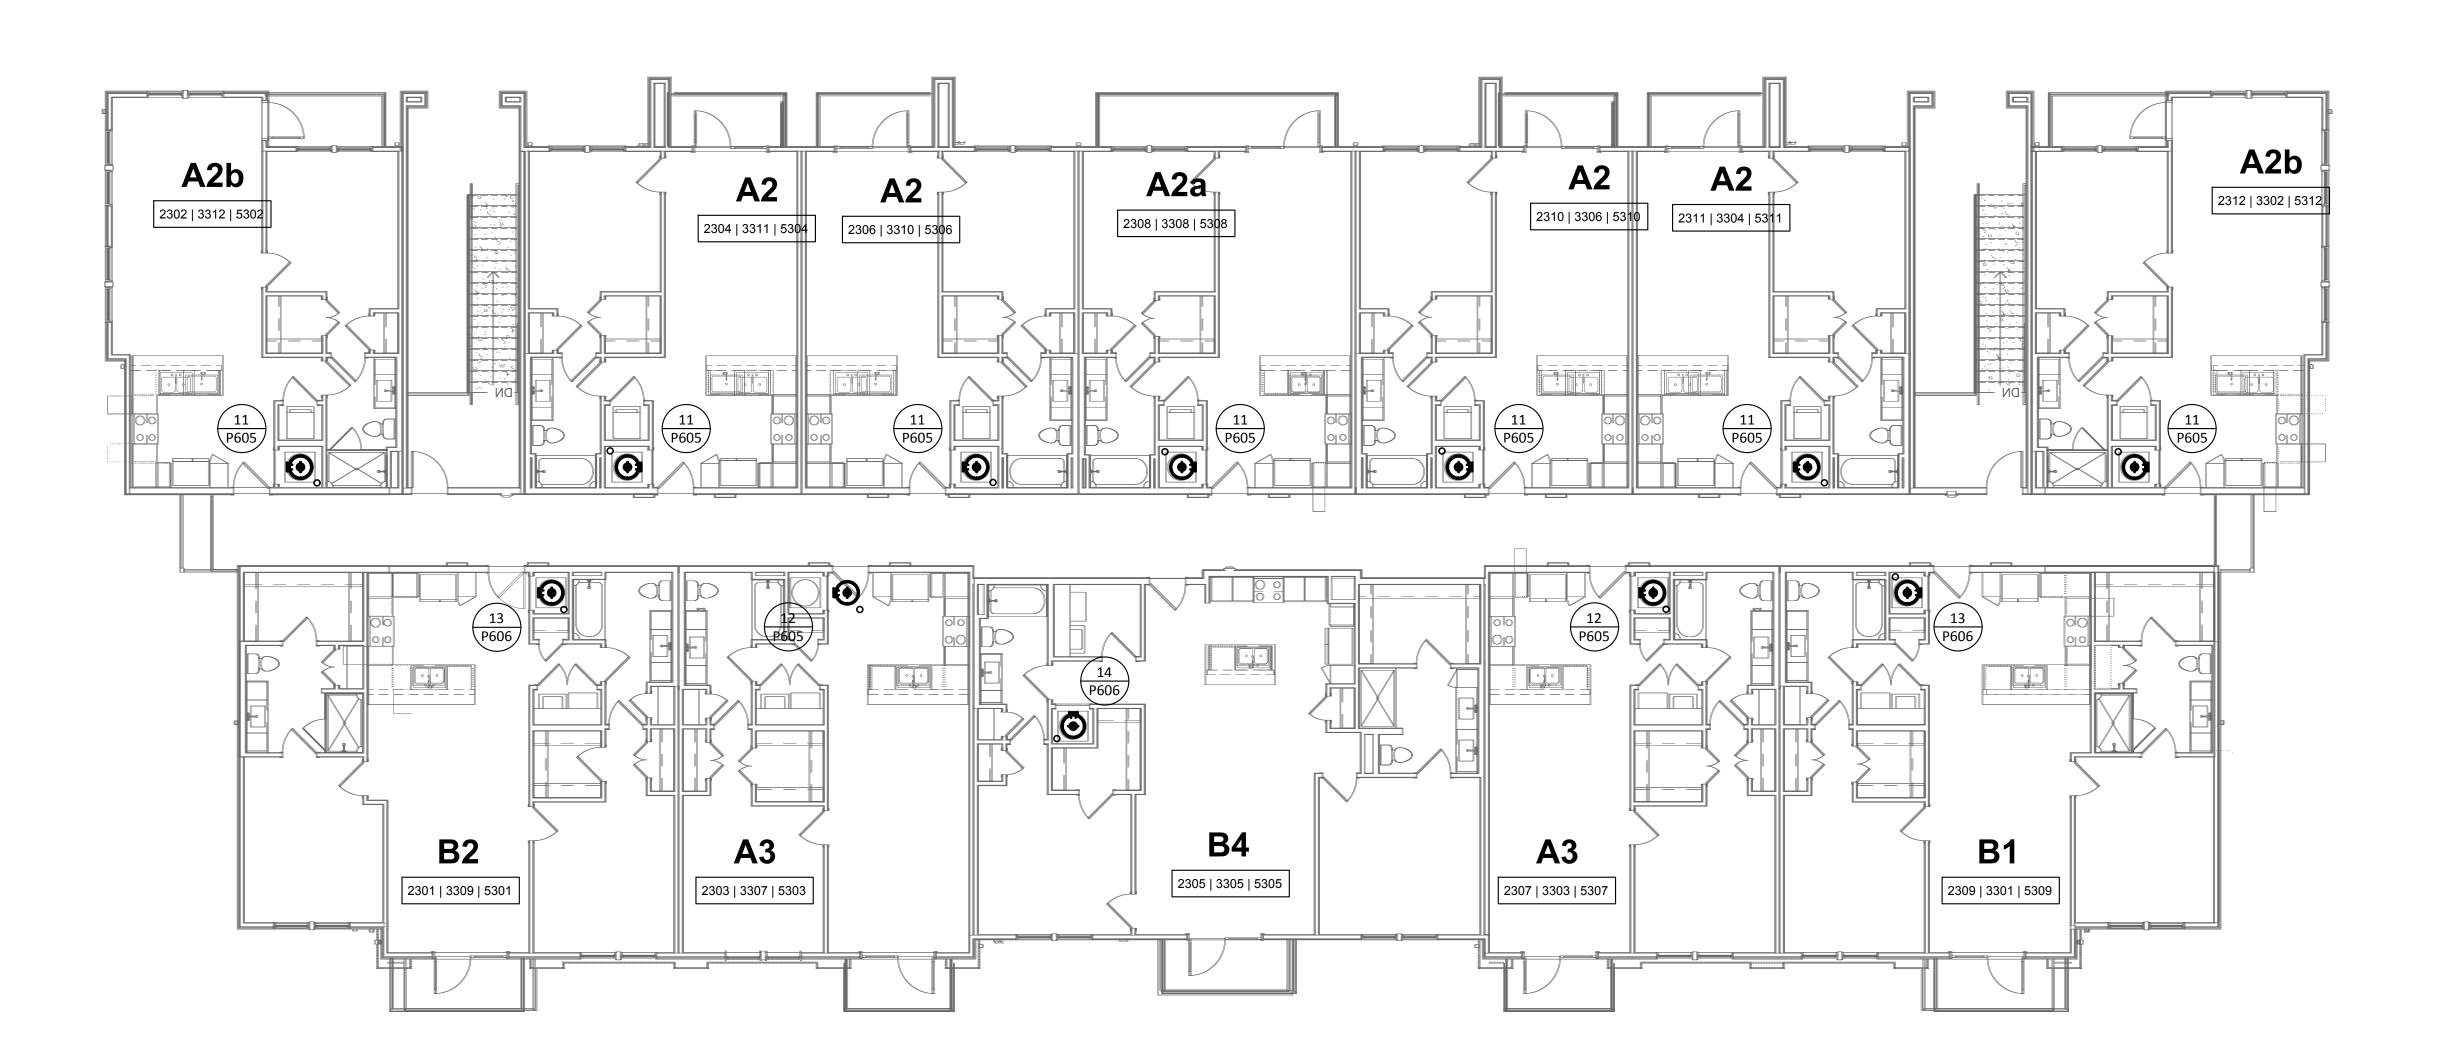



A. REFER TO SHEET POOD FOR ADDITIONAL INFORMATION.

REFER TO DOMESTIC WATER RISER DIAGRAMS ON SHEETS P605 & P606 FOR VERTICAL PIPE SIZING BETWEEN FLOORS.



Structural Engineer:

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ISSUANCES		
01	SCHEMATIC DESIGN	09.10.18
02	DEVELOPMENT DESIGN	11.09.18
03	PERMIT SET	01.28.19

REVISIONS




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West Cevallos
San Antonio, Texas

PLUMBING DOMESTIC WATER BLDG II (#4) LEVEL 3

Project Number	18054
Date	01/14/2018
Drawn By	TLR
Checked By	EEC


P226

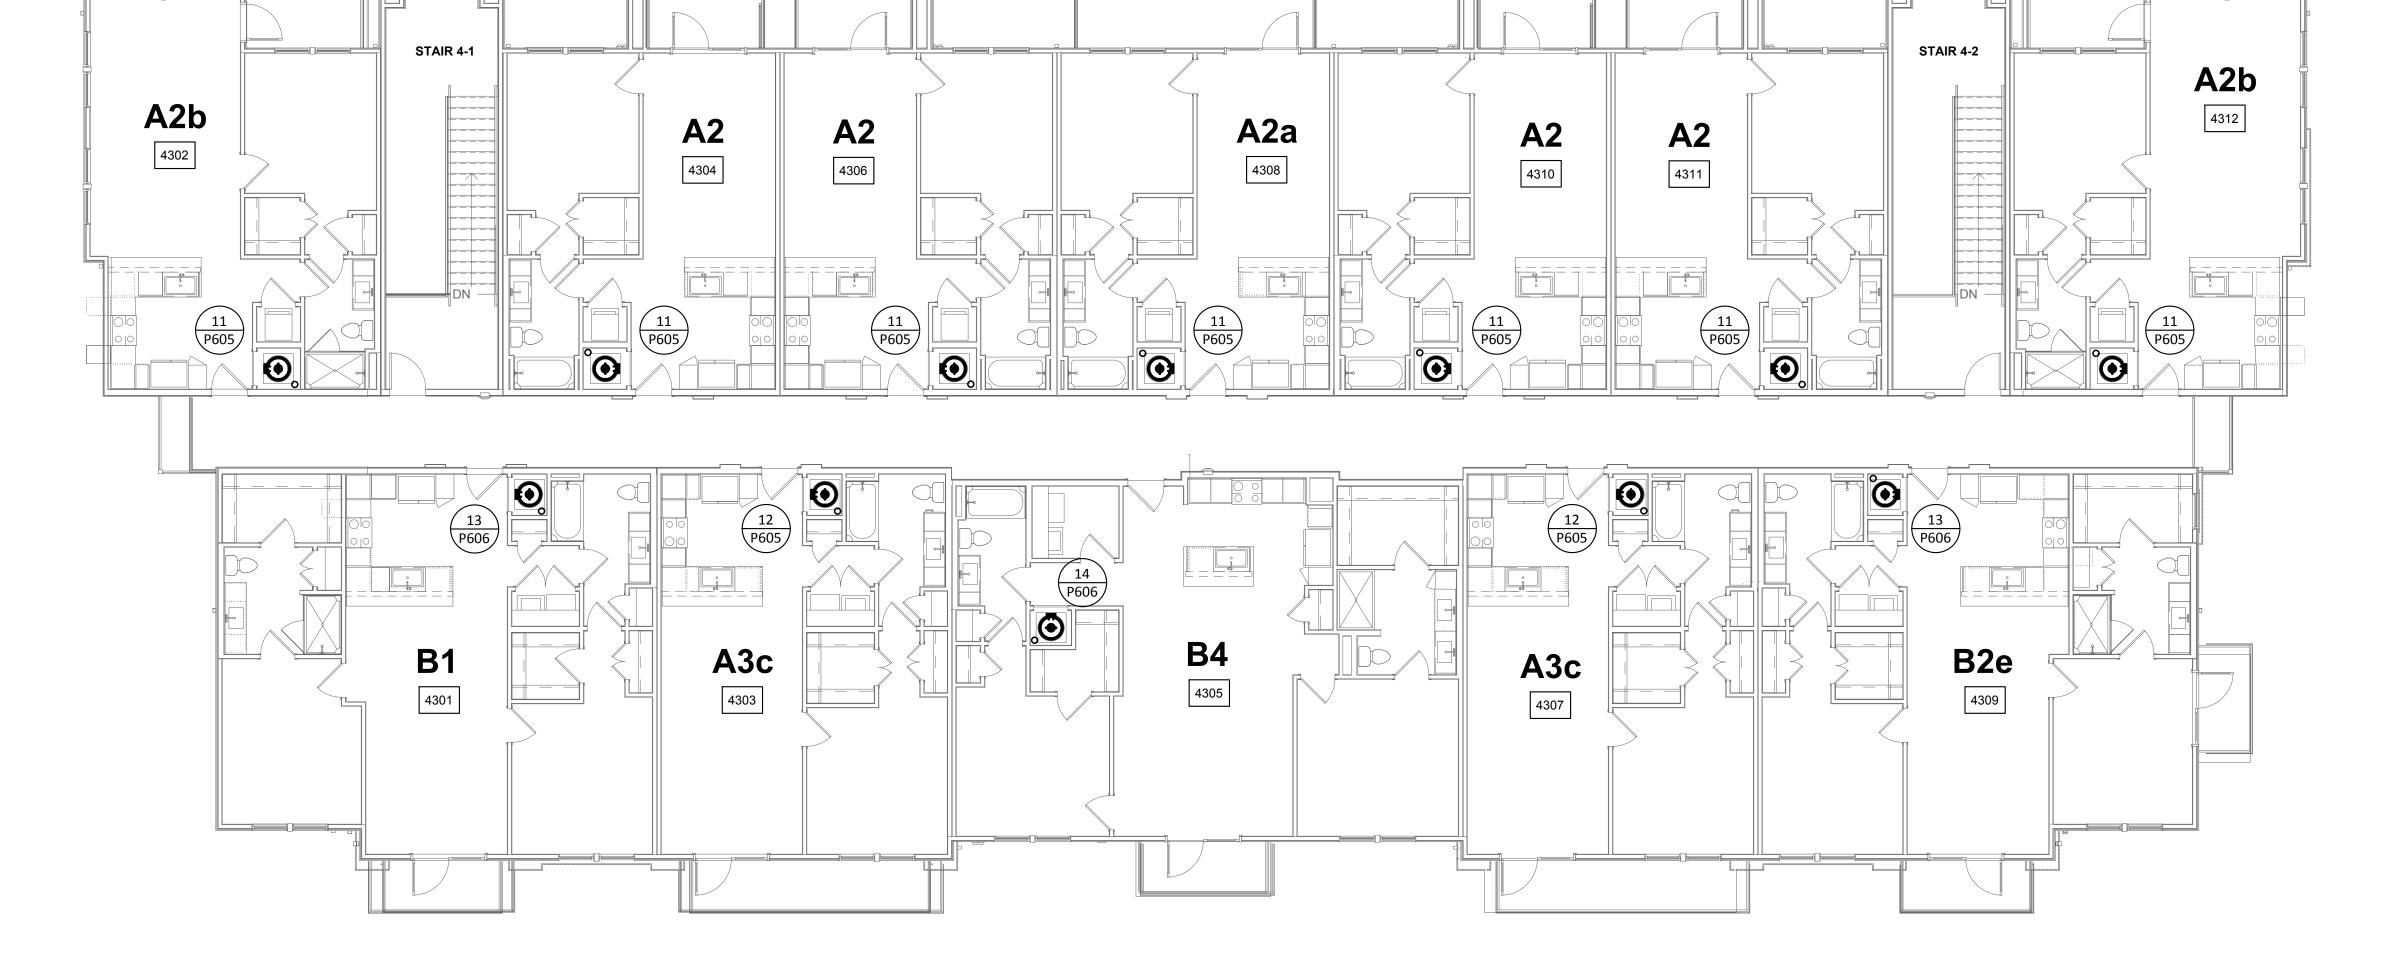


PLUMBING DOMESTIC WATER - BUILDING II (#4) - LEVEL 3

SCALE: 1/8"=1'-0"



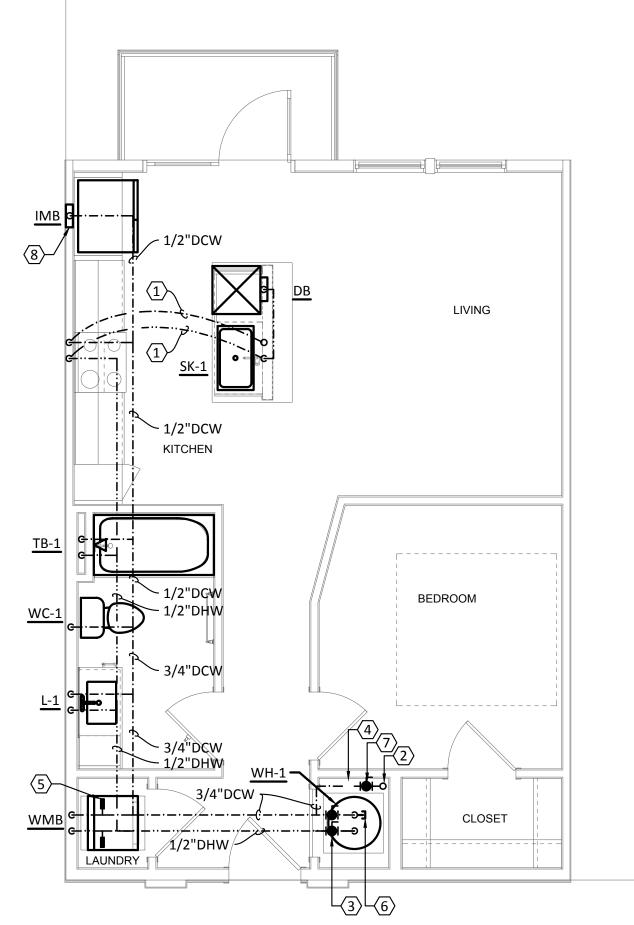

✓ PLUMBING - UNIT TYPE A1 SCALE: 1/4"=1'-0"

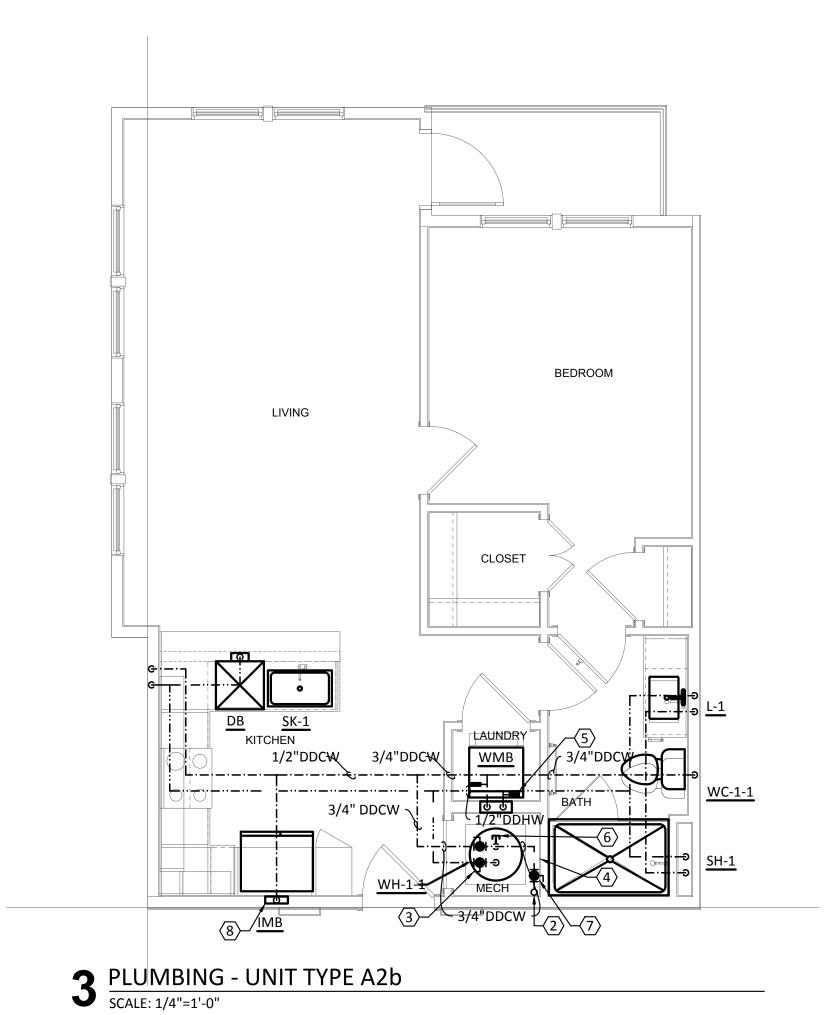

BEDROOM LIVING CLOSET

AND FLOOR SINKS.

KEYED NOTES:

DISDHWASHER BOX.

DRAIN IN MECHANICAL CLOSET.

RISER DIAGRAMS FOR VERTICAL PIPE SIZES.

PRIOR TO CONNECTION TO WATER HEATER.

REQUIREMENTS FOR ADDITIONAL INFORMATION.

PROVIDE ISOLATION VALVE PRIOR TO SUB-METER.

8. PROVIDE RPZ AT ALL REFRIGERATOR ICE MAKERS.

COORDINATED WITH ARCHITECT. REFER TO DETAIL 1/P701

A. REFER TO SHEET P000 FOR ADDITIONAL INFORMATION.

PROVIDE PROSET TRAP GUARDS AT ALL AIR HANDLER CLOSET HUB DRAINS.

DO NOT ROUTE PIPING OVER ELECTRICAL PANELS OR ELECTRICAL EQUIPMENT.

PROVIDE JAY R. SMITH #3101L TRAP PRIMERS AT ALL HUB DRAINS, FLOOR DRAIN

WASTE CONNECTION OF A RESIDENTIAL DISHWASHER SHALL CONNECT DIRECTLY T A WYE BRANCH FITTING ON THE TAILPIECE OF THE KITCHEN SINK, DIRECTLY TO THE DISHWASHER CONNECTION OF A FOOD WASTE DISPOSER, OR THROUGH AN AIR

BREAK TO A STANDPIPE. THE WASTE LINE OF A RESIDENTIAL DISHWASHER SHALL

ROUTE INSULATED T & P RELIEF VALVE AND WATER HEATER DRAIN PAN TO HUB

ROUTE COLD AND HOT WATER PIPING BENEATH FLOOR FROM WALL TO ISLAND

KITCHEN SINK. RISE UP UNDER COUNTERTOP. EXTEND 1/2" HOT WATER LINE TO

COLD WATER RISER UP IN WALL FROM FIRST FLOOR TRUSS/JOIST SPACE. REFER TO BUILDING PLANS FOR CONTINUATION. REFER TO DOMESTIC COLD WATER

PROVIDE ISOLATION VALVE ON DOMESTIC WATER AND HOT WATER SUPPLY

PROVIDE WATER SUB-METER. INSTALL IN EASILY ACCESSIBLE LOCATION FOR


PROVIDE "A" SIZE WATER HAMMER ARRESTOR ON 1/2" DCW AND 1/2" DHW WATER PIPES IN WASHER CONNECTION BOX. WASHER BOX HEIGHT SHALL BE


PROVIDE VACUUM RELIEF VALVE ON THE COLD WATER SUPPLY LINE ABOVE THE

TOP OF THE WATER HEATER. VALVE SHALL COMPLY WITH ANSI Z21.22.

READING AND MAINTENANCE. REFER TO LOCAL UTILITY COMPANY

RISE AND BE SECURELY FASTENED TO THE UNDERSID EOF THE SINK RIM OR

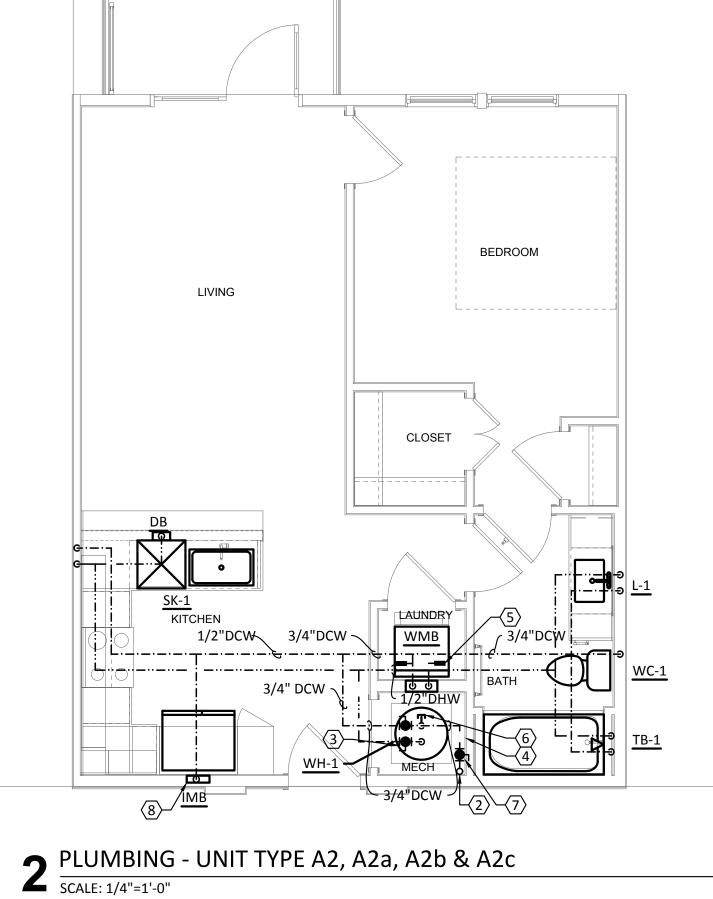

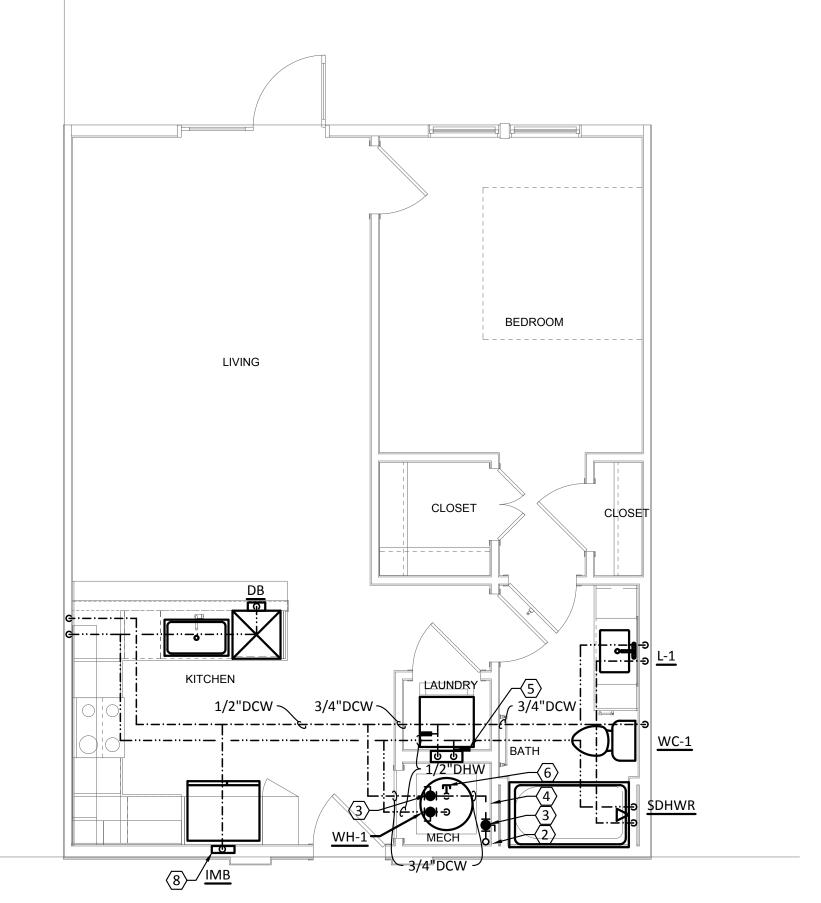

PLUMBING - UNIT TYPE A2c, A2d, A2e & A2f

SCALE: 1/4"=1'-0"





Structural Engineer:

VIEWTECH INC. 4205 Beltway Dr. Addison, TX 75001 Victor Lisiak III 972.661.8187

MEP Engineer:

ENCOTECH 8500 Bluffstone Cove, Austin, TX. 78759 Tessa Roberts 512.338.1101

Civil Engineer:

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Landscape Architect:

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Interior Designer:

SJL Design Group 921 N. Riverfront Blvd. Suite 100, Dallas, TX 75207 Cassie Farley 214.443.9090

09.10.18


11.09.18

01.28.19

ISSUANCES SCHEMATIC DESIGN DEVELOPMENT DESIGN

PERMIT SET

REVISIONS

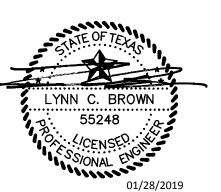


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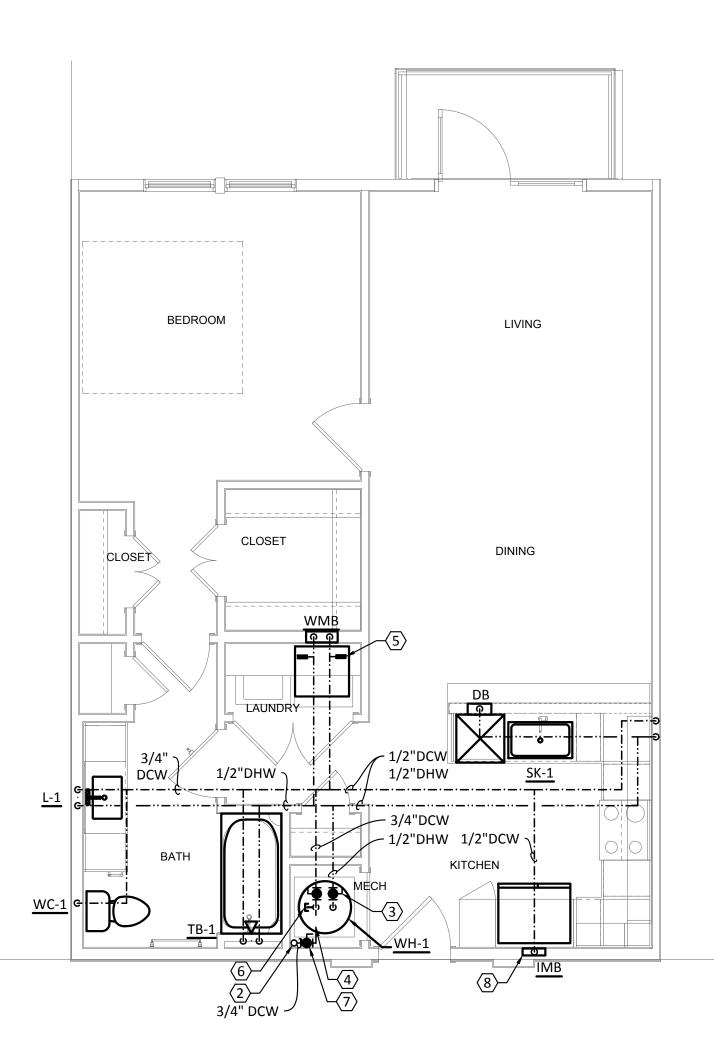
West Cevallos San Antonio, Texas

PLUMBING UNIT A1 & A2


18054 Project Number 01/14/2018 TLR Drawn By Checked By

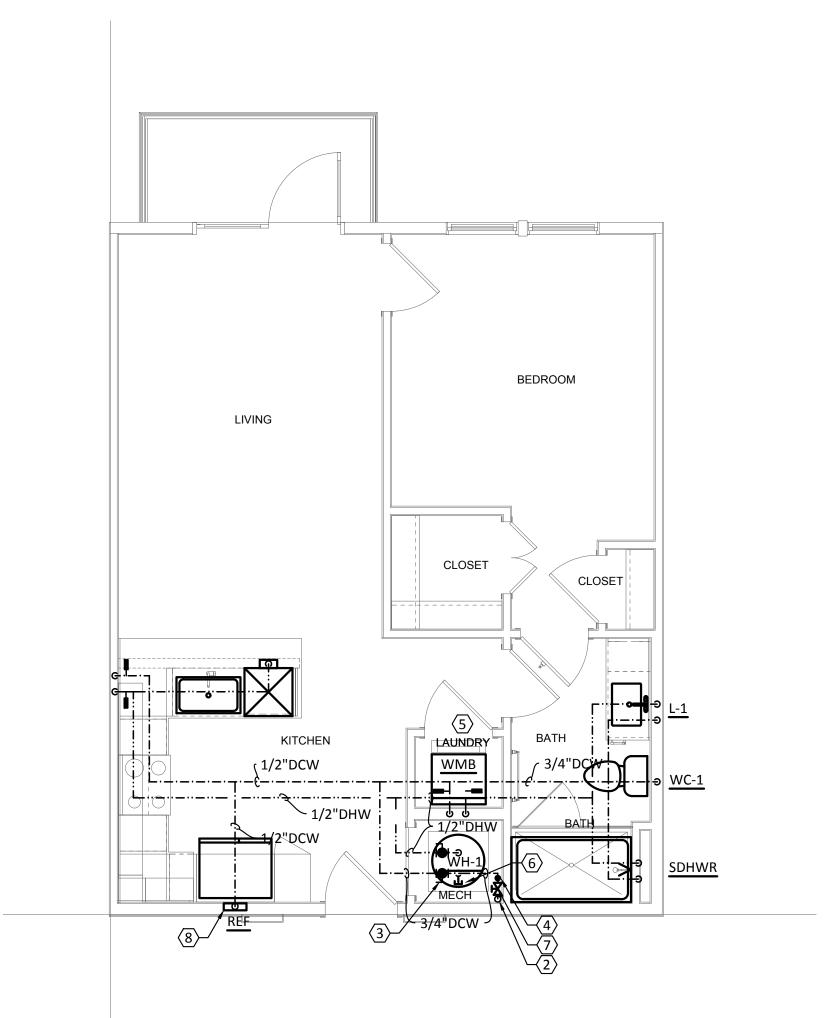

PLUMBING - UNIT TYPE A2-ALT-1
SCALE: 1/4"=1'-0"




2 PLUMBING - UNIT TYPE A3, A3a, A3b & A3c SCALE: 1/4"=1'-0"

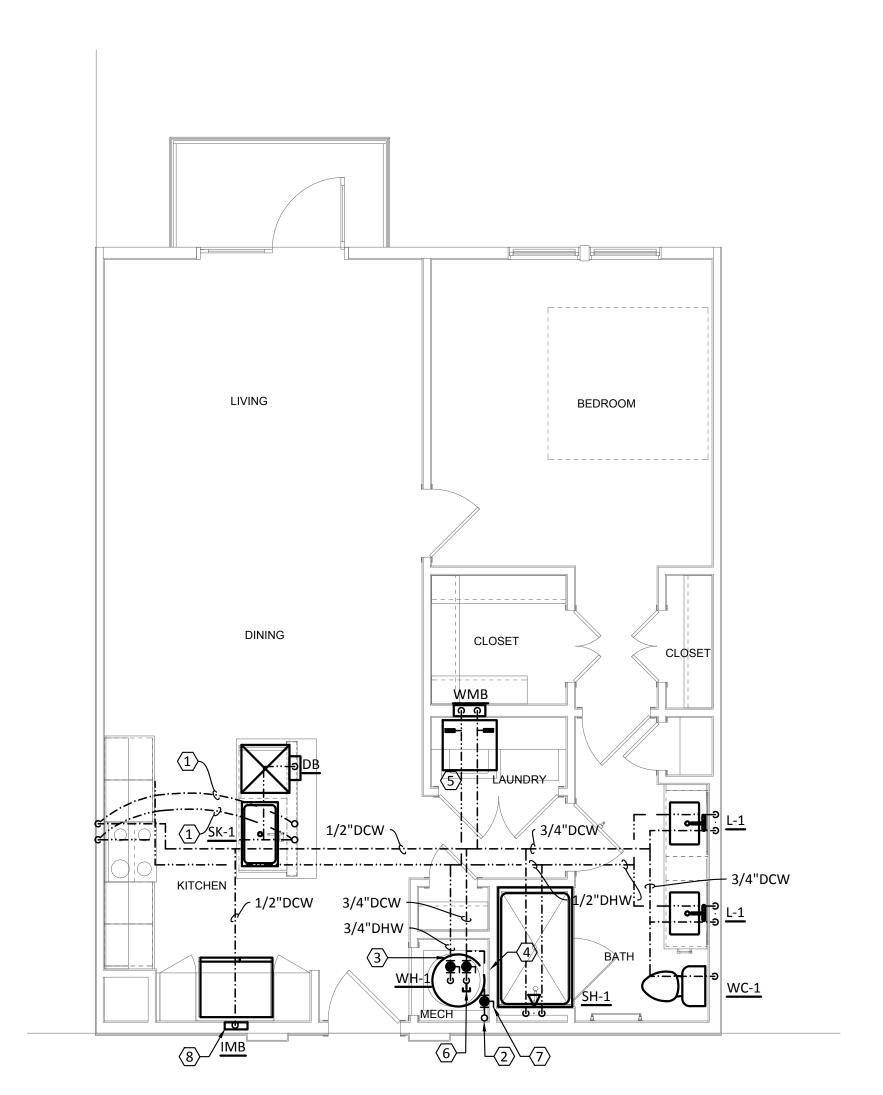

3 PLUMBING - UNIT TYPE A4, A4a & A4b

SCALE: 1/4"=1'-0"

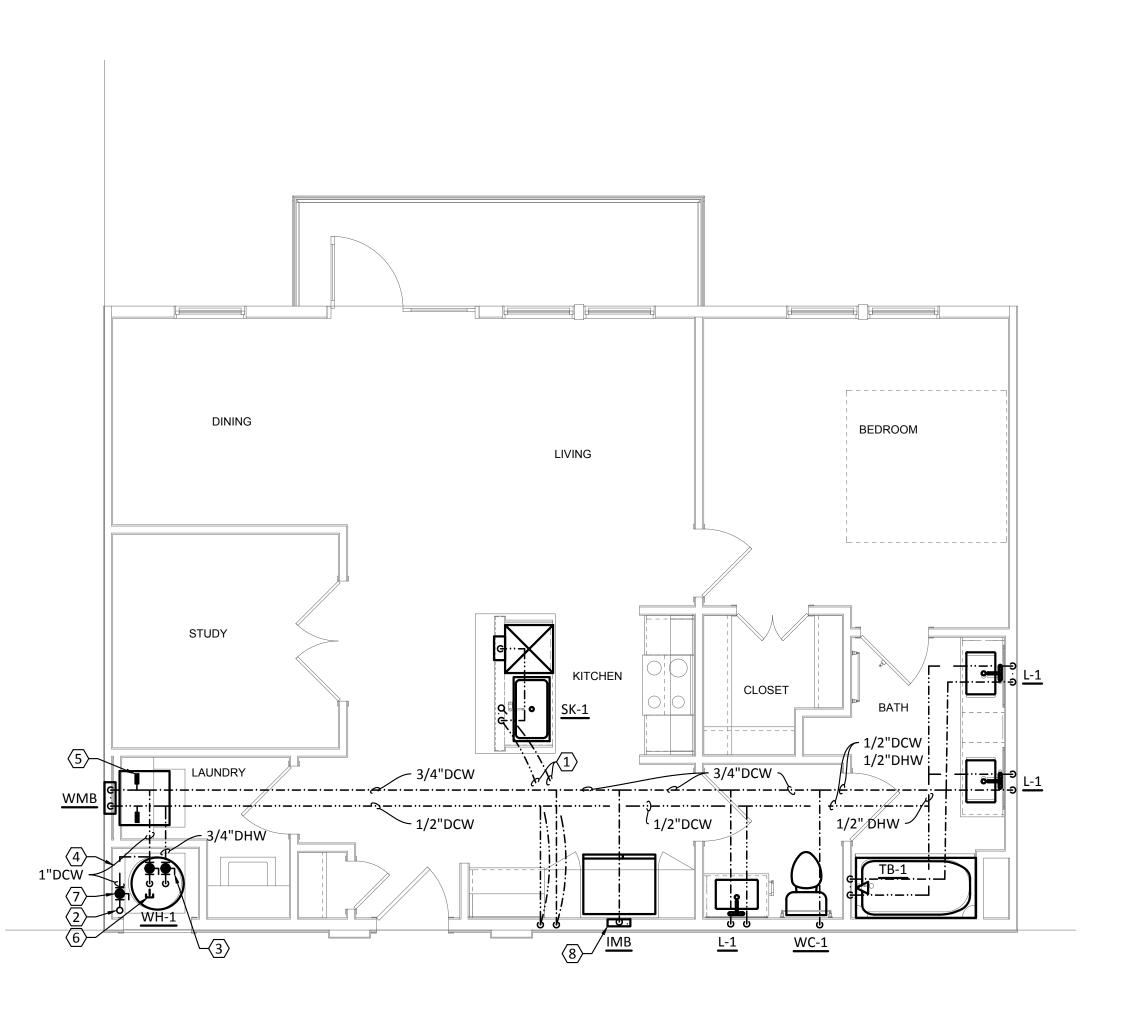

PLUMBING - UNIT TYPE A5

SCALE: 1/4"=1'-0"



GENERAL NOTES:

- A. REFER TO SHEET P000 FOR ADDITIONAL INFORMATION.
- PROVIDE PROSET TRAP GUARDS AT ALL AIR HANDLER CLOSET HUB DRAINS.
- DO NOT ROUTE PIPING OVER ELECTRICAL PANELS OR ELECTRICAL EQUIPMENT.
- D. PROVIDE JAY R. SMITH #3101L TRAP PRIMERS AT ALL HUB DRAINS, FLOOR DRAIN AND FLOOR SINKS.
- E. WASTE CONNECTION OF A RESIDENTIAL DISHWASHER SHALL CONNECT DIRECTLY TO A WYE BRANCH FITTING ON THE TAILPIECE OF THE KITCHEN SINK, DIRECTLY TO THE DISHWASHER CONNECTION OF A FOOD WASTE DISPOSER, OR THROUGH AN AIR BREAK TO A STANDPIPE. THE WASTE LINE OF A RESIDENTIAL DISHWASHER SHALL RISE AND BE SECURELY FASTENED TO THE UNDERSID EOF THE SINK RIM OR
- ROUTE INSULATED T & P RELIEF VALVE AND WATER HEATER DRAIN PAN TO HUB DRAIN IN MECHANICAL CLOSET.

KEYED NOTES:

- ROUTE COLD AND HOT WATER PIPING BENEATH FLOOR FROM WALL TO ISLAND KITCHEN SINK. RISE UP UNDER COUNTERTOP. EXTEND 1/2" HOT WATER LINE TO DISDHWASHER BOX.
- COLD WATER RISER UP IN WALL FROM FIRST FLOOR TRUSS/JOIST SPACE. REFER TO BUILDING PLANS FOR CONTINUATION. REFER TO DOMESTIC COLD WATER RISER DIAGRAMS FOR VERTICAL PIPE SIZES.
- PROVIDE ISOLATION VALVE ON DOMESTIC WATER AND HOT WATER SUPPLY PRIOR TO CONNECTION TO WATER HEATER.
- PROVIDE WATER SUB-METER. INSTALL IN EASILY ACCESSIBLE LOCATION FOR READING AND MAINTENANCE. REFER TO LOCAL UTILITY COMPANY REQUIREMENTS FOR ADDITIONAL INFORMATION.
- 5. PROVIDE "A" SIZE WATER HAMMER ARRESTOR ON 1/2" DCW AND 1/2" DHW WATER PIPES IN WASHER CONNECTION BOX. WASHER BOX HEIGHT SHALL BE COORDINATED WITH ARCHITECT. REFER TO DETAIL 1/P701
- PROVIDE VACUUM RELIEF VALVE ON THE COLD WATER SUPPLY LINE ABOVE THE TOP OF THE WATER HEATER. VALVE SHALL COMPLY WITH ANSI Z21.22.
- PROVIDE ISOLATION VALVE PRIOR TO SUB-METER.
- 8. PROVIDE RPZ AT ALL REFRIGERATOR ICE MAKERS.



Structural Engineer:

VIEWTECH INC. 4205 Beltway Dr. Addison, TX 75001 Victor Lisiak III 972.661.8187

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Interior Designer:

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ISSUANCES 01 SCHEMATIC DESIGN 09.10.18 02 DEVELOPMENT DESIGN 11.09.18 03 PERMIT SET 01.28.19

REVISIONS



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West Cevallos
San Antonio, Texas

PLUMBING UNIT A2-ALT-1, A3, A4 & A5


Project Number 18054

Date 01/14/2018

Drawn By TLR


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P302

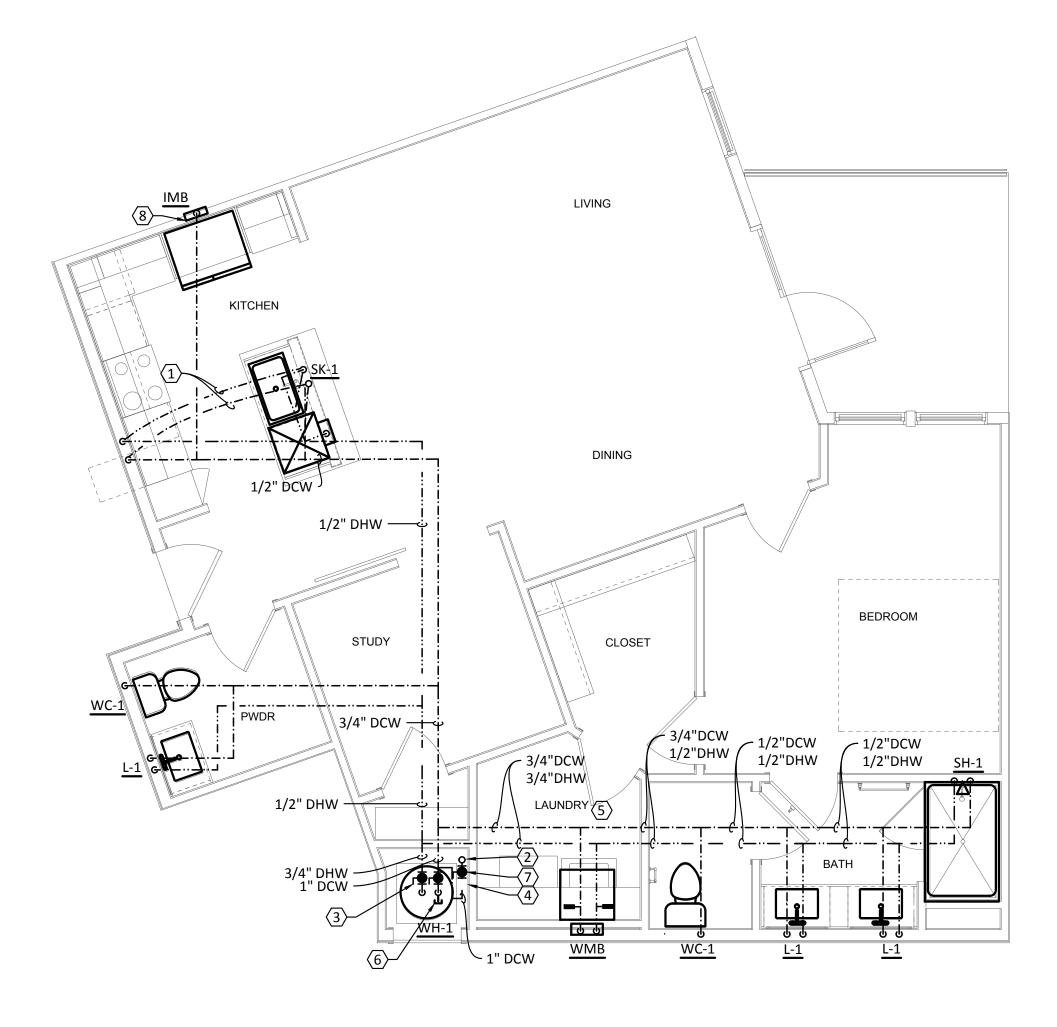

PLUMBING - UNIT TYPE A6

SCALE: 1/4"=1'-0"

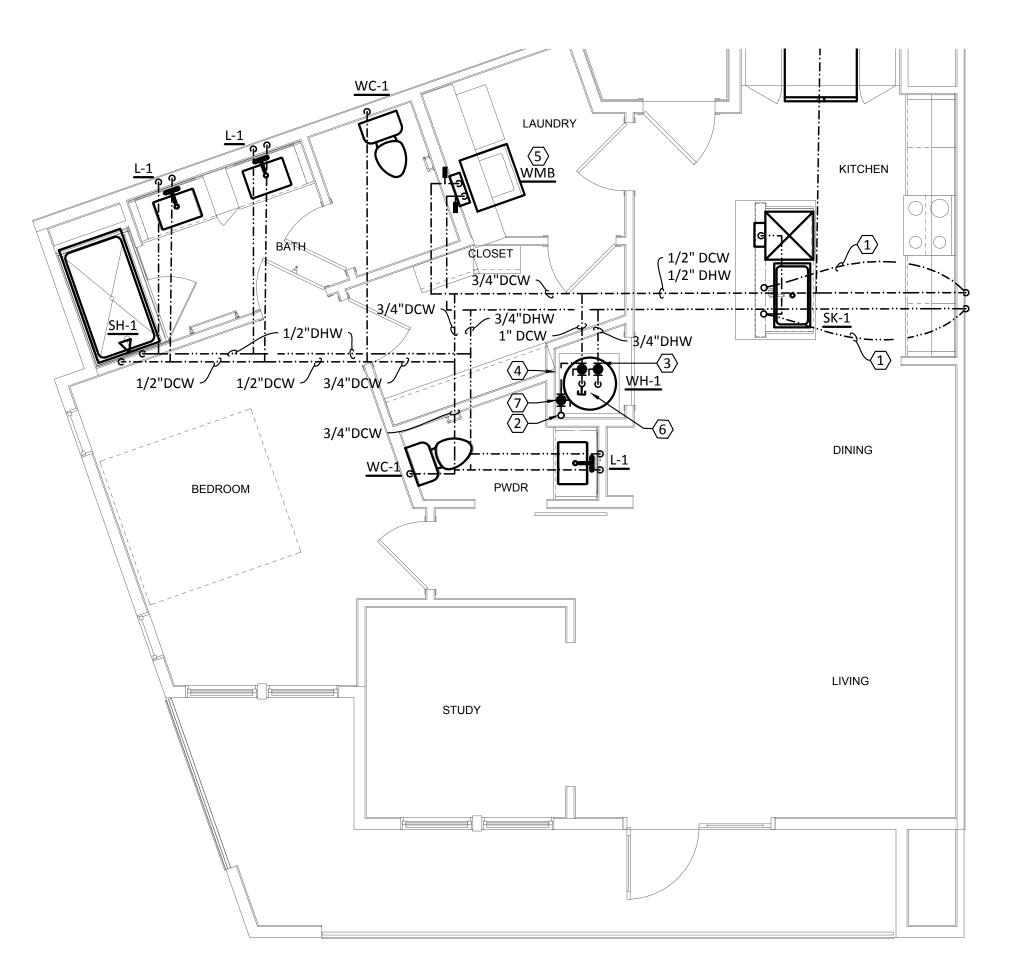

2 PLUMBING - UNIT TYPE A7
SCALE: 1/4"=1'-0"

GENERAL NOTES:

- A. REFER TO SHEET P000 FOR ADDITIONAL INFORMATION.
- PROVIDE PROSET TRAP GUARDS AT ALL AIR HANDLER CLOSET HUB DRAINS.
- DO NOT ROUTE PIPING OVER ELECTRICAL PANELS OR ELECTRICAL EQUIPMENT.
- PROVIDE JAY R. SMITH #3101L TRAP PRIMERS AT ALL HUB DRAINS, FLOOR DRAIN AND FLOOR SINKS.
- E. WASTE CONNECTION OF A RESIDENTIAL DISHWASHER SHALL CONNECT DIRECTLY TO A WYE BRANCH FITTING ON THE TAILPIECE OF THE KITCHEN SINK, DIRECTLY TO THE DISHWASHER CONNECTION OF A FOOD WASTE DISPOSER, OR THROUGH AN AIR BREAK TO A STANDPIPE. THE WASTE LINE OF A RESIDENTIAL DISHWASHER SHALL RISE AND BE SECURELY FASTENED TO THE UNDERSID EOF THE SINK RIM OR
- ROUTE INSULATED T & P RELIEF VALVE AND WATER HEATER DRAIN PAN TO HUB DRAIN IN MECHANICAL CLOSET.

KEYED NOTES:

- 1. ROUTE COLD AND HOT WATER PIPING BENEATH FLOOR FROM WALL TO ISLAND KITCHEN SINK. RISE UP UNDER COUNTERTOP. EXTEND 1/2" HOT WATER LINE TO DISDHWASHER BOX.
- 2. COLD WATER RISER UP IN WALL FROM FIRST FLOOR TRUSS/JOIST SPACE. REFER TO BUILDING PLANS FOR CONTINUATION. REFER TO DOMESTIC COLD WATER RISER DIAGRAMS FOR VERTICAL PIPE SIZES.
- PROVIDE ISOLATION VALVE ON DOMESTIC WATER AND HOT WATER SUPPLY PRIOR TO CONNECTION TO WATER HEATER.
- PROVIDE WATER SUB-METER. INSTALL IN EASILY ACCESSIBLE LOCATION FOR READING AND MAINTENANCE. REFER TO LOCAL UTILITY COMPANY REQUIREMENTS FOR ADDITIONAL INFORMATION.
- 5. PROVIDE "A" SIZE WATER HAMMER ARRESTOR ON 1/2" DCW AND 1/2" DHW WATER PIPES IN WASHER CONNECTION BOX. WASHER BOX HEIGHT SHALL BE COORDINATED WITH ARCHITECT. REFER TO DETAIL 1/P701
- 6. PROVIDE VACUUM RELIEF VALVE ON THE COLD WATER SUPPLY LINE ABOVE THE TOP OF THE WATER HEATER. VALVE SHALL COMPLY WITH ANSI Z21.22.
- PROVIDE ISOLATION VALVE PRIOR TO SUB-METER.
- 8. PROVIDE RPZ AT ALL REFRIGERATOR ICE MAKERS.



Structural Engineer:

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ISSUANCES 01 SCHEMATIC DESIGN 09.10.18 02 DEVELOPMENT DESIGN 11.09.18 03 PERMIT SET 01.28.19

REVISIONS



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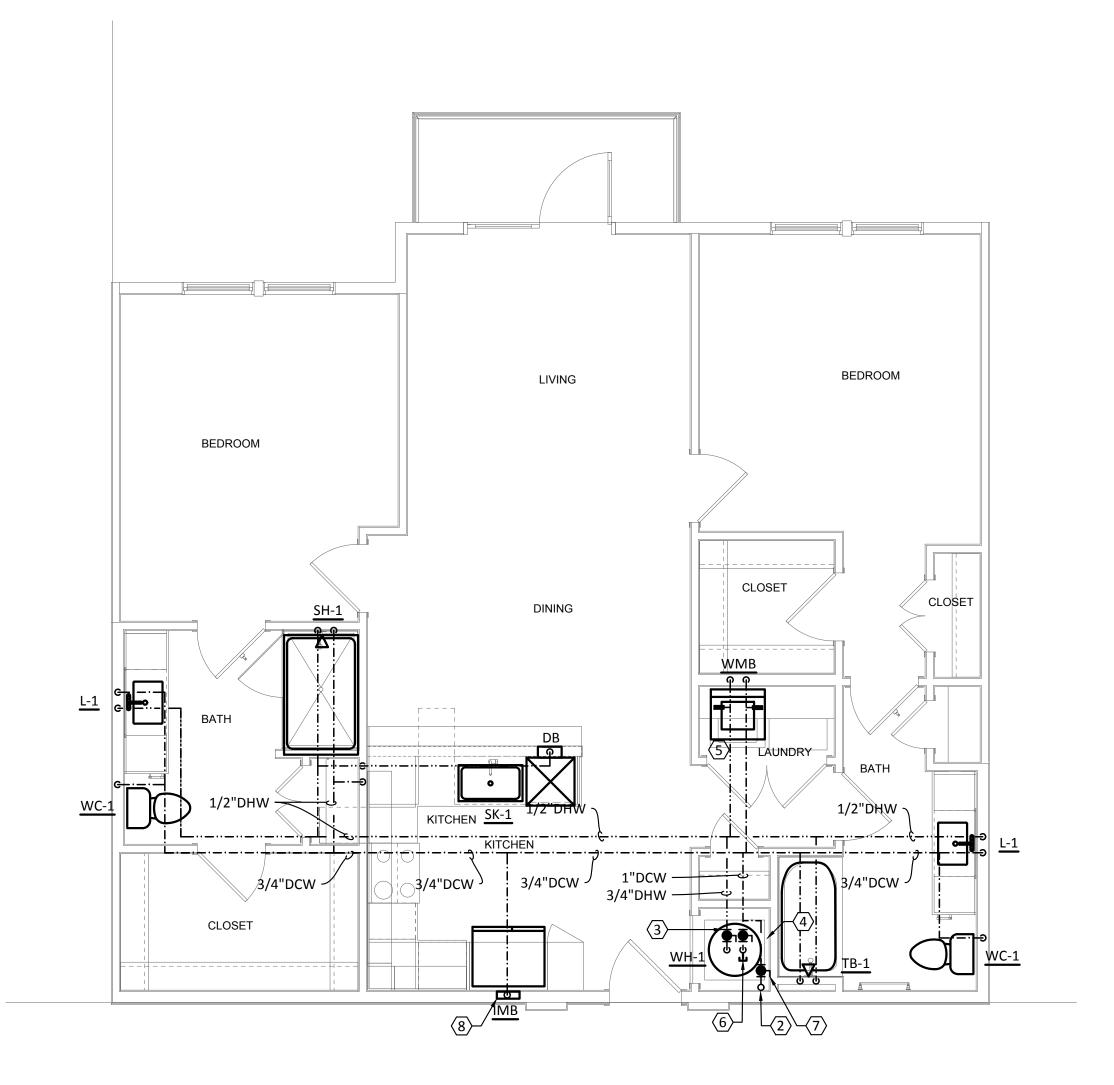
West Cevallos San Antonio, Texas

PLUMBING UNIT A6 & A7


18054
01/14/2018
TLR
EEC

P303





PLUMBING - UNIT TYPE B1, B1a & B1b SCALE: 1/4"=1'-0"

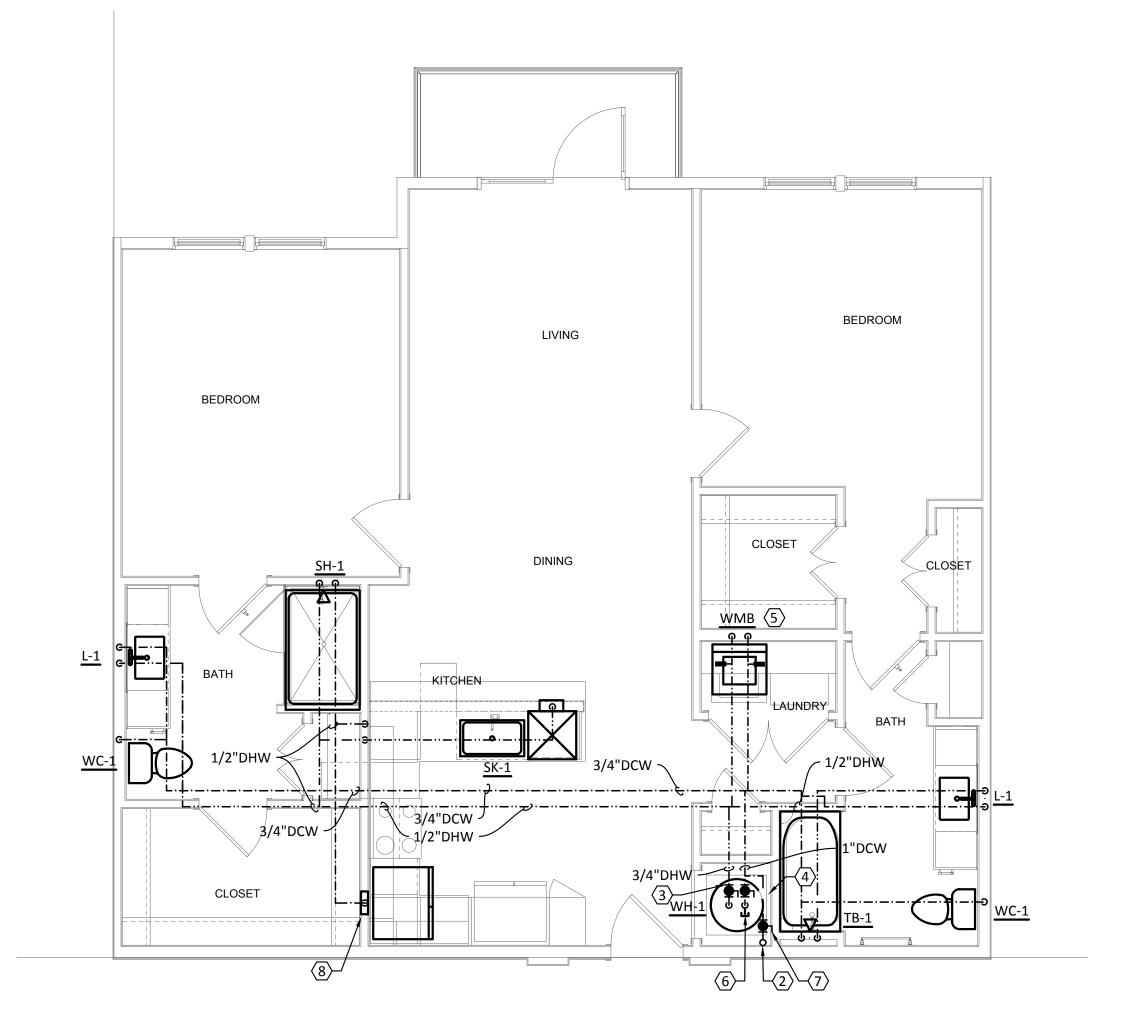

2 PLUMBING - UNIT TYPE B2, B2a, B2b, B2c, B2d & B2e SCALE: 1/4"=1'-0"



GENERAL NOTES:

- A. REFER TO SHEET P000 FOR ADDITIONAL INFORMATION.
- PROVIDE PROSET TRAP GUARDS AT ALL AIR HANDLER CLOSET HUB DRAINS.
- DO NOT ROUTE PIPING OVER ELECTRICAL PANELS OR ELECTRICAL EQUIPMENT.
- PROVIDE JAY R. SMITH #3101L TRAP PRIMERS AT ALL HUB DRAINS, FLOOR DRAIN AND FLOOR SINKS.
- WASTE CONNECTION OF A RESIDENTIAL DISHWASHER SHALL CONNECT DIRECTLY TO A WYE BRANCH FITTING ON THE TAILPIECE OF THE KITCHEN SINK, DIRECTLY TO THE DISHWASHER CONNECTION OF A FOOD WASTE DISPOSER, OR THROUGH AN AIR BREAK TO A STANDPIPE. THE WASTE LINE OF A RESIDENTIAL DISHWASHER SHALL RISE AND BE SECURELY FASTENED TO THE UNDERSID EOF THE SINK RIM OR
- ROUTE INSULATED T & P RELIEF VALVE AND WATER HEATER DRAIN PAN TO HUB DRAIN IN MECHANICAL CLOSET.

KEYED NOTES:

- ROUTE COLD AND HOT WATER PIPING BENEATH FLOOR FROM WALL TO ISLAND KITCHEN SINK. RISE UP UNDER COUNTERTOP. EXTEND 1/2" HOT WATER LINE TO DISDHWASHER BOX.
- COLD WATER RISER UP IN WALL FROM FIRST FLOOR TRUSS/JOIST SPACE. REFER TO BUILDING PLANS FOR CONTINUATION. REFER TO DOMESTIC COLD WATER RISER DIAGRAMS FOR VERTICAL PIPE SIZES.
- PROVIDE ISOLATION VALVE ON DOMESTIC WATER AND HOT WATER SUPPLY PRIOR TO CONNECTION TO WATER HEATER.
- PROVIDE WATER SUB-METER. INSTALL IN EASILY ACCESSIBLE LOCATION FOR READING AND MAINTENANCE. REFER TO LOCAL UTILITY COMPANY
- PROVIDE "A" SIZE WATER HAMMER ARRESTOR ON 1/2" DCW AND 1/2" DHW WATER PIPES IN WASHER CONNECTION BOX. WASHER BOX HEIGHT SHALL BE COORDINATED WITH ARCHITECT. REFER TO DETAIL 1/P701
- PROVIDE VACUUM RELIEF VALVE ON THE COLD WATER SUPPLY LINE ABOVE THE TOP OF THE WATER HEATER. VALVE SHALL COMPLY WITH ANSI Z21.22.
- PROVIDE ISOLATION VALVE PRIOR TO SUB-METER.

REQUIREMENTS FOR ADDITIONAL INFORMATION.

8. PROVIDE RPZ AT ALL REFRIGERATOR ICE MAKERS.



Structural Engineer:

VIEWTECH INC. 4205 Beltway Dr. Addison, TX 75001 Victor Lisiak III 972.661.8187

MEP Engineer:

ENCOTECH 8500 Bluffstone Cove, Austin, TX. 78759 Tessa Roberts 512.338.1101

Civil Engineer:

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Landscape Architect:

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Interior Designer:

SJL Design Group 921 N. Riverfront Blvd. Suite 100, Dallas, TX 75207 Cassie Farley 214.443.9090

ISSUANCES SCHEMATIC DESIGN 09.10.18 DEVELOPMENT DESIGN 11.09.18 01.28.19 PERMIT SET

REVISIONS




a multifamily project for NRP Group

West Cevallos San Antonio, Texas

PLUMBING UNIT B1 & B2

18054 Project Number 01/14/2018 TLR Drawn By EEC Checked By

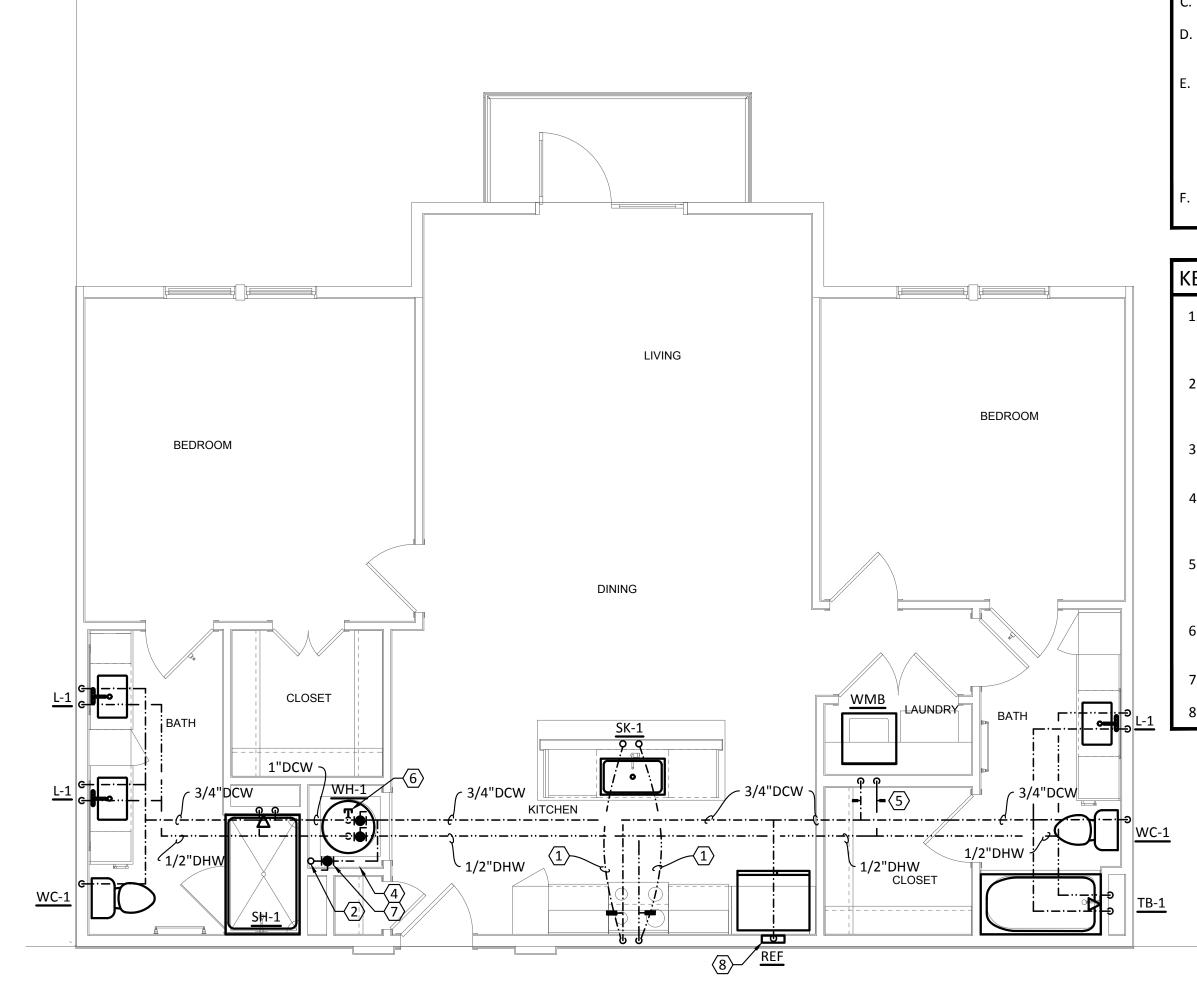

- A. REFER TO SHEET P000 FOR ADDITIONAL INFORMATION.
- PROVIDE PROSET TRAP GUARDS AT ALL AIR HANDLER CLOSET HUB DRAINS.
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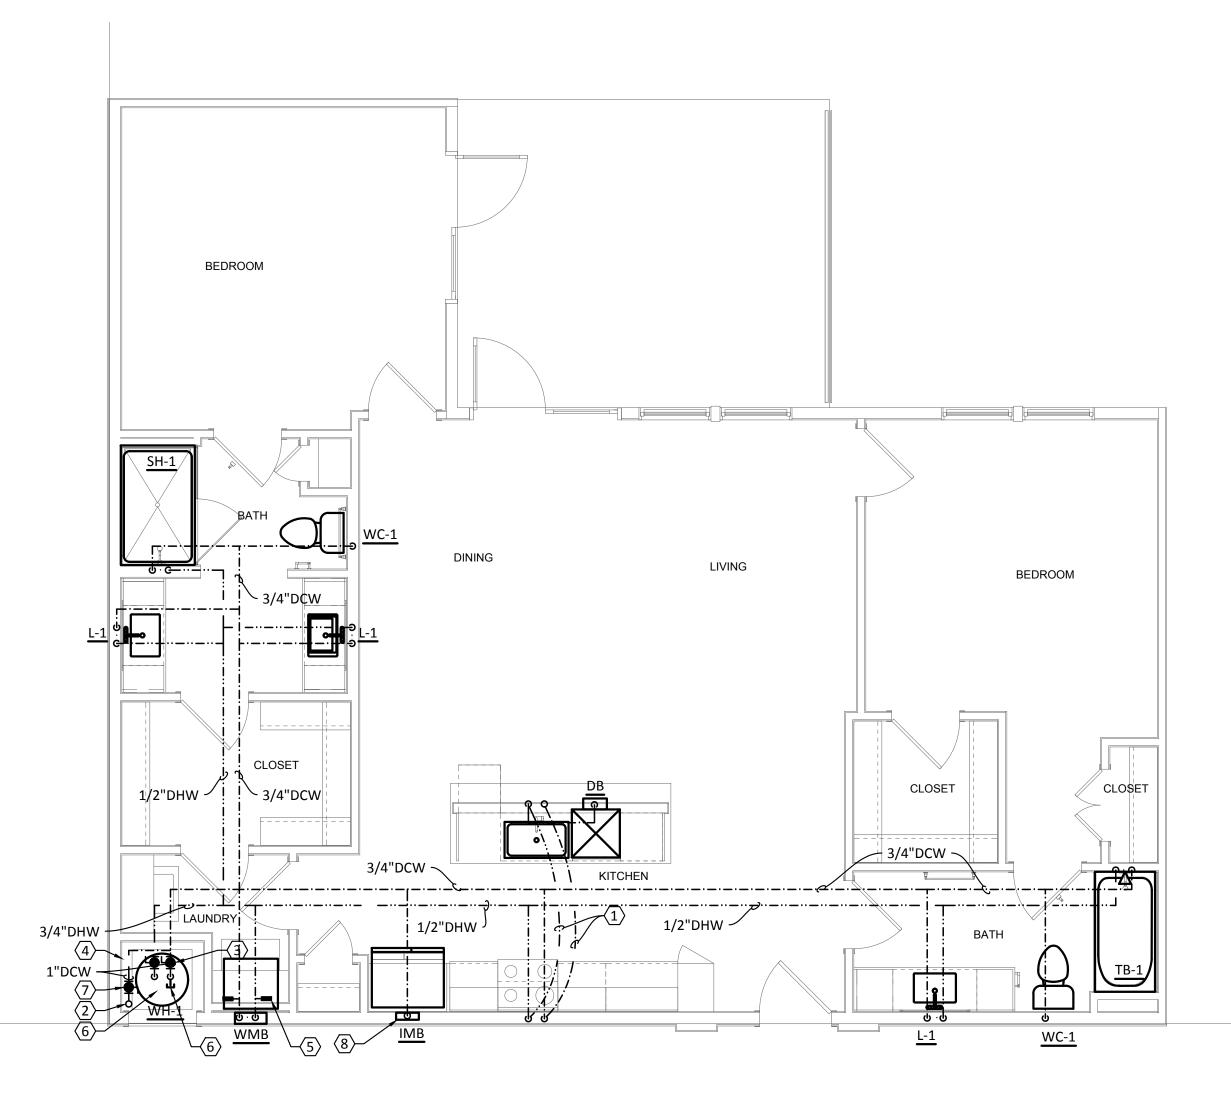
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PLUMBING - UNIT TYPE B3 SCALE: 1/4"=1'-0"

BEDROOM

LAUNDRY



2 PLUMBING - UNIT TYPE B4
SCALE: 1/4"=1'-0"

KITCHEN

BEDROOM

PLUMBING - UNIT TYPE B5

SCALE: 1/4"=1'-0"





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ISSUANCES		
01	SCHEMATIC DESIGN	09.10.18
02	DEVELOPMENT DESIGN	11.09.18
03	PERMIT SET	01.28.19

REVISIONS




a multifamily project for NRP Group

West Cevallos San Antonio, Texas


PLUMBING UNIT B3, B4 & B5


I .		
	Project Number	18054
	Date	01/14/2018
	Drawn By	TLR
	Checked By	EEC

P305

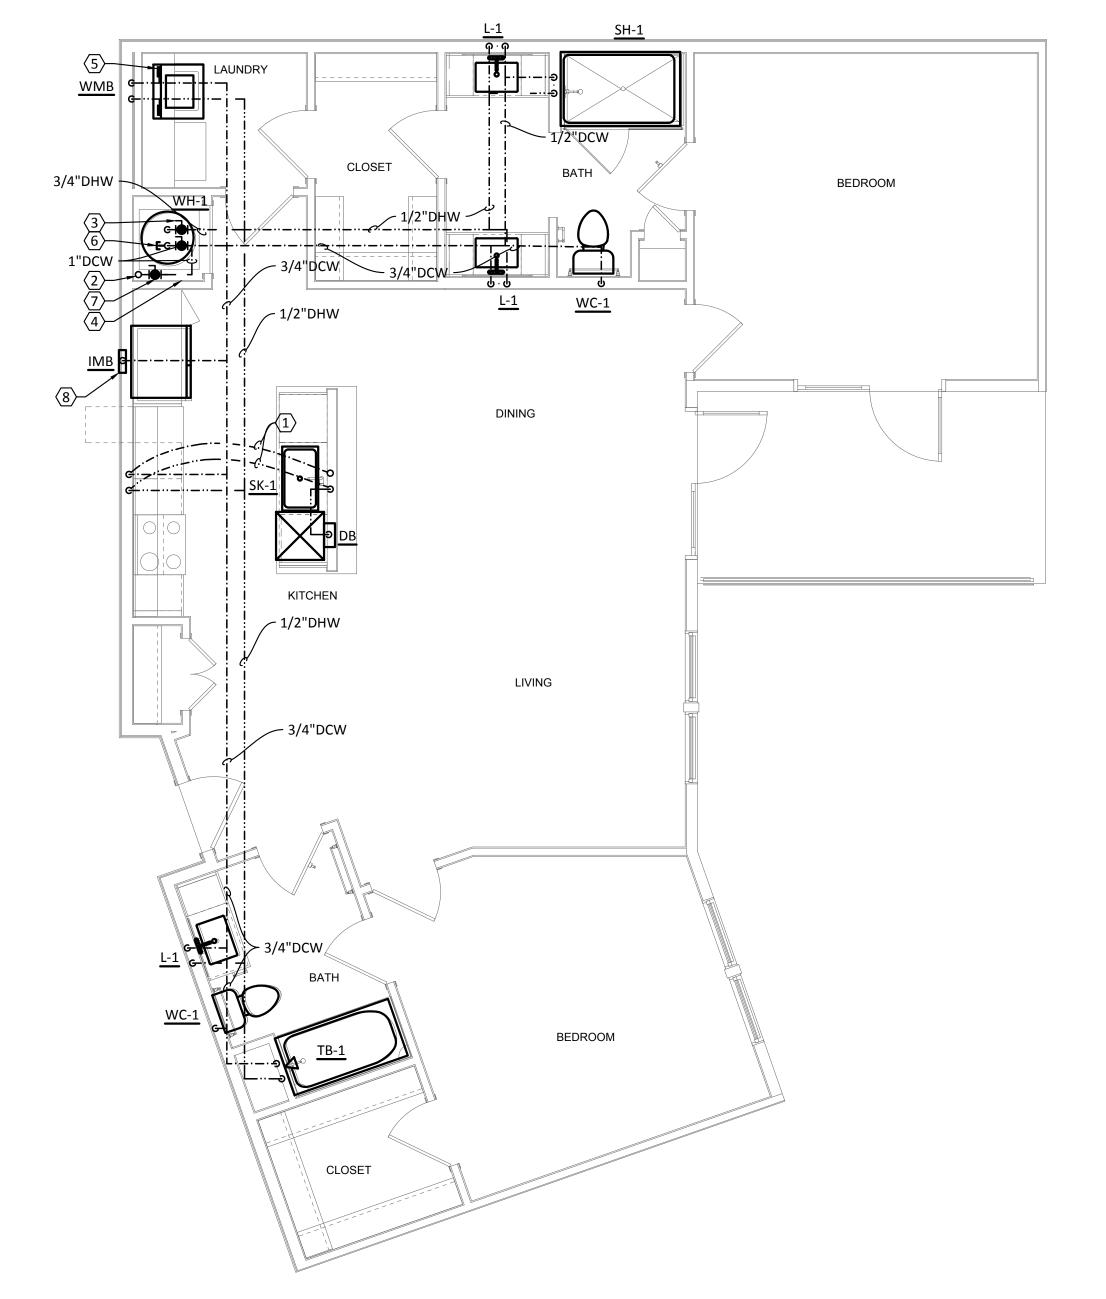

PLUMBING - UNIT TYPE B6 SCALE: 1/4"=1'-0"

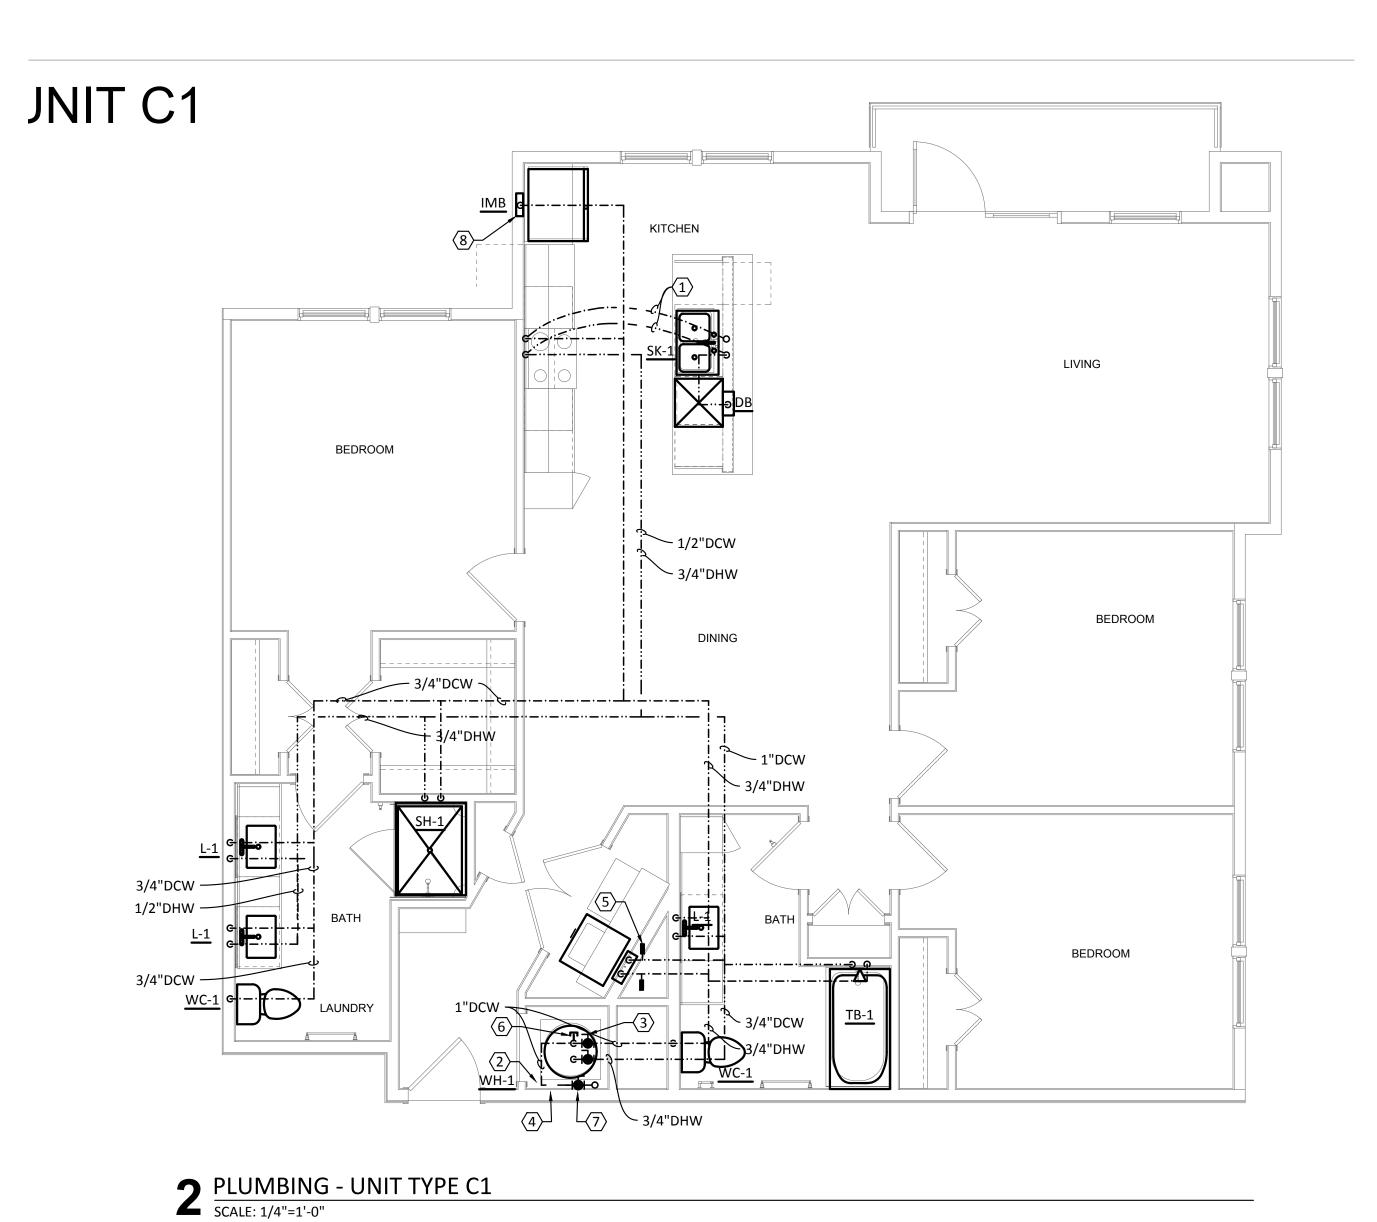

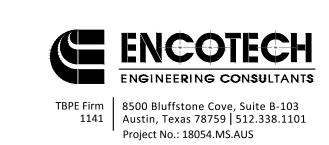



- A. REFER TO SHEET P000 FOR ADDITIONAL INFORMATION.
- . PROVIDE PROSET TRAP GUARDS AT ALL AIR HANDLER CLOSET HUB DRAINS.
- C. DO NOT ROUTE PIPING OVER ELECTRICAL PANELS OR ELECTRICAL EQUIPMENT.
- D. PROVIDE JAY R. SMITH #3101L TRAP PRIMERS AT ALL HUB DRAINS, FLOOR DRAIN AND FLOOR SINKS.
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- PROVIDE ISOLATION VALVE ON DOMESTIC WATER AND HOT WATER SUPPLY PRIOR TO CONNECTION TO WATER HEATER.
- PROVIDE WATER SUB-METER. INSTALL IN EASILY ACCESSIBLE LOCATION FOR READING AND MAINTENANCE. REFER TO LOCAL UTILITY COMPANY REQUIREMENTS FOR ADDITIONAL INFORMATION.
- 5. PROVIDE "A" SIZE WATER HAMMER ARRESTOR ON 1/2" DCW AND 1/2" DHW WATER PIPES IN WASHER CONNECTION BOX. WASHER BOX HEIGHT SHALL BE COORDINATED WITH ARCHITECT. REFER TO DETAIL 1/P701
- 6. PROVIDE VACUUM RELIEF VALVE ON THE COLD WATER SUPPLY LINE ABOVE THE TOP OF THE WATER HEATER. VALVE SHALL COMPLY WITH ANSI Z21.22.
- PROVIDE ISOLATION VALVE PRIOR TO SUB-METER.
- 8. PROVIDE RPZ AT ALL REFRIGERATOR ICE MAKERS.



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09.10.18

11.09.18 01.28.19

O1 SCHEMATIC DESIGN O2 DEVELOPMENT DESIGN

PERMIT SET

REVISIONS



a multifamily project for NRP Group

West Cevallos
San Antonio, Texas

PLUMBING UNIT B6 & C1

Project Number 18054

Date 01/14/2018

Drawn By TLR


Checked By EEC

P306

- A. REFER TO SHEET P000 FOR ADDITIONAL INFORMATION.
- 3. INSTALL ALL DOMESTIC WATER PIPING ABOVE CONDITIONED SPACE. ANY WATER PIPING OUTSIDE THE CONDITIONED ENVELOPE MUST BE INSULATED PER CODE.
- REFER TO BUILDING WASTEWATER PLANS FOR ADDITIONAL INFORMATION FOR RESIDENTIAL WASTEWATER PIPING.

KEYED NOTES:


- 1. REFER TO CIVIL PLANS FOR CONTINUATION OF COMBINATION DOMESTIC WATER AND FIRE LINES.
- 2. COMBINATION FIRE AND DOMESTIC WATER PIPE RISES UP THRU SLAB TO INSIDE THE SPRINKLER CLOSET. INSTALL AS CLOSE TO THE WALL AS POSSIBLE..
- INSTALL SHUT-OFF VALVE ON DOMESTIC WATER INCOMING LINE.
- 4. PROVIDE AND INSTALL WATTS # 957-NRS PRESSURE REDUCING VALVE ON 4"
 DOMESTIC WATER LINE. MUST MEET ASTM A536. SET PRESSURE AT MAXIMUM
 80 PSI. REFER TO BUILDING PLUMBING CALCULATIONS FOR ADDITIONAL
 INFORMATION.
- . SPRINKLER CONTRACTORS SHALL INSTALL A CITY APPROVED BACKFLOW PREVENTOR (DOUBLE CHECK VALVE ASSEMBLY) ON INCOMING SPRINKLER LINE.
- 5. FIRE SPRINKLER PIPING, SIZED BY FIRE SPRINKLER CONTRACTOR. REFER TO FIRE PROTECTION PLANS FOR SPRINKLER SYSTEM LAYOUT.
- 7. DROP 3/4" WATER PIPE DOWN IN WALL TO NON-FREEZE HOSE BIBB. PROVIDE ISOLATION VALVE ON COLD WATER LINE. INSTALL HOSE BIBB 24" ABOVE FINISHED FLOOR. ANCHOR PIPE TO WALL.
- 8. REFER TO PLUMBING BUILDING PLANS FOR CONTINUATION AND SIZES.
- 9. PROVIDE SUMP PUMP IN ELEVATOR PIT. DISCHARGE TO STORM DRAIN. EXTEND STORM PIPING TO EXTERIOR OF BUILDING AND TIE INTO STORM TRUNK LINE. REFER TO STRUCTURAL FOR EXACT LOCATION OF PIT. REFER TO DETAIL 8/P703.
- 10. INSTANTANEOUS WATER HEATER. PROVIDE BALL VALVE ON INCOMING WATER LINE AND BOTH COLD AND HOT WATER PRIOR TO CONNECTION TO WATER HEATER. INSTALL BELOW LAVATORY.
- 11. PROVIDE AND INSTALL JAY R. SMITH "PRIME-EZE" #2698BS WATER SAVER TRAP PRIMER TO FLOOR DRAIN.
- 12. PROVIDE AND INSTALL WATTS # 957-NRS PRESSURE REDUCING VALVE ON 3" DOMESTIC WATER LINE. MUST MEET ASTM A536. SET PRESSURE AT MAXIMUM 80 PSI. REFER TO BUILDING PLUMBING CALCULATIONS FOR ADDITIONAL INFORMATION.

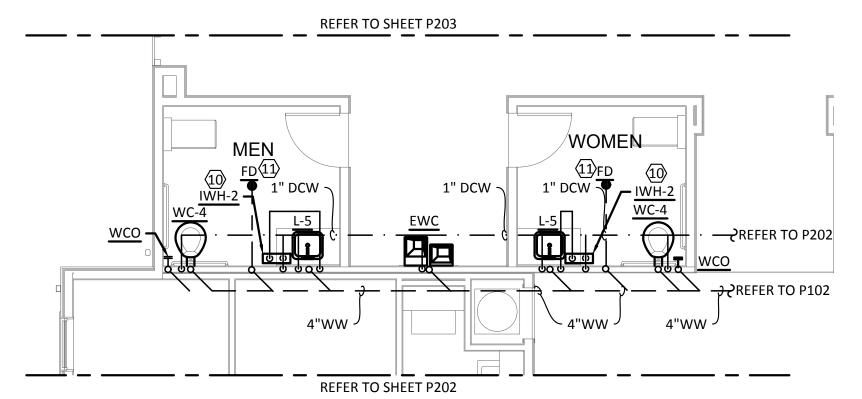


1 PLUMBING DOMESTIC WATER POOL RESTROOM

SCALE: 3/16"=1'-0"

2 PLUMBING - MAINTENANCE
SCALE: 1/4"=1'-0"

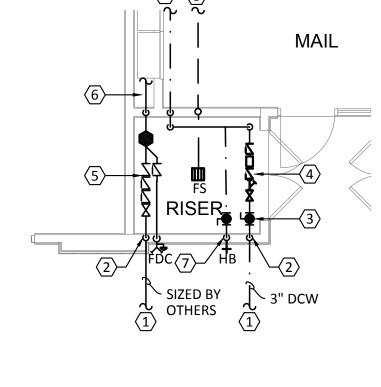

3 PLUMBING DOMESTIC WATER RISER ROOM - BUILDING TYPE I
SCALE: 3/16"=1'-0"

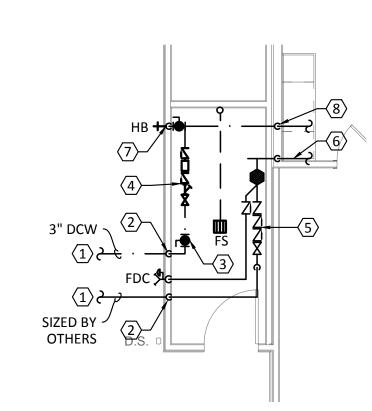

4 PLUMBING DOMESTIC WATER RISER ROOM - BUILDING TYPE II
SCALE: 3/16"=1'-0"



4"SS. INV. ELEV. @ 3'-9" BFF





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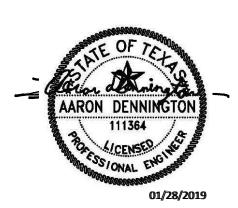
Interior Designer:

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ISSUANCES 01 SCHEMATIC DESIGN 09.10.18 02 DEVELOPMENT DESIGN 11.09.18 03 PERMIT SET 01.28.19

REVISIONS



a multifamily project for NRP Group

West Cevallos
San Antonio, Texas

PLUMBING POOL RESTROOM, RISER RM & MAINTENANCE

Project Number 18054

Date 01/14/2018

Drawn By TLR

Checked By EEC

P401

WATER C	LOSET, FL	USH TANK (PRIVATE)	261 x	2.2 F.U.=	574.2 F.U.
WATER C	LOSET, FLU	USH VALVE (PUBLIC)	· 5 x	10.0 F.U.=	50.0 F.U.
		NK		3.0 F.U.=	3.0 F.U.
LAVATOR	Y (PRIVAT	E)	353 x	0.7 F.U.=	247.1 F.U.
	•)		1.4 F.U. =	228.2 F.U.
	•	IVATE)		1.4 F.U. =	137.2 F.U.
		/ATE		1.4 F.U. =	289.8 F.U.
		CHINE		1.4 F.U. =	289.8 F.U.
WASHING	MACHIN	E, 8 LB (PRIVATE)	· 205 x	1.4 F.U. =	287.0 F.U.
TOTAL FIX	XTURE UN	ITS		=	2106.3 F.U.
2106.3 FI	XTURE UN	IITS		=	336.7 GPM
HIGHEST	FIXTURE =	: 10 FEET			
(10 FT.) x	0.43 = 4.3	PSI STATIC LOSS			
					371 FEET
HORIZON	ITAL PIPE L	ENGTH TAP TO METER		=	D/I FEE
		LENGTH TAP TO METER LENGTH METER TO BUILDING			
HORIZON	ITAL PIPE L	ENGTH METER TO BUILDING		=	61 FEET
HORIZON HORIZON	ITAL PIPE L ITAL PIPE L		 E	= =	61 FEET
HORIZON HORIZON VERTICAL	ITAL PIPE L ITAL PIPE L . PIPE LEN	LENGTH METER TO BUILDING LENGTH BUILDING TO LAST FIXTURE GTH BUILDING RISE TO HIGHEST FIX	 E (TURE	= = =	61 FEET 550 FEET 44 FEET
HORIZON HORIZON VERTICAL TOTAL PII	TAL PIPE L TAL PIPE L . PIPE LEN PE LENGTH	ENGTH METER TO BUILDING ENGTH BUILDING TO LAST FIXTURE	(TURE	= = =	61 FEET
HORIZON HORIZON VERTICAL TOTAL PII	TAL PIPE L TAL PIPE L . PIPE LEN PE LENGTH	LENGTH METER TO BUILDING LENGTH BUILDING TO LAST FIXTURE GTH BUILDING RISE TO HIGHEST FIX 	CTURE VELOPED L	= = =	61 FEET 550 FEET 44 FEET
HORIZON HORIZON VERTICAL TOTAL PII	ITAL PIPE L ITAL PIPE L PIPE LEN PE LENGTH) x 1.25 (FI	LENGTH METER TO BUILDING LENGTH BUILDING TO LAST FIXTURE GTH BUILDING RISE TO HIGHEST FIX 		=== === === ENGTH	61 FEET 550 FEET 44 FEET
HORIZON HORIZON VERTICAL TOTAL PII	ITAL PIPE L ITAL PIPE L PIPE LENGTH PE LENGTH) x 1.25 (FI	LENGTH METER TO BUILDING LENGTH BUILDING TO LAST FIXTURE GTH BUILDING RISE TO HIGHEST FIX TTING LOSS) = 1283 FEET TOTAL DE DEVICE		=== === ENGTH SI LOSS 11.2 PSI	61 FEET 550 FEET 44 FEET
HORIZON HORIZON VERTICAL TOTAL PII	ITAL PIPE L ITAL PIPE L PIPE LENGTH PE LENGTH) x 1.25 (FI	LENGTH METER TO BUILDING LENGTH BUILDING TO LAST FIXTURE GTH BUILDING RISE TO HIGHEST FIX T TTING LOSS) = 1283 FEET TOTAL DE DEVICE METER	CTURE VELOPED L PS	= = = = = = = = = = = = = = = = = = =	61 FEET 550 FEET 44 FEET
HORIZON HORIZON VERTICAL TOTAL PII	ITAL PIPE L ITAL PIPE L PIPE LENGTH PE LENGTH) x 1.25 (FI	LENGTH METER TO BUILDING LENGTH BUILDING TO LAST FIXTURE GTH BUILDING RISE TO HIGHEST FIX TOTAL DESTRUCTOR OF THE STATIC DEVICE METER	PS	= = = = = = = = = = = = = = = = = = =	61 FEET 550 FEET 44 FEET
HORIZON HORIZON VERTICAL TOTAL PII	ITAL PIPE L ITAL PIPE L PIPE LENGT PE LENGTH) x 1.25 (FI SIZE 4"	LENGTH METER TO BUILDING LENGTH BUILDING TO LAST FIXTURE GTH BUILDING RISE TO HIGHEST FIX TOTAL DESTRUCTION DEVICE METER STATIC BACKFLOW PREVENTOR FIXTURE (FLUSH VALVE)	PS	= = = = = = = = = = = = = = = = = = =	61 FEET 550 FEET 44 FEET
HORIZON HORIZON VERTICAL TOTAL PII (1026 FT.)	TAL PIPE LITAL PIPE LENGTE PE LENGTE) x 1.25 (FI SIZE 4" TOTAL B	LENGTH METER TO BUILDING LENGTH BUILDING TO LAST FIXTURE GTH BUILDING RISE TO HIGHEST FIX H TTING LOSS) = 1283 FEET TOTAL DE DEVICE METER STATIC BACKFLOW PREVENTOR FIXTURE (FLUSH VALVE) SUILDING LOSS	CTURE VELOPED L PS = =	61 FEET 550 FEET 44 FEET
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HORIZON HORIZON VERTICAL TOTAL PII (1026 FT.) PRESSURI BUILDING DIFFEREN	TAL PIPE LITAL PIPE LITAL PIPE LENGTH PE LENGTH) x 1.25 (FI SIZE 4" TOTAL B E AT STREE G LOSS	LENGTH METER TO BUILDING LENGTH BUILDING TO LAST FIXTURE GTH BUILDING RISE TO HIGHEST FIX H TTING LOSS) = 1283 FEET TOTAL DE DEVICE METER STATIC BACKFLOW PREVENTOR FIXTURE (FLUSH VALVE) BUILDING LOSS	CTURE VELOPED L PS = = 61 FEET 550 FEET 44 FEET 1026 FEET 82.9 PSI 42.5 PSI
HORIZON HORIZON VERTICAL TOTAL PII (1026 FT.) PRESSURI BUILDING DIFFEREN	TAL PIPE LITAL PIPE LITAL PIPE LENGTH PE LENGTH) x 1.25 (FI SIZE 4" TOTAL B E AT STREE G LOSS	LENGTH METER TO BUILDING LENGTH BUILDING TO LAST FIXTURE GTH BUILDING RISE TO HIGHEST FIX H TTING LOSS) = 1283 FEET TOTAL DE DEVICE METER STATIC BACKFLOW PREVENTOR FIXTURE (FLUSH VALVE) SUILDING LOSS	CTURE VELOPED L PS = = 61 FEET 550 FEET 44 FEET 1026 FEET 82.9 PSI 42.5 PSI
PRESSURI BUILDING DIFFEREN (40.4 / 12	TAL PIPE LITAL PIPE LENGTE PE LENGTE) x 1.25 (FI SIZE 4" TOTAL B E AT STREE G LOSS ICE	LENGTH METER TO BUILDING LENGTH BUILDING TO LAST FIXTURE GTH BUILDING RISE TO HIGHEST FIX H TTING LOSS) = 1283 FEET TOTAL DE DEVICE METER STATIC BACKFLOW PREVENTOR FIXTURE (FLUSH VALVE) BUILDING LOSS	PS	= = = = = = = = = = = = = = = = = = =	61 FEET 550 FEET 44 FEET 1026 FEET 82.9 PSI 42.5 PSI

PRESSURE TO 80 PSI MAXIMUM.

	_USH TANK (PRIVATE)	38 x	2.2 F.U. =	83.6 F.U.
LAVATORY (PRIVAT	TE)	41 x	0.7 F.U. =	28.7 F.U.
BATHTUB (PRIVAT	E)	29 x	1.4 F.U. =	40.6 F.U.
SHOWER HEAD (PF	RIVATE)	9 x	1.4 F.U.=	12.6 F.U.
KITCHEN SINK, PRI	VATE	29 x	1.4 F.U. =	40.6 F.U.
DISHWASHING MA	ACHINE	29 x	1.4 F.U. =	40.6 F.U.
WASHING MACHIN	NE, 8 LB (PRIVATE)	29 x	1.4 F.U. =	40.6 F.U.
TOTAL FIXTURE UI	VITS		=	287.3 F.U.
287.3 FIXTURE UN	ITS		=	82.5 GPM
HIGHEST FIXTURE	= 10 FEET			
(10 FT.) x 0.43 = 4.	3 PSI STATIC LOSS			
HORIZONTAL PIPE	LENGTH TAP TO METER		=	371 FEET
HORIZONTAL PIPE	LENGTH METER TO BUILDING		=	690 FEET
HORIZONTAL PIPE	LENGTH BUILDING TO LAST FIXTURI	_		100 FFFT
	LENGTH BUILDING TO LAST FIXTORI	L	=	199 FEET
	NGTH BUILDING RISE TO HIGHEST FIX			
VERTICAL PIPE LEN		XTURE	· =	
VERTICAL PIPE LEN TOTAL PIPE LENGT	NGTH BUILDING RISE TO HIGHEST FIX	XTURE	=	33 FEET
VERTICAL PIPE LEN TOTAL PIPE LENGT	NGTH BUILDING RISE TO HIGHEST FIX	XTURE EVELOPED LE	=	33 FEET
VERTICAL PIPE LEN TOTAL PIPE LENGT (1293 FT.) x 1.25 (F	NGTH BUILDING RISE TO HIGHEST FIX	XTUREEVELOPED LE	= ENGTH	33 FEET
VERTICAL PIPE LEN TOTAL PIPE LENGT (1293 FT.) x 1.25 (F	NGTH BUILDING RISE TO HIGHEST FIX TH	XTURE EVELOPED LE PS	= :NGTH I LOSS 5.9 PSI	33 FEET
VERTICAL PIPE LEN TOTAL PIPE LENGT (1293 FT.) x 1.25 (F	NGTH BUILDING RISE TO HIGHEST FIX TH FITTING LOSS) = 1616 FEET TOTAL DE DEVICE METER	XTURE EVELOPED LE PS =	:= :NGTH : LOSS 5.9 PSI 4.3 PSI	33 FEET
VERTICAL PIPE LENGT TOTAL PIPE LENGT (1293 FT.) x 1.25 (F SIZE 2"	NGTH BUILDING RISE TO HIGHEST FIX TH	PS	= ENGTH I LOSS 5.9 PSI 4.3 PSI 8.0 PSI	33 FEET
VERTICAL PIPE LENGT TOTAL PIPE LENGT (1293 FT.) x 1.25 (F SIZE 2" TOTAL	NGTH BUILDING RISE TO HIGHEST FIX TH FITTING LOSS) = 1616 FEET TOTAL DE DEVICE METER STATIC FIXTURE (FLUSH TANK)	PS	= ENGTH I LOSS 5.9 PSI 4.3 PSI 8.0 PSI 18.2 PSI	33 FEET
VERTICAL PIPE LENGT TOTAL PIPE LENGT (1293 FT.) x 1.25 (F SIZE 2" TOTAL PRESSURE AT STRE	TH	PS = =	ENGTH I LOSS 5.9 PSI 4.3 PSI 8.0 PSI 18.2 PSI	33 FEET 1293 FEET
VERTICAL PIPE LENGT TOTAL PIPE LENGT (1293 FT.) x 1.25 (F SIZE 2" TOTAL PRESSURE AT STRE BUILDING LOSS	NGTH BUILDING RISE TO HIGHEST FIXTH	PS = =	ENGTH LOSS 5.9 PSI 4.3 PSI 8.0 PSI 18.2 PSI	33 FEET 1293 FEET 82.9 PSI
VERTICAL PIPE LENGT TOTAL PIPE LENGT (1293 FT.) x 1.25 (F SIZE 2" TOTAL PRESSURE AT STRE BUILDING LOSS	NGTH BUILDING RISE TO HIGHEST FIX TH FITTING LOSS) = 1616 FEET TOTAL DE DEVICE METER STATIC FIXTURE (FLUSH TANK) BUILDING LOSS	PS = =	ENGTH LOSS 5.9 PSI 4.3 PSI 8.0 PSI 18.2 PSI	33 FEET 1293 FEET 82.9 PSI 18.2 PSI
VERTICAL PIPE LENGT TOTAL PIPE LENGT (1293 FT.) x 1.25 (F SIZE 2" TOTAL PRESSURE AT STRE BUILDING LOSS DIFFERENCE	NGTH BUILDING RISE TO HIGHEST FIX TH FITTING LOSS) = 1616 FEET TOTAL DE DEVICE METER STATIC FIXTURE (FLUSH TANK) BUILDING LOSS	PS = = =	ENGTH LOSS 5.9 PSI 4.3 PSI 8.0 PSI 18.2 PSI	33 FEET 1293 FEET 82.9 PSI 18.2 PSI

* VERIFY PRESSURE AT TIME OF CONSTRUCTION. IF GREATER THAN 80 PSI

PROVIDE AND INSTALL PRESSURE REDUCING VALVE TO REDUCE WATER

PRESSURE TO 80 PSI MAXIMUM.

	WATER CALCULATION - BUILD	DING II	(#3)	
	USH TANK (PRIVATE)	38 x	2.2 F.U.=	83.6 F.U.
LAVATORY (PRIVA	ΓΕ)	41 x	0.7 F.U.=	28.7 F.U.
BATHTUB (PRIVAT	E)	29 x	1.4 F.U. =	40.6 F.U.
SHOWER HEAD (PF	RIVATE)	9 x	1.4 F.U.=	12.6 F.U.
KITCHEN SINK, PRI	VATE	29 x	1.4 F.U.=	40.6 F.U.
DISHWASHING MA	CHINE	29 x	1.4 F.U.=	40.6 F.U.
WASHING MACHIN	NE, 8 LB (PRIVATE)	29 x	1.4 F.U.=	40.6 F.U.
TOTAL FIXTURE UI	NITS		=	287.3 F.U.
287.3 FIXTURE UN	ITS		=	82.5 GPM
HIGHEST FIXTURE	= 10 FEET			
(10 FT.) x 0.43 = 4.	3 PSI STATIC LOSS			
HORIZONTAL PIPE	LENGTH TAP TO METER		=	371 FEET
HORIZONTAL PIPE	LENGTH METER TO BUILDING		=	421 FEET
HORIZONTAL PIPE	LENGTH BUILDING TO LAST FIXTURE		=	199 FEET
VERTICAL PIPE LEN	NGTH BUILDING RISE TO HIGHEST FIXTU	RE	=	33 FEET
	TH FITTING LOSS) = 1280 FEET TOTAL DEVE			1024 FEET
SIZE	DEVICE	PS	I LOSS	
2"	METER	=	5.9 PSI	
	STATIC	=	4.3 PSI	
	FIXTURE (FLUSH TANK)	=	8.0 PSI	
TOTAL	BUILDING LOSS	=	18.2 PSI	
PRESSURE AT STRE	ET		=	82.9 PSI
BUILDING LOSS			=	18.2 PSI
DIFFERENCE			=	64.7 PSI
(64.7 / 1280) x 100	PER 100 FT. PIPE LENGTH			
USE 2" METER ANI	O 2" MAIN WATER LINE TO BUILDING			
	WATER CALCULATION N	IOTES		
* VERIFY PRESSUR	ON IS BASED ON INTERNATIONAL PLUME AT TIME OF CONSTRUCTION. IF GREAT	TER THA	N 80 PSI	

BATHROOM GROUP	117 x	5.0 F.L	J. =	585.	0 F.U.
KITCHEN, DOMESTIC (WITH OR WITHOUT DISHWASHER)	129 x	2.0 F.L	J. =	258.	0 F.U.
WASHING MACHINE BOX, DOMESTIC	129 x	2.0 F.L	J. =	258.	0 F.U.
2" HUB DRAIN	129 x	3.0 F.L	J. =	387.	0 F.U.
 TOTAL FIXTURE UNITS			=	 1488.	0 F.U.
		SLOPE	=	1/8	IN/F
USE 8 INCH WASTE WATER LINE FROM BUILDING AT 0.0625 IN/FT					

PROVIDE AND INSTALL PRESSURE REDUCING VALVE TO REDUCE WATER

PRESSURE TO 80 PSI MAXIMUM.

BATHROOM GROUP	132 x	5.0 F.L	J. =	660.0	F.U.
KITCHEN, DOMESTIC (WITH OR WITHOUT DISHWASHER)	76 x	2.0 F.L	J. =	152.0	F.U.
WASHING MACHINE BOX, DOMESTIC	76 x	2.0 F.L	J. =	152.0	F.U.
2" HUB DRAIN	76 x	1.0 F.L	J. =	76.0	F.U.
TOTAL FIXTURE UNITS				 1040.0	F.U.
		SLOPE	=	1/8	IN/FT
USE 8 INCH WASTE WATER LINE FROM BUILDING AT 1/8 IN/FT					

BATHROOM GROUP	17 x	5.0 F.U.=	85.0 F.U.
WATER CLOSET	21 x	4.0 F.U. =	84.0 F.U.
LAVATORY	24 x	1.0 F.U. =	24.0 F.U.
BATHTUB	12 x	2.0 F.U. =	24.0 F.U.
SHOWER	9 x	2.0 F.U. =	18.0 F.U.
KITCHEN, DOMESTIC (WITH OR WITHOUT DISHWASHER)	29 x	2.0 F.U. =	58.0 F.U.
WASHING MACHINE BOX, DOMESTIC	29 x	2.0 F.U. =	58.0 F.U.
2" HUB DRAIN	29 x	1.0 F.U. =	29.0 F.U.
4" FLOOR DRAIN/FLOOR SINK	1 x	6.0 F.U. =	6.0 F.U.
TOTAL FIXTURE UNITS		=	 386.0 F.U.
		SLOPE =	1/8 IN/F

LAVATORY 1 x 1.0 F.I MOP SINK 1 x 2.0 F.I	U. = 1.0 F.U.
MOP SINK 1 x 2.0 F.I	2.0
	U. = 2.0 F.U.
2" HUB DRAIN 1 x 1.0 F.I	U. = 1.0 F.U.
2" FLOOR DRAIN/FLOOR SINK 2 x 3.0 F.I	U. = 6.0 F.U.

WATER CLOSET, FI	USH TANK (PRIVATE)	38 x	2.2 F.U.=	83.6 F.U
LAVATORY (PRIVA	TE)	41 x	0.7 F.U.=	28.7 F.U
BATHTUB (PRIVAT	E)	29 x	1.4 F.U.=	40.6 F.U.
SHOWER HEAD (PR	RIVATE)	9 x	1.4 F.U.=	12.6 F.U.
KITCHEN SINK, PRI	VATE	29 x	1.4 F.U.=	40.6 F.U.
DISHWASHING MA	ACHINE	29 x	1.4 F.U.=	40.6 F.U.
WASHING MACHIN	NE, 8 LB (PRIVATE)	29 x	1.4 F.U. =	40.6 F.U.
TOTAL FIXTURE UI	NITS		=	287.3 F.U.
287.3 FIXTURE UN	ITS		=	82.5 GPN
HIGHEST FIXTURE	= 10 FEET			
(10 FT.) x 0.43 = 4.	3 PSI STATIC LOSS			
HORIZONTAL PIPE	LENGTH TAP TO METER		=	371 FEE
HORIZONTAL PIPE	LENGTH METER TO BUILDING		=	337 FEE
HORIZONTAL PIPE	LENGTH BUILDING TO LAST FIXTUR	E	=	199 FEE
VERTICAL PIPE LEN	NGTH BUILDING RISE TO HIGHEST FIX	XTURE	=	33 FEE
			=	940 FEE
TOTAL PIPE LENGT	⁻ H			
	H TTING LOSS) = 1175			
	TTING LOSS) = 1175 FEET TOTAL DEV	/ELOPED LEN		
(940 FT.) x 1.25 (FI	TTING LOSS) = 1175 FEET TOTAL DEV	/ELOPED LEN PS	IGTH LOSS	
(940 FT.) x 1.25 (FI SIZE	TTING LOSS) = 1175 FEET TOTAL DEV	/ELOPED LEN PS	IGTH LOSS 5.9 PSI	
(940 FT.) x 1.25 (FI	TTING LOSS) = 1175 FEET TOTAL DEV DEVICE METER	/ELOPED LEN PS =	IGTH LOSS 5.9 PSI 4.3 PSI	
(940 FT.) x 1.25 (FI SIZE 2"	TTING LOSS) = 1175 FEET TOTAL DE\ DEVICE METER	/ELOPED LEN PS = =	IGTH LOSS 5.9 PSI 4.3 PSI 8.0 PSI	
(940 FT.) x 1.25 (FI SIZE 2" TOTAL	TTING LOSS) = 1175 FEET TOTAL DEV DEVICE METER STATIC FIXTURE (FLUSH TANK)	/ELOPED LEN PS = =	IGTH LOSS 5.9 PSI 4.3 PSI 8.0 PSI 18.2 PSI	82.9 PSI
(940 FT.) x 1.25 (FI SIZE 2" TOTAL PRESSURE AT STRE	TTING LOSS) = 1175 FEET TOTAL DEN DEVICE METER STATIC FIXTURE (FLUSH TANK) BUILDING LOSS	/ELOPED LEN PS = =	IGTH LOSS 5.9 PSI 4.3 PSI 8.0 PSI 18.2 PSI	82.9 PSI 18.2 PSI
(940 FT.) x 1.25 (FI SIZE 2" TOTAL PRESSURE AT STRE BUILDING LOSS	TTING LOSS) = 1175 FEET TOTAL DEV DEVICE METER STATIC FIXTURE (FLUSH TANK) BUILDING LOSS	/ELOPED LEN PS = =	IGTH LOSS 5.9 PSI 4.3 PSI 8.0 PSI 18.2 PSI	
(940 FT.) x 1.25 (FI SIZE 2" TOTAL PRESSURE AT STRE BUILDING LOSS	TTING LOSS) = 1175 FEET TOTAL DEN DEVICE METER STATIC FIXTURE (FLUSH TANK) BUILDING LOSS	PS = = =	IGTH LOSS 5.9 PSI 4.3 PSI 8.0 PSI 18.2 PSI	18.2 PSI
(940 FT.) x 1.25 (FI SIZE 2" TOTAL PRESSURE AT STRE BUILDING LOSS DIFFERENCE	TTING LOSS) = 1175 FEET TOTAL DEN DEVICE METER STATIC FIXTURE (FLUSH TANK) BUILDING LOSS	/ELOPED LEN PS = = = VABLE	IGTH LOSS 5.9 PSI 4.3 PSI 8.0 PSI 18.2 PSI	18.2 PSI
(940 FT.) x 1.25 (FI SIZE 2" TOTAL PRESSURE AT STRE BUILDING LOSS DIFFERENCE (64.7 / 1175) x 100	TTING LOSS) = 1175 FEET TOTAL DEV DEVICE METER STATIC FIXTURE (FLUSH TANK) BUILDING LOSS EET 0 = 5.5 MAX PSI DROP ALLOV	/ELOPED LEN PS = = = VABLE GTH	IGTH LOSS 5.9 PSI 4.3 PSI 8.0 PSI 18.2 PSI	18.2 PSI

PROVIDE AND INSTALL PRESSURE REDUCING VALVE TO REDUCE WATER

PRESSURE TO 80 PSI MAXIMUM.

	WATER CALCULATION - BUILD	ING II	(#5)	
WATER CLOSET, I	LUSH TANK (PRIVATE)	38 x	2.2 F.U.=	83.6 F.U.
LAVATORY (PRIVA	ATE)	41 x	0.7 F.U.=	28.7 F.U.
BATHTUB (PRIVA	TE)	29 x	1.4 F.U.=	40.6 F.U.
SHOWER HEAD (F	PRIVATE)	9 x	1.4 F.U.=	12.6 F.U.
KITCHEN SINK, PF	RIVATE	29 x	1.4 F.U.=	40.6 F.U.
	ACHINE	29 x	1.4 F.U.=	40.6 F.U.
WASHING MACH	NE, 8 LB (PRIVATE)	29 x	1.4 F.U.=	40.6 F.U.
TOTAL FIXTURE U	JNITS		=	287.3 F.U.
287.3 FIXTURE U	NITS		=	82.5 GPM
HIGHEST FIXTURE	E = 10 FEET			
(10 FT.) x 0.43 = 4	1.3 PSI STATIC LOSS			
HORIZONTAL PIP	E LENGTH TAP TO METER		=	371 FEET
HORIZONTAL PIP	E LENGTH METER TO BUILDING		=	153 FEET
HORIZONTAL PIP	E LENGTH BUILDING TO LAST FIXTURE			100 555
	E LENGTH BUILDING TO LAST FIXTURE		=	199 FEET
	NGTH BUILDING RISE TO HIGHEST FIXTU			33 FEET
VERTICAL PIPE LE TOTAL PIPE LENG		RE	= =	
VERTICAL PIPE LE TOTAL PIPE LENG	NGTH BUILDING RISE TO HIGHEST FIXTUI	RE PED LEN	= =	33 FEET
VERTICAL PIPE LE TOTAL PIPE LENG (756 FT.) x 1.25 (F	NGTH BUILDING RISE TO HIGHEST FIXTUI THE TOTAL DEVELOR	REPED LEN	= GTH I LOSS	33 FEET
VERTICAL PIPE LE TOTAL PIPE LENG (756 FT.) x 1.25 (F	ENGTH BUILDING RISE TO HIGHEST FIXTUI STH	PED LENG PS	= GTH I LOSS 5.9 PSI	33 FEET
VERTICAL PIPE LE TOTAL PIPE LENG (756 FT.) x 1.25 (F	ENGTH BUILDING RISE TO HIGHEST FIXTUI 	PED LEN	GTH 1 LOSS 5.9 PSI 4.3 PSI	33 FEET
VERTICAL PIPE LE TOTAL PIPE LENG (756 FT.) x 1.25 (F SIZE 2"	ENGTH BUILDING RISE TO HIGHEST FIXTUI ETH	PED LENG PS =	======================================	33 FEET
VERTICAL PIPE LE TOTAL PIPE LENG (756 FT.) x 1.25 (F SIZE 2" TOTAL	ENGTH BUILDING RISE TO HIGHEST FIXTURE STH FITTING LOSS) = 945 FEET TOTAL DEVELOF DEVICE METER STATIC FIXTURE (FLUSH TANK)	PED LENG PS = =	5.9 PSI 4.3 PSI 8.0 PSI 18.2 PSI	33 FEET 756 FEET
VERTICAL PIPE LE TOTAL PIPE LENG (756 FT.) x 1.25 (F SIZE 2" TOTAL PRESSURE AT STE	ENGTH BUILDING RISE TO HIGHEST FIXTURE STATURE (FLUSH TANK)	PED LENG PS = =	5.9 PSI 4.3 PSI 8.0 PSI 18.2 PSI	33 FEET 756 FEET
VERTICAL PIPE LE TOTAL PIPE LENG (756 FT.) x 1.25 (F SIZE 2" TOTAL PRESSURE AT STE BUILDING LOSS	ENGTH BUILDING RISE TO HIGHEST FIXTURE FIXTURE (FLUSH TANK)	PED LEN	GTH I LOSS 5.9 PSI 4.3 PSI 8.0 PSI 18.2 PSI	33 FEET 756 FEET 82.9 PSI
VERTICAL PIPE LE TOTAL PIPE LENG (756 FT.) x 1.25 (F SIZE 2" TOTAL PRESSURE AT STE BUILDING LOSS	ENGTH BUILDING RISE TO HIGHEST FIXTURE STH FITTING LOSS) = 945 FEET TOTAL DEVELOR DEVICE METER STATIC FIXTURE (FLUSH TANK) BUILDING LOSS	PED LENG PS = =	GTH I LOSS 5.9 PSI 4.3 PSI 8.0 PSI 18.2 PSI	33 FEET 756 FEET 82.9 PSI 18.2 PSI
VERTICAL PIPE LE TOTAL PIPE LENG (756 FT.) x 1.25 (F SIZE 2" TOTAL PRESSURE AT STE BUILDING LOSS	ENGTH BUILDING RISE TO HIGHEST FIXTURE STH FITTING LOSS) = 945 FEET TOTAL DEVELOR DEVICE METER STATIC FIXTURE (FLUSH TANK) BUILDING LOSS	PED LENG PS = =	GTH I LOSS 5.9 PSI 4.3 PSI 8.0 PSI 18.2 PSI	33 FEET 756 FEET 82.9 PSI 18.2 PSI
VERTICAL PIPE LE TOTAL PIPE LENG (756 FT.) x 1.25 (F SIZE 2" TOTAL PRESSURE AT STE BUILDING LOSS DIFFERENCE (64.7 / 945) x 100	ENGTH BUILDING RISE TO HIGHEST FIXTURE STATIC FIXTURE (FLUSH TANK) BUILDING LOSS BUILDING LOSS	PED LENG PS = =	GTH I LOSS 5.9 PSI 4.3 PSI 8.0 PSI 18.2 PSI	33 FEET 756 FEET 82.9 PSI 18.2 PSI

- THIS CALCULATION IS BASED ON INTERNATIONAL PLUMBING CODE 2015.

* VERIFY PRESSURE AT TIME OF CONSTRUCTION. IF GREATER THAN 80 PSI
PROVIDE AND INSTALL PRESSURE REDUCING VALVE TO REDUCE WATER

PRESSURE TO 80 PSI MAXIMUM.



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ISSUANCES		
01	SCHEMATIC DESIGN	09.10.18
02	DEVELOPMENT DESIGN	11.09.18
03	PERMIT SET	01.28.19

REVISIONS



a multifamily project for NRP Group

West Cevallos
San Antonio, Texas

PLUMBING CALCULATIONS

Project Number 18054

Date 01/14/2018

Drawn By TLR

Checked By EEC

P501

1 30 1

TBPE Firm | 8500 Bluffstone Cove, Suite B-103 | Austin, Texas 78759 | 512.338.1101 | Project No.: 18054.MS.AUS

ENCOTECH ENGINEERING CONTINUES

WATER CALCULATION - UNIT A1					
WATER CLOSET, FLUSH TANK (PRIVATE)	1 x	2.2 F.U.=	2.2 F.U.		
LAVATORY (PRIVATE)	1 x	0.7 F.U. =	0.7 F.U.		
SHOWER HEAD (PRIVATE)	0 x	1.4 F.U. =	0.0 F.U.		
BATHTUB (PRIVATE)	1 x	1.4 F.U. =	1.4 F.U.		
KITCHEN SINK, PRIVATE	1 x	1.4 F.U. =	1.4 F.U.		
DISHWASHING MACHINE	1 x	1.4 F.U. =	1.4 F.U.		
WASHING MACHINE, 8 LB (PUBLIC)	1 x	3.0 F.U. =	3.0 F.U.		
TOTAL FIXTURE UNITS=					
10.1 FIXTURE UNITS		=	14.7 GPM		

WATER CALCULATION - UI	NIT A2		
WATER CLOSET, FLUSH TANK (PRIVATE)	1 x	2.2 F.U.=	2.2 F.U.
LAVATORY (PRIVATE)	1 x	0.7 F.U.=	0.7 F.U.
SHOWER HEAD (PRIVATE)	0 x	1.4 F.U. =	0.0 F.U.
BATHTUB (PRIVATE)	1 x	1.4 F.U. =	1.4 F.U.
KITCHEN SINK, PRIVATE	1 x	1.4 F.U. =	1.4 F.U.
DISHWASHING MACHINE	1 x	1.4 F.U. =	1.4 F.U.
WASHING MACHINE, 8 LB (PUBLIC)	1 x	3.0 F.U.=	3.0 F.U.
TOTAL FIXTURE UNITS	10.1 F.U.		
10.1 FIXTURE UNITS		=	14.7 GPM

WATER CALCULATION - UNIT A2b				
WATER CLOSET, FLUSH TANK (PRIVATE)	1 x	2.2 F.U. =	2.2 F.U.	
LAVATORY (PRIVATE)	1 x	0.7 F.U. =	0.7 F.U.	
SHOWER HEAD (PRIVATE)	1 x	1.4 F.U. =	1.4 F.U.	
BATHTUB (PRIVATE)	0 x	1.4 F.U. =	0.0 F.U.	
KITCHEN SINK, PRIVATE	1 x	1.4 F.U. =	1.4 F.U.	
DISHWASHING MACHINE	1 x	1.4 F.U. =	1.4 F.U.	
WASHING MACHINE, 8 LB (PUBLIC)	1 x	3.0 F.U.=	3.0 F.U.	
TOTAL FIXTURE UNITS		=	10.1 F.U.	
10.1 FIXTURE UNITS		=	14.7 GPM	

WATER CALCULATION - UNIT A2-ALT-1				
WATER CLOSET, FLUSH TANK (PRIVATE)	1 x	2.2 F.U.=	2.2 F.U.	
LAVATORY (PRIVATE)	1 x	0.7 F.U. =	0.7 F.U.	
SHOWER HEAD (PRIVATE)	1 x	1.4 F.U. =	1.4 F.U.	
BATHTUB (PRIVATE)	0 x	1.4 F.U. =	0.0 F.U.	
KITCHEN SINK, PRIVATE	1 x	1.4 F.U. =	1.4 F.U.	
DISHWASHING MACHINE	1 x	1.4 F.U. =	1.4 F.U.	
WASHING MACHINE, 8 LB (PUBLIC)	1 x	3.0 F.U.=	3.0 F.U.	
TOTAL FIXTURE UNITS		=	10.1 F.U.	
10.1 FIXTURE UNITS		=	14.7 GPM	

WATER CALCULATION - U	INII A3		
WATER CLOSET, FLUSH TANK (PRIVATE)	1 x	2.2 F.U.=	2.2 F
LAVATORY (PRIVATE)	1 x	0.7 F.U.=	0.7 F
SHOWER HEAD (PRIVATE)	0 x	1.4 F.U.=	0.0 F
BATHTUB (PRIVATE)	1 x	1.4 F.U. =	1.4 F
KITCHEN SINK, PRIVATE	1 x	1.4 F.U. =	1.4 F
DISHWASHING MACHINE	1 x	1.4 F.U.=	1.4 F
WASHING MACHINE, 8 LB (PUBLIC)	1 x	3.0 F.U.=	3.0 F
TOTAL FIXTURE UNITS		=	10.1 F

WATER CALCULATION - UN	IT A4		
WATER CLOSET, FLUSH TANK (PRIVATE)	1 x	2.2 F.U.=	2.2 F.U.
LAVATORY (PRIVATE)	2 x	0.7 F.U.=	1.4 F.U.
SHOWER HEAD (PRIVATE)	1 x	1.4 F.U. =	1.4 F.U.
BATHTUB (PRIVATE)	0 x	1.4 F.U.=	0.0 F.U.
KITCHEN SINK, PRIVATE	1 x	1.4 F.U.=	1.4 F.U.
DISHWASHING MACHINE	1 x	1.4 F.U.=	1.4 F.U.
WASHING MACHINE, 8 LB (PRIVATE) 🕶	1 x	1.4 F.U. =	1.4 F.U.
TOTAL FIXTURE UNITS		=	9.2 F.U.
9.2 FIXTURE UNITS		=	13.9 GPM

WATER CALCULATION - UN	NII A5		
WATER CLOSET, FLUSH TANK (PRIVATE)	1 x	2.2 F.U.=	2.2 F.U.
LAVATORY (PRIVATE)	2 x	0.7 F.U.=	1.4 F.U.
SHOWER HEAD (PRIVATE)	0 x	1.4 F.U.=	0.0 F.U.
BATHTUB (PRIVATE)	1 x	1.4 F.U.=	1.4 F.U.
KITCHEN SINK, PRIVATE	1 x	1.4 F.U.=	1.4 F.U.
DISHWASHING MACHINE	1 x	1.4 F.U.=	1.4 F.U.
WASHING MACHINE, 8 LB (PRIVATE)	1 x	1.4 F.U.=	1.4 F.U.
TOTAL FIXTURE UNITS		=	9.2 F.U.
9.2 FIXTURE UNITS		=	13.9 GPM

WATER CLOSET, FLUSH TANK (PRIVATE)	1 x	2.2 F.U. =	2.2 F.U.
LAVATORY (PRIVATE)	2 x	0.7 F.U. =	1.4 F.U.
SHOWER HEAD (PRIVATE)	1 x	1.4 F.U. =	1.4 F.U.
BATHTUB (PRIVATE)	0 x	1.4 F.U. =	0.0 F.U
KITCHEN SINK, PRIVATE	1 x	1.4 F.U. =	1.4 F.U.
DISHWASHING MACHINE	1 x	1.4 F.U. =	1.4 F.U
WASHING MACHINE, 8 LB (PUBLIC)	1 x	3.0 F.U.=	3.0 F.U
TOTAL FIXTURE UNITS		=	10.8 F.U.

WATER CALCULATION - UNIT A7			
WATER CLOSET, FLUSH TANK (PRIVATE)	4 x	2.2 F.U.=	8.8 F.L
LAVATORY (PRIVATE)	8 x	0.7 F.U. =	5.6 F.L
SHOWER HEAD (PRIVATE)	4 x	1.4 F.U. =	5.6 F.U
BATHTUB (PRIVATE)	0 x	1.4 F.U. =	0.0 F.U
KITCHEN SINK, PRIVATE	4 x	1.4 F.U. =	5.6 F.U
DISHWASHING MACHINE	4 x	1.4 F.U. =	5.6 F.L
WASHING MACHINE, 8 LB (PUBLIC)	4 x	3.0 F.U.=	12.0 F.L
TOTAL FIXTURE UNITS		=	43.2 F.U

WATER CLOSET, FLUSH TANK (PRIVATE)	2 x	2.2 F.U.=	4.4 F.U
LAVATORY (PRIVATE)	2 x	0.7 F.U.=	1.4 F.U
SHOWER HEAD (PRIVATE)	1 x	1.4 F.U.=	1.4 F.U
BATHTUB (PRIVATE)	1 x	1.4 F.U. =	1.4 F.U
KITCHEN SINK, PRIVATE	1 x	1.4 F.U.=	1.4 F.U
DISHWASHING MACHINE	1 x	1.4 F.U. =	1.4 F.U
WASHING MACHINE, 8 LB (PUBLIC)	1 x	3.0 F.U.=	3.0 F.l
TOTAL FIXTURE UNITS		=	14.4 F.U

WATER CALCULATION - UN	NIT B2		
WATER CLOSET, FLUSH TANK (PRIVATE)	2 x	2.2 F.U.=	4.4 F.U.
LAVATORY (PRIVATE)	2 x	0.7 F.U.=	1.4 F.U.
SHOWER HEAD (PRIVATE)	1 x	1.4 F.U.=	1.4 F.U.
BATHTUB (PRIVATE)	1 x	1.4 F.U.=	1.4 F.U.
KITCHEN SINK, PRIVATE	1 x	1.4 F.U.=	1.4 F.U.
DISHWASHING MACHINE	1 x	1.4 F.U.=	1.4 F.U.
WASHING MACHINE, 8 LB (PUBLIC)	1 x	3.0 F.U.=	3.0 F.U.
TOTAL FIXTURE UNITS		=	14.4 F.U.
14.4 FIXTURE UNITS		=	17.2 GPM

WATER CLOSET, FLUSH TANK (PRIVATE)	2 x	2.2 F.U.=	4.4 F.U.
LAVATORY (PRIVATE)	3 x	0.7 F.U.=	2.1 F.U.
SHOWER HEAD (PRIVATE)	1 x	1.4 F.U.=	1.4 F.U.
BATHTUB (PRIVATE)	1 x	1.4 F.U.=	1.4 F.U.
KITCHEN SINK, PRIVATE	1 x	1.4 F.U.=	1.4 F.U.
DISHWASHING MACHINE	1 x	1.4 F.U.=	1.4 F.U.
WASHING MACHINE, 8 LB (PUBLIC)	1 x	3.0 F.U.=	3.0 F.U.
TOTAL FIXTURE UNITS		=	15.1 F.U.

WATER CLOSET, FLUSH TANK (PRIVATE)	2 x	2.2 F.U.=	4.4 F.
LAVATORY (PRIVATE)	3 x	0.7 F.U.=	2.1 F.
SHOWER HEAD (PRIVATE)	1 x	1.4 F.U.=	1.4 F.
BATHTUB (PRIVATE)	1 x	1.4 F.U.=	1.4 F.
KITCHEN SINK, PRIVATE	1 x	1.4 F.U.=	1.4 F.
DISHWASHING MACHINE	1 x	1.4 F.U.=	1.4 F.
WASHING MACHINE, 8 LB (PUBLIC)	1 x	3.0 F.U.=	3.0 F.
TOTAL FIXTURE UNITS		=	15.1 F.

WATER CLOSET, FLUSH TANK (PRIVATE)	2 x	2.2 F.U.=	4.4 F.U
LAVATORY (PRIVATE)	3 x	0.7 F.U.=	2.1 F.U
SHOWER HEAD (PRIVATE)	1 x	1.4 F.U.=	1.4 F.U
BATHTUB (PRIVATE)	1 x	1.4 F.U.=	1.4 F.U
KITCHEN SINK, PRIVATE	1 x	1.4 F.U.=	1.4 F.U
DISHWASHING MACHINE	1 x	1.4 F.U.=	1.4 F.U
WASHING MACHINE, 8 LB (PUBLIC)	1 x	3.0 F.U.=	3.0 F.U
TOTAL FIXTURE UNITS		=	15.1 F.U

WATER CALCULATION - UNIT B6				
WATER CLOSET, FLUSH TANK (PRIVATE)	2 x	2.2 F.U.=	4.4 F.U.	
LAVATORY (PRIVATE)	3 x	0.7 F.U.=	2.1 F.U.	
SHOWER HEAD (PRIVATE)	1 x	1.4 F.U.=	1.4 F.U.	
BATHTUB (PRIVATE)	1 x	1.4 F.U.=	1.4 F.U.	
KITCHEN SINK, PRIVATE	1 x	1.4 F.U.=	1.4 F.U.	
DISHWASHING MACHINE	1 x	1.4 F.U.=	1.4 F.U.	
WASHING MACHINE, 8 LB (PUBLIC)	1 x	3.0 F.U.=	3.0 F.U.	
TOTAL FIXTURE UNITS		=	15.1 F.U.	
15.1 FIXTURE UNITS		=	17.6 GPM	

WATER CLOSET, FLUSH TANK (PRIVATE)	2 x	2.2 F.U. =	4.4 F.U.
LAVATORY (PRIVATE)	3 x	0.7 F.U. =	2.1 F.U.
SHOWER HEAD (PRIVATE)	1 x	1.4 F.U. =	1.4 F.U.
BATHTUB (PRIVATE)	1 x	1.4 F.U. =	1.4 F.U.
KITCHEN SINK, PRIVATE	1 x	1.4 F.U. =	1.4 F.U.
DISHWASHING MACHINE	1 x	1.4 F.U. =	1.4 F.U.
WASHING MACHINE, 8 LB (PUBLIC)	1 x	3.0 F.U. =	3.0 F.U.
TOTAL FIXTURE UNITS		=	15.1 F.U.

WATER CLOSET, FLUSH TANK (PUBLIC)	1 x	5.0 F.U. =	5.0 F.U.
LAVATORY (PUBLIC)	1 x	2.0 F.U. =	2.0 F.U.
SERVICE SINK (PUBLIC)	1 x	3.0 F.U. =	3.0 F.U.
FIRST HOSE BIBB	1 x	2.5 F.U. =	2.5 F.U.
TOTAL FIXTURE UNITS		=	12.5 F.U.
12.5 FIXTURE UNITS		=	16.3 GPM

FIREPLACE COURTYARD)	1 x	142 MBH =	142 MBH
FIREPLACE (CLUBHOUSE)	1 x	116 MBH =	116 MBH
GRILLE	2 x	75 MBH =	150 MBH
TOTAL MBH		=	408 MBH
408 MBH = 408 CUBIC FOOT PER HOUR (CFH)			
			6 5557
VERTICAL PIPE LENGTH HORIZONTAL PIPE LENGTH METER TO LAST FIXTURE			6 FEET 200 FEET



Structural Engineer:

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MEP Engineer:

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ISSUANCES		
01	SCHEMATIC DESIGN	09.10.18
02	DEVELOPMENT DESIGN	11.09.18
03	PERMIT SET	01.28.19

REVISIONS



a multifamily project for NRP Group

West Cevallos
San Antonio, Texas

PLUMBING CALCULATIONS

Project Number 18054

Date 01/14/2018

Drawn By TLR

Checked By EEC

P502



MARK	CW	HW	VENT	S&W	MODEL NUMBER	DESCRIPTION
BFP	PER PLAN	-	_	1	BACKFLOW PREVENTOR: WATTS 757NRS	DOUBLE CHECK VALVE BACKFLOW PREVENTOR, STAINLESS STEEL, ASSE 1015. PROVIDE WITH WATTS 77F-DI-FD/EPOXY COATED CAST IRON STRAINER.
DB DCO	-	1/2"	-	-	IPS MDWB1 (2) SMITH 4237	DISHWASHER OUTLET BOX. SECURE BOX TO STRUCTURAL MEMBER. DOUBLE GROUND CLEANOUTS. INSTALL (2) GCO FIXTURES (REFER TO SCHEDULE BELOW AND DETAIL).
ECO	- 4 /211	- 4 /211	-	*	SMITH 4237	EXTERIOR CLEANOUT. CAST IRON WITH CAST IRON NON-TILT ADJUSTABLE TOP.
EWC	1/2"	1/2"	1-1/2"	2"	ELECTRIC WATER COOLER: ELKAY MODEL: LZWS-LRPBM28K	DUAL-LEVEL ELECTRIC WATER COOLER WITH SWIRLFLO REFRIGERATED FOUNTAIN WITH BOTTLE FILLER. WAL MOUNTED. 8 GPH., STAINLESS STEEL
FCO FD-1	-	-	2"	*	SMITH 4020 SMITH 2000	FLOOR CLEANOUT. CAST IRON WITH NICKEL BRONZE ADUSTABLE TOP. FLOOR DRAIN. CAST IRON. 4" ROUND BODY, MEDIUM DUTY. ADJUSTABLE STRAINER HEAD.
FD-2 FS	-	-	2" 2"	* 4"	SMITH 2110L-B SMITH 3140	FLOOR DRAIN. CAST IRON. 8" ROUND BODY, MEDIUM DUTY. ADJUSTABLE STRAINER HEAD. FLOOR SINK. CAST IRON RECEPTOR WITH ALUMINUM DOME BOTTOM STRAINER. 12-1/2" SQUARE NICKEL
		-		•		BRONZE TOP.
HD IMB	1/2"	-	1-1/2"	2" -	SMITH 3811 IPS W9700	HUB DRAIN. CAST IRON. PROVIDE WITH DEEP SEAL TRAP AND TRAP PRIMER PORT CONNECTION. ICE MAKER OUTLET BOX. SECURE BOX TO STRUCTURAL MEMBER. PROVIDE WITH WATTS LF009QT-S REDUCED
IWH-1	1/2"	1/2"	-	-	WATER HEATER: STIEBEL ELTRON	PRESSURE ZONE BACKFLOW PREVENTOR (OR APPROVED EQUAL). POINT OF USE MINITANK WATER HEATER, 2.5 GALLON TANK, 1.3 KW HEATING ELEMENT, 140°F OUTPUT, 18
MAINT					MODEL: SHC-2.5	MINUTE RECOVERY, 120V RECEPTACLE CONNECTION
140,41141						
IWH-2	1/2"	1/2"	-	-	WATER HEATER: EEMAX	INSTANTANEOUS TANKLESS WATER HEATER, 3.0 KW HEATING ELEMENT, 105°F OUTPUT, 0.3 GPM TURN ON, 41
POOL RR					MODEL: EX3012T	DEGREE TEMPERATURE RISE AT 0.5 GPM, 120V ELECTRIC POWER.
MAINT RR FITNESS RR						
IWH-3	1/2"	1/2"			WATER HEATER: EEMAX	INSTANTANEOUS TANKLESS WATER HEATER, 11.5 KW HEATING ELEMENT, 110°F OUTPUT, 0.3 GPM TURN ON, 3
10011-3	1/2	1/2	-	-	MODEL: EX012240T-ML	DEGREE TEMPERATURE RISE AT2.0 GPM, 240V ELECTRIC POWER.
CLUB						
L-1	1/2"	1/2"	1-1/2"	2"	LAVATORY: YUDU	VITREOUS CHINA, UNDER MOUNT. SELF-RIMMING WITH FRONT OVERFLOW. 20"DIAMETER RECTANGULAR SIN
UNIT	·				MODEL: WP-2114SB	3 HOLE, 4" CENTERS. WHITE FINISH.
ONII						
					FAUCET: CLEVELAND FAUCET GROUP MODEL: 46100	EDGESTONE LAVATORY FAUCET. METAL BODY, CERAMIC CARTRIDGE. 3 HOLE, 4" CENTERS. SINGLE LEVER HANDLE. 1.0 GPM AERATOR. PROVIDE POP-UP DRAIN. CHROME FINISH. ADA ACCESSIBLE.
L-2	1/2"	1/2"	1-1/2"	2"	LAVATORY: YUDU MODEL: WP-2114SB	VITREOUS CHINA, UNDER MOUNT. SELF-RIMMING WITH FRONT OVERFLOW. 20"DIAMETER RECTANGULAR SINGLES AS HOLE, 4" CENTERS. WHITE FINISH.
ADA UNIT						
UNII					FAUCET: CLEVELAND FAUCET GROUP	EDGESTONE LAVATORY FAUCET. METAL BODY, CERAMIC CARTRIDGE. 3 HOLE, 4" CENTERS. SINGLE LEVER
L-3	1/2"	1/2"	1-1/2"	2"	MODEL: 46103 LAVATORY: BRADLEY	HANDLE. 1.0 GPM AERATOR. PROVIDE POP-UP DRAIN. CHROME FINISH. ADA ACCESSIBLE. RECTANGLAR BOWL, OMNIDECK, 5000 SERIES, TERREON SOLID SURFACE MATERIAL, STAINLESS STEEL BASIN,
					MODEL: LD-5010-1	WALL, WASH BAR, TOUCH-FREE SOAP, WATER AND DRYER, CHARCOAL GRAY CUSTOM DIMENSIONS (REFER TO ID1.0 & ID6.0 FOR ADDITIONAL INFORMATION).INSULATE ALL EXPOSED DRAIN AND WATER PIPING UNDER SIN
						PER ADA REQUIREMENTS WITH TRUEBRO #102 WHITE INSULATION OR EQUIVALENT.
RESTROOM					MIXING VALVE: LEONARD	ASSE 1070 LEAD FREE, BRONZE BODY THERMOSTATIC MIXING VALVE. SET TO OUTELET TEMPERATURE TO 105°
					MODEL: 270-LF	
					FAUCET: CHICAGO FAUCET MODEL: 116.750.AB.1	SENSOR LAVATORY FAUCET. METAL BODY, SINGLE HOLE. SINGLE LEVER HANDLE. 0.5 GPM AERATOR. PROVIDE POP-UP DRAIN. CHROME FINISH. ADA COMPLIANT. PROVIDE WITH TRANSFORMER.
L-4	1/2"	1/2"	1-1/2"	2"	LAVATORY: KOHLER	VITREOUS CHINA, WALL-MOUNT LAVATORY. SELF-RIMMING WITH FRONT OVERFLOW. RECTANGULAR, WHITE
					MODEL: K-2035-0 "PINOIR"	FINISH. MOUNT IN ADA ACCESSIBLE INSTALLATION. INSULATE ALL EXPOSED DRAIN AND WATER PIPING UNDEF SINK PER ADA REQUIREMENTS WITH TRUEBRO #102 WHITE INSULATION OR EQUIVALENT.
MAINT.					MIXING VALVE: LEONARD	ASSE 1070 LEAD FREE, BRONZE BODY THERMOSTATIC MIXING VALVE. SET TO OUTELET TEMPERATURE TO 105°
					MODEL: 270-LF	
					FAUCET: CHICAGO FAUCET	SENSOR LAVATORY FAUCET. METAL BODY, SINGLE HOLE. SINGLE LEVER HANDLE. 0.5 GPM AERATOR. PROVIDE
L-5	1/2"	1/2"	1-1/2"	2"	MODEL: 116.750.AB.1 LAVATORY: BRADLEY	POP-UP DRAIN. CHROME FINISH. ADA COMPLIANT. PROVIDE WITH TRANSFORMER. RECTANGLAR BOWL, OMNIDECK, 5000 SERIES, TERREON SOLID SURFACE MATERIAL, STAINLESS STEEL BASIN,
					MODEL: LD-5010-1	WALL, WASH BAR, TOUCH-FREE SOAP, WATER AND DRYER, CHARCOAL GRAY CUSTOM DIMENSIONS (REFER TO ID1.0 & ID6.0 FOR ADDITIONAL INFORMATION).INSULATE ALL EXPOSED DRAIN AND WATER PIPING UNDER SIN
LEASING						PER ADA REQUIREMENTS WITH TRUEBRO #102 WHITE INSULATION OR EQUIVALENT.
CLUB RR					MIXING VALVE: LEONARD	ASSE 1070 LEAD FREE, BRONZE BODY THERMOSTATIC MIXING VALVE. SET TO OUTELET TEMPERATURE TO 105°
POOL RR					MODEL: 270-LF	
					FAUCET: CHICAGO FAUCET MODEL: 116.750.AB.1	SENSOR LAVATORY FAUCET. METAL BODY, SINGLE HOLE. SINGLE LEVER HANDLE. 0.5 GPM AERATOR. PROVIDE POP-UP DRAIN. CHROME FINISH. ADA COMPLIANT. PROVIDE WITH TRANSFORMER.
NWH SK-1	3/4" 1/2"	- 1/2"	- 1-1/2"	- 2"	HOSE BIBB: WOODFORD B67 KITCHEN: STERLING (OR EQUAL)	RECESSED NON-FREEZE WALL HYDRANT, FREEZE PROOF, ANTI-SIPHON VACUUM BREAKER, LOSSE KEY HANDLE.
	1/2	1/2	1-1/2	2	MODEL: 11600-NA	UNDER-MOUNT, SINGLE BOWL SINK, 31-7/8"X18-1/16"X9-5/16", STAINLESS STEEL
UNIT					kitchen: sterling (or equal) MODEL: 97447-NA	UNDER-MOUNT, SINGLE BOWL SINK, 23-3/8"X1-11/16"8", STAINLESS STEEL
					DISPOSER: IN-SINK-ERATOR BADGER 5	DISPOSER. RESIDENTIAL DISPOSER WITH 1/2 HP MOTOR. PROVIDE STEEL BLADES, AND LUBRICATED BEARINGS
					, and the state of	120V, SINGLE PHASE. ELECTRICAL TO PROVIDE OUTLET.
					FAUCET: CLEVELAND FAUCET GROUP	SINK FAUCET. EDGESTON SINGLE HOLE, SINGLE LEVER, 1.5 GPM. CHROME FINISH. ADA COMPLIANT.
SK-2	1/2"	1/2"	1-1/2"	2"	MODEL: CA46201CH KITCHEN: ELKAY	DAYTON DOUBLE BOWL SINK. STAINLESS STEEL, 22 GA. UNDER MOUNT 4 HOLES, 21-1/4"W x 33"L x 5-3/8"H
ACC					MODEL: ELUHAD2816	EACH BOWL, ADA COMPLIANT.
UNIT					DISPOSER: IN-SINK-ERATOR BADGER 5	DISPOSER. RESIDENTIAL DISPOSER WITH 1/2 HP MOTOR. PROVIDE STEEL BLADES, AND LUBRICATED BEARINGS
					S.S. SSEN. IN SHAK ENATOR DADGER S	120V, SINGLE PHASE. ELECTRICAL TO PROVIDE OUTLET.
					FAUCET: CLEVELAND FAUCET GROUP	SINK FAUCET. EDGESTON SINGLE HOLE, SINGLE LEVER, 1.5 GPM. CHROME FINISH. ADA COMPLIANT.
					MODEL: CA46201CH ALTERNATE: DANZE D455158 OR D457144	
SK-3	1/2"	1/2"	1-1/2"	2"	KITCHEN: ELKAY MODEL: ELUHAD191655PD	SINGLE BOWL SINK. STAINLESS STEEL, 18 GA. UNDER MOUNT, 21-1/2"X18-1/2"X5-3/8" SINK, 19"X16"X5-3/8" BOWL. ADA COMPLIANT. MATTE BLACK, MOUNT IN ADA ACCESSIBLE INSTALLATION. INSULATE ALL EXPOSED
						DRAIN AND WATER PIPING UNDER SINK PER ADA REQUIREMENTS WITH TRUEBRO #102 WHITE INSULATION O
						EQUIVALENT.
VORK/BREAK ROOM					MIXING VALVE: LEONARD MODEL: 270-LF	ASSE 1070 LEAD FREE, BRONZE BODY THERMOSTATIC MIXING VALVE. SET TO OUTELET TEMPERATURE TO 110°
					FAUCET: DANZE	SINK FAUCET. SINGLE LEVER HANDLE. PARMA, WITH SIDE SPRAY, 1.5 GPM. CHROME FINISH. 2-HOLE, 15" H X 9-
CIV 4	4./0"	4 /0"	4 4 /="	0 "	MODEL: D401058SS	1/4" L, ADA COMPLIANT.
SK-4	1/2"	1/2"	1-1/2"	2"	KITCHEN: KOHLER MODEL: K8437-1-CM1	SINGLE BOWL SINK. STAINLESS STEEL, UNDERMOUNT MOUNT 1 HOLE ON REAR DECK, 9-1/2" DEEP WITH SINK RACK.
ROOF CLUB					FAUCET: DANZE	SINK FAUCET. SINGLE LEVER HANDLE, 2- FUNCTION SPRAY/AERATED STREAM, 8" DECK PLATE, 1.75 GPM.
		1			1710 0211 0711122	

MARK	CW	HW	VENT	S&W	MODEL NUMBER	DESCRIPTION
SK-5	1/2"	1/2"	1-1/2"	2"	KITCHEN: ELKAY MODEL: ELGUAD2519PD	SINGLE BOWL SINK. UNDERMOUNT MOUNT, QUARTZ,BLACK, PERFECT DRAIN, ADA COMPLIANT, 25"x18-1/2"x5 1/2"
COFFEE BAR						
SKY LOUNGE					FAUCET: DANZE MODEL: D404562	SINK FAUCET. EDGESTON SINGLE HOLE, SINGLE LEVER, 1.5 GPM. CHROME FINISH. ADA COMPLIANT.
SK-6	3/4"	3/4"	2"	-	SERVICE SINK: ELKAY MODEL: EFS2523C	SERVICE SINK BASIN, MOLDED STONE, FLOOR MOUNT, 24"W x 24"L x 10"D BASIN, STAINLESS STEEL STRAINER, DRAIN BODY AND LINT BASKET
MAINT	М				FAUCET: T&S BRASS	
					MODEL: B-0665-BSTR	COMBINATION FAUCET WITH VACUUM BREAKER, 3/4" HOSE THREAD ON SPOUT, PAIL HOOK, LEVER HANDLES, INTEGRAL STOPS, WALL BRACE, MOP BRACKET
					FAUCET: CLEVELAND FAUCET GROUP	SHOWER VALVE TRIM, LEVEL HANDLE TUB/SHOWER, CHROME, 1.75 GPM, 45312 CYCLING 1/2" CC MALE IPS
SH-1	1/2"	1/2"	2"		MODEL: 40311CGR BATHTUB: STERLING	CONNECTION INCLUDED. ENSEMBLE, 48" SHOWER PAN, VIKREL/FIBERGLASS MATERIAL, WHITE
UNIT	·				MODEL: 7212110	
01411					MIXING VALVE: LEONARD	ASSE 1070 LEAD FREE, BRONZE BODY THERMOSTATIC MIXING VALVE. SET TO OUTELET TEMPERATURE TO 110°F
					MODEL: 270-LF	
					FAUCET: CLEVELAND FAUCET GROUP MODEL: 016-300C	HAND HELD SHOWER, 3 FUNCTIONS, INCLUDES BACKFLOW PREVENTOR, 60" METAL HOSE WITH MATCHING FINISH
SH-2	1/2"	1/2"	2"		BATHTUB: STERLING	ENSEMBLE ROLL-IN 63" SHOWER PAN, VIKRELL MATERIAL, WHITE, ADA COMPLIANT ROLL-IN SHOWER
ACC					MODEL: 62060103	
UNIT					MIXING VALVE: LEONARD MODEL: 270-LF	ASSE 1070 LEAD FREE, BRONZE BODY THERMOSTATIC MIXING VALVE. SET TO OUTELET TEMPERATURE TO 110°F
						LIAND HELD SHOWED A SUNGTIONS INCLUDES DAGYELOW DESVENTOR SOULATERAL HOSE WITH MATCHING
					FAUCET: CLEVELAND FAUCET GROUP MODEL: 016-300C	HAND HELD SHOWER, 3 FUNCTIONS, INCLUDES BACKFLOW PREVENTOR, 60" METAL HOSE WITH MATCHING FINISH
SP-1	-	-	-		SUMP PUMP: GRUNDFOS	ELEVATAOR PIT SUMP PUMP, 50.6 GPM, SEMI-OPEN IMPELLER, STAINLESS STEEL, ANSI 304, 32.8' MAXIMUM
SP-2	-	-	-		KP-250 - 012DC1001 SUMP PUMP: LIBERTY PUMPS	DEPTH, 120V, 480 W, 10' LENGTH OF CABLE. LID FEATURE SUBMERSIBLE PUMP, 30 GPM, 3/4" SOLIDS HANDLING CAPACITY, 115V, 1/2 HP, 3,450 RPM, 60
TB-1	3/4"	3/4"	2"	3"	280 SERIES TUB: STERLING	HERTZ, 25' TOTAL HEAD DISCHARGE ALL PRO BATHTUB, 32"X60", VIKERLL MATERAL SWIRL GLOSS
	, . 	3, .			MODEL: ENSEMBLE 71121110	, lee the symmetry of the lee to the least the
UNIT					FALIGET OF STATE AND THE STATE OF STATE	EDOCECTONE LEVEL HANDLE TUD (SUBJUSE CONTROL OF CONTROL
					FAUCET: CLEVELAND FAUCET GROUP MODEL: T46301CGR	EDGESTONE LEVEL HANDLE TUB/SHOWER, CHROME, 1.75 GPM, 45312 CYCLING 1/2" CC MALE IPS CONNECTION INCLUDED.
TB-2	3/4"	3/4"	2"		TUB: STERLING MODEL: ENSEMBLE 71121110	ALL PRO BATHTUB, 32"X60", VIKERLL MATERAL SWIRL GLOSS
ACC UNIT						
OWIT					FAUCET: CLEVELAND FAUCET GROUP	EDGESTONE LEVEL HANDLE TUB/SHOWER, CHROME, 1.75 GPM, 45312 CYCLING 1/2" CC MALE IPS CONNECTION
UR	1/2"	-	2"		MODEL: T46301CGR WATER CLOSET: KOHLER	INCLUDED, ADA COMPLIANT BARDON, FLUSH METER VALVE AND WASHDOWN URINAL, HIGH EFFICIENCY, 26-7/8"HX18"WX14-18-1/8"D,
СОММ					MODEL: K4991-ET-0	WHITE, POLISHED CHROME, ADA COMPLIANT
					FLUSH VALVE: K-13519-CP	FLUSHMETER VALVE 0.5 GPF
WC-1	1/2"	-	2"	3"	WATER CLOSET: GERBER MODEL: HE-21-802	AVALANCHE, FLUSH TANK WATER CLOSET, HIGH EFFICIENCY, 28-3/4 H, ROUND BOWL, 1.28 GPF, WHITE
UNIT					SEAT: KOHLER:K-4639	CLOSED FRONT, ELONGATED SEAT WITH STAINLESS STEEL LOCKING HINGE AND COVER. ADA ACCESSIBLE.
WC-2	1/2"	-	2"	3"	WATER CLOSET: GERBER	FLUSH TANK WATER CLOSET, HIGH EFFICIENCY, 17" H, ELONGATED BOWL, 1.28 GPF, WHITE, ADA COMPLIANT
ACC					MODEL: 21-818	
UNIT					SEAT: KOHLER K-4636-0	CLOSED FRONT, ELONGATED SEAT WITH STAINLESS STEEL LOCKING HINGE AND COVER. ADA ACCESSIBLE.
WC-3	1/2"	-	2"		WATER CLOSET: TOTO MODEL: CT705ELN #1	FLUSH VALVE WATER CLOSET, FLOOR MOUNTED, ELONGATED BOWL, #01 COTTON, 1.28 GPF., ADA COMPLIANT
AMENITY					 FLUSH VALVE: TOTO TMT1LN32#CP	FLUSH VALVE, TOP-MOUNT, 1.28 GPF, MANUAL, POLISHED CHROME FINISH, EXPOSED.
WC-4	1/2"	_	2"	3"	SEAT: AMERICAN STANDARD 5901.110T WATER CLOSET: TOTO	OPEN FRONT, ELONGATED SEAT WITH EVERCLEAN SURFACE, STAINLESS STEEL LOCKING HINGE. FLUSH VALVE WATER CLOSET, SIPHON JET FLUSHING ACTION, WHITE VITREOUS CHINA, WALL-MOUNTED, BACK
AMENITY	·				MODEL: CT708E#01	OUTLET OUTLET, ELONGATED BOWL, WHITE, 1.28 GPF. ADA ACCESSIBLE.
FITNESS					FLUSH VALVE: TOTO TET2LA32#SS	FLUSH VALVE, TOP-MOUNT, 1.28 GPF, MANUAL, POLISHED CHROME FINISH, EXPOSED. ADA ACCESSIBLE.
					SEAT: TOTO SC534	OPEN FRONT, ELONGATED SEAT WITH STAINLESS STEEL LOCKING HINGE, ADA ACCESSIBLE.
WC-5	1/2"	-	2"		WATER CLOSET: GERBER	FLUSH TANK WATER CLOSET, HIGH EFFICIENCY, 17" H, ELONGATED BOWL, 1.28 GPF, WHITE, ADA COMPLIANT
MAINT					MODEL: PF96403WH	
WCO	-	=	_		SEAT: KOHLER K-4636-0 SMITH 9776	CLOSED FRONT, ELONGATED SEAT WITH STAINLESS STEEL LOCKING HINGE AND COVER. ADA ACCESSIBLE. WALL CLEANOUT WITH THREADED PLUG AND COVER. HEAVY DUTY. POLISHED STAINLESS STEEL COVER PLATE.
	-	2.1				ROUGH FINISH STAINLESS STEEL PLUG.
WH-1	3/4"	3/4"	_	-	WATER HEATER: A.O. SMITH MODEL: DEL-40	LOWBOY ELECTRIC WATER HEATER, 40 GALLON TANK, 9 KW HEATING ELEMENT, 120°F OUTPUT, 70 GPH RECOVERY AT 53°F TEMPERATURE RISE, 240V/1Ø ELECTRIC POWER.
A UNIT					EXPANSION TANK: AMTROL ST-5	2 GALLON INLINE EXPANSION TANK. SET TANK AIR SIDE PRESSURE TO MATCH DOMESTIC WATER SYSTEM
WH-2	3/4"	3/4"	_	_	WATER HEATER: A.O. SMITH	PRESSURE. LOWBOY ELECTRIC WATER HEATER, 50 GALLON TANK, 9 KW HEATING ELEMENT, 120°F OUTPUT, 70 GPH
	-, -	_, ¬			MODEL: DEL-50	RECOVERY AT 53°F TEMPERATURE RISE, 240V/1Ø ELECTRIC POWER.
B, C & D UNIT					EXPANSION TANK: AMTROL ST-5	2 GALLON INLINE EXPANSION TANK. SET TANK AIR SIDE PRESSURE TO MATCH DOMESTIC WATER SYSTEM
WH-3	3/4"	3/4"	-	-	WATER HEATER: A.O. SMITH	PRESSURE. LOWBOY ELECTRIC WATER HEATER, 20 GALLON TANK, 3 KW HEATING ELEMENT, 120°F OUTPUT, 23 GPH
COMM					MODEL: DEL-20	RECOVERY AT 53°F TEMPERATURE RISE, 240V/1Ø ELECTRIC POWER.
CTR					EXPANSION TANK: AMTROL ST-5	2 GALLON INLINE EXPANSION TANK. SET TANK AIR SIDE PRESSURE TO MATCH DOMESTIC WATER SYSTEM
WH-4	3/4"	3/4"	-		WATER HEATER: RHEEM	PRESSURE. ELECTRIC WATER HEATER, 10 GALLON TANK, 3 KW HEATING ELEMENT, 120°F OUTPUT, 53 GPH RECOVERY AT 53
MAINT					MODEL: ES10-G	TEMPERATURE RISE, 240V/1Ø ELECTRIC POWER.
					EXPANSION TANK: AMTROL ST-5	2 GALLON INLINE EXPANSION TANK. SET TANK AIR SIDE PRESSURE TO MATCH DOMESTIC WATER SYSTEM PRESSURE.
WH-5	3/4"	3/4"	-	-	WATER HEATER: A.O. SMITH	ELECTRIC WATER HEATER, 80 GALLON TANK, 9 KW HEATING ELEMENT, 120°F OUTPUT, 72 GPH RECOVERY AT 53
					MODEL: DEN-80	TEMPERATURE RISE, 208V/3Ø ELECTRIC POWER.
LAUNDRY					EXPANSION TANK: AMTROL ST-5	2 GALLON INLINE EXPANSION TANK. SET TANK AIR SIDE PRESSURE TO MATCH DOMESTIC WATER SYSTEM PRESSURE.
WHA WMB	- 1/2"	- 1/2"	- 1-1/2"		PRECISION PLUMBING PRODUCTS IPS W4700	WATER HAMMER ARRESTOR. PROVIDE PDI SIZES "A" THROUGH "F" AS INDICATED ON PLANS. WASHING MACHINE OUTLET BOX. SECURE BOX TO STRUCTURAL MEMBER. PROVIDE WITH WATER HAMMER
עווווא	-/ -	1/4	/-2		5 ** 1766	ARRESTOR.

** PLUMBING FIXTURES, ACCESSORIES AND INSTALLATION SHALL MEET ALL FEDERAL, STATE, ADA AND LOCAL REQUIREMENTS.





Structural Engineer:

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Interior Designer:

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ISSUANCES		
01	SCHEMATIC DESIGN	09.10.18
02	DEVELOPMENT DESIGN	11.09.18
03	PERMIT SET	01.28.19

REVISIONS



a multifamily project for NRP Group

West Cevallos
San Antonio, Texas

PLUMBING SCHEDULES


Project Number 18054

Date 01/14/2018


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Checked By EEC


P503

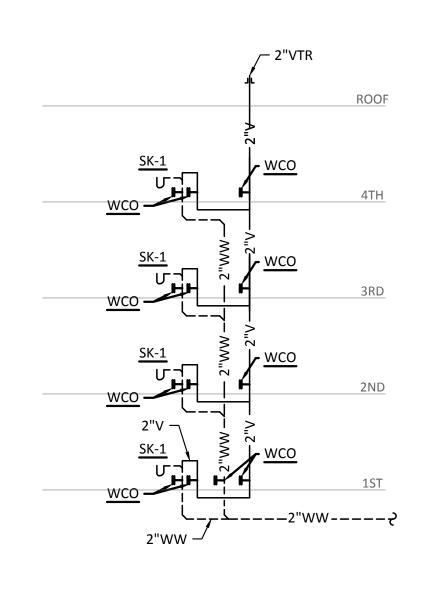


1 ISLAND KITCHEN WASTE & VENT RISER
N.T.S.

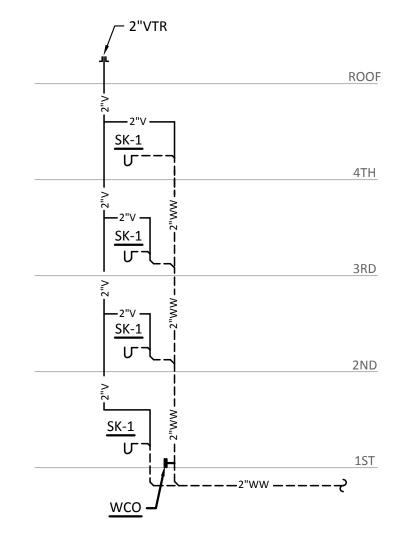


2 SINK WASTE & VENT RISER N.T.S.

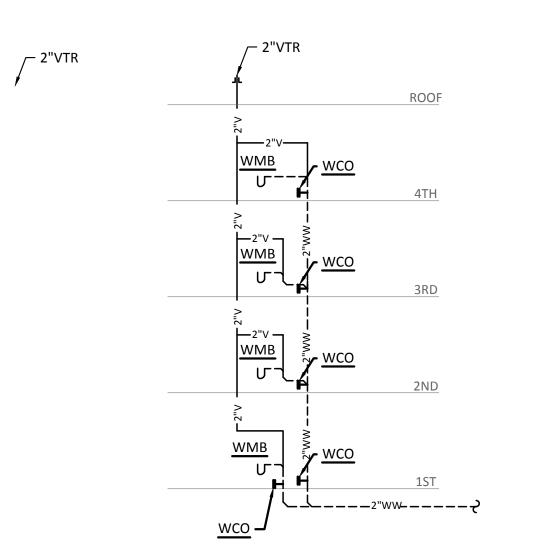


3 WASHING MACHINE BOX WASTE & VENT RISER N.T.S.

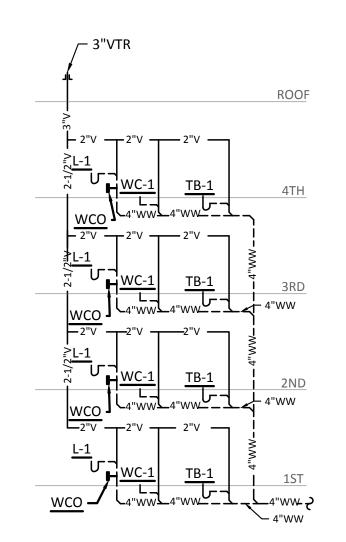


4 BATHROOM GROUPING WASTE & VENT RISER
N.T.S.

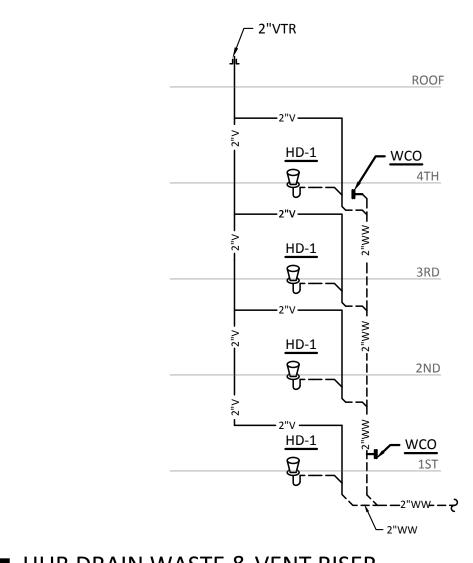


 $\mathbf{5} \, \underset{\mathsf{N.T.S.}}{\mathsf{HUB}} \, \mathsf{DRAIN} \, \mathsf{WASTE} \, \& \, \mathsf{VENT} \, \mathsf{RISER}$

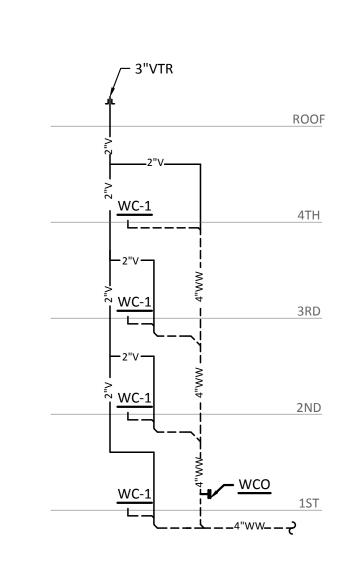


 $6 \frac{\text{WATER CLOSET WASTE & VENT RISER}}{\text{N.T.s.}}$

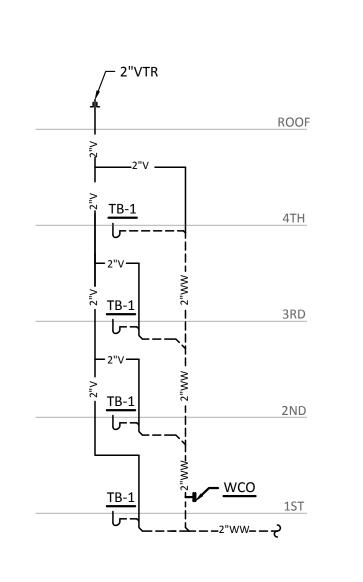


 $7 \frac{\text{TUB WASTE & VENT RISER}}{\text{N.T.s.}}$

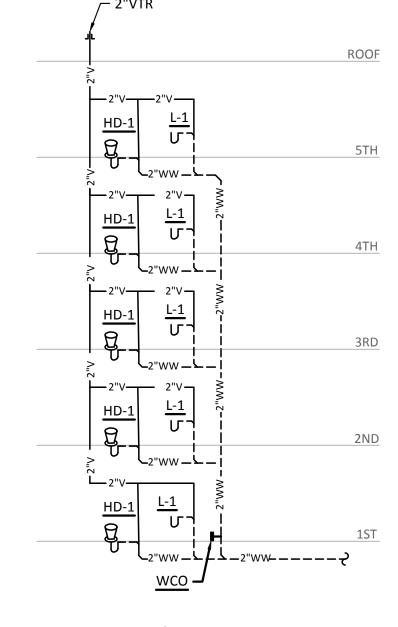


8 LAVATORY WASTE & VENT RISER N.T.S.

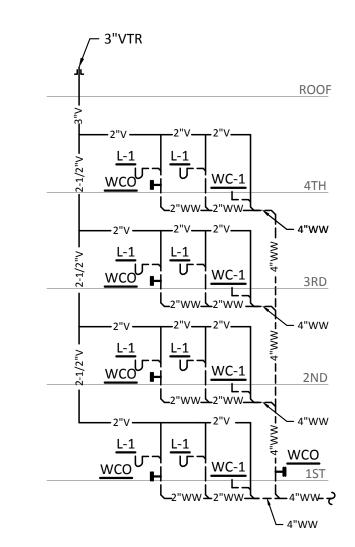


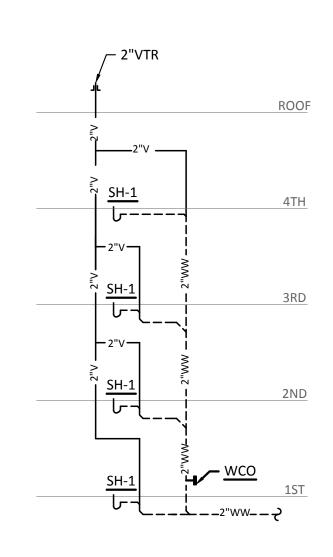

10 SHOWER WASTE & VENT RISER N.T.S.

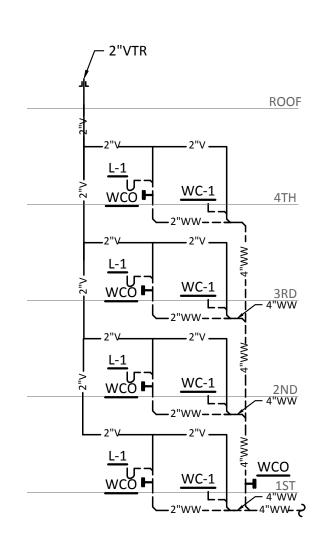

1 1 WATER CLOSET/LAVATORY WASTE & VENT RISER
N.T.S.

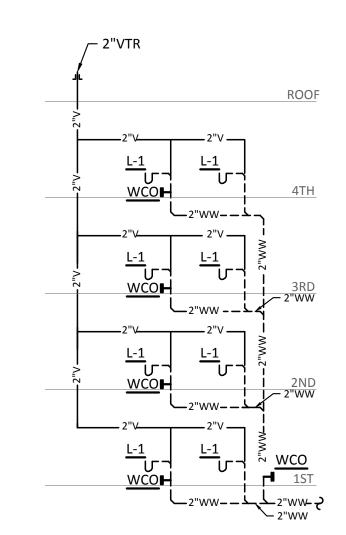

12 LAVATORY WASTE & VENT RISER N.T.S.





Structural Engineer: VIEWTECH INC. 4205 Beltway Dr. Addison, TX 75001 Victor Lisiak III

MEP Engineer:

972.661.8187

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Civil Engineer:

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Interior Designer:

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ISSUANCES		
01	SCHEMATIC DESIGN	09.10.18
02	DEVELOPMENT DESIGN	11.09.18
03	PERMIT SET	01.28.19

REVISIONS




a multifamily project for NRP Group


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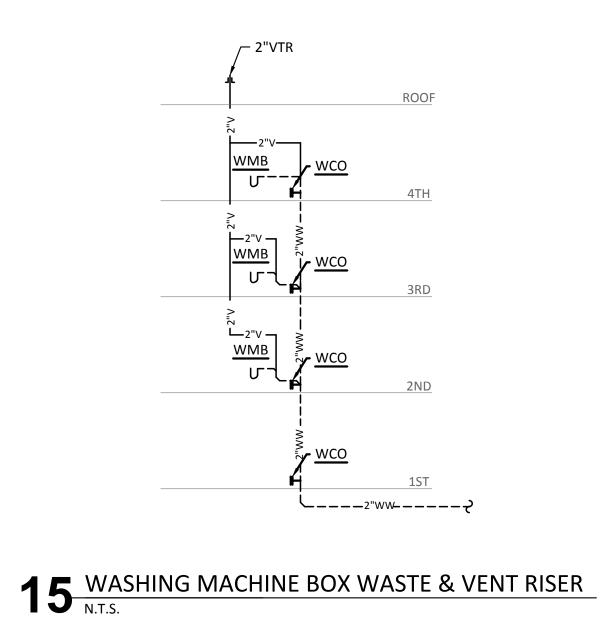
PLUMBING WASTEWATER RISERS


	TL	Drawn By
Date 01/14/2018		

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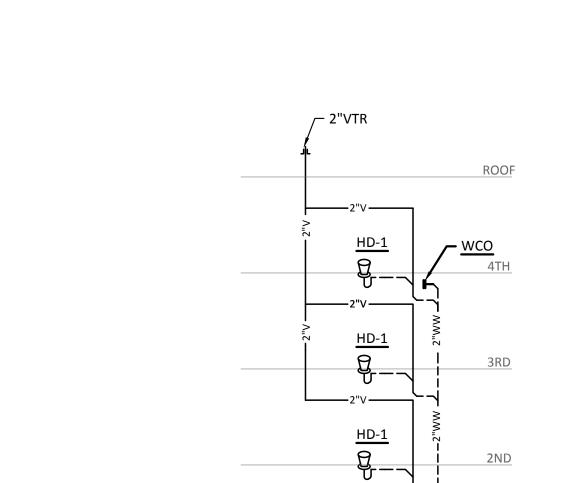





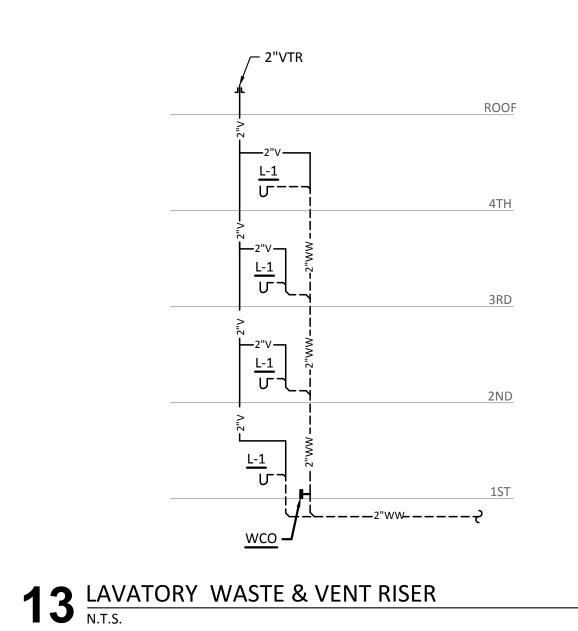

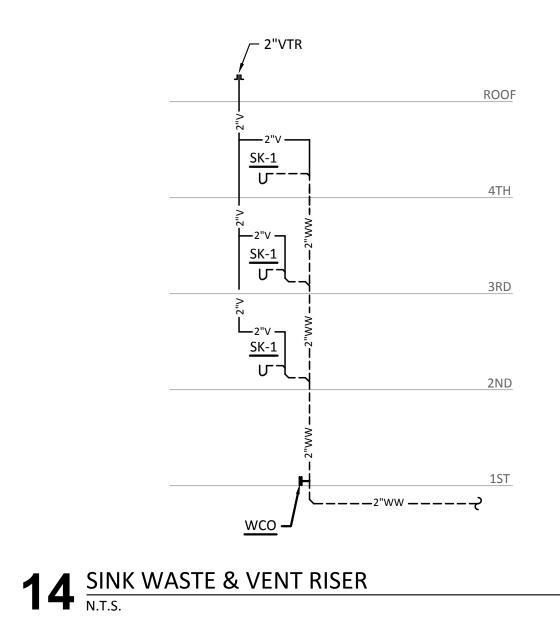


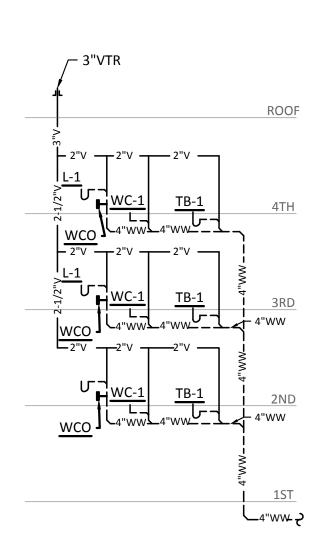
16 BATHROOM GROUPING WASTE & VENT RISER



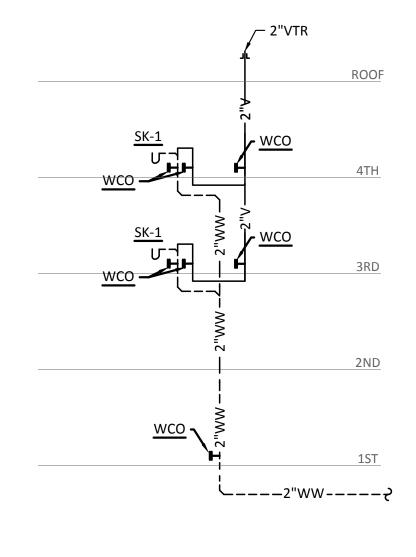


18 ISLAND KITCHEN WASTE & VENT RISER
N.T.S.

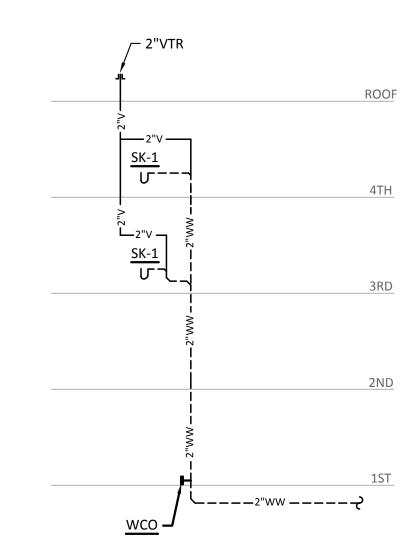


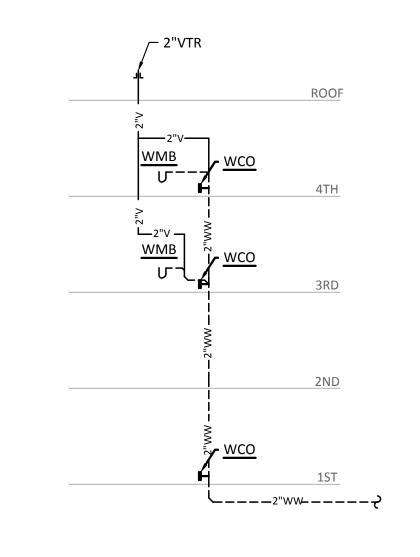


19 SINK WASTE & VENT RISER 20 WASHING MACHINE BOX WASTE & VENT RISER N.T.S.


17 HUB DRAIN WASTE & VENT RISER N.T.S.

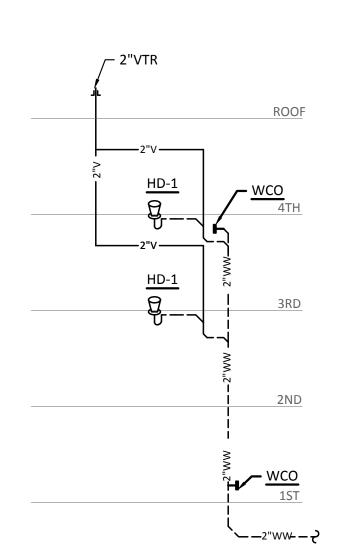

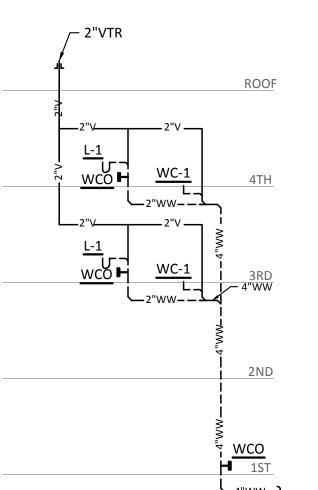

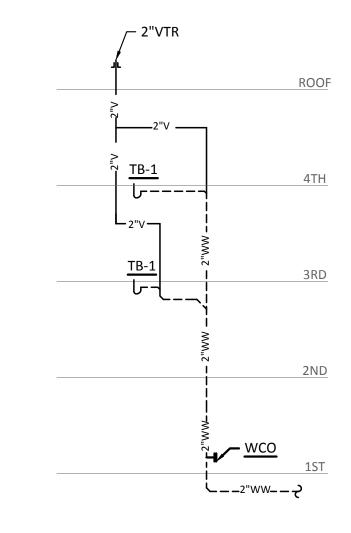


24 TUB WASTE & VENT RISER
N.T.S.

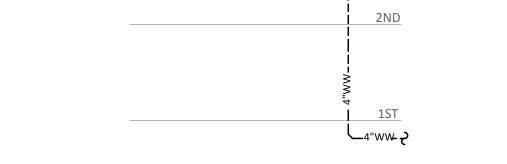

21 BATHROOM GROUPING WASTE & VENT RISER
N.T.S.





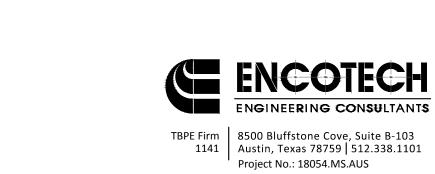



OLLABORATIVE S Lamar Blvd, Suite 103 Austin, Texas 78704 512.852.4310
Structural Engineer:
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ISSUANCES		
01	SCHEMATIC DESIGN	09.10.18
02	DEVELOPMENT DESIGN	11.09.18
03	PERMIT SET	01.28.19
	<u> </u>	· · · · · · · · · · · · · · · · · · ·

REVISIONS





a multifamily project for NRP Group


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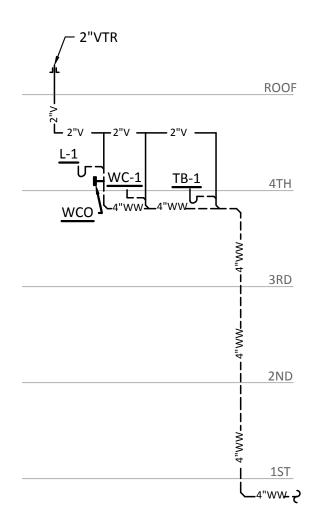
PLUMBING WASTEWATER RISERS

P60)2
Checked By	EEC
Drawn By	TLR
Date	01/14/2018
Project Number	18054



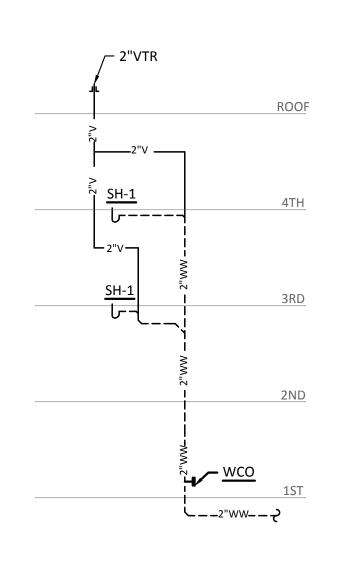

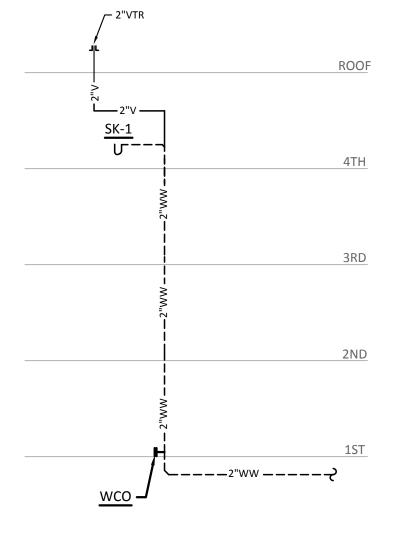

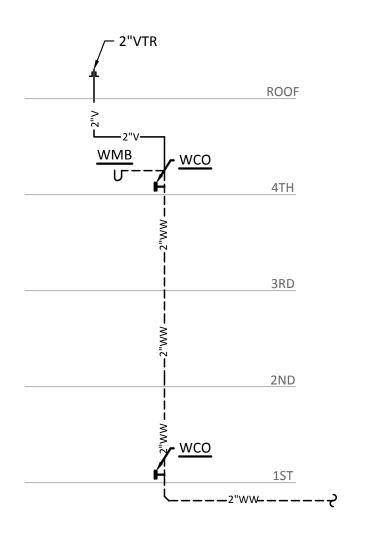



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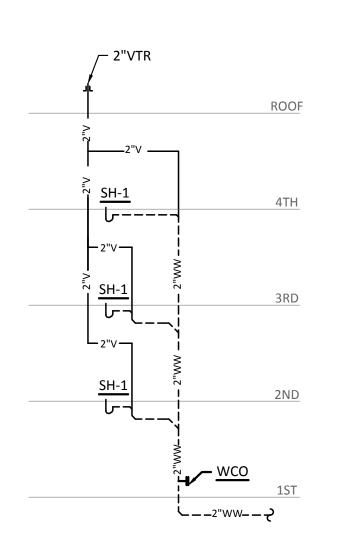
25 SHOWER WASTE & VENT RISER N.T.S.


26 SINK WASTE & VENT RISER N.T.S.

27 WASHING MACHINE BOX WASTE & VENT RISER N.T.S.



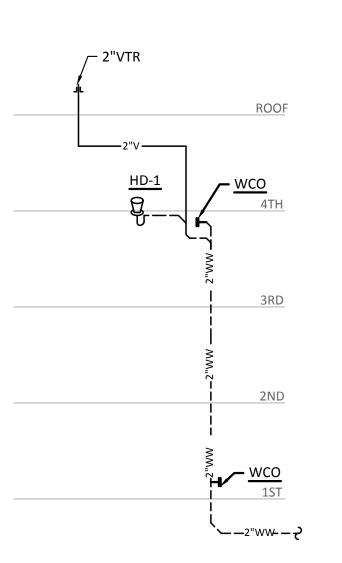

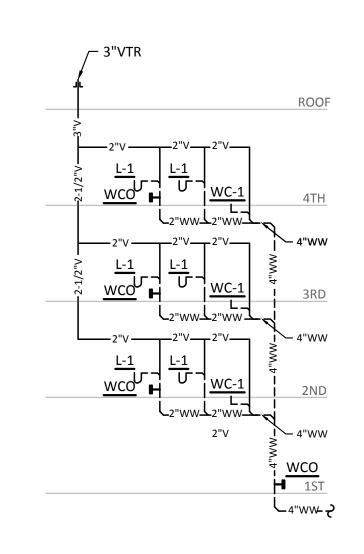


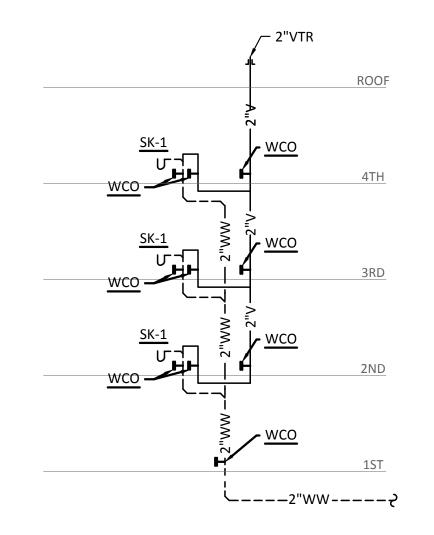


29 HUB DRAIN WASTE & VENT RISER


31 SHOWER WASTE & VENT RISER N.T.S.


32 ISLAND KITCHEN WASTE & VENT RISER N.T.S.

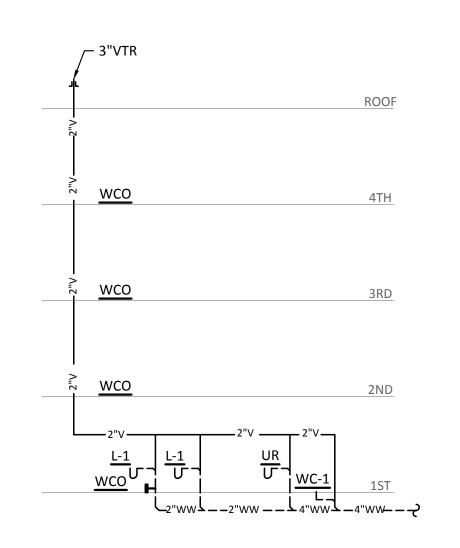

 $33 \frac{\text{PUBLIC MENS RESTROOM WASTE & VENT RISER}}{\text{N.T.S.}}$

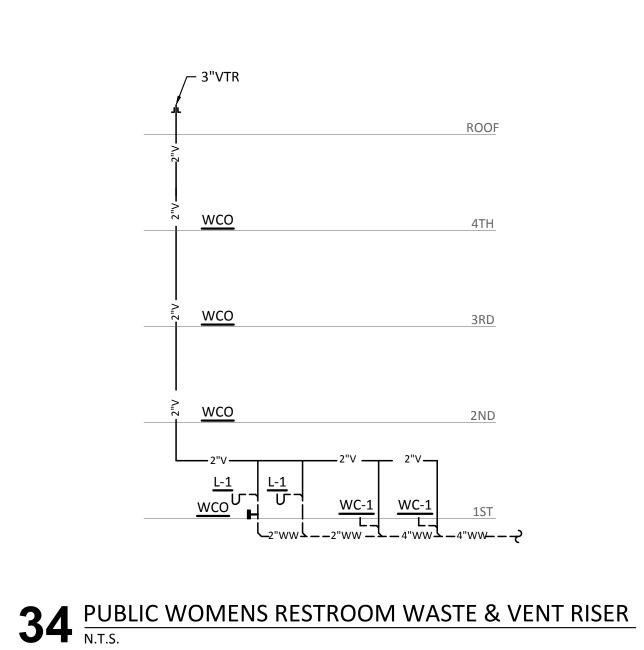

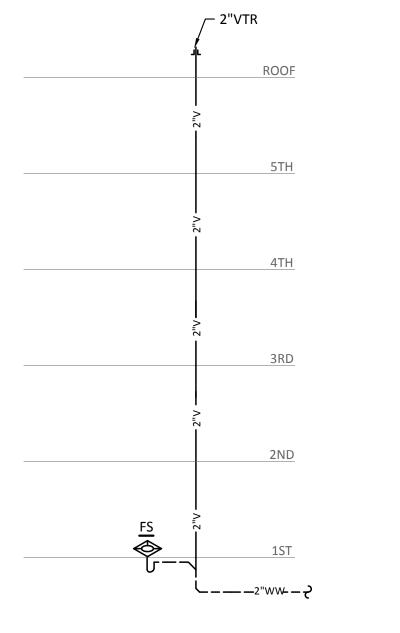

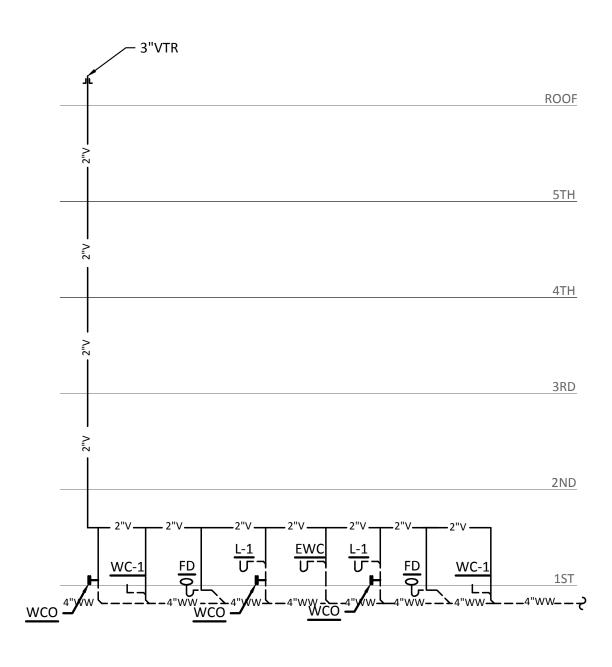

35 FLOOR SINK WASTE & VENT RISER N.T.S.

36 POOL RESTROOMS WASTE & VENT RISER N.T.S.





Structural Engineer:
VIEWTECH INC.
4205 Beltway Dr. Addison, TX 75001
Victor Lisiak III
972.661.8187

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ISSUANCES

ISSUANCES		
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02	DEVELOPMENT DESIGN	11.09.18
03	PERMIT SET	01.28.19



a multifamily project for NRP Group


West Cevallos


San Antonio, Texas


PLUMBING WASTEWATER RISERS

Project Number	18054
Date	01/14/2018
Drawn By	TLR
Checked By	EEC


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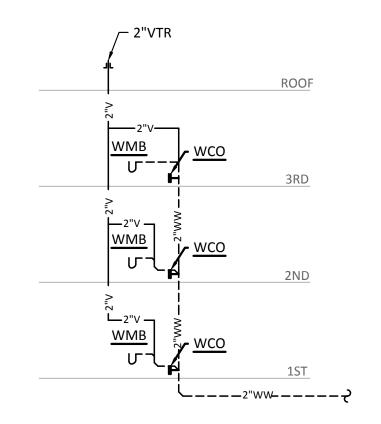


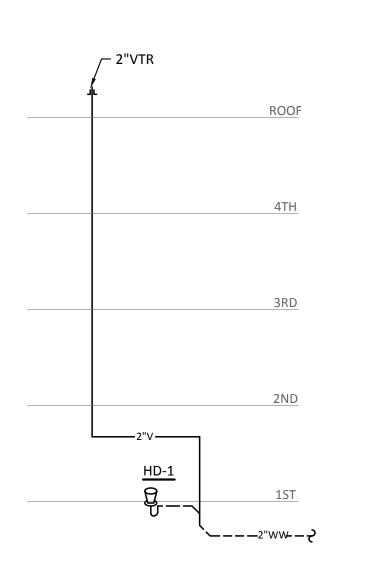

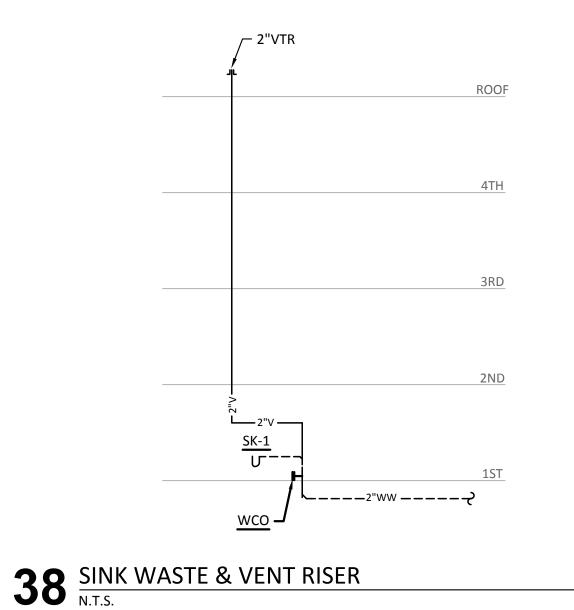
39 LAVATORY WASTE & VENT RISER N.T.S.

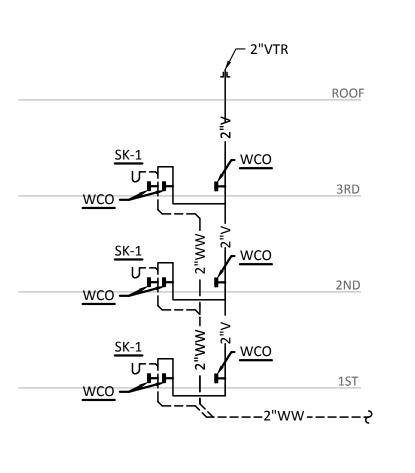



40 SINK WASTE & VENT RISER N.T.S.

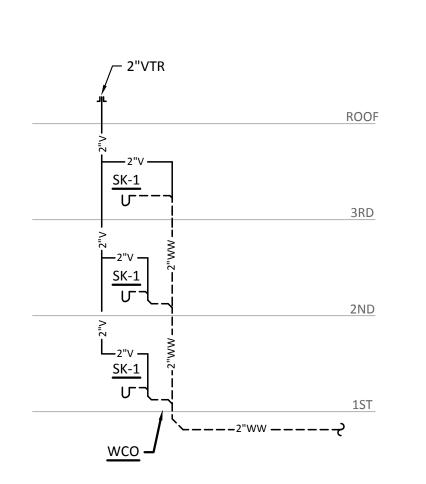

37 HUB DRAIN WASTE & VENT RISER N.T.S.

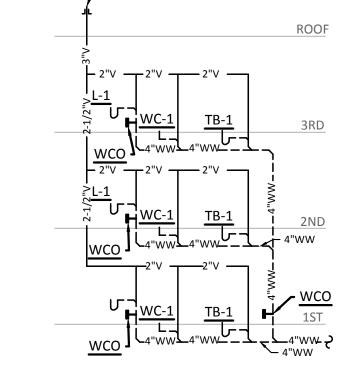

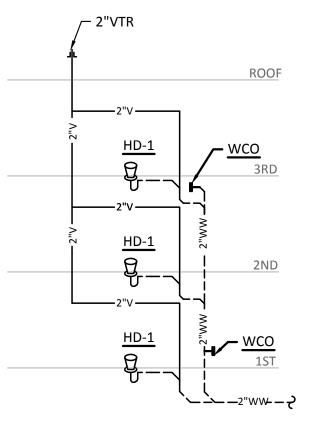

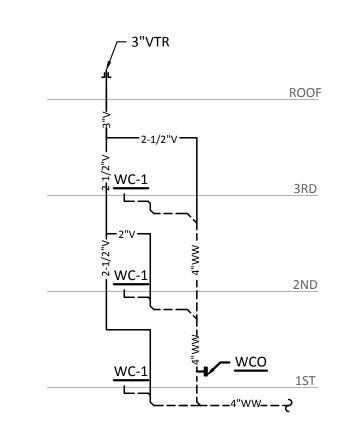


41 WASHING MACHINE BOX WASTE & VENT RISER


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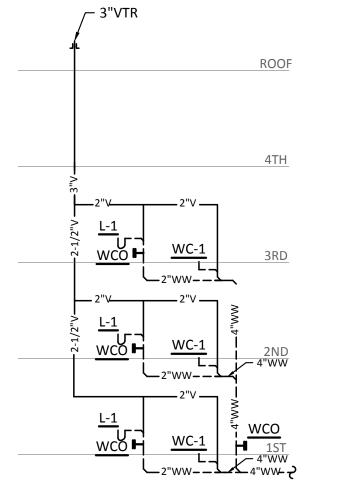



43 HUB DRAIN WASTE & VENT RISER $\frac{1}{N.T.S.}$

44 WATER CLOSET WASTE & VENT RISER
N.T.S.



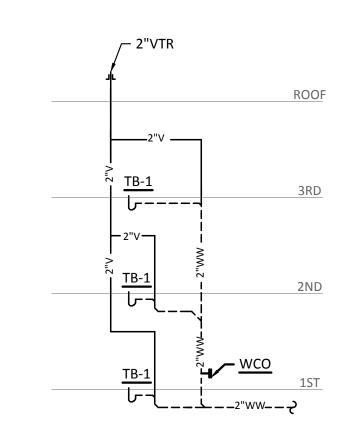

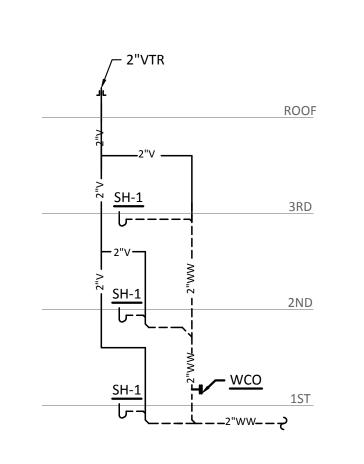

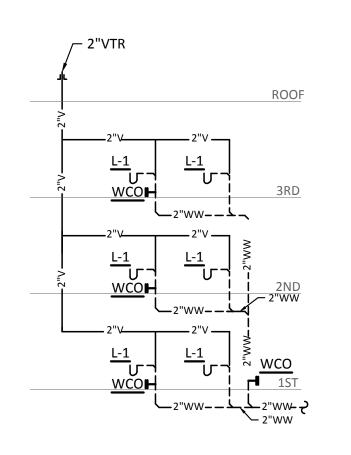

46 SHOWER WASTE & VENT RISER N.T.S. 45 TUB WASTE & VENT RISER N.T.S.

47 WATER CLOSET/LAVATORY WASTE & VENT RISER

48 LAVATORY WASTE & VENT RISER N.T.S.





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ISSUANCES

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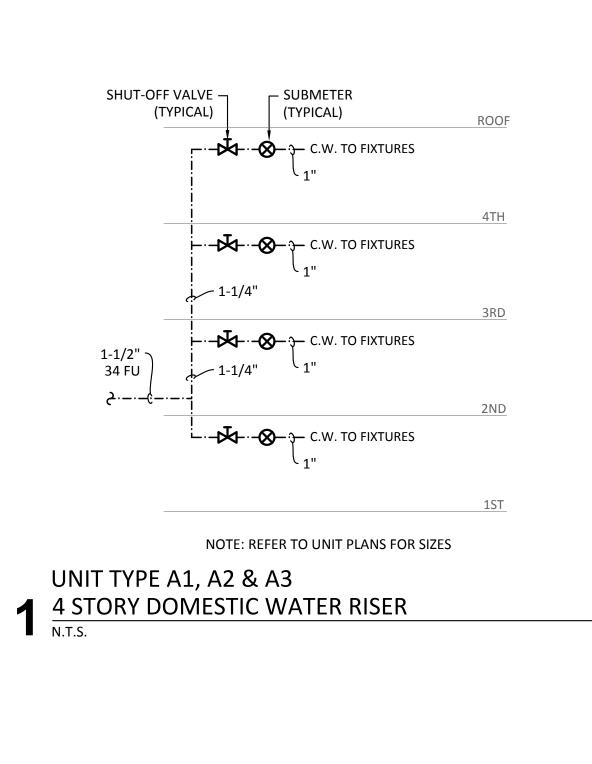
a multifamily project for NRP Group


West Cevallos


San Antonio, Texas


PLUMBING WASTEWATER RISERS

Project Number	18054
Date	01/14/2018
Drawn By	TLR
Checked By	EEC



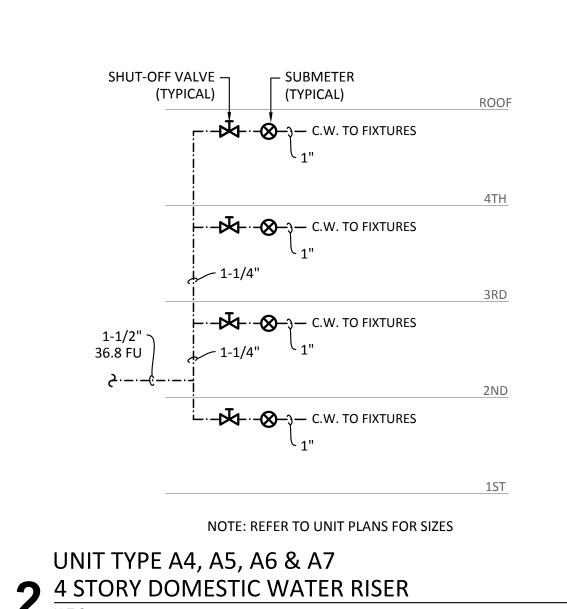


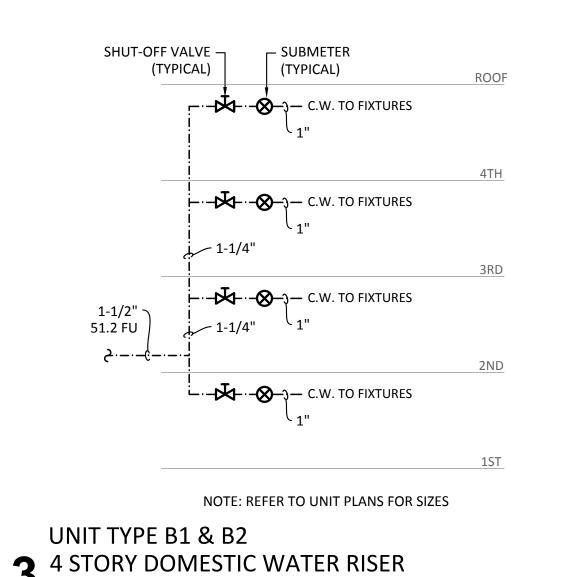


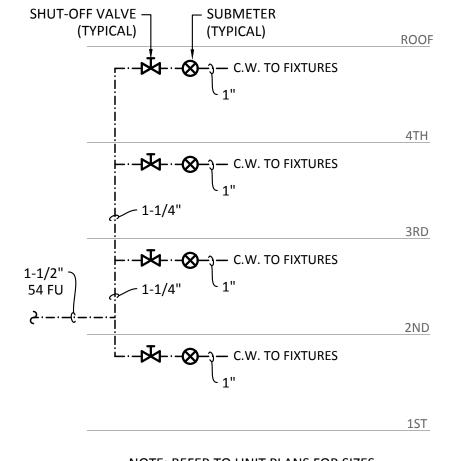



NOTE: REFER TO UNIT PLANS FOR SIZES UNIT TYPE B3, B4, B5, B6 & C1 4 STORY DOMESTIC WATER RISER


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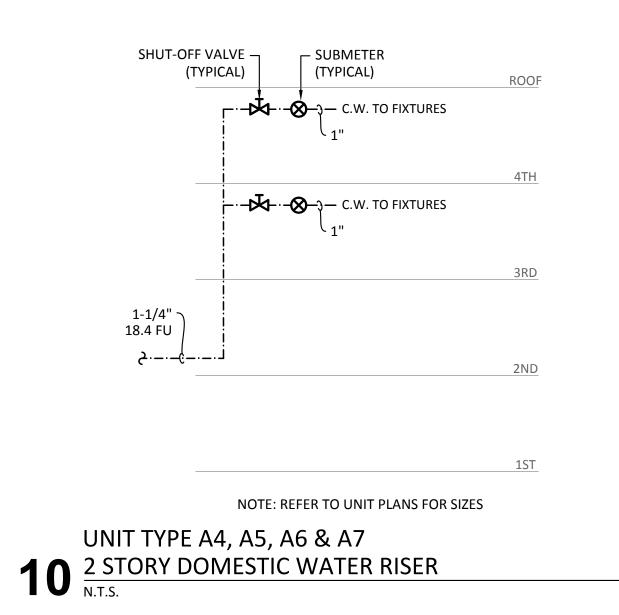


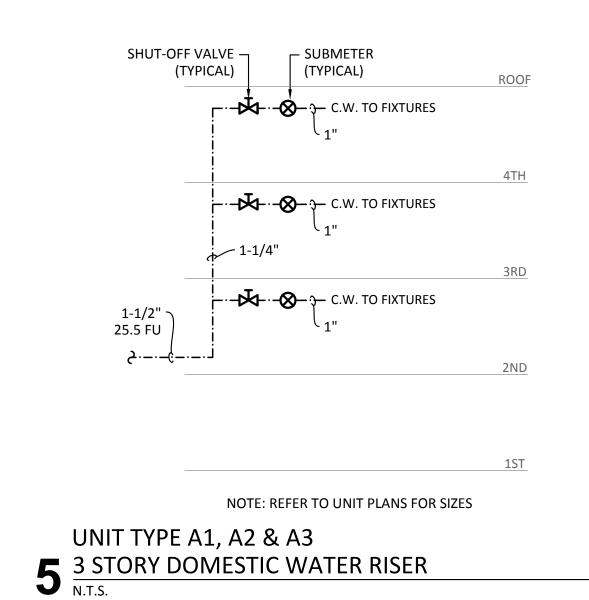


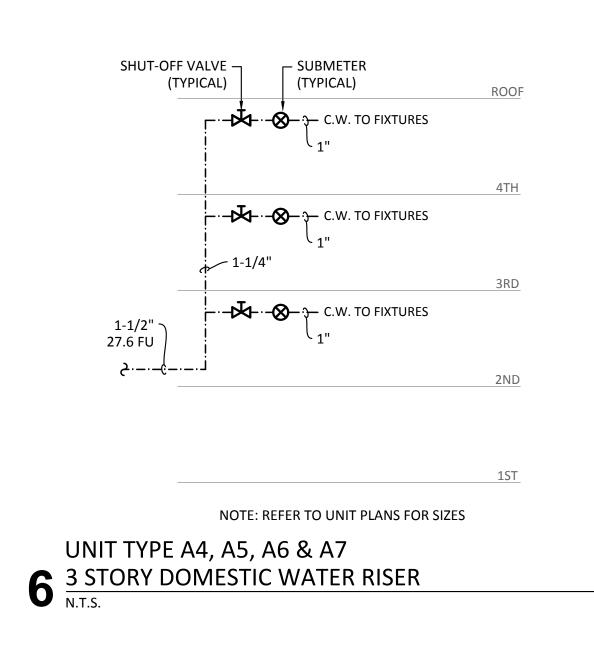


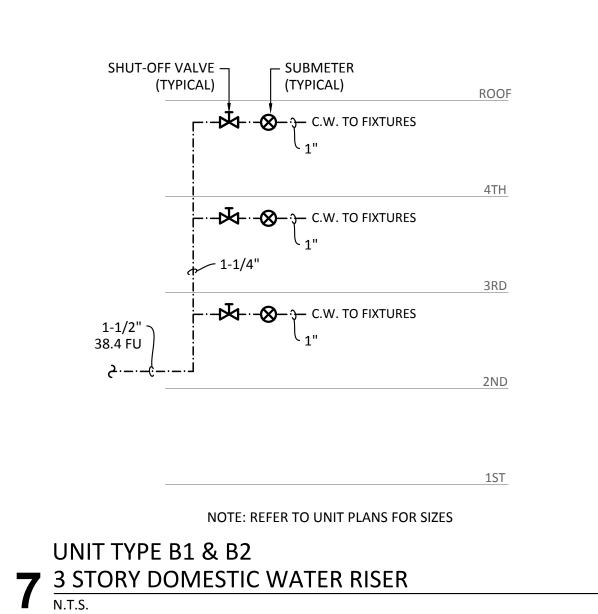
UNIT TYPE A1, A2 & A3

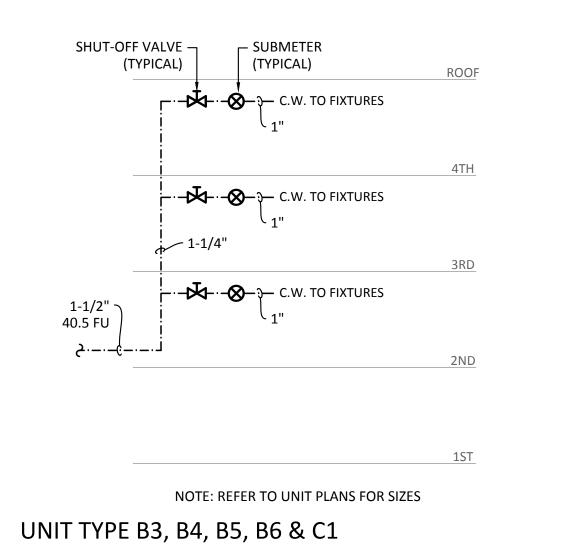9 2 STORY DOMESTIC WATER RISER
N.T.S.

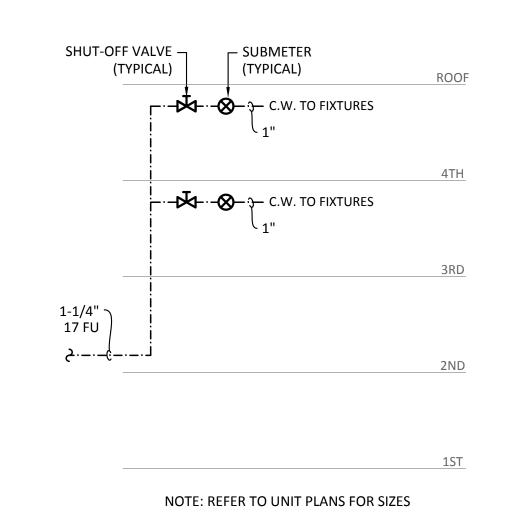

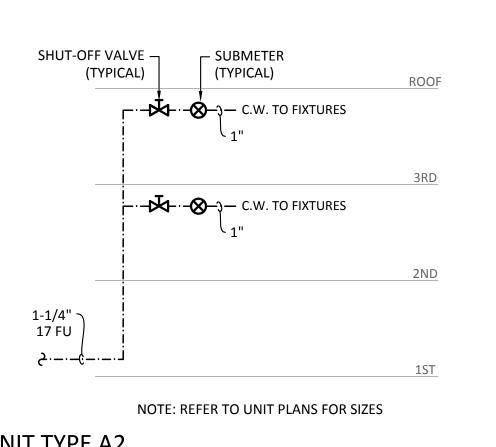

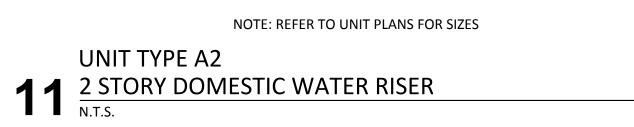

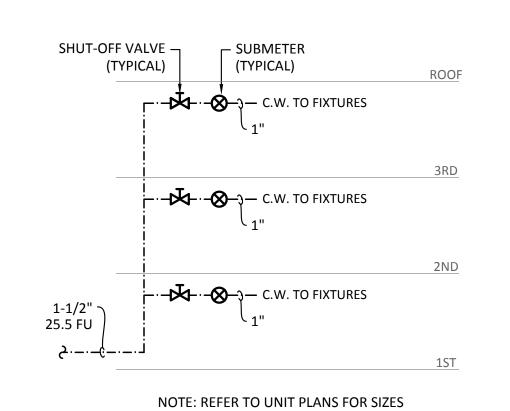

UNIT TYPE A3 12 2 STORY DOMESTIC WATER RISER

N.T.S.

 $8 \frac{3 \text{ STORY DOMESTIC WATER RISER}}{N.T.S.}$





Structural Enginee	er:
VIEWTECH INC.	
4205 Beltway Dr. /	Addison, TX 75001
Victor Lisiak III	
972.661.8187	

MEP Engineer:

ENCOTECH 8500 Bluffstone Cove, Austin, TX. 78759 Tessa Roberts 512.338.1101

Civil Engineer:

MBC & Associates, Inc 1035 Central Pkwy N, San Antonio, TX 78732 David Allen 210.545.1122

Landscape Architect: LEE & Associates, Inc. 9020 N Capital of Texas Hwy, Austin, TX. 78759

Interior Designer:

Amber Rothwell 512.345.8477

SJL Design Group 921 N. Riverfront Blvd. Suite 100, Dallas, TX 75207 Cassie Farley 214.443.9090

ISSUANCES		
01	SCHEMATIC DESIGN	09.10.18
02	DEVELOPMENT DESIGN	11.09.18
03	PERMIT SET	01.28.19

REVISIONS




a multifamily project for NRP Group

West Cevallos

San Antonio, Texas

PLUMBING DOMESTIC WATER RISERS


P60)5
Checked By	EEC
Drawn By	TLR
Date	01/14/2018
Project Number	18054

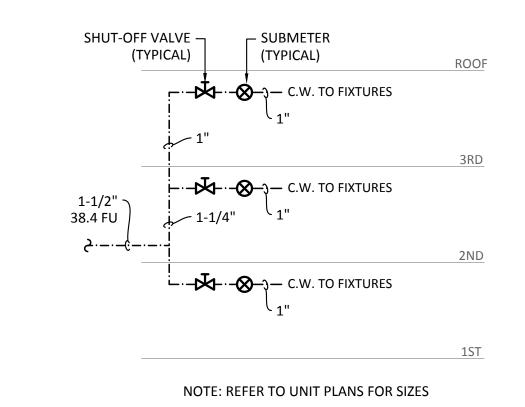

UNIT TYPE B1 & B2

13 STORY DOMESTIC WATER RISER

N.T.S.

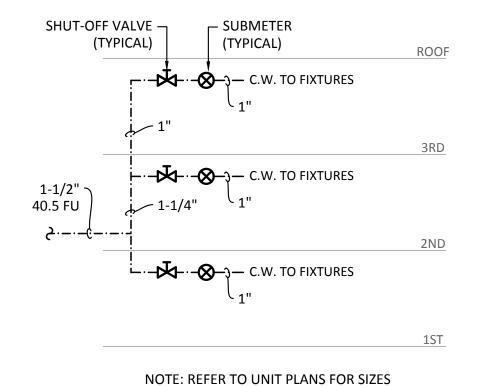

UNIT TYPE B4

3 STORY DOMESTIC WATER RISER

N.T.S.



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REVISIONS



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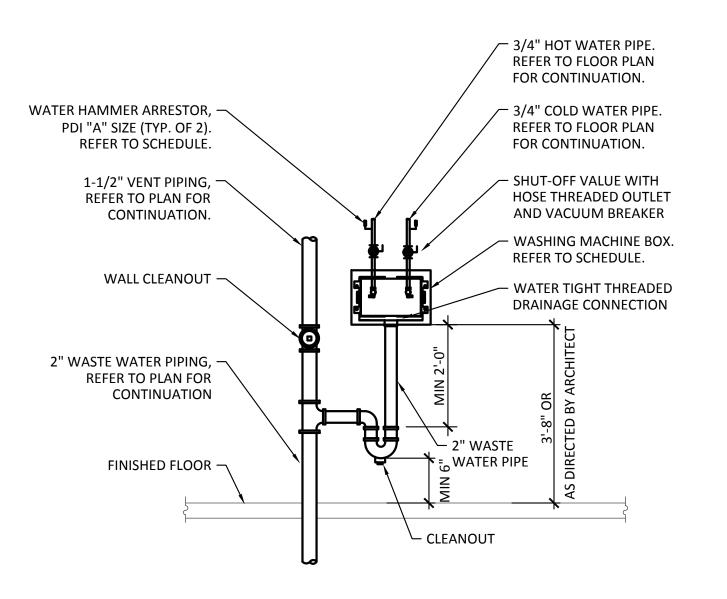
West Cevallos
San Antonio, Texas


PLUMBING DOMESTIC WATER RISERS

Project Number	1805
Date Drawn By	01/14/201 TL
Checked By	EE

P605







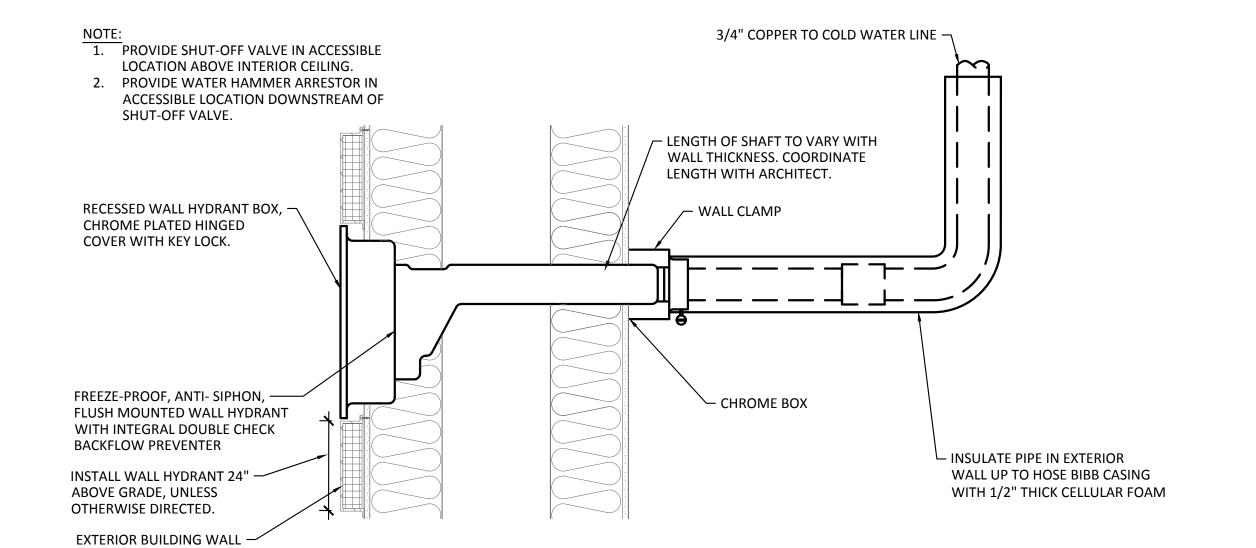


WASHING MACHINE OUTLET BOX
N.T.S.

2 FREEZEPROOF WALL HYDRANT

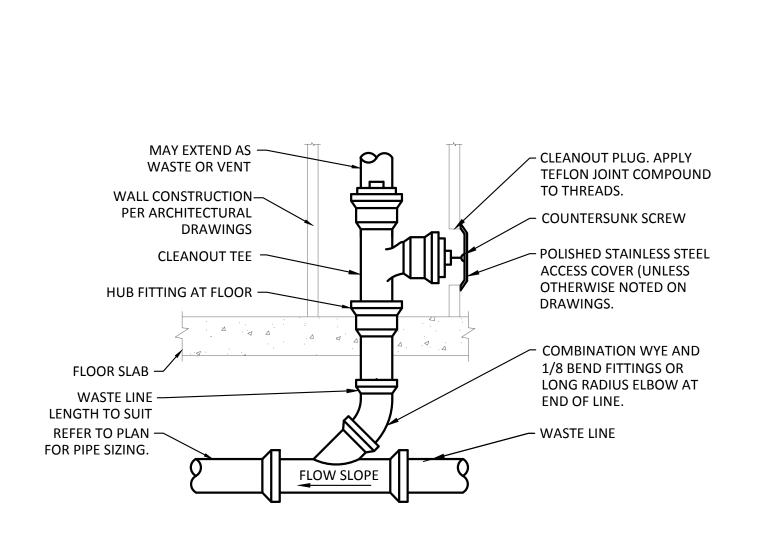

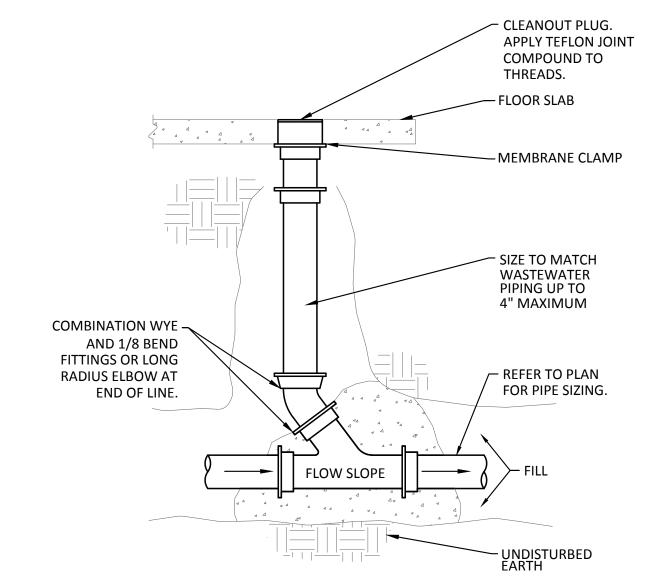


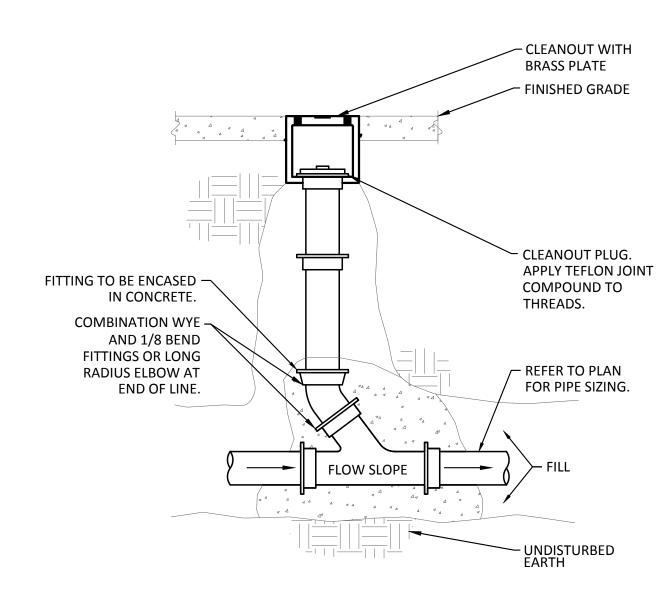


3 WALL CLEAN OUT DETAIL
N.T.S.

4 FLOOR CLEAN OUT DETAIL
N.T.S.

5 EXTERIOR CLEAN OUT N.T.S.

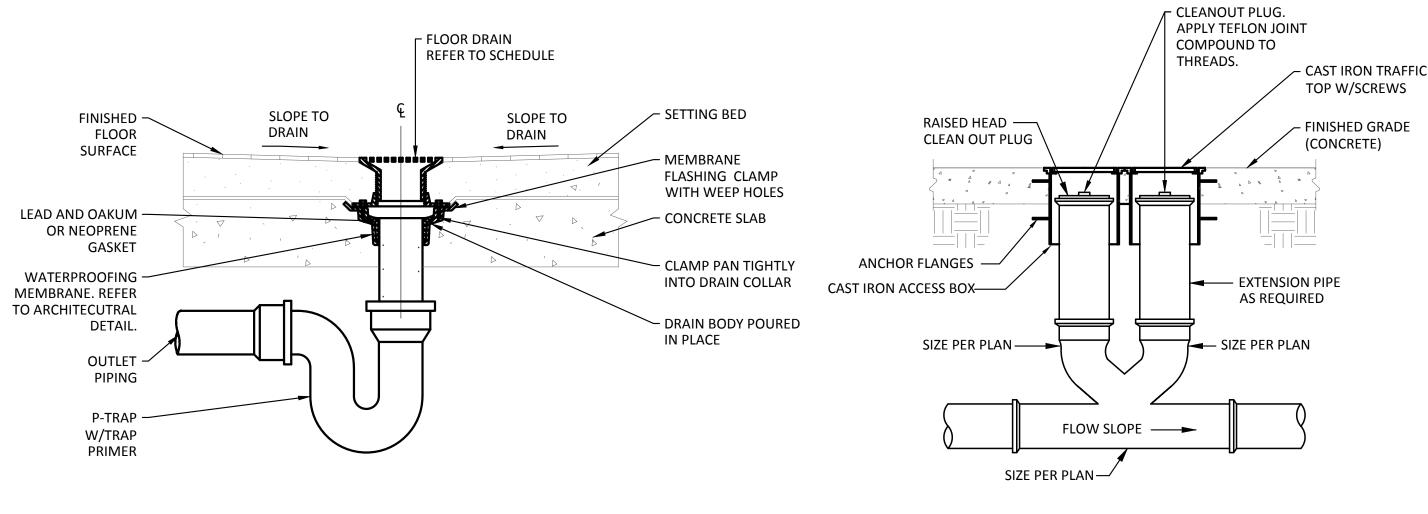

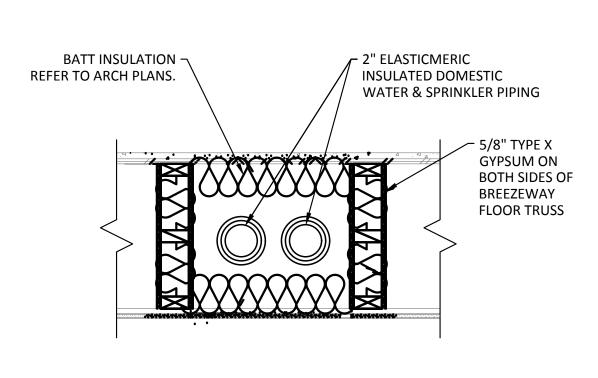

 $6 \frac{\text{FLOOR DRAIN DETAIL}}{\text{N.T.s.}}$

7 DOUBLE CLEAN OUT DETAIL

N.T.S.

8 WATER DISTRIBUTION CHASE @ BREEZEWAY





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ISSUAN

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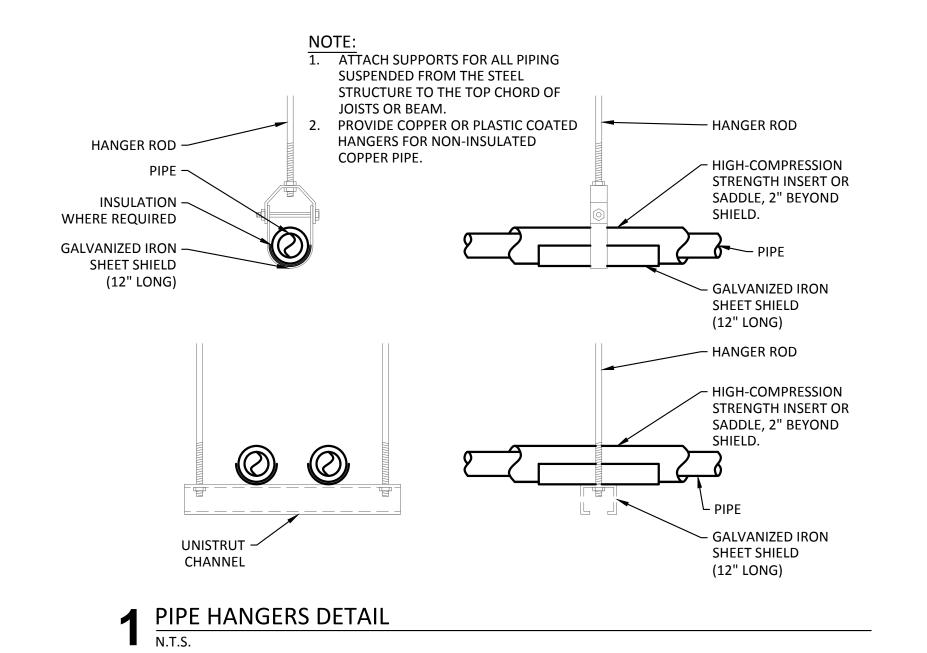
West Cevallos


San Antonio, Texas


PLUMBING DETAILS

Project Number	1805
Date	01/14/201
Drawn By	TL
Checked By	EE


P701




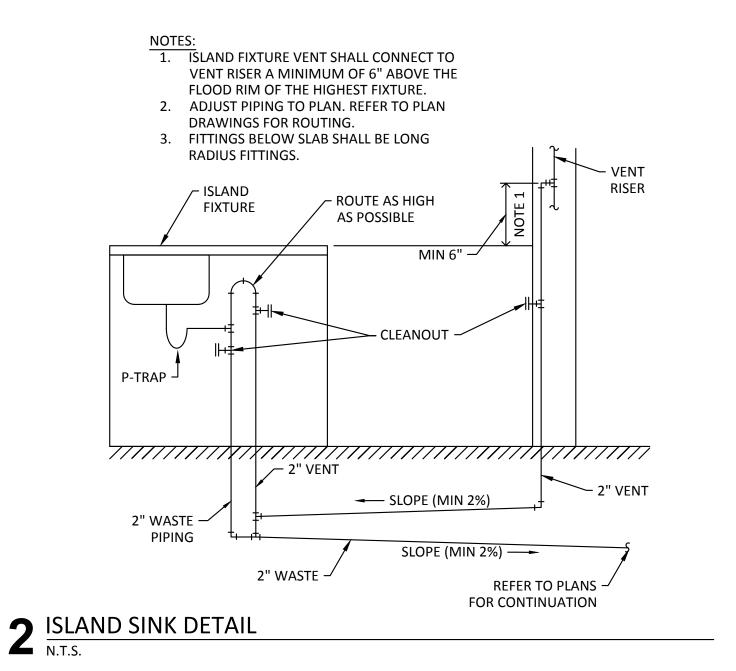


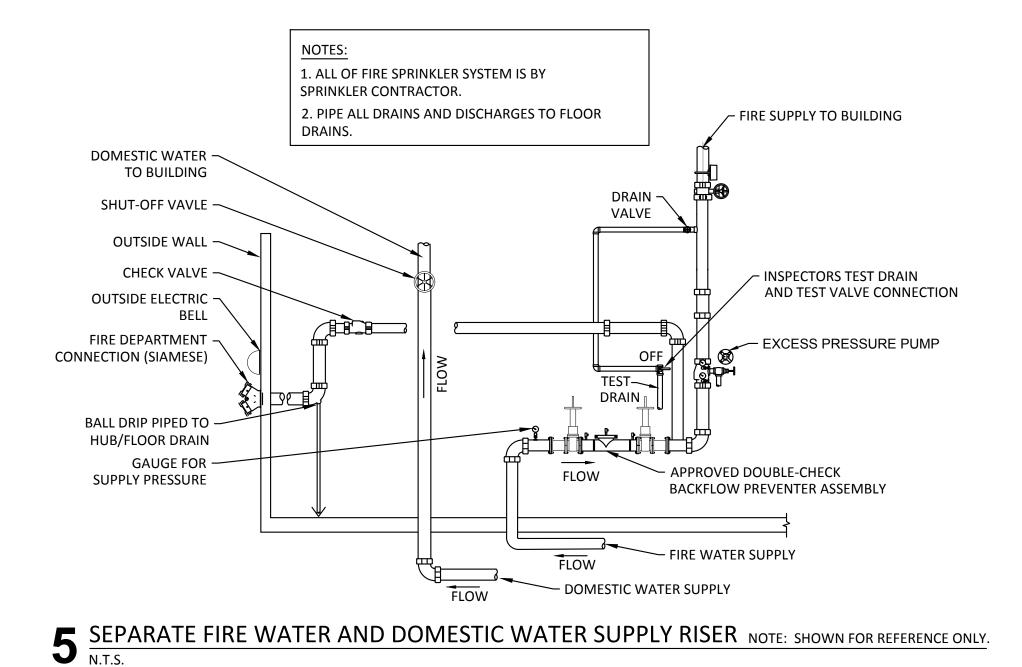


 $6 \frac{\text{FLOOR HUB DRAIN DETAIL}}{\text{N.T.S.}}$

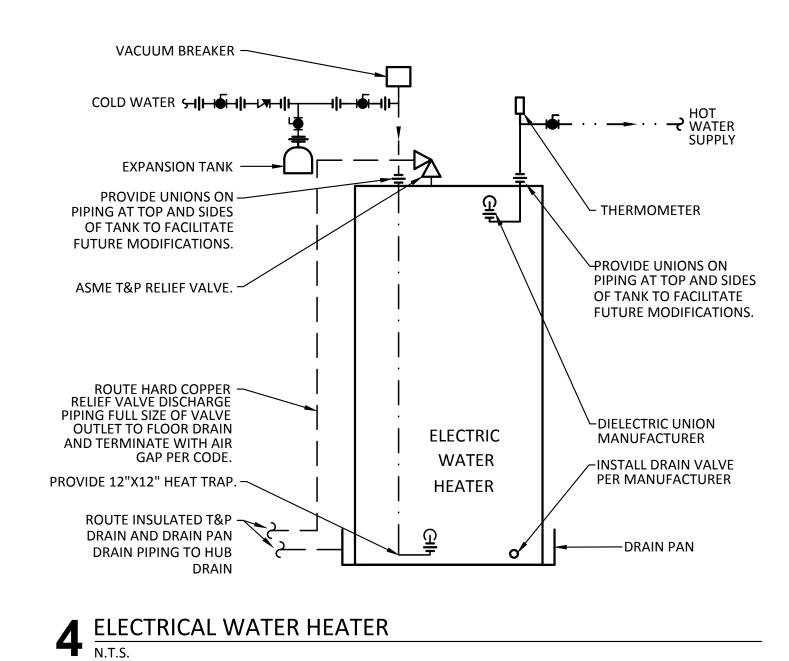

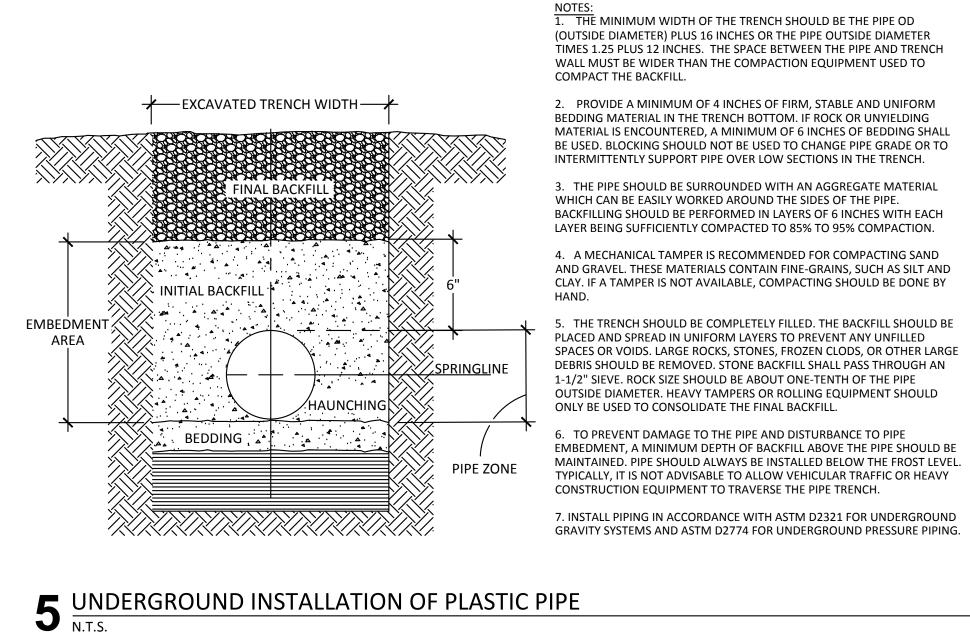

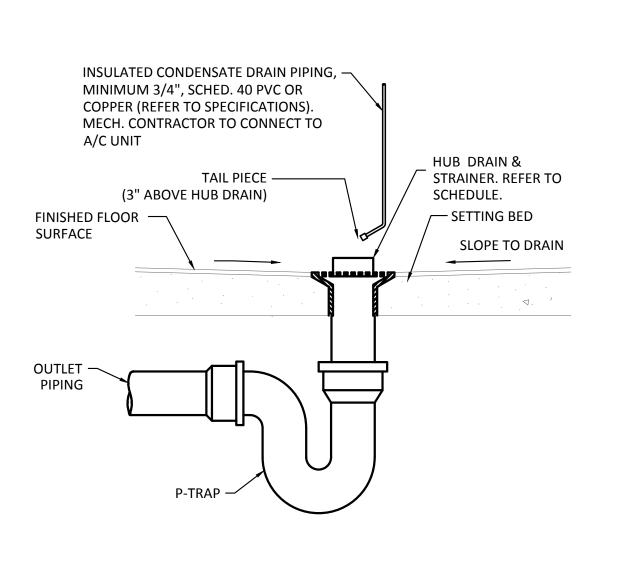

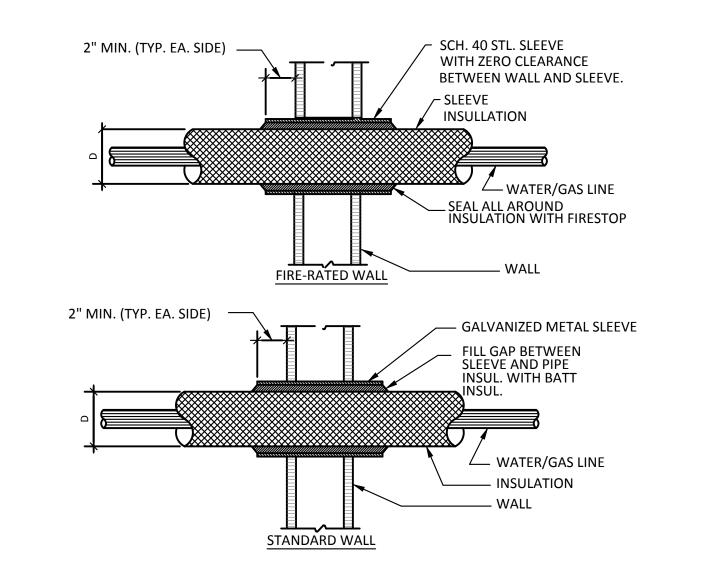

7 TYPICAL PIPE PENETRATION DETAIL
N.T.S.



COLLABORATIVE 3607 S Lamar Blvd, Suite 103 Austin, Texas 78704 512.852.4310

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ISSUANCES

REVISIONS

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02	DEVELOPMENT DESIGN	11.09.18
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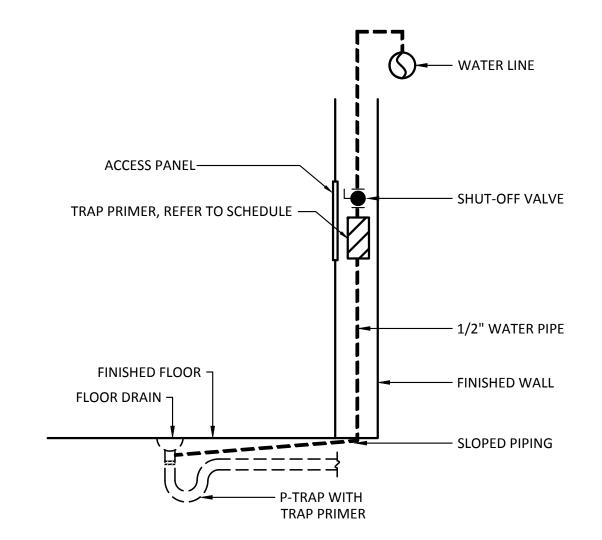
West Cevallos

San Antonio, Texas


PLUMBING DETAILS

Project Number	18054
Date	01/14/2018
Drawn By	TLF
Checked By	EE(


P702



 $\begin{array}{c}
\mathbf{1} \quad \frac{\mathsf{TRAP} \; \mathsf{PRIMER} \; \mathsf{DETAIL}}{\mathsf{N.T.S.}}
\end{array}$

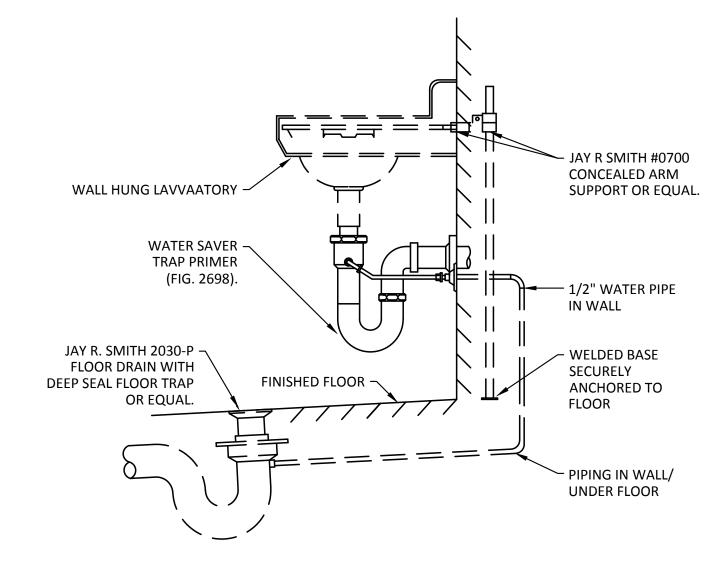

 $2^{\frac{TRAP\ PRIMER\ DETAIL}{N.T.S.}}$

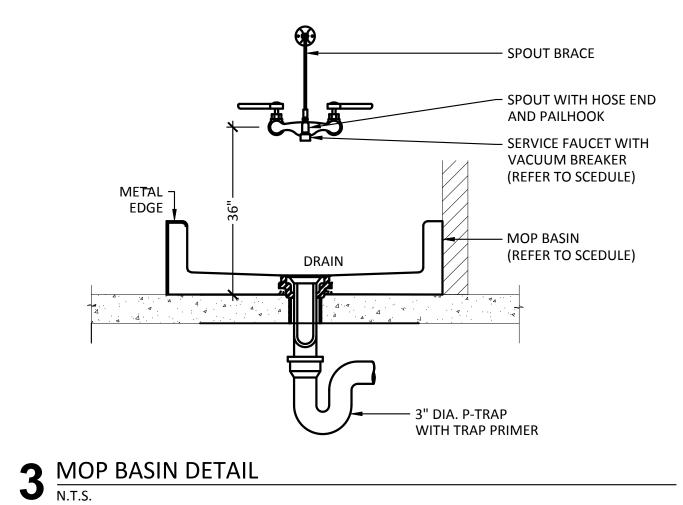


(REFER TO SCHEDULE)

CHROME
QUARTER-TURN
ADAPTER BALL VALVE.
1/2" SWEAT
CONNECTION


WATER HAMMER
ARRESTOR
PDI "A" SIZE
(REFER TO SCHEDULE)

┌ ICE MAKER BOX

4 ICE MAKER VALVE BOX DETAIL
N.T.S.

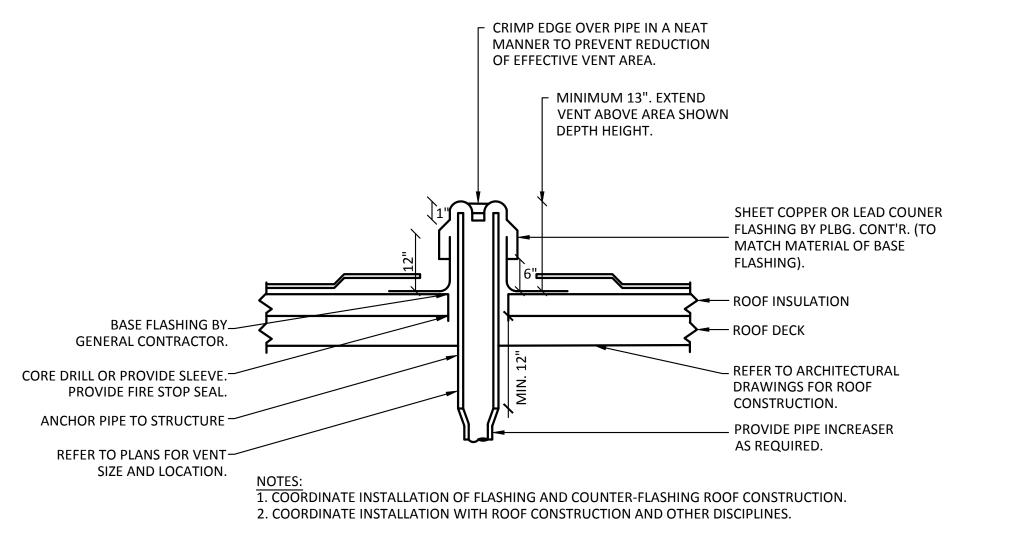

5 PLUMBING VENT THRU ROOF DETAIL N.T.S.

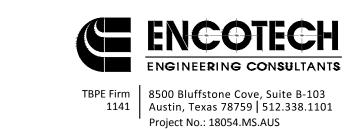



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REVISIONS



a multifamily project for NRP Group

West Cevallos
San Antonio, Texas

PLUMBING DETAILS

Project Number 18054

Date 01/14/2018

Drawn By TLR

Checked By EEC

P703