

HISTORIC AND DESIGN REVIEW COMMISSION

May 01, 2019

HDRC CASE NO: 2019-212
ADDRESS: 5919 W COMMERCE ST
LEGAL DESCRIPTION: NCB 8242 BLK 1 LOT E 607 FT OF BLK 20.00AC
ZONING: R-6
CITY COUNCIL DIST.: 5
APPLICANT: Marc Zac
OWNER: City of San Antonio - Parks/TCI
TYPE OF WORK: Park improvements
APPLICATION RECEIVED: April 12, 2019
60-DAY REVIEW: June 11, 2019
CASE MANAGER: Adam Rajper
REQUEST:

The applicant is requesting a Certificate of Appropriateness for approval to carry out various park improvements.

APPLICABLE CITATIONS:

UDC Sec. 35-641. - Design Considerations for Historic and Design Review Commission Recommendations.

In reviewing an application, the historic and design review commission shall be aware of the importance of attempting to find a way to meet the current needs of the City of San Antonio, lessee or licensee of public property. The historic and design review commission shall also recognize the importance of recommending approval of plans that will be reasonable to implement. The best urban design standards possible can and should be employed with public property including buildings and facilities, parks and open spaces, and the public right-of-way. Design and construction on public property should employ such standards because the use of public monies for design and construction is a public trust. Public commitment to quality design should encourage better design by the private sector. Finally, using such design standards for public property improves the identity and the quality of life of the surrounding neighborhoods.

UDC Sec 35-642. – New Construction of Buildings and Facilities:

In considering whether to recommend approval or disapproval of a certificate, the historic and design review commission shall be guided by the following design considerations. These are not intended to restrict imagination, innovation or variety, but rather to assist in focusing on design principles, which can result in creative solutions that will enhance the city and its neighborhoods. Good and original design solutions that meet the individual requirements of a specific site or neighborhood are encouraged and welcomed.

(a) Site and Setting.

(1) Building sites should be planned to take into consideration existing natural climatic and topographical features. The intrusive leveling of the site should be avoided. Climatic factors such as sun, wind, and temperature should become an integral part of the design to encourage design of site-specific facilities which reinforces the individual identity of a neighborhood and promotes energy efficient facilities.

(2) Special consideration should be given to maintain existing urban design characteristics, such as setbacks, building heights, streetscapes, pedestrian movement, and traffic flow. Building placement should enhance or create focal points and views. Continuity of scale and orientation shall be emphasized.

(3) Accessibility from streets should be designed to accommodate safe pedestrian movement as well as vehicular traffic. Where possible, parking areas should be screened from view from the public right-of-way by attractive fences, berms, plantings or other means.

(4) Historically significant aspects of the site shall be identified and if possible incorporated into the site design. Historic relationships between buildings, such as plazas or open spaces, boulevards or axial relationships should be maintained.

(b) Building Design.

(1) Buildings for the public should maintain the highest quality standards of design integrity. They should elicit a pride of ownership for all citizens. Public buildings should reflect the unique and diverse character of San Antonio and should be responsive to the time and place in which they were constructed.

(2) Buildings shall be in scale with their adjoining surroundings and shall be in harmonious conformance to the identifying quality and characteristics of the neighborhood. They shall be compatible in design, style and materials. Reproductions of styles and designs from a different time period are not encouraged, consistent with

the secretary of the interior's standards. Major horizontal and vertical elements in adjoining sites should be respected.

(3) Materials shall be suitable to the type of building and design in which they are used. They shall be durable and easily maintained. Materials and designs at pedestrian level shall be at human scale, that is they shall be designed to be understood and appreciated by someone on foot. Materials should be selected that respect the historic character of the surrounding area in texture, size and color.

(4) Building components such as doors, windows, overhangs, awnings, roof shapes and decorative elements shall all be designed to contribute to the proportions and scale of their surrounding context. Established mass/void relationships shall be maintained. Patterns and rhythms in the streetscape shall be continued.

(5) Colors shall be harmonious with the surrounding environment, but should not be dull. Choice of color should reflect the local and regional character. Nearby historic colors shall be respected.

(6) Mechanical equipment or other utility hardware should be screened from public view with materials compatible with the building design. Where possible, rooftop mechanical equipment should be screened, even from above. Where feasible, overhead utilities should also be underground or attractively screened. Exterior lighting shall be an integral part of the design. Interior lighting shall be controlled so that the spillover lighting onto public walkways is not annoying to pedestrians.

(7) Signs which are out of keeping with the character of the environment in question should not be used. Excessive size and inappropriate placement on buildings results in visual clutter. Signs should be designed to relate harmoniously to exterior building materials and colors. Signs should express a simple clear message with wording kept to a minimum.

(8) Auxiliary design. The site should take into account the compatibility of landscaping, parking facilities, utility and service areas, walkways and appurtenances. These should be designed with the overall environment in mind and should be in visual keeping with related buildings, structures and places.

FINDINGS:

- a. The property located at 5919 W Commerce is a public park with the common name of Monterrey Park and is situated northwest of Downtown. The applicant is requesting approval for various park improvements.
- b. PARK IMPROVEMENTS – The applicant has proposed various park improvements. This will include the resurfacing of the existing basketball court and addition of new playground equipment, addition a shade canopy over the existing basketball courting, improving the parking lot, replacement of the pool shade structure with two cantilevered canvas shade structures (this will require modifications to the existing fence and benches), and upgrading of site lighting. Staff finds the proposal consistent with the UDC.
- c. ARCHAEOLOGY – The project shall comply with all federal, state, and local laws, rules, and regulations regarding archaeology.

RECOMMENDATION:

Staff recommends approval based on findings a through c with the following stipulation:


- i. ARCHAEOLOGY – The project shall comply with all federal, state, and local laws, rules, and regulations regarding archaeology.

5919 W Commerce



April 22, 2019

— User drawn lines

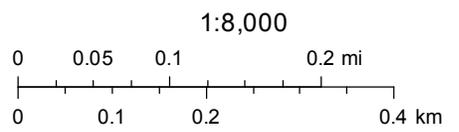

CoSA





April 12, 2019

City of San Antonio
Office of Historic Preservation
1901 South Alamo
San Antonio, Texas 78204

To whom it may concern:

The following is a detailed description of the improvements proposed for Monterrey Park to be considered appropriate by the Office of Historic Preservation.

1. Resurface the existing basketball court and provide new goals.
2. Add a shade canopy over the existing basketball court with lighting.
3. Improve the existing ADA parking spaces adjacent to the community center.
4. Remove existing shade structure at pool and replace with two cantilevered canvas shade structures. This includes modifications to the existing fence and benches.
5. Replace existing lighting around the ballfields with new poles and LED fixtures.

Please let us know if you have any questions or comments regarding the proposed improvements at Monterrey Park.

Respectfully,

A handwritten signature in blue ink, appearing to read 'Marc R. Zak', written over a light blue horizontal line.

Marc R. Zak, PLA





Shuffleboard
RULES


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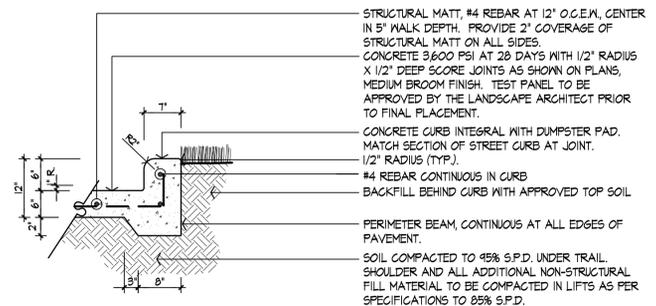




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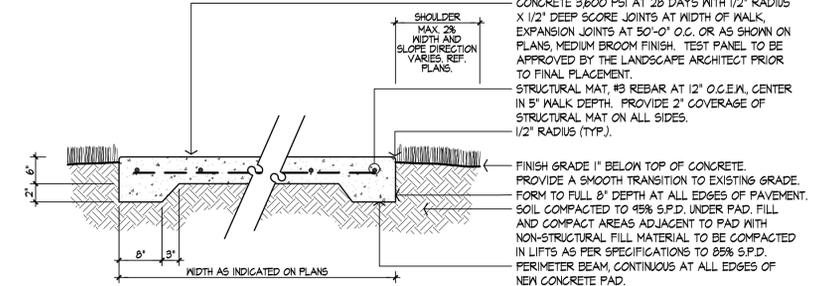


1 PLAN: ACCESSIBLE PARKING REPAIR & DUMPSTER LOCATION
 Scale: 1/8" = 1'-0"

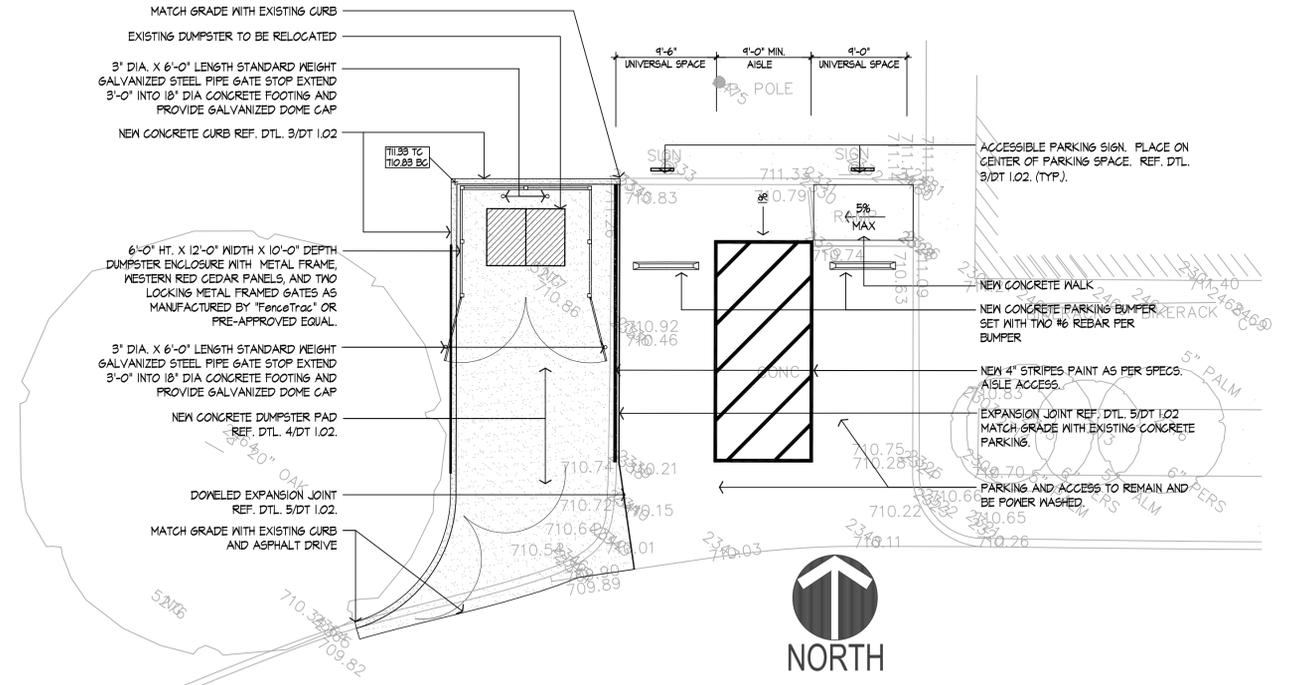


3 SECTION: DUMPSTER PAD CURB
 Scale: 3/4" = 1'-0"


NOTES:
 1. ACCEPTABLE MATERIAL FOR FORMS: 2" NOMINAL THICKNESS LUMBER, 1" NOMINAL THICKNESS LUMBER, 3/4" THICKNESS EXTERIOR PLYWOOD OR STEEL FORMS. KERF 2" LUMBER TO FORM SMOOTH CURVES. 1" LUMBER AND 3/4" PLYWOOD MAY NOT NEED TO BE KERFED.
 2. MATERIALS NOT ACCEPTED FOR FORMS: MASONITE, PARTICLE BOARD, CHIP BOARD, OR "HARDI" TYPE MATERIAL.
 3. WHERE NEW CONCRETE PAD ABUTS EXISTING ASPHALT SAW CUT A CLEAN STRAIGHT EDGE IN THE ASPHALT AND EXCAVATE AS REQUIRED TO ACCOMMODATE NEW CONCRETE PAD.
 4. WHERE NEW CONCRETE PAD ABUTS EXISTING CONCRETE SEE DETAIL 5/DT1.02



4 SECTION: CONCRETE DUMPSTER PAD
 Scale: 3/4" = 1'-0"

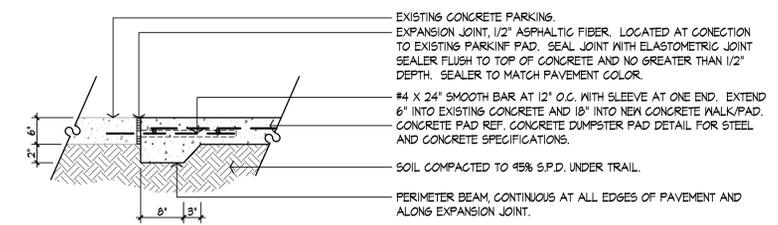


5 SECTION: EXPANSION JOINT DUMPSTER PAD
 Scale: 3/4" = 1'-0"

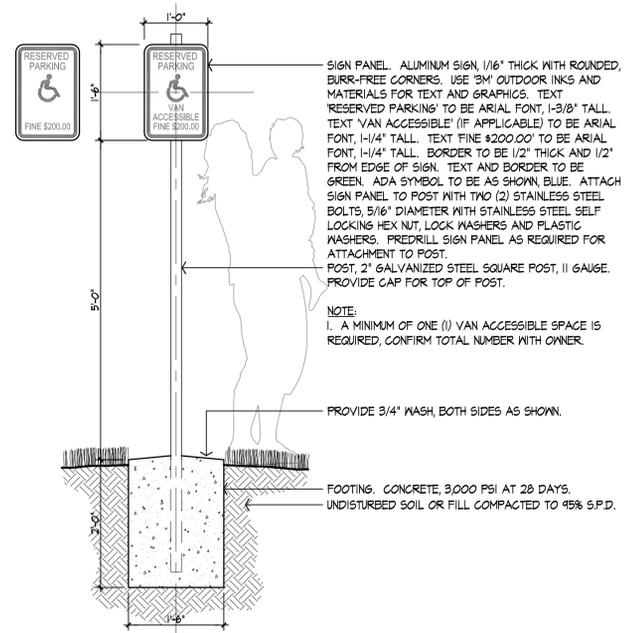

2 ELEVATION: ACCESSIBLE PARKING SIGN
 Scale: 3/4" = 1'-0"

SIGN PANEL: ALUMINUM SIGN, 1/16" THICK WITH ROUNDED, BURR-FREE CORNERS. USE 3M OUTDOOR INKS AND MATERIALS FOR TEXT AND GRAPHICS. TEXT 'RESERVED PARKING' TO BE ARIAL FONT, 1-3/8" TALL. TEXT 'VAN ACCESSIBLE' (IF APPLICABLE) TO BE ARIAL FONT, 1-1/4" TALL. TEXT 'FINE \$200.00' TO BE ARIAL FONT, 1-1/4" TALL. BORDER TO BE 1/2" THICK AND 1/2" FROM EDGE OF SIGN. TEXT AND BORDER TO BE GREEN. ADA SYMBOL TO BE AS SHOWN, BLUE. ATTACH SIGN PANEL TO POST WITH TWO (2) STAINLESS STEEL BOLTS, 5/16" DIAMETER WITH STAINLESS STEEL SELF LOCKING HEX NUT, LOCK WASHERS AND PLASTIC WASHERS. PREDRILL SIGN PANEL AS REQUIRED FOR ATTACHMENT TO POST. POST, 2" GALVANIZED STEEL SQUARE POST, 11 GAUGE. PROVIDE GAP FOR TOP OF POST.
 NOTE:
 1. A MINIMUM OF ONE (1) VAN ACCESSIBLE SPACE IS REQUIRED, CONFIRM TOTAL NUMBER WITH OWNER.

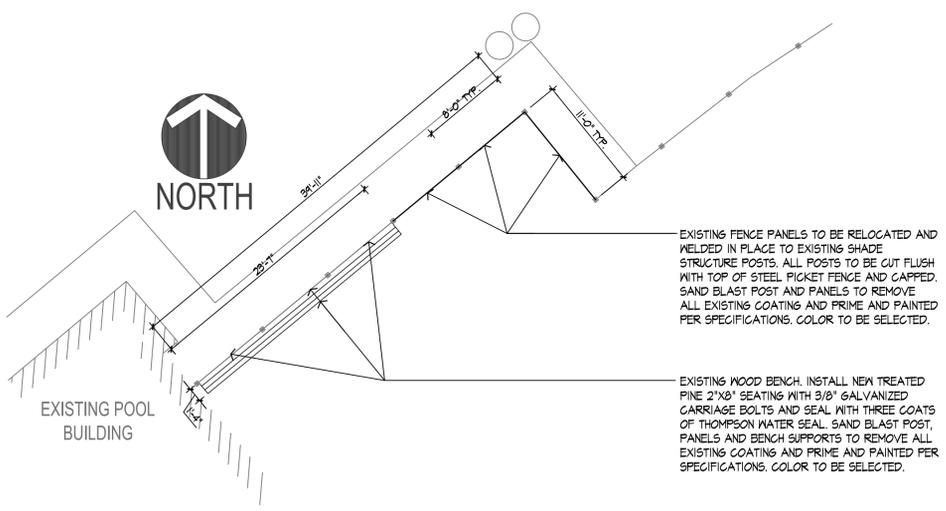

6 PLAN: FENCE AND BENCH MODIFICATIONS
 Scale: 1/8" = 1'-0"

MONTERREY PARK

5919 W. Commerce
 San Antonio, Texas 78237

REVISION	DATE

Project no: 23-01682
 Date: MARCH 29, 2019
 Sheet:


DETAIL SHEETS

DT 1.02


CONSTRUCTION PLANS

Date: Apr 16, 2019, 10:52am User: hward
 Drawn: FFB P. LCN of San Antonio, Monterrey Park (L26) (S26) (Library Park Detail Sheet.dwg)
 Last Saved By: hward Apr 16, 2019, 10:14am
 Layout Name: DT 1.02

LIGHT FIXTURE SCHEDULE									
TYPE	MANUF.	CATALOG No.	MOUNTING	LAMPS		VOLTAGE	INPUT W	REMARKS	NOTES
				#	TYPE				
A	LITHONIA	DSX1 LED P5 40K T4M 480 DF	POLE	-	LED	480	138	LED POLE LIGHT. COORDINATE FINISH WITH ARCHITECT.	-
C	LITHONIA	DSX1 LED P3 40K T4M 480 DF	POLE	-	LED	480	102	LED POLE LIGHT. COORDINATE FINISH WITH ARCHITECT.	-
D	LITHONIA	DSX1 LED P3 40K T4M 277 SF	POLE	-	LED	277	102	LED POLE LIGHT. COORDINATE FINISH WITH ARCHITECT.	-
F	LITHONIA	DSXF1 LED P2 40K WFL MVOLT THK VG	SURFACE	-	LED	120/277	42	ADJUSTABLE LED FLOODLIGHT. COORDINATE FINISH WITH ARCHITECT.	-

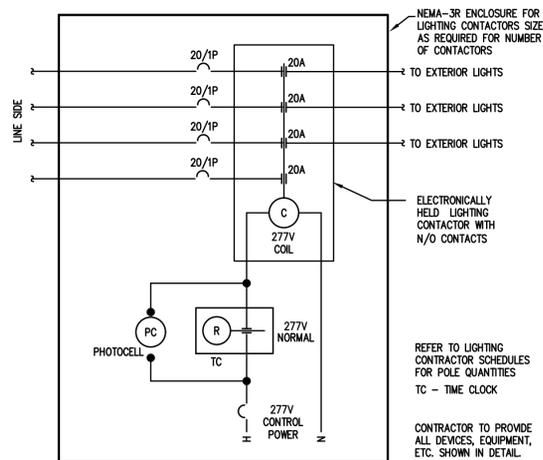

1 EXTERIOR LIGHTING CONTACTOR DETAIL
NTS

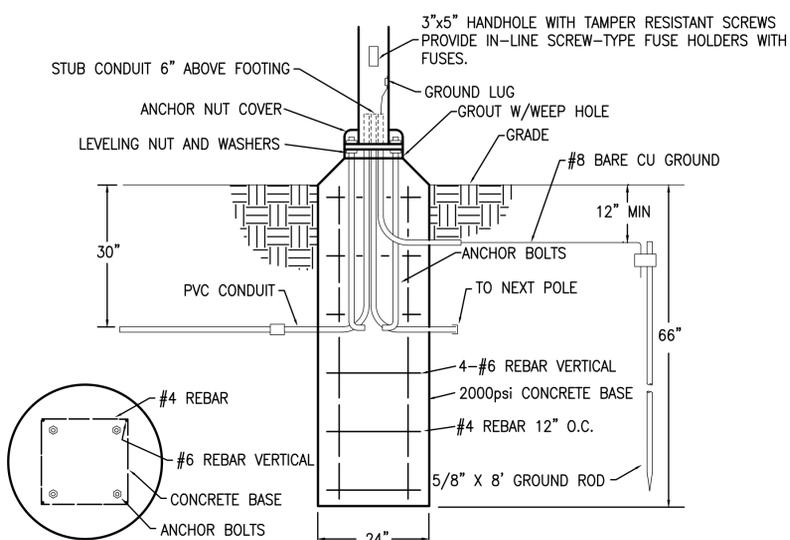

2 POLE BASE DETAIL - PEDESTRIAN
NTS



1 MEP SITE PLAN
1/64" = 1'-0"

ELECTRICAL KEYED NOTES:

- 1 NEW LED LIGHT FIXTURE "A" TO REPLACE EXISTING POLE LIGHT FIXTURE. EXISTING POLE TO REMAIN.
- 2 NEW LED LIGHT FIXTURE "C" TO REPLACE EXISTING POLE LIGHT FIXTURE. EXISTING POLE TO REMAIN.
- 3 NEW LED LIGHT FIXTURE "D" MOUNTED ON NEW POLE. PROVIDE 20' SQUARE ALUMINUM POLE.
- 4 NEW LED LIGHT FIXTURE "F" MOUNTED TO NEW BASKETBALL COURT SHADE STRUCTURE FRAME.
- 5 CONNECT TO EXISTING PANEL USING (2) #12 AND (1) #12 GND IN 1/2" CONDUIT. PROVIDE 20A/1P CIRCUIT BREAKER IN EXISTING 480/277V LIGHTING PANEL. ROUTE THROUGH NEW EXTERIOR PHOTOCELL/TIME CLOCK/CONTACTOR.
- 6 APPROXIMATE LOCATION OF EXISTING PANEL RACK. PROVIDE NEW EXTERIOR LIGHTING CONTACTOR ADJACENT TO EXISTING PANEL. THE CONTACTOR SHALL BE A 2 POLE FOR CONTROL OF EXTERIOR LIGHTING AS NOTED. PROVIDE 277V FROM EXISTING PANEL SPARE 20A/1P C.B.
- 7 PROPOSED UNDERGROUND ROUTE TO EXISTING PANEL.



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MONTERREY PARK

5919 W. COMMERCE
SAN ANTONIO, TEXAS 78232



HMB
ENGINEERING
CONSULTANTS

2902 NORTH FLORES
SAN ANTONIO, TEXAS 78212
210.393.1840 PHONE
SAN ANTONIO - RGV
TBPE FIRM REGISTRATION NO. 13361

REVISION DATE


Project no: 23-01682
Date: APRIL 2, 2019
Sheet:

MEP SITE PLAN


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CONSTRUCTION PLANS


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				#	TYPE				
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C	LITHONIA	DSX1 LED P3 40K T4M 480 DF	POLE	-	LED	480	102	LED POLE LIGHT. COORDINATE FINISH WITH ARCHITECT.	-
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1 EXTERIOR LIGHTING CONTACTOR DETAIL
NTS

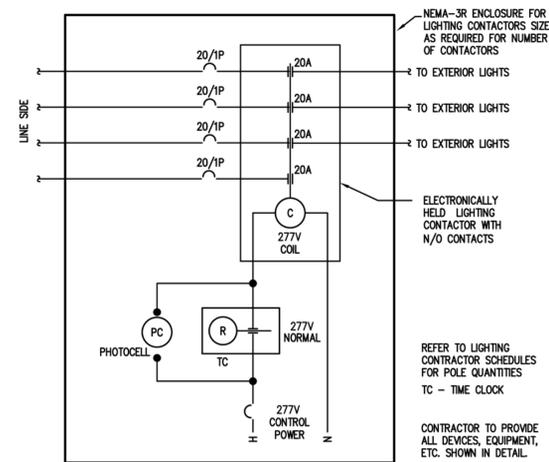

2 POLE BASE DETAIL - PEDESTRIAN
NTS SD265600-02

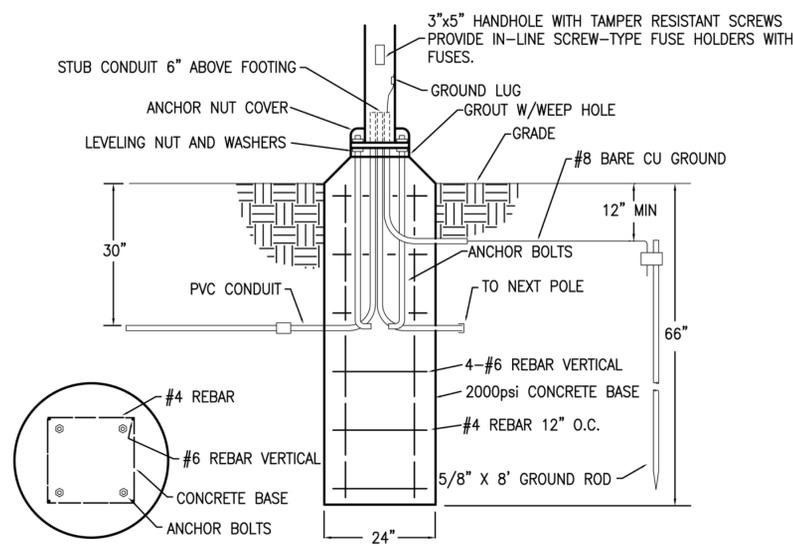

1 ALTERNATE - MEP SITE PLAN
1/64" = 1'-0"
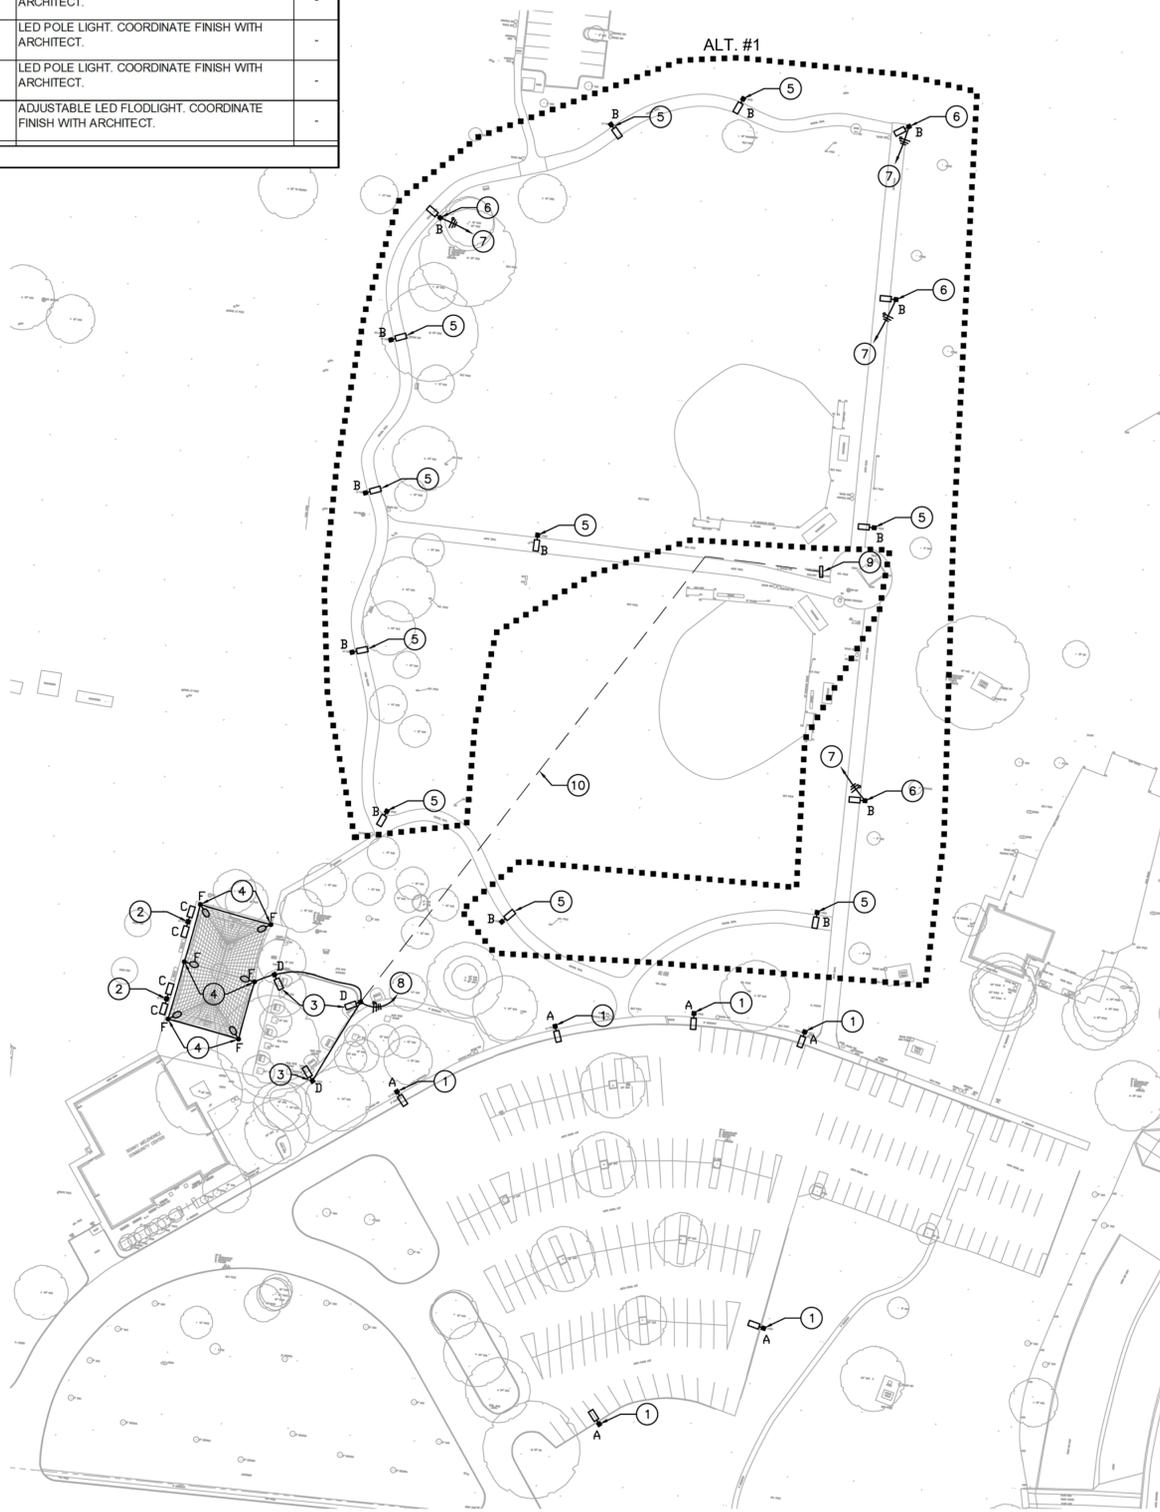
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- 5 NEW LED LIGHT FIXTURE "B" TO REPLACE EXISTING POLE LIGHT FIXTURE. EXISTING POLE TO REMAIN.
- 6 NEW LED LIGHT FIXTURE "B" MOUNTED ON NEW POLE. PROVIDE 20' SQUARE ALUMINUM POLE.
- 7 INTERCEPT, SPLICE, AND EXTEND EXISTING TRAIL LIGHTING CIRCUIT TO NEW POLE LIGHT AS SHOWN ON PLAN. MATCH EXISTING BRANCH CIRCUIT SIZE AND MATERIALS.
- 8 CONNECT TO EXISTING PANEL USING (2) #12 AND (1) #12 GND IN 1/2" CONDUIT. PROVIDE 20A/1P CIRCUIT BREAKER IN EXISTING 480/277V LIGHTING PANEL. ROUTE THROUGH NEW EXTERIOR PHOTOCELL/TIME CLOCK/CONTACTOR.
- 9 APPROXIMATE LOCATION OF EXISTING PANEL RACK. PROVIDE NEW EXTERIOR LIGHTING CONTACTOR ADJACENT TO EXISTING PANEL. THE CONTACTOR SHALL BE A 2 POLE FOR CONTROL OF EXTERIOR LIGHTING AS NOTED. PROVIDE 277V FROM EXISTING PANEL SPARE 20A/1P C.B.
- 10 PROPOSED UNDERGROUND ROUTE TO EXISTING PANEL.



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MONTERREY PARK

5919 W. COMMERCE
SAN ANTONIO, TEXAS 78232

REVISION DATE

Project no: 23-01682
Date: APRIL 2, 2019
Sheet:



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CONSULTANTS



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SAN ANTONIO, TEXAS 78212
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TPE FIRM REGISTRATION NO. 13361

ALTERNATE
MEP SITE PLAN

MEP1.1

CONSTRUCTION PLANS

NOTES:
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 -FINAL FOOTING TYPE AND SIZE WILL BE DETERMINED AT ENGINEERING PHASE.

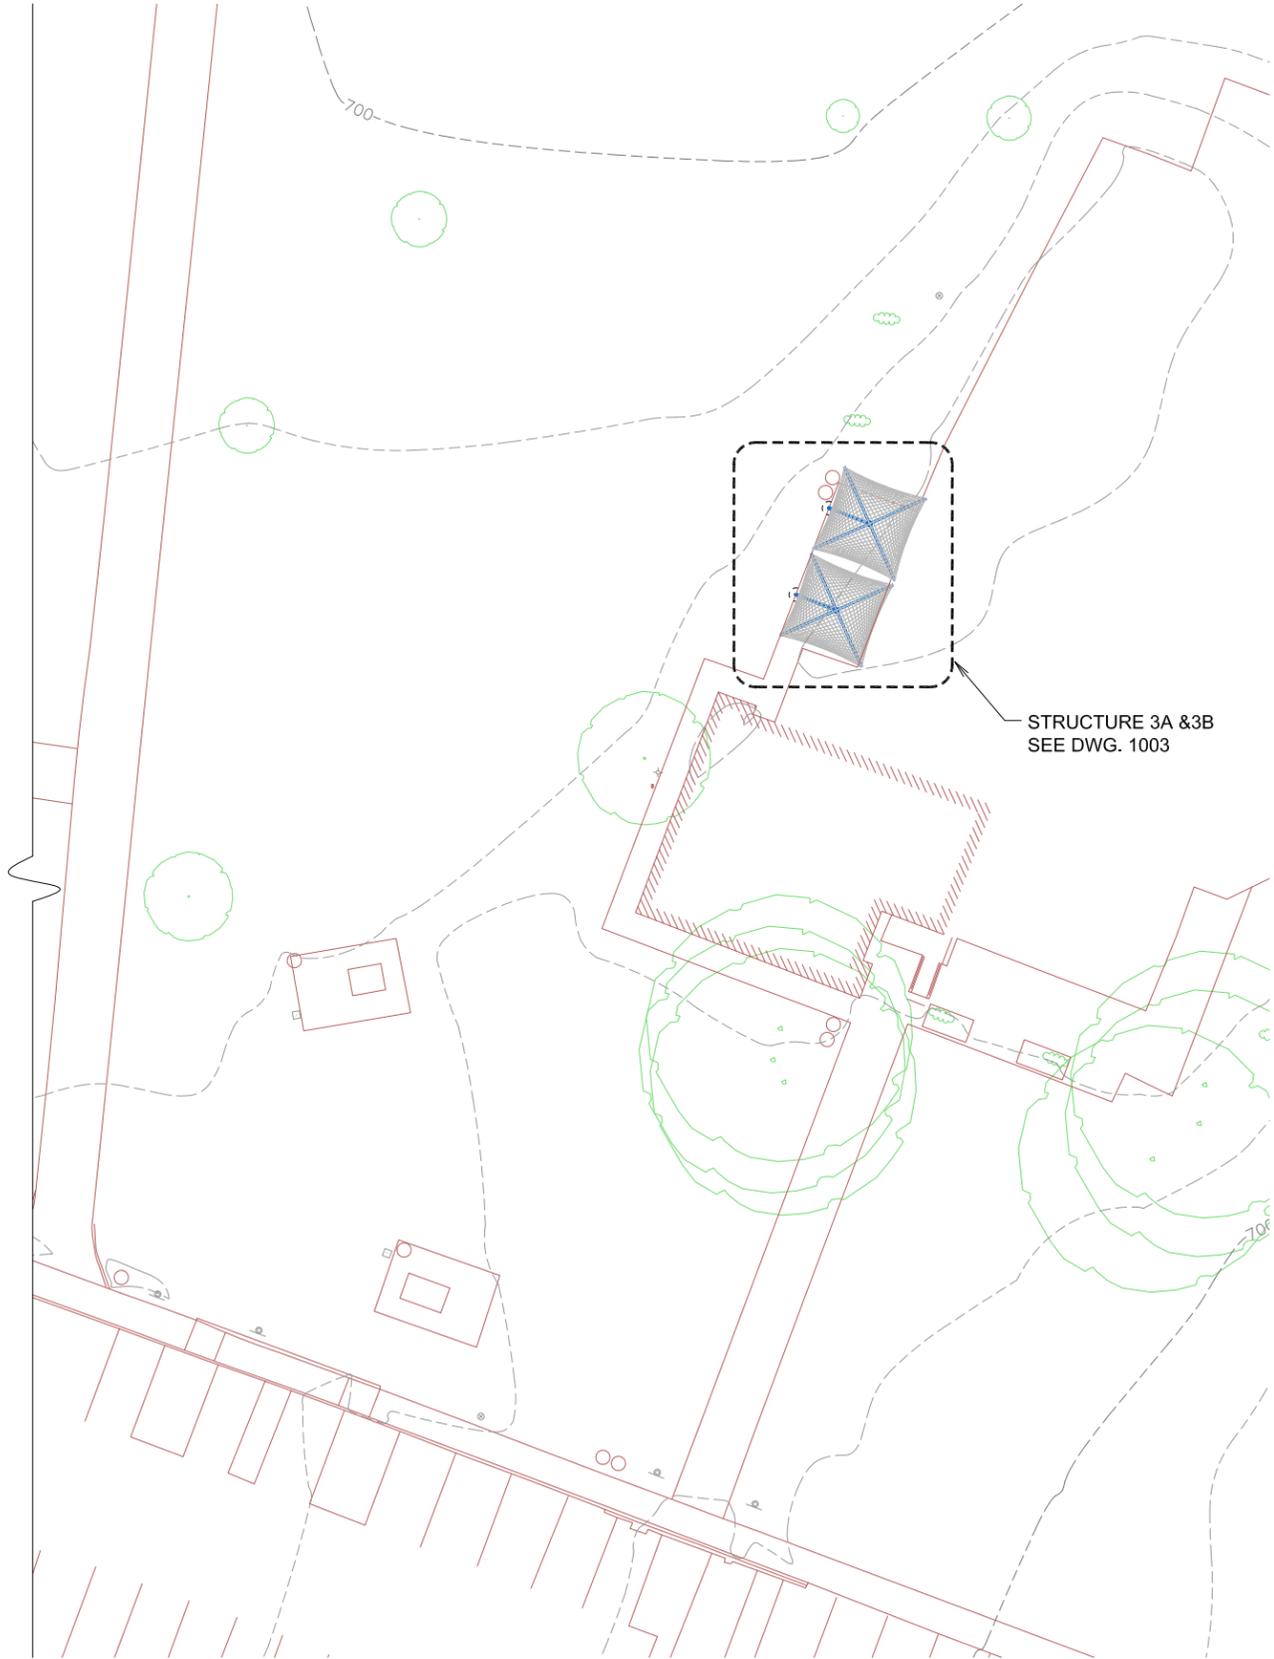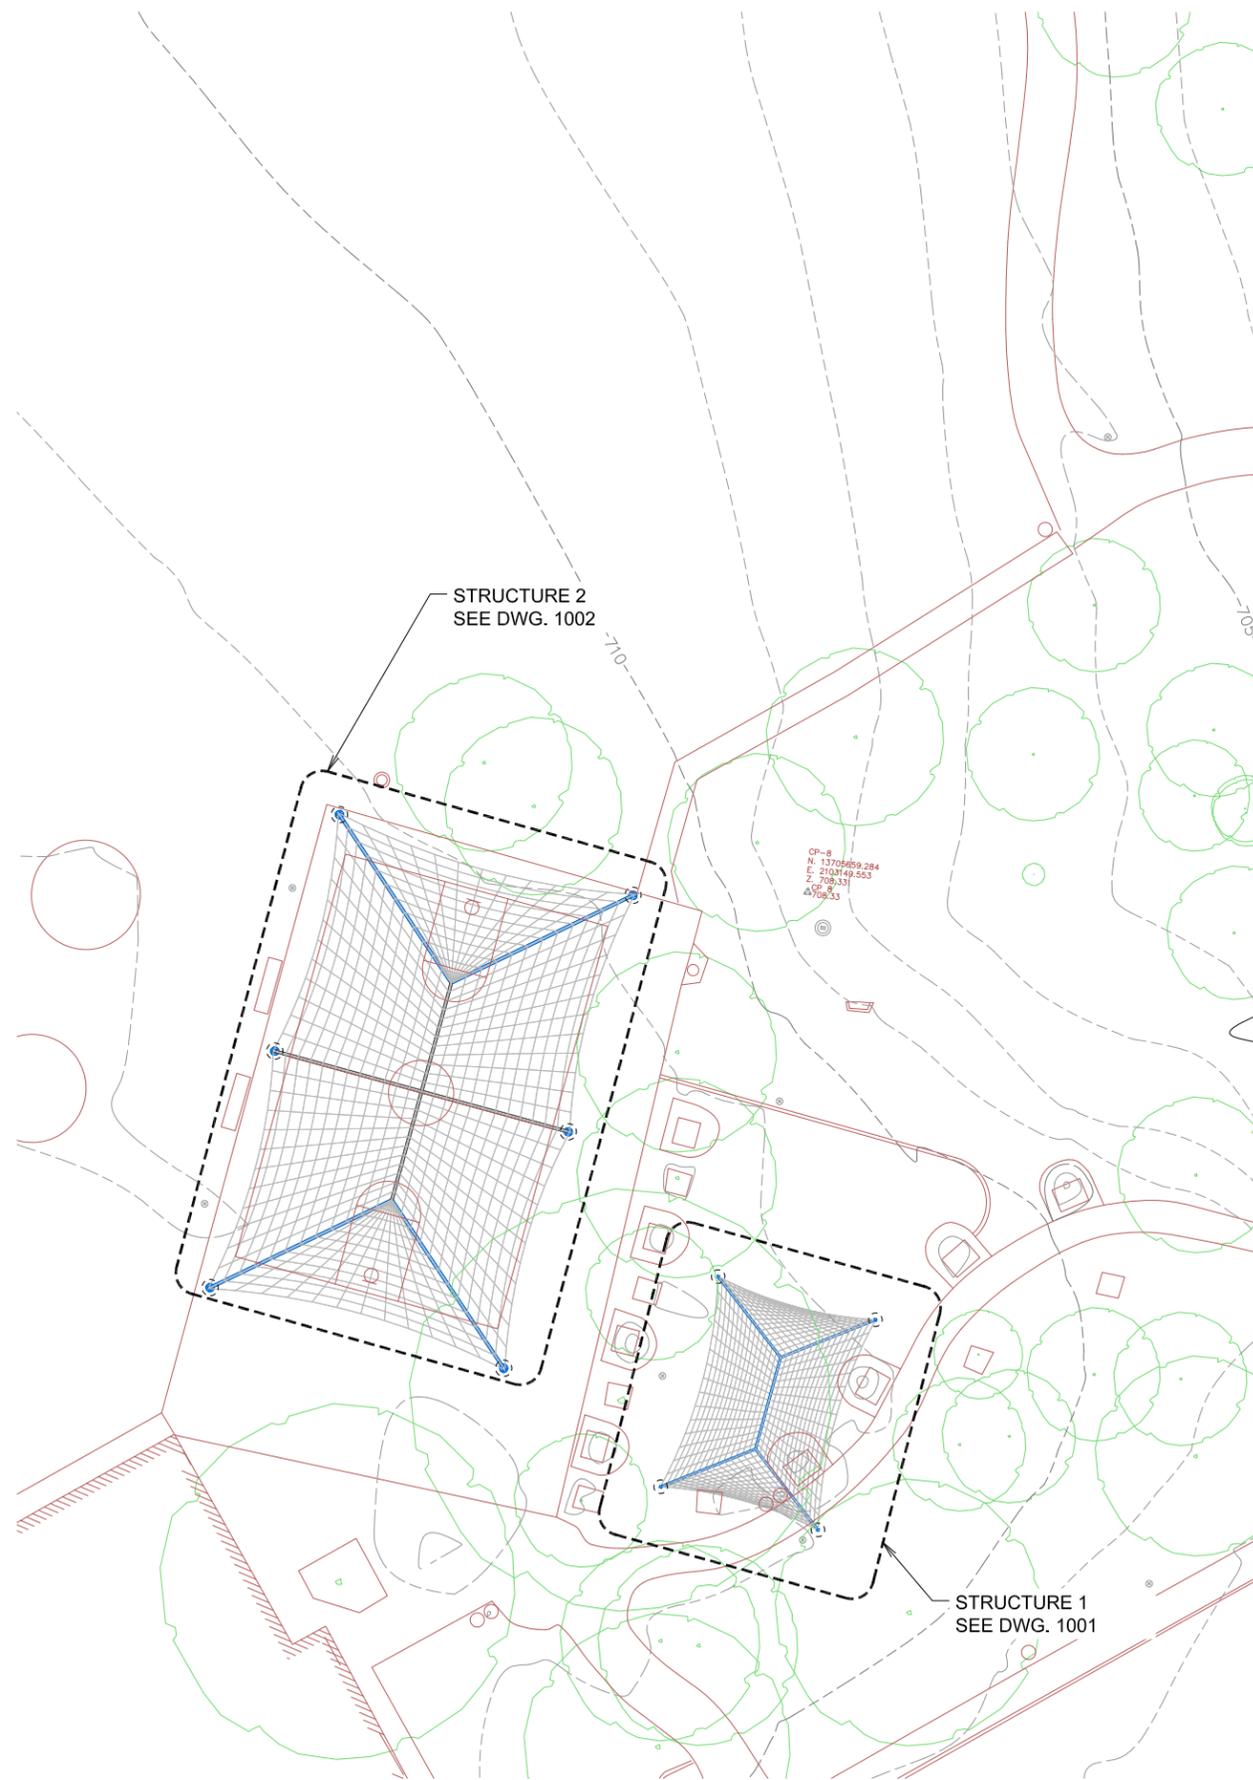

SITE PLAN



CUSTOMER:
CITY OF SAN ANTONIO -TCI
 PROJECT NAME:
MONTERREY PARK - PLAYGROUND SHADE
 LOCATION:
**5919 W COMMERCE
 SAN ANTONIO, TX 78237**

STRUCTURE TYPE:
VARIES
 SIZE:
VARIES

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USASHADE & FABRIC STRUCTURES
 CORPORATE HEADQUARTERS
 2580 ESTERS BLVD., SUITE 100
 DFW AIRPORT, TX 75261
 800-966-5005

CERTIFICATIONS:
 IAS CERTIFICATION No: FA-428
 CLARK COUNTY MANUFACTURER
 CERTIFICATION NUMBER (NEVADA): 355

REV	DESCRIPTION	DATE	DRW	CHK	ENG

Drawn By : YH 04/03/19
 Checked By : YH 04/03/19
 Approved By : YH 04/03/19

DRAWING DESCRIPTION:
VIEWS

DWG. **CON-APR-001-19**

PAGE **1000**

REV.

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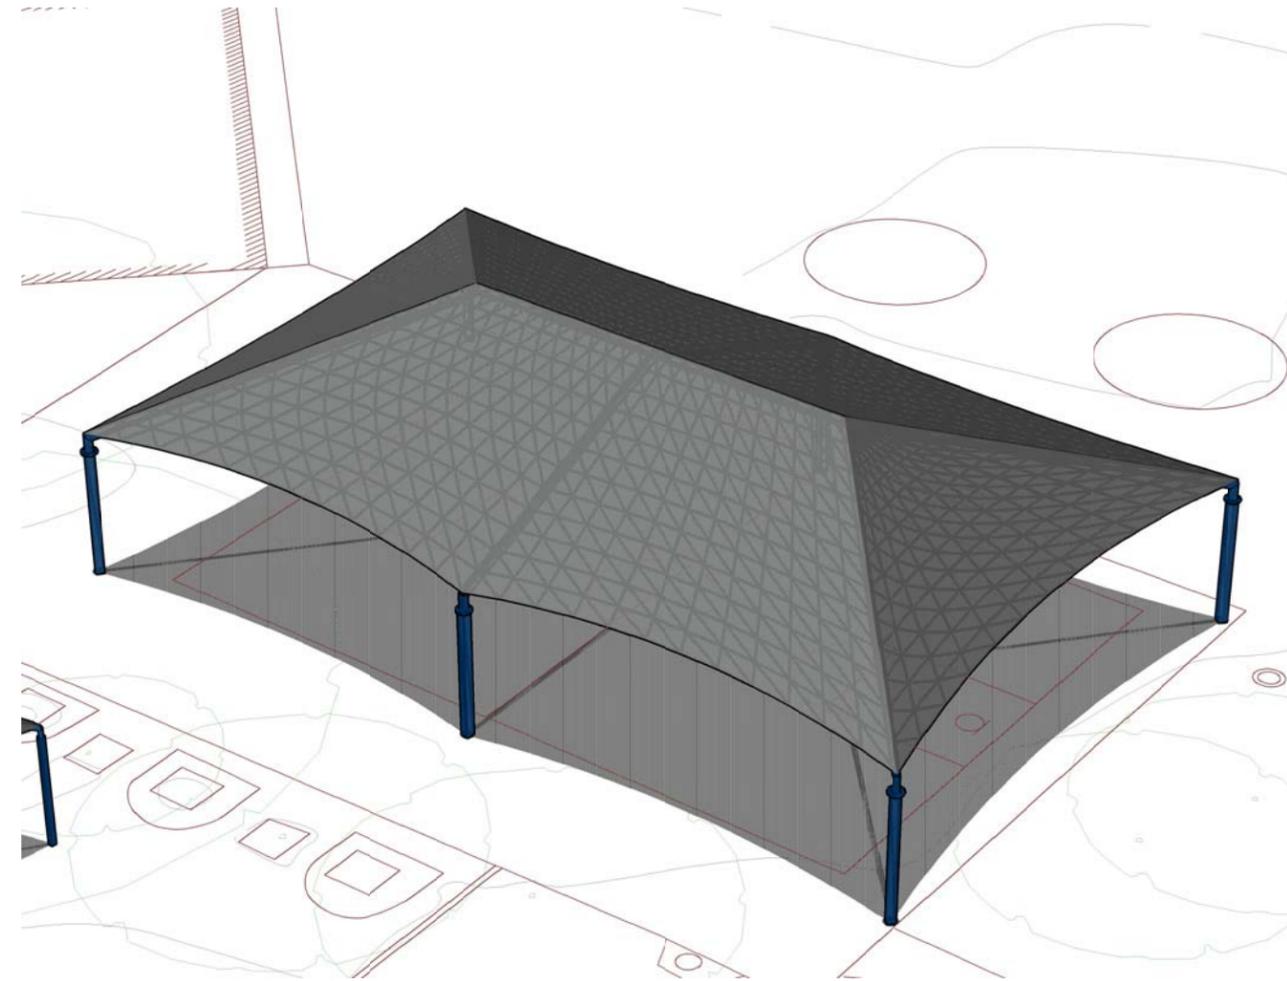
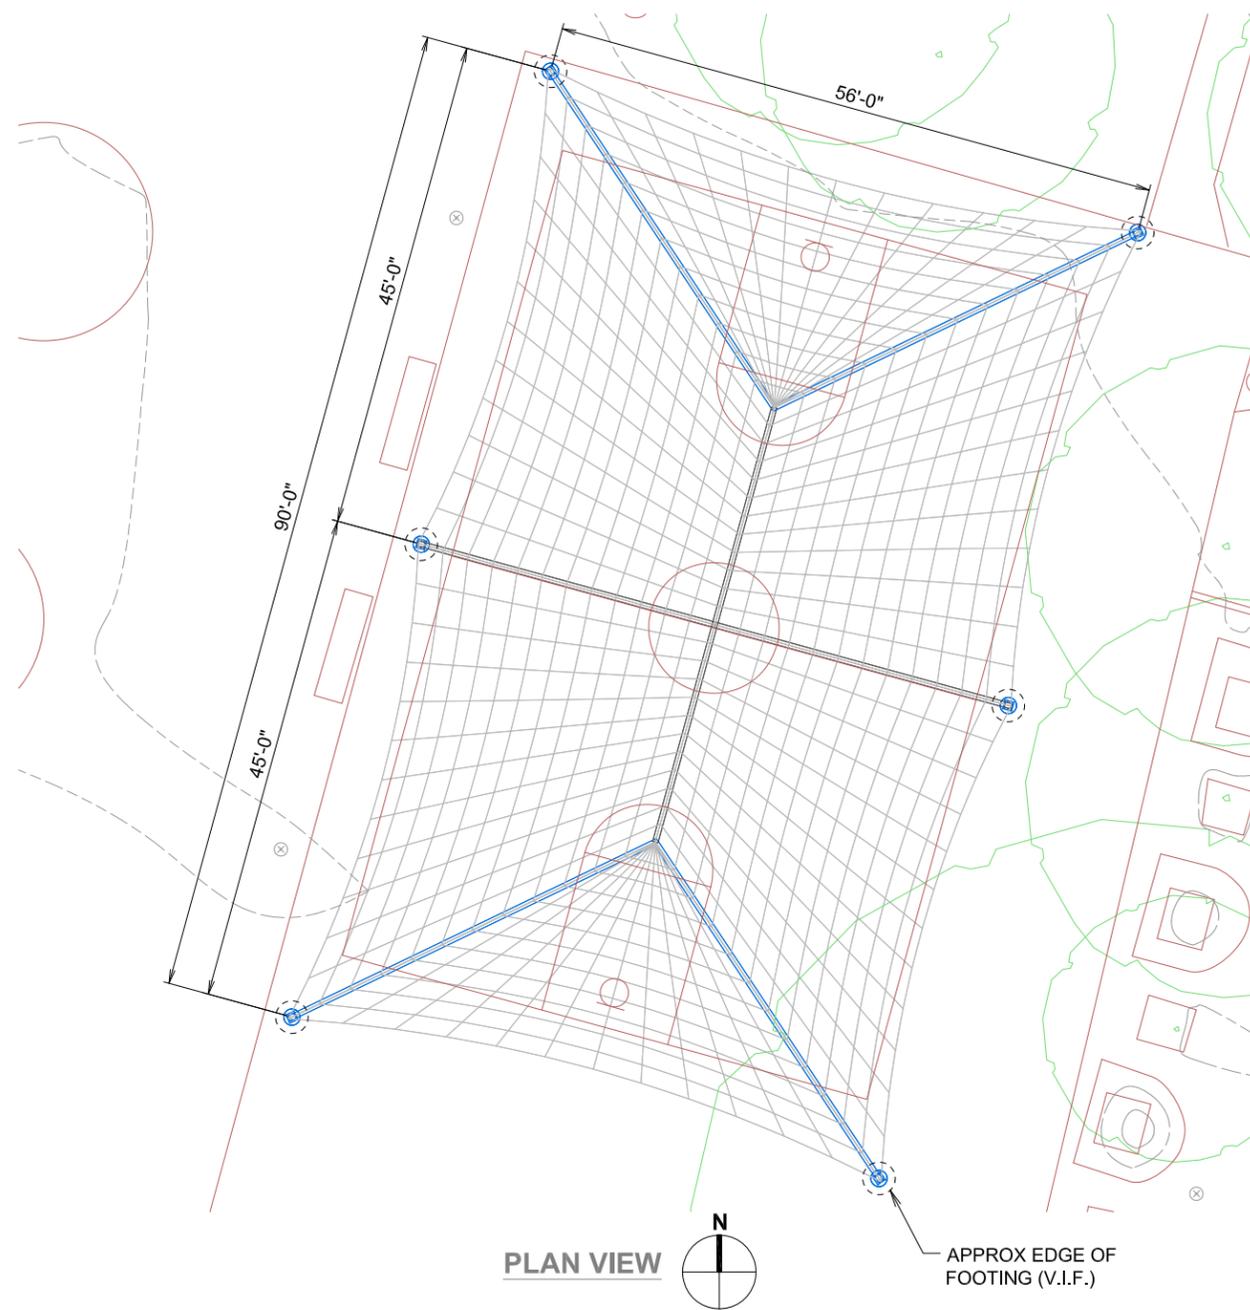
CUSTOMER:
CITY OF SAN ANTONIO -TCI
 PROJECT NAME:
MONTERREY PARK - PLAYGROUND SHADE
 LOCATION:
**5919 W COMMERCE
 SAN ANTONIO, TX 78237**

STRUCTURE TYPE:
SS HIP
 SIZE:
56' X 90' X 15' e


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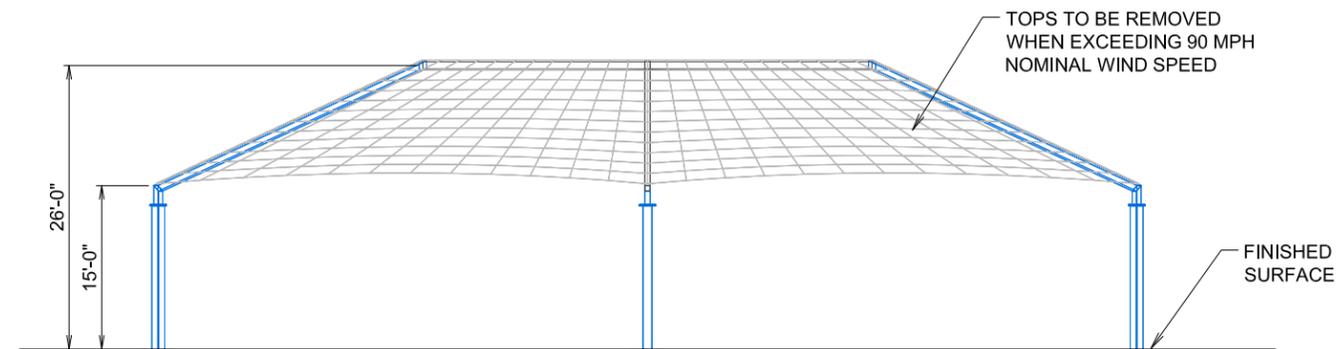
CERTIFICATIONS:
 IAS CERTIFICATION No: FA-428
 CLARK COUNTY MANUFACTURER CERTIFICATION NUMBER (NEVADA): 355



PERSPECTIVE VIEW



SOUTH ELEVATION

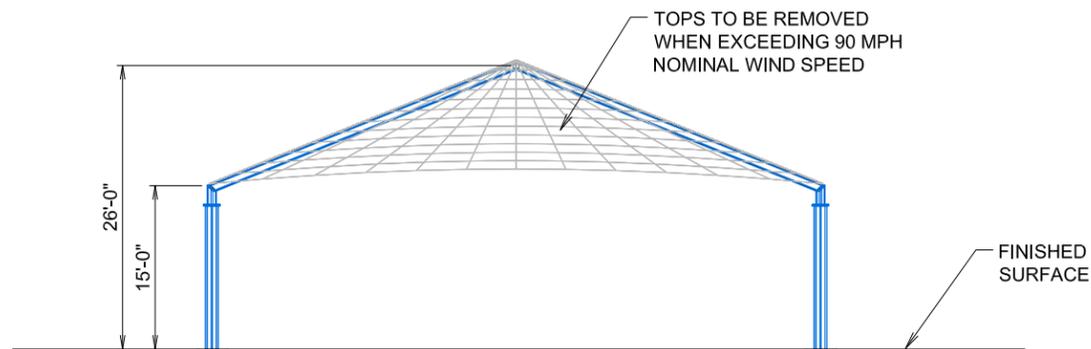

WEST ELEVATION

REV	DESCRIPTION	DATE	DRW	CHK	ENG

Drawn By :	YH	04/03/19
Checked By :	YH	04/03/19
Approved By :	YH	04/03/19

DRAWING DESCRIPTION:
STRUCTURE #2

DWG.
CON-APR-001-19

PAGE
1002

REV.

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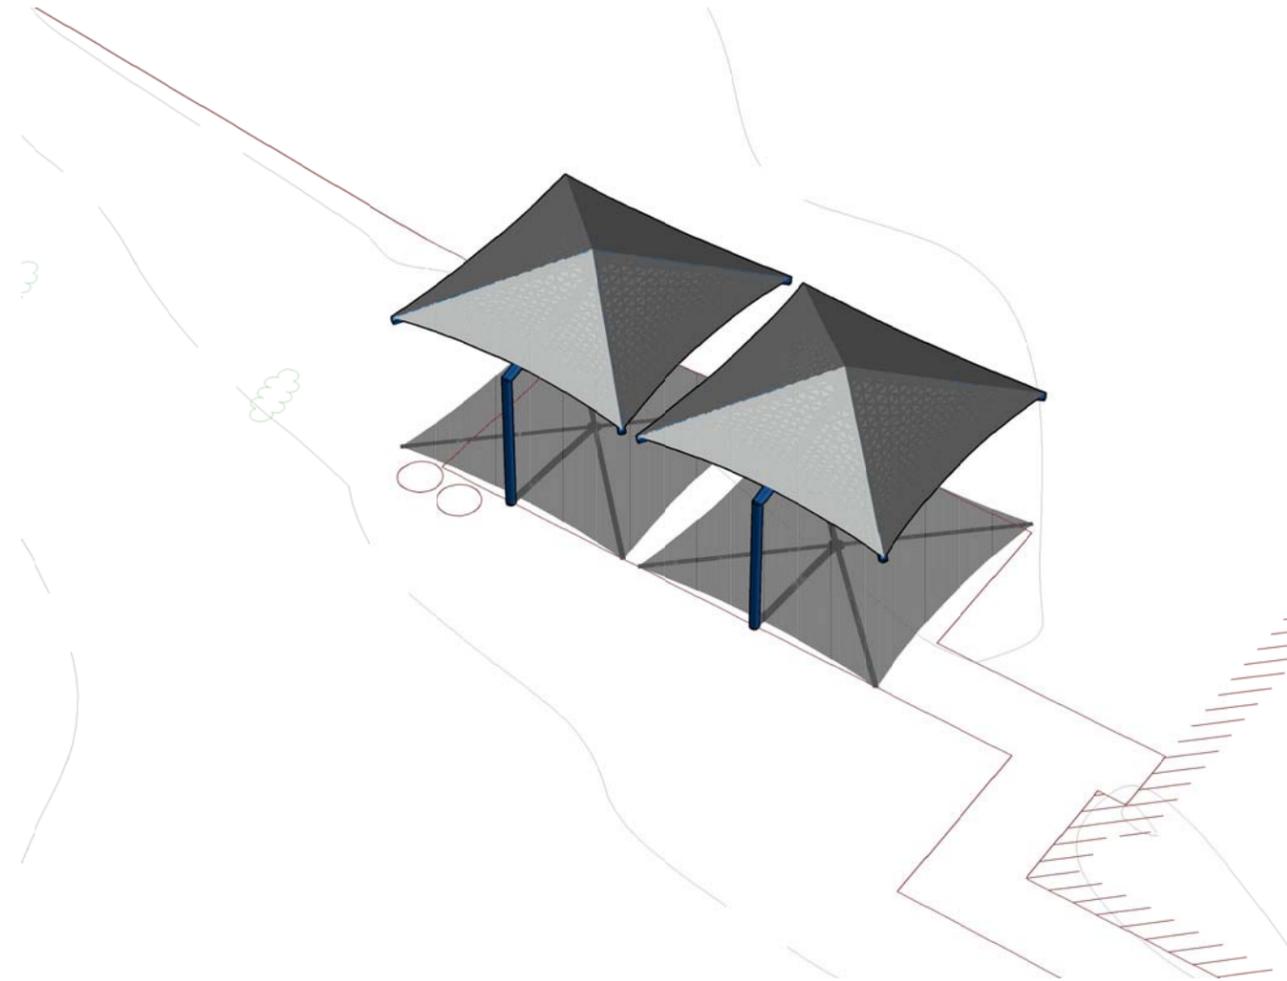
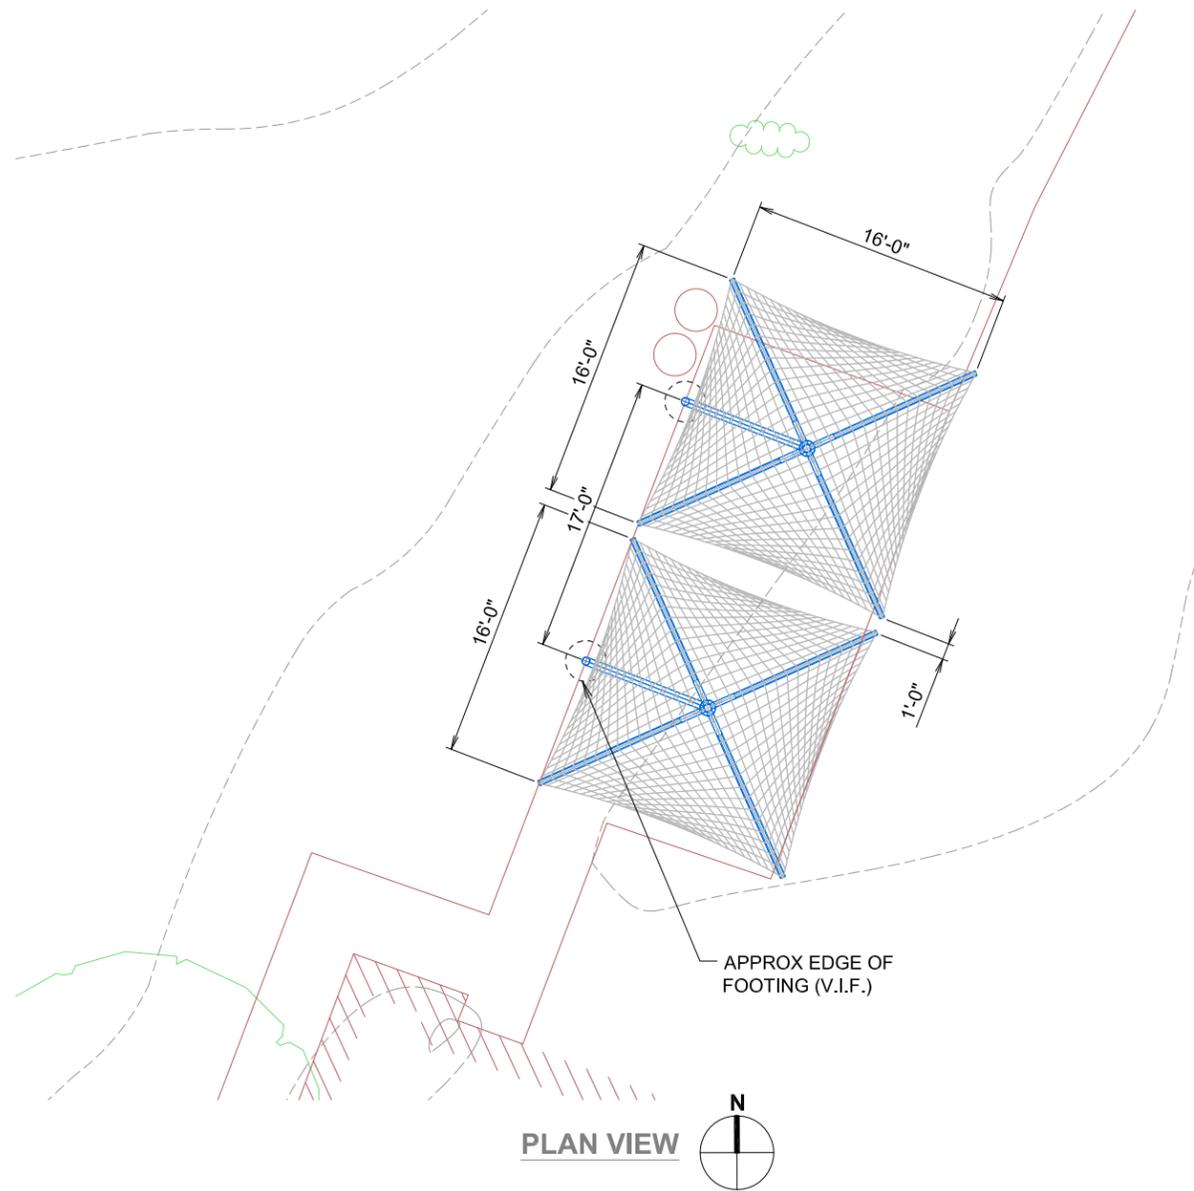
CUSTOMER:
CITY OF SAN ANTONIO -TCI
 PROJECT NAME:
MONTERREY PARK - PLAYGROUND SHADE
 LOCATION:
**5919 W COMMERCE
 SAN ANTONIO, TX 78237**

STRUCTURE TYPE:
SP PYRAMID CANTI (QTY 2)
 SIZE:
16' X 16' X 9' e


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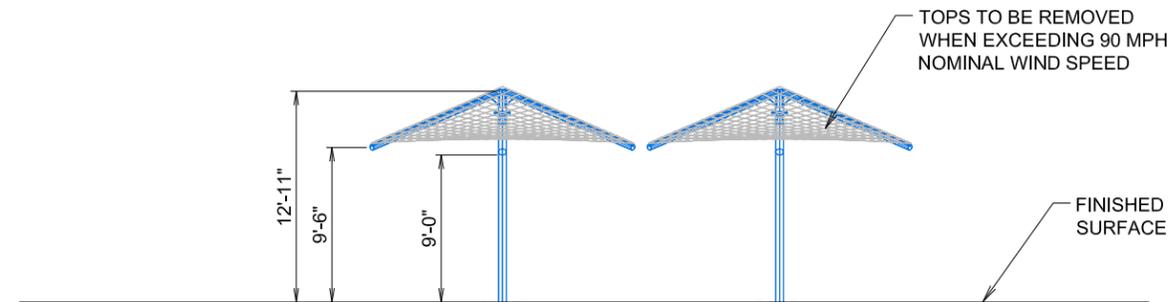
CERTIFICATIONS:
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PERSPECTIVE VIEW



SOUTH ELEVATION



WEST ELEVATION

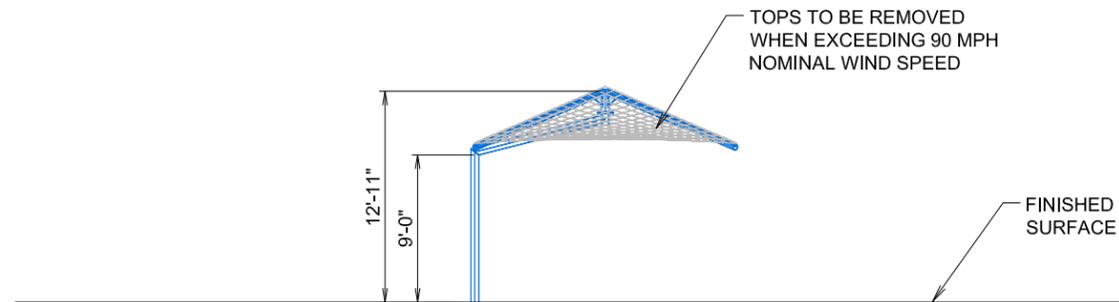REV DESCRIPTION DATE DRW CHK ENG

Drawn By : YH 04/03/19
 Checked By : YH 04/03/19
 Approved By : YH 04/03/19

DRAWING DESCRIPTION:
STRUCTURE #3

DWG. **CON-APR-001-19**

PAGE **1003**

REV.