HISTORIC AND DESIGN REVIEW COMMISSION

August 19, 2020

HDRC CASE NO: 2020-318
COMMON NAME: Maverick Plaza
ADDRESS: 323 S ALAMO ST

LEGAL DESCRIPTION: NCB: 14015 BLK: 8 LOT: 1 CIVIC CENTER PROJECT NO. 5 TEX R-83

ZONING: D, H, RIO-3

PUBLIC PROPERTY: Yes **CITY COUNCIL DIST.:** 1

DISTRICT: La Villita Historic District

APPLICANT: Mark Navaro/Fisher Heck Architects **OWNER:** Steve Collier/CITY OF SAN ANTONIO

TYPE OF WORK: Rehabilitation of Maverick Plaza, site work, utility work, rehabilitation of

historic structure and construction of utility structures

APPLICATION RECEIVED: July 17, 2020

60-DAY REVIEW: Not applicable due to City Council Emergency Orders

CASE MANAGER: Edward Hall

REQUEST:

The applicant is requesting a Certificate of Appropriateness for approval to perform various rehabilitative scopes of work and new construction at 323 S Alamo, commonly known as Maverick Plaza. Within this request, the applicant has proposed the following:

- 1. Remove the existing limestone walls that have enclosed Maverick Plaza along Nueva and S Alamo, remove the fences that separate Maverick Plaza from other portions of La Villita, remove the existing cedar arbor, remove the existing fountain, remove and salvage the existing paving on King Philip V Street, remove the existing concrete and clay tile paving in the plaza and the old Alamo Street walkway, remove portions of low tree planter walls along Alamo Street, remove contemporary CMU addition to Faville House, and remove and relocate electrical panels throughout the plaza
- 2. Install a variety of new paving materials forming various interlocking patterns including diagonal strips and three quatrefoil patterns.
- 3. Install a new fountain within the plaza.
- 4. Install additional trees including sycamore trees within the plaza and trees along the old Alamo Street walkway. The existing twenty-two live oak trees will be preserved.
- 5. Install lighting throughout the plaza to include general lighting, festoon lighting, tree lighting and entrance lighting.
- 6. Perform rehabilitative scopes of work to the historic Faville House, including foundation repair and repair to the porch roof's framing and decking, as well as the installation of a new standing seam metal roof.
- 7. Construct a demonstration kitchen in the plaza for public demonstration and teaching. This structure will include public restrooms.
- 8. Construct a kiosk to serve as a permanent food both.
- 9. Construct two smaller kiosks (mobile) to be located near the proposed fountain.
- 10. Construct new entry features with signage at Alamo St/Nueva St. corner, and Villita Street entry without signage. These elements will also include decorative panels on the S Alamo wall.
- 11. Relocate Mayor Maury Maverick Statue within the Plaza.
- 12. Construct screen walls along Nueva St to hide new transformer. Construct screen wall near Faville house to hide back of house equipment for plaza.

APPLICABLE CITATIONS:

Sec. 35-640. - Public Property and Rights-of-Way.

(a) Public Property. Generally, the historic and design review commission will consider applications for actions affecting the exterior of public properties except in the case of building interiors that are the sites of major public assemblies or public lobbies. The historic and design review commission will also consider

applications for actions affecting public properties such as city parks, open spaces, plazas, parking lots, signs and appurtenances.

(b) Public Rights-of-Way. Generally, the historic and design review commission will consider applications for actions affecting public rights-of-way whose construction or reconstruction exceeds in quality of design or materials standards of the design manual of the public works department.

Sec. 35-641. - Design Considerations for Historic and Design Review Commission Recommendations.

In reviewing an application, the historic and design review commission shall be aware of the importance of attempting to find a way to meet the current needs of the City of San Antonio, lessee or licensee of public property. The historic and design review commission shall also recognize the importance of recommending approval of plans that will be reasonable to implement. The best urban design standards possible can and should be employed with public property including buildings and facilities, parks and open spaces, and the public right-of-way. Design and construction on public property should employ such standards because the use of public monies for design and construction is a public trust. Public commitment to quality design should encourage better design by the private sector. Finally, using such design standards for public property improves the identity and the quality of life of the surrounding neighborhoods.

Sec. 35-642. - New Construction of Buildings and Facilities.

In considering whether to recommend approval or disapproval of a certificate, the historic and design review commission shall be guided by the following design considerations. These are not intended to restrict imagination, innovation or variety, but rather to assist in focusing on design principles, which can result in creative solutions that will enhance the city and its neighborhoods. Good and original design solutions that meet the individual requirements of a specific site or neighborhood are encouraged and welcomed.

(a) Site and Setting.

- (1) Building sites should be planned to take into consideration existing natural climatic and topographical features. The intrusive leveling of the site should be avoided. Climatic factors such as sun, wind, and temperature should become an integral part of the design to encourage design of site-specific facilities which reinforces the individual identity of a neighborhood and promotes energy efficient facilities.
- (2) Special consideration should be given to maintain existing urban design characteristics, such as setbacks, building heights, streetscapes, pedestrian movement, and traffic flow. Building placement should enhance or create focal points and views. Continuity of scale and orientation shall be emphasized.
- (3) Accessibility from streets should be designed to accommodate safe pedestrian movement as well as vehicular traffic. Where possible, parking areas should be screened from view from the public right-of-way by attractive fences, berms, plantings or other means.
- (4) Historically significant aspects of the site shall be identified and if possible incorporated into the site design. Historic relationships between buildings, such as plazas or open spaces, boulevards or axial relationships should be maintained.

(b) Building Design.

- (1) Buildings for the public should maintain the highest quality standards of design integrity. They should elicit a pride of ownership for all citizens. Public buildings should reflect the unique and diverse character of San Antonio and should be responsive to the time and place in which they were constructed.
- (2) Buildings shall be in scale with their adjoining surroundings and shall be in harmonious conformance to the identifying quality and characteristics of the neighborhood. They shall be compatible in design, style and materials. Reproductions of styles and designs from a different time period are not encouraged, consistent with the secretary of the interior's standards. Major horizontal and vertical elements in adjoining sites should be respected.

- (3) Materials shall be suitable to the type of building and design in which they are used. They shall be durable and easily maintained. Materials and designs at pedestrian level shall be at human scale, that is they shall be designed to be understood and appreciated by someone on foot. Materials should be selected that respect the historic character of the surrounding area in texture, size and color.
- (4) Building components such as doors, windows, overhangs, awnings, roof shapes and decorative elements shall all be designed to contribute to the proportions and scale of their surrounding context. Established mass/void relationships shall be maintained. Patterns and rhythms in the streetscape shall be continued.
- (5) Colors shall be harmonious with the surrounding environment, but should not be dull. Choice of color should reflect the local and regional character. Nearby historic colors shall be respected.
- (6) Mechanical equipment or other utility hardware should be screened from public view with materials compatible with the building design. Where possible, rooftop mechanical equipment should be screened, even from above. Where feasible, overhead utilities should also be underground or attractively screened. Exterior lighting shall be an integral part of the design. Interior lighting shall be controlled so that the spillover lighting onto public walkways is not annoying to pedestrians.
- (7) Signs which are out of keeping with the character of the environment in question should not be used. Excessive size and inappropriate placement on buildings results in visual clutter. Signs should be designed to relate harmoniously to exterior building materials and colors. Signs should express a simple clear message with wording kept to a minimum.
- (8) Auxiliary design. The site should take into account the compatibility of landscaping, parking facilities, utility and service areas, walkways and appurtenances. These should be designed with the overall environment in mind and should be in visual keeping with related buildings, structures and places.
- (c) Multiple Facades. In making recommendations affecting new buildings or structures which will have more than one (1) important facade, such as those which will face two (2) streets or a street and the San Antonio River, the historic and design review commission shall consider the above visual compatibility standards with respect to each important facade.

Historic Design Guidelines, Chapter 2, Guidelines for Exterior Maintenance and Alterations

3. Materials: Roofs

B. ALTERATIONS (REHABILITATION, RESTORATION, AND RECONSTRUCTION)

i. Roof replacement—Consider roof replacement when more than 25-30 percent of the roof area is damaged or 25-30 percent of the roof tiles (slate, clay tile, or cement) or shingles are missing or damaged.

ii. Roof form—Preserve the original shape, line, pitch, and overhang of historic roofs when replacement is necessary. iii. Roof features—Preserve and repair distinctive roof features such as cornices, parapets, dormers, open eaves with exposed rafters and decorative or plain rafter tails, flared eaves or decorative purlins, and brackets with shaped ends.

FINDINGS:

- a. The applicant is requesting a Certificate of Appropriateness to perform a number of rehabilitative scopes of work as well as new construction at 323 S Alamo, commonly known as Maverick Plaza.
- b. DESIGN REVIEW COMMITTEE This request was reviewed by the Historic and Design Review Committee on March 24, 2020. At that meeting, committee members commented on the proposed plaza improvements, site improvements, paving and landscaping elements. This request was reviewed a second time by the DRC on August 11, 2020. At that meeting committee members asked questions and provided feedback in regards to site paving, stone walls, planters and landscaping elements.
- c. REMOVAL OF EXISTING ELEMENTS The applicant has proposed to remove the existing limestone walls that have enclosed Maverick Plaza along Nueva and S Alamo, remove the fences that separate Maverick Plaza from other portions of La Villita, remove the existing cedar arbor, remove the

- existing fountain, remove and salvage the existing paving on King Philip V Street, and remove and salvage the existing concrete and clay tile paving in the plaza and the old Alamo Walkway. Staff finds the proposed scope of work to be appropriate; however, staff finds that materials should be salvaged and reused when possible.
- d. PAVING The applicant has proposed to install a variety of new paving materials forming various interlocking patterns including diagonal strips and three quatrefoil patterns. Staff finds the proposed scope and patterns to be appropriate.
- e. FOUNTAIN The applicant has proposed to install a new fountain within the plaza. Staff finds the proposed placement and design to be appropriate.
- f. TREE PRESERVATION The applicant has proposed to plant new trees within the plaza as well as along the old Alamo Street walkway. Additionally, the applicant has noted the preservation of all existing live oak trees within the plaza. Staff finds the installation of new trees as well as the proposed tree preservation to be appropriate.
- g. LIGHTING The applicant has proposed to install lighting throughout the plaza to include general lighting, festoon lighting, tree lighting and entrance lighting. Staff finds the proposed lighting to be appropriate.
- h. FAVILLE HOUSE REHABILITATION The applicant has proposed to perform rehabilitative scopes of work to the historic Faville House, including foundation repair, the removal of a non-original addition, and repair to the porch roof's framing and decking, as well as the installation of a new standing seam metal roof. Staff finds the proposed scope of work to be appropriate and consistent with the Guidelines for Exterior Maintenance and Alterations. Staff finds that the proposed re-framing and re-decking of the porch roof should be performed in-kind and should not result in a change of roof profile. The new standing seam metal roof should feature panels that are 18 to 21 inches in width, seams that are 1 to 2 inches in height, a crimped ridge seam and a standard galvalume finish. A ridge cap is not to be used.
- i. PEDESTRIAN KITCHEN The applicant has proposed to construct a pedestrian kitchen in the plaza for public cooking. This structure will include restrooms. The applicant has proposed materials that include sand finished plaster, board and batten siding, standing seam metal roofs, porcelain tile and other similar materials. The applicant has also noted the installation of overhead coiling doors. Generally, staff finds the proposed design and materials to be appropriate. The proposed standing seam metal roofs should feature panels that are 18 to 21 inches in width, seams that are 1 to 2 inches in height, a crimped ridge seam and a standard galvalume finish.
- j. KIOSKS The applicant has proposed to construct three kiosks, two of which will be mobile to facilitate on site feed sales. Staff finds the overall design and materials proposed for each kiosk to be appropriate. The proposed standing seam metal roofs should feature panels that are 18 to 21 inches in width, seams that are 1 to 2 inches in height, a crimped ridge seam and a standard galvalume finish.
- k. ENTRY FEATURES The applicant has proposed to construct new entry features with signage at the Alamo and Nueve corners and Villita Street without signage. Staff finds the proposed request to be appropriate.
- 1. MAYOR MAURY MAVERICK STATUE RELOCATION The applicant has proposed to relocate the Mayor Maury Maverick statue from its existing location adjacent to S Alamo to the north side of the plaza. Staff finds this relocation to be appropriate.
- m. SCREENING WALLS The applicant has proposed to construct screen walls along Neuva to screen new transformer locations as well as to construct screen walls near the Faville House to screen back of house equipment from the plaza. Staff finds this to be appropriate.
- n. ARCHAEOLOGY The property is located within a River Improvement Overlay District, a Local Historic Landmark, the La Villita Local Historic District, and the La Villita Historic District National Register of Historic Places District. The Texas Sites Atlas indicates that archaeological sites have been previously identified along/adjacent to the San Antonio River. In addition, the project area is in close


proximity to previously recorded sites 41BX919, 41BX575, and 41BX2246. Furthermore, a review of historic archival documents identifies structures within or adjacent to the property as early as 1764. Moreover, this is the reported location of the Spanish Colonial Quartel. The property may contain sites, some of which may be significant. Therefore, archaeological investigations are required. Work within public property is subject to the Texas Antiquities Code. The project shall comply with all federal, state, and local laws, rules, and regulations regarding archaeology, as applicable.

RECOMMENDATION:


Staff recommends approval based on findings a through n with the following stipulations:

- i. That the proposed re-framing and re-decking of the porch roof of the Faville house be performed in-kind and not result in a change of roof profile. The new standing seam metal roof is to feature panels that are 18 to 21 inches in width, seams that are 1 to 2 inches in height, a crimped ridge seam and a standard galvalume finish. A ridge cap is not to be used.
- ii. That the proposed outdoor kitchen and kiosks feature standing seam metal roofs that are 18 to 21 inches in width, seams that are 1 to 2 inches in height, a crimped ridge seam and a standard galvalume finish.
- iii. ARCHAEOLOGY Archaeological investigations are required. The project shall comply with all federal, state, and local laws, rules, and regulations regarding archaeology, as applicable.

City of San Antonio One Stop

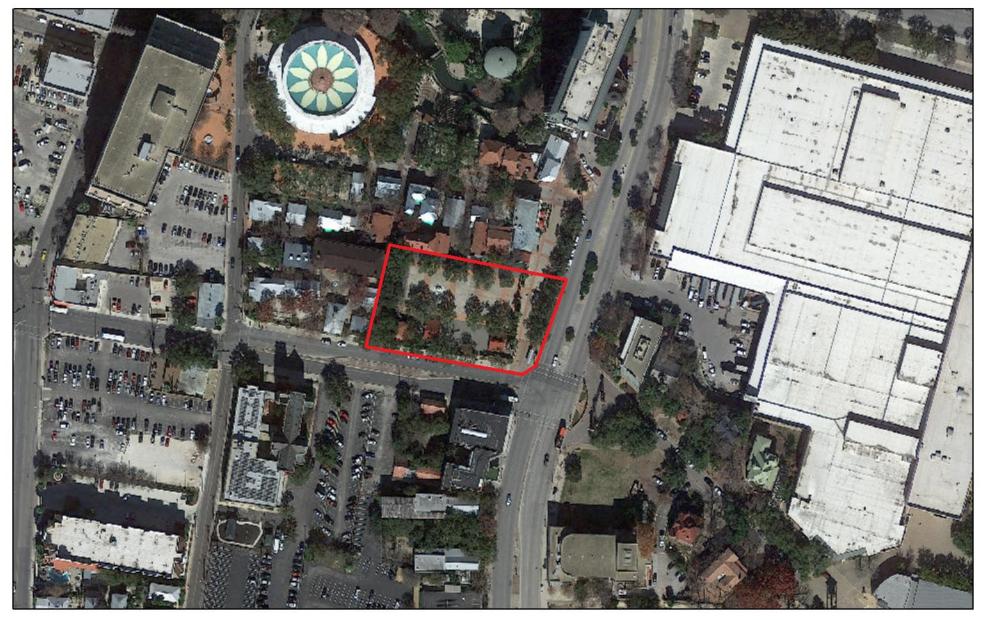

July 30, 2020

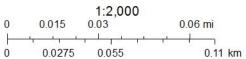



Historic and Design Review Commission Design Review Committee Report & Recommendation

ADDRESS: Maverick Plaza (La Villita) Meeting Location: WebEx
APPLICANT: Mark Navarro / Fisher Heck Architects
DRC Members present: Scott Carpenter, Curtis Fish, Jeff Fetzer
Staff present: Cory Edwards, Edward Hall
Others present: Mark Padilla, Derek Keck, Cameron Robles, Lewis Fisher, Raul Rodriguez, David Hannan, Rhea Roberts (CMO)
REQUEST: Maverick Plaza redevelopment, construction of three commercial structures
COMMENTS/CONCERNS:
CR: Overview of plaza, landscaping and paseo improvements and updates. Overview of materials, site elements and entry element.
JF: Patterning is appropriate—provides separation of hard surfaces. Discussion regarding plaza space interacting with Mexican restaurant and fountain.
All: Discussion regarding additional landscaping and planters.
JF: Can the water element be raised?
SC: Proposal is attractive. Corner entry, will there be accommodation for B-Cycle, etc.? Materials are nice, but the renderings should include an details and information for expansion joints, concrete score joints, etc. There is no transition from large scale to smaller (bricks).
CF: Question regarding stone elements—what is the material and what joints or seams would it have?
JF: Will planers feature a cap? 4inch thick stone cap on planter walls would be appropriate.
OVERALL COMMENTS:
Committee Chair Signature (or representative) Date

DATE: March 24, 2020 HDRC Case#_____

MN: Overview of proposed Mexican restaurant, design, etc.

JF: Comments on roof materials for Mexican restaurant, crimped ridge seams should be used .

JF: How will mechanical equipment be screened?

SC: Can soffits or beams be introduced to separate stucco façade.

JF: Add detailing to brick façade (northwest perspective, Mexican Restaurant).

CF: Concerns about irregular spacing of windows on south elevation (Mexican Restaurant)

JF: Consider a blind window on the first floor of south elevation.

DK: Overview of German Restaurant

JF: Scale of addition works well. Questions regarding glass enclosed dining room—do walls open or fixed glass (fixed glass). Can glass walls be modified? (different profile—break up long horizontal dimension)

SC: Can southern wall at kitchen by separated in some form?

MN: Overview of Spanish Restaurant

JF: Questions regarding stucco finish detailing; no general concerns.

CF: No general concerns.



Historic and Design Review Commission Design Review Committee Report

DATE: August 11, 2020 HDRC Case #:

ADDRESS: 323 S Alamo, Maverick Plaza Meeting Location: WebEx

APPLICANT: Mark Navarro/Fisher Heck

DRC Members present: Jeff Fetzer, Curtis Fish

Staff Present: Shanon Miller, Cory Edwards, Edward Hall

Others present: Rhea Robets (CMO), Mark Padilla, Lewis Fisher

REQUEST: Redevelopment of Maverick Plaza, new construction of kiosks, rehabilitation of historic structure

COMMENTS/CONCERNS:

RR: Update on progress up to this point, overview of project/current location

MN: Overview of design, design highlights

MP: Overview of plaza/fountain/site design and elements

CF: Questions regarding public space/private space at plaza and restaurants. Question about location of demonstration kitchen

JF: Is Old Alamo current accessible during NIOSA (yes).

MN: 21% reduction in public space

CF: No concerns regarding materials for design.

CF: When would the design return to the Commission (RR: August 19)

JF: Should the paving pattern be adjusted to help pedestrian orientation and pedestrian traffic on site

JF: Will planters have cap stones?

JF: Questions about what will be included in the restaurant design

OVERALL COMMENTS:

LA VILLITA - MAVERICK PLAZA REHABILITATION

A project of the City of San Antonio with MP Studio and Fisher Heck Architects

DESCRIPTION OF PROJECT:

This project is intended to completely rehabilitate Maverick Plaza, renovating the central tree-lined plaza and a section of Old Alamo Street that remains to the west of the current South Alamo Street. This quadrant of La Villita was once completely covered with houses and commercial/industrial structures. The structures were all removed by Urban Renewal, and Maverick Plaza was created after HemisFair68.

In the coming months, a privately funded project will add three restaurants to activate La Villita and Maverick Plaza. This project is associated with the World Heritage Office and the city's designation as a World Heritage City of Gastronomy.

The project has been previously discussed with the Office of Historic Preservation and the Architectural Review Committee. This first project, the Rehabilitation of Maverick Plaza, will bring new utilities into the site, repave the plaza, landscape existing and new planting beds, construct a new fountain, and add new entrance features at the corners of Nueva Street and South Alamo, and at Villita Street and South Alamo Street. New lighting will be installed in the plaza and along old Alamo Street. A new edge for La Villita will be defined along South Alamo Street through the addition of colorful punched metal panels that form a low fence within the existing tree planters.

Demolition and modifications:

- 1. The limestone walls which have closed Maverick Plaza from the City along Nueva and South Alamo Streets will be removed.
- 2. The fences that closed Maverick Plaza from the rest of La Villita will be removed.
- 3. The existing cedar arbor will be removed
- 4. The existing fountain will be removed, and a new fountain installed at the opposite side of the plaza to draw visitors into La Villita.
- 5. Existing paving on King Philip V Street will be removed, salvaged and reinstalled where possible.
- 6. Existing concrete and clay tile paving in the plaza and old Alamo Walkway will be removed or used as a foundation for new paving.

Paving: Consistent with the paving materials in La Villita, the plaza will be paved with a variety of materials that form interlocking patterns. Three quatrefoil patterns will decorate the plaza and form the paving surrounding the new fountain. Diagonal strips of paving will provide visual activation and a variety of appropriate earth tone colors. They will also reflect the variety of paving materials found through La Villita.

Landscaping Plant Materials: La Villita, since its first restoration in 1939, has displayed a romantic collection of plant materials that provide shade and color. Twenty-two existing live oak trees will be preserved. Four new Sycamore trees will be added to provide additional shade within the plaza and three trees will be added along Old Alamo Street walkway.

Lighting: New Lighting will be installed. The lighting will meet several needs and functions:

- 1. General lighting
- 2. Festoon lighting above the plaza
- 3. Tree lighting
- 4. Lighting highlighting the two new entries at Villita and Nueva.

Stabilization of the Faville House:

As a part of the obligation of the City of San Antonio to the Culinary Concept Developer, the City is responsible for basic structural stability of the historic structures which will be rehabilitated by the private developer. It has been determined that the rubble limestone foundation and the wooden front porch of the Faville House are in poor condition. The City of San Antonio will stabilize the foundation of the house and replace the deteriorated wooden framing and roof decking on the porch. To protect the new framing, a new galvanized metal roof will be installed over the porch.

No rehabilitation of the Gissi House (the other historic house in the project) will be accomplished in this project, but the house will be rehabilitated in the restaurant project.

New Structures:

This City of San Antonio will construct several small structures supporting the goals of the project:

- 1. A presentation kitchen will be built so that local chefs and others can teach about the foodways of historic San Antonio while preparing these foods for classes and public demonstration. Men's and Women's rest rooms will be included in the new building.
- 2. A kiosk will be built to serve as a permanent food booth that can be used during events and on a daily basis.
- 3. Two smaller kiosks (which are movable) will be located near the new fountain. They will serve as booths to sell a variety of items, including arts and craft. These too, will be used during events and on a day by day basis to activate the plaza.



MAVERICK PLAZA REHABILITATION

PHOTOGRAPHS OF MAVERICK PLAZA



Existing View of Maverick Plaza Looking East. Stone columns and gates will be removed. The rest room building on the right has been removed.



Existing View of Maverick Plaza Looking West towards Plaza Nacional.



Existing View of Maverick Plaza Looking Southeast. The Fairmount Hotel is seen in the distance.



Existing view of Maverick Plaza looking South.



Existing view of Maverick Plaza looking southwest with the Gissi House in the background.



Existing View of Maverick Plaza Looking Northwest.



Existing view of Maverick Plaza looking north. The Mayor Maury Maverick statue will be re-located between these two tree planters.



Existing view of the Plaza looking northeast. The red-roofed Faville house is in the background. The future addition of the Faville house will be located behind the two oak trees.


NUEVA STREET PHOTOGRAPHS



Stone walls along E. Nueva Street are to be removed. A portion of the furthest stone wall will remain to conceal the CPS electrical Equipment.



The CPS Transformer and Switchboard is proposed to be located behind the existing stone wall along East Nueva Street. The left nineteen feet of the ten-foot-tall wall will remain to conceal the CPS switchboard and transformer.

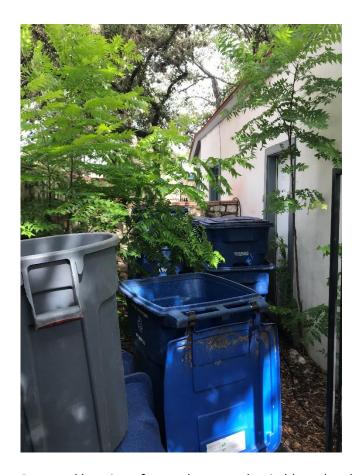

Proposed location of ground-mounted switchboard and transformer.



Fountain is proposed to be removed.



All arbors are to be removed.



Metal fences around Maverick Plaza are proposed to be removed.



Brick wall on left side of photograph is to be removed. Concrete block addition at the rear of the Faville House is to be removed.

PHOTOGRAPHS OF THE OLD ALAMO STREET WALKWAY



The existing walkway that follows the right of way of old South Alamo Street.



Stone walls and gates along S Alamo Street to be removed. The planters in the foreground will be bisected to create more access to S. Alamo Street. The six oak trees will remain.



Proposed Location of the new fountain. The fountain will be located to welcome visitors to Maverick Plaza approximately where the metal gates and stone columns are located.



The existing statue of Mayor Maury Maverick is to be relocated to the north side of Maverick Plaza. This space is proposed as the site of Small Kiosk 1.



Proposed Site of the Small Kiosk 3. An 18'-0" wide portion of the planter will be removed to open La Villita to the South Alamo Sidewalk. The space will be paved and will serve as a walkway and a location for Kiosk 3.

PROPOSED LOCATIONS FOR NEW BUILDINGS AND KIOSKS



Proposed site for the presentation kitchen and rest room building. The building will be placed 10 feet from the adjacent Starving Artist Gallery.



Proposed Site of Kiosk 1. After removal of the walls and gate, the new kiosk is proposed to be placed here.

VILLITA STREET ENTRANCE FROM SOUTH ALAMO STREET



View of Villita Street looking west. Part of the planter on the right is proposed to be removed and replaced with paving to connect to the sidewalk beyond. The Villita Street entrance will be defined by stone pylons and landscaping.





201 GROVETON | SATX 78210 210.314.5582 | MPSTUD.IO

STATUS

100% CONSTRUCTION **DOCUMENT SET**

FOR REVIEW ONLY Not for regulatory approval, permitting or construction

PROJECT

LA VILLITA

MAVERICK PLAZA REHABILITATION

PROJECT ADDRESS

418 VILLITA STREET #9 SAN ANTONIO, TX 78205

OWNER | CLIENT

CITY OF SAN ANTONIO (PW)
100 HOUSTON ST., SUITE 210
SAN ANTONIO, TX 78205

SUBCONSULTANT

		REVISIONS	
		ISSUE SETS	
NO.	DATE	DESCRIPTION	
1	06.16.20	ISSUE FOR CONSTRUCTION	

SHEET INFORMATION

PROJECT NO.


DATE ISSUED

JULY 22, 2020

SHEET NAME

PLAZA RENDERING

SHEET NUMBER

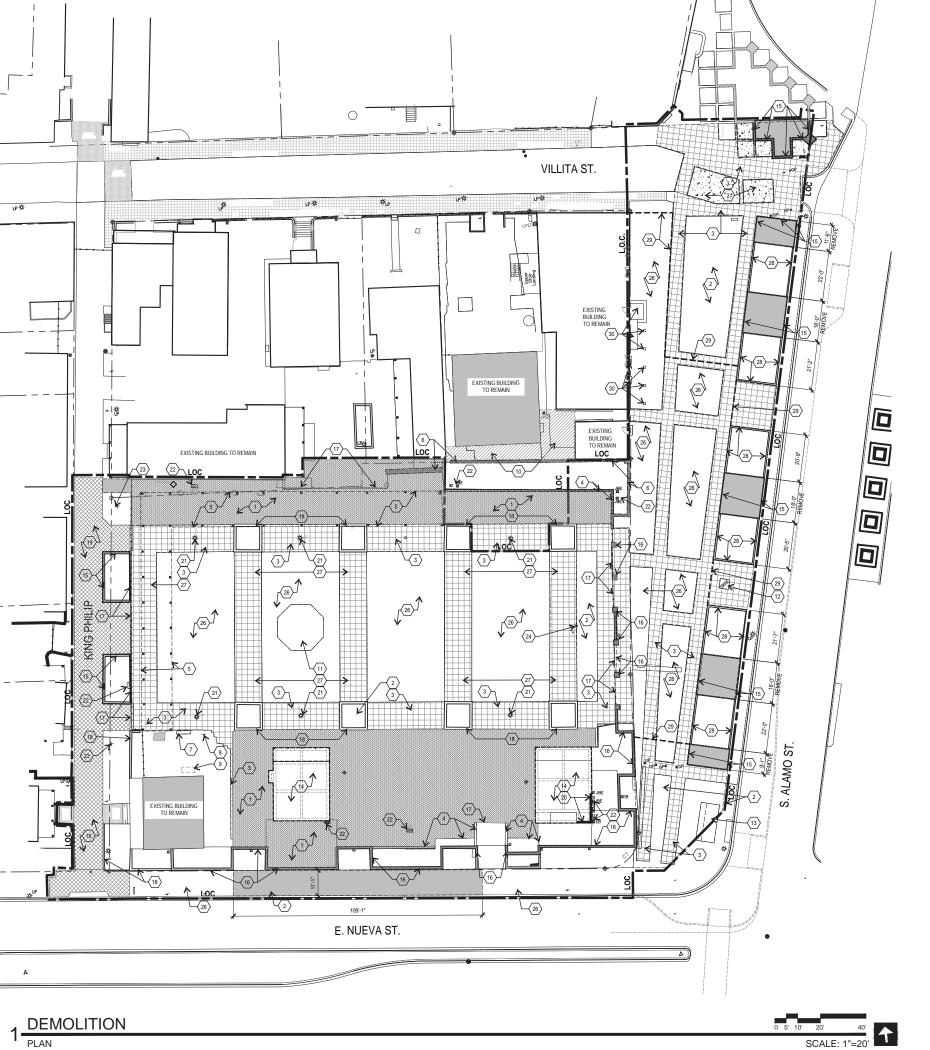

SITE DEMOLITION LEGEND

EXISTING CLAY PAVERS, SEE NOTE #3

EXISTING CONCRETE PAVERS, SEE NOTE #1

EXISTING PAVERS, SEE NOTE #19

SITE DEMOLITION KEYNOTES

- EXISTING CONCRETE PAVERS AND BASE TO BE REMOVED, SALVAGED AND STORED FOR REINSTALLATION
- EXISTING CONCRETE PAVING TO REMOVED
- EXISTING CLAY PAVERS TO BE REMOVED
 EXISTING STONE CURB TO BE REMOVED
- EXISTING WOODEN TRELLIS TO BE REMOVED
 EXISTING MASONRY WALL TO BE REMOVED
 EXISTING CONCRETE FOUNDATION TO BE REMOVED
- EXISTING SIGNAGE TO BE REMOVED AND SALVAGED EXISTING BENCH TO BE REMOVED AND SLAVAGED
- EXISTING PAVERS TO BE REMOVED
- EXISTING FOUNTIAN AND STEPS TO BE REMOVED EXISTING FOUNTIAN AND STEPS TO BE REMOVED EXISTING MAURY MAVERICK STATUE & BASE TO BE REMOVED & STORED OFFSITE FOR REINISTALLATION AS SHOWN ON LS 1.1 USING PROTECTIVE MEASURES. CONTRACTOR SHALL BE RESPONSIBLE FOR ANY DAMAGE TO THE STATUE INCLUDING THE SUPPORTIVE BASE
- 13 EXISTING BUS SHELTER, COORDINATE REMOVAL WITH VIA METRO
- EXISTING BUILDING FOUNDATION TO BE REMOVED (14"x30" PERIMETER BEAMS & 12"x30" INTERIOR BEAMS)
- EXISTING PLANTER WALL BE REMOVED; STONE VENEER & PAVING CAP TO BE REMOVED/ SALVAGE AND STORED FOR USE ON NEW PLANTER WALL REF. DETAIL 11/LS 2.4
- EXISTING STONE/TILE WALL AND COLUMNS TO BE REMOVED SALVAGE AND STORE STONE VENEER FOR USE ON NEW RESTAURANT EXISTING METAL GATES AND FENCE TO BE REMOVED EXISTING METAL GATES AND EXICE TO SE REMOVED EXISTING PLANTER RETAINING WALL TO REMAIN IN PLAZA

- EXISTING PAVERS TO BE REMOVED, SALVAGED AND STORED FOR REINSTALLATION
- EXISTING WALL TO BE REMOVED

 EXISTING LIGHT POLE TO BE REMOVED, SEE ELECTRICAL
- EXISTING ELECTRICAL EQUIPMENT TO BE REMOVED, SALVAGED OR RELOCATED, SEE ELECTRICAL EXISTING FIRE DEPARTMENT CONNECTION, SEE MEP EXISTING FLAGPOLE TO BE REMOVED

- 24 EXISTING FLAGFOLE TO BE KEMOVED
 25 EXISTING STONE/TILE WALL TO REMAIN
 26 EXISTING CONCRETE PAVING TO REMAIN 8 RECEIVE SCARIFICATION IN
 PREPARATION FOR NEW PLAZA DESIGN REF. DETAIL 3/LD 1.1 BELOW
 27 EXISTING CLAY PAVERS TO BE REMOVED 8 REPLACED WITH NEW
 CONCRETE WITH SCARIFICATION IN PREPARATION FOR NEW PLAZA
 DESIGN REF. DETAIL 4/LS 1.2 BELOW
- 28 EXISTING MASONRY WALL TO REMAIN & LOWERED IN HEIGHT; REF. DETAIL 2/LD 1.1 BELOW
- 29 LIMIT OF EXISTING CONCRETE DEMOLITION
- 30 EXISTING BUILDING STEP/ RAMP/ COLUMN TO REMAIN

STUDIO

201 GROVETON | SATX 78210 210.314.5582 | MPSTUD.IO

STATUS

100% **CONSTRUCTION DOCUMENT SET**

FOR REVIEW ONLY Not for regulatory approval, permitting or construction

PROJECT

LA VILLITA


MAVERICK PLAZA REHABILITATION

PROJECT ADDRESS

418 VILLITA STREET #9 SAN ANTONIO, TX 78205

OWNER | CLIENT

CITY OF SAN ANTONIO (PW) 100 HOUSTON ST., SUITE 210 SAN ANTONIO, TX 78205

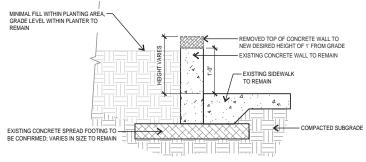


2 EXISTING CONCRETE PLANTER WALL SECTION S

SCALE: 1"=1'-0"

NOTE: CONTRACTOR TO TREAT EXISTING PLAZA CONCRETE WITH SCARIFICATION TO PROVIDE CONNECTION WITH NEW PLAZA PAVEMENT WIDTH VARES - REF. PLANS CONCRETE BONDING AGENT — EXISTING PLAZA CONCRETE TO REMAIN UNKNOWN COMPACTED MATERIAL BENEATH PLAZA

3 EXISTING PLAZA CONCRETE PAVEMENT SCAL

SCALE: 1"=1'-0"

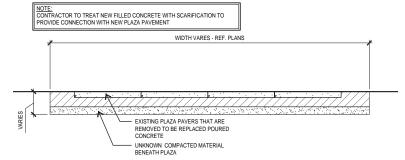

4 EXISTING PLAZA PAVERS SECTION

SCALE: 1"=1'-0"

ISSUE SETS 1 06.16.20 ISSUE FOR CONSTRUCTION SHEET INFORMATION PROJECT NO.

SUBCONSULTANT


18100


DATE ISSUED JULY 22, 2020

SHEET NAME **DEMO PLAN**

SHEET NUMBER

LD 1.1

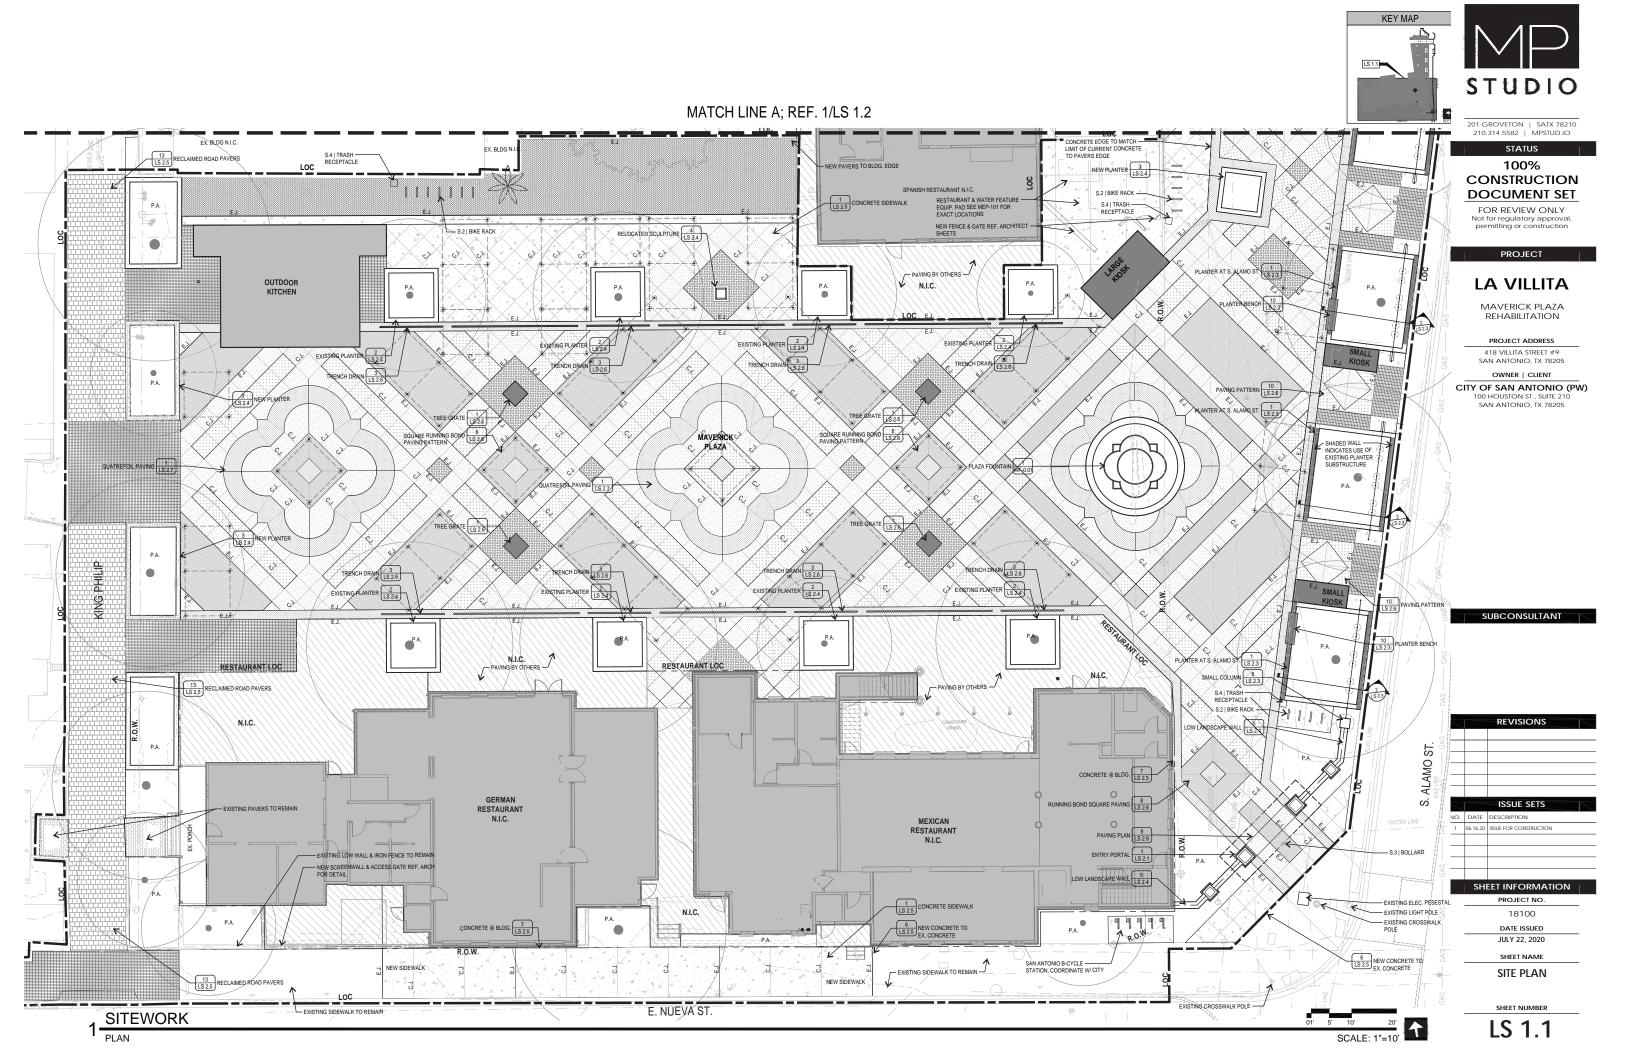

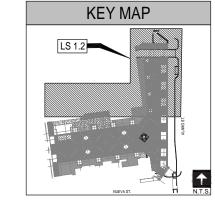



201 GROVETON | SATX 78210 210.314.5582 | MPSTUD.IO

STATUS

100% CONSTRUCTION **DOCUMENT SET**

FOR REVIEW ONLY Not for regulatory approval, permitting or construction

PROJECT

LA VILLITA

MAVERICK PLAZA REHABILITATION

PROJECT ADDRESS

418 VILLITA STREET #9 SAN ANTONIO, TX 78205

OWNER | CLIENT CITY OF SAN ANTONIO (PW)

100 HOUSTON ST., SUITE 210 SAN ANTONIO, TX 78205

ISSUE SETS 1 06.16.20 ISSUE FOR CONSTRUCTION

> SHEET INFORMATION PROJECT NO.


18100 DATE ISSUED

JULY 22, 2020

SHEET NAME SITE PLAN

SHEET NUMBER

LS 1.2

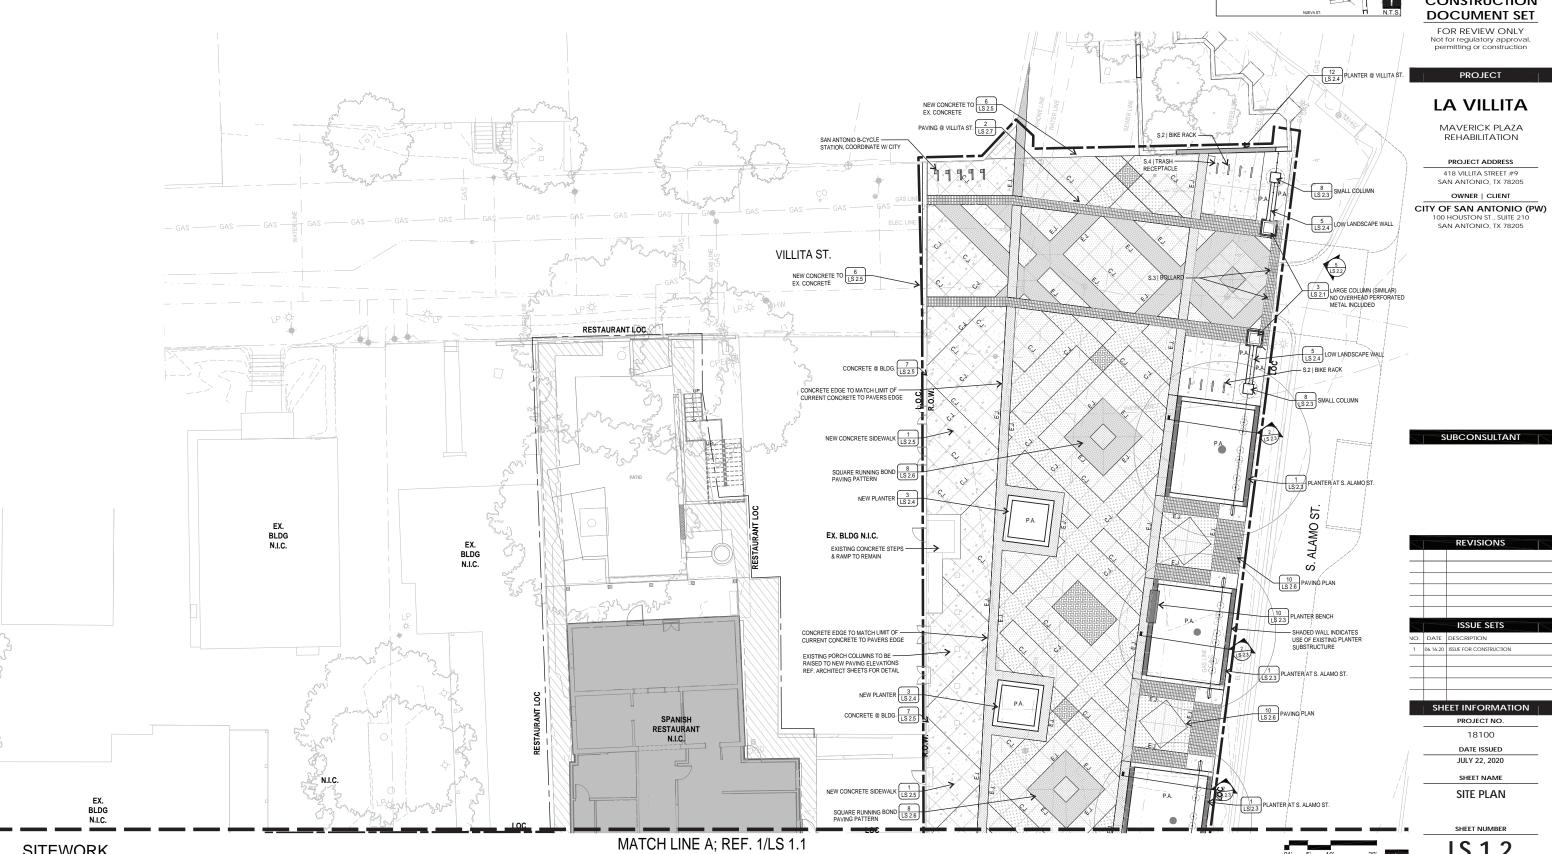



(1A) SPECIALTY CONCRETE

ACID WASH SANDBLASTED | THICKNESS PER CIVIL DETAILS INTEGRAL COLOR: U20 SMOKE
CONTACT: CONSTRUCOLOR, 210.714.3488



201 GROVETON | SATX 78210 210.314.5582 | MPSTUD.IO STATUS 100% CONSTRUCTION **DOCUMENT SET** FOR REVIEW ONLY Not for regulatory approval, permitting or construction

PROJECT

LA VILLITA

MAVERICK PLAZA REHABILITATION

PROJECT ADDRESS 418 VILLITA STREET #9 SAN ANTONIO, TX 78205 OWNER | CLIENT

(B) SPECIALTY CONCRETE

ACID WASH SANDBLASTED | THICKNESS PER CIVIL DETAILS INTEGRAL COLOR: U11 AUTUMN OAK CONTACT: CONSTRUCOLOR, 210.714.3488



CITY OF SAN ANTONIO (PW) 100 HOUSTON ST., SUITE 210 SAN ANTONIO, TX 78205

©2D'HANIS PAVERS

SIZE: 4"X8"X 2.25" | COLOR: TERRA COTTA | COMPANY: D'HANIS BRICK & TILE 210.525.8142



(3) RECLAIMED CONCRETE PAVERS RECLAIMED CONCRETE PAVERS IN SELECT HIGHLIGHTED

AREAS TO INDICATE ARRIVALS AND SITE | PATTERN: HERRINGBONE | COMPANY: COSA TCI



SUBCONSULTANT

ISSUE SETS NO. DATE DESCRIPTION

1 06.16.20 ISSUE FOR CONSTRUCTION

SHEET INFORMATION

PROJECT NO. 18100

DATE ISSUED JULY 22, 2020

SHEET NAME SITE PLAN

SHEET NUMBER

LS 1.0



NOTE: • ALL NEW SITEWORK & TREE LIGHTING SHALL HAVE NO TRENCHING IN CRITICAL ROOT ZONE OF TREES WITHOUT CONSULTING CITY ARBORIST OF TREES WITHOUT CONSULTING CITY AND DRIST.

**ALL UTILITY LINES (GAS, ELECTRIC, WATER, SEWER, COMMUNICATION, ETC.) TO AVOID IMPACTS/
TRENCHING TO TREES IDENTIFIED TO BE PRESERVED INCLUDING THEIR INDIVIDUAL TREE CRITICAL
ROOT ZONES AND TREE CANOPIES WITHOUT CONSULTING CITY ARBORIST.

TREE PRESERVATION

TREE PRESERVATION: (Tree Survey Method)
TREES SURVEYED
SIGNIFICANT TREE:
340 NOTA. 440'R REQUIRED TO BE PRESERVED:
SIGNIFICANT TREE INCH. PRESERVED:
REQUIRED SIGNIFICANT MITIGATION.
HERTRAGE TREE:
50 NOTA. 1 400'S REQUIRED TO BE PRESERVED:
HERTRAGE TREE NOTA PRESERVED:
REQUIRED VEHETIAGE MITIGATION.
TOTAL REQUIRED MITIGATION ON SITE:
PAUNT TREE:

PRESERVED TREES

REMOVED TREES

TREE PRESERVATION OUTSIDE R.O.W.

COMPLYING MITIGATION CALCULATIONS

REQUIRED MITIGATION: 5' - 24' MITIGATION PROVIDED = 0' REMAINING

"REFERENCE SHEET LP 2.1 FOR PROPOSED MITIGATION INCH CALCULATIONS AND TREE TYPES"



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PROJECT

LA VILLITA

MAVERICK PLAZA REHABILITATION

PROJECT ADDRESS

418 VILLITA STREET #9 SAN ANTONIO, TX 78205

OWNER | CLIENT CITY OF SAN ANTONIO (PW)

100 HOUSTON ST., SUITE 210 SAN ANTONIO, TX 78205

SUBCONSULTANT

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			ISSUE SETS	
N	Ο.	DATE	DESCRIPTION	
	1	06.16.20	ISSUE FOR CONSTRUCTION	
	<u>.</u>	SHI	EET INFORMATION	

REVISIONS

PROJECT NO.

18100

DATE ISSUED

JULY 22, 2020

SHEET NAME

TREE PRESERVATION PLAN

SHEET NUMBER

TP 1.1





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PROJECT

LA VILLITA

MAVERICK PLAZA REHABILITATION

PROJECT ADDRESS

418 VILLITA STREET #9 SAN ANTONIO, TX 78205

OWNER | CLIENT

CITY OF SAN ANTONIO (PW) 100 HOUSTON ST., SUITE 210 SAN ANTONIO, TX 78205

SUBCONSULTANT

		REVISIONS	$\overline{}$
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		ISSUE SETS	$\overline{}$
NO.	DATE	DESCRIPTION	
1	06.16.20	ISSUE FOR CONSTRUCTION	


SHEET INFORMATION PROJECT NO.

DATE ISSUED


JULY 22, 2020

SHEET NAME LIGHTING PLAN

SHEET NUMBER LL 1.0

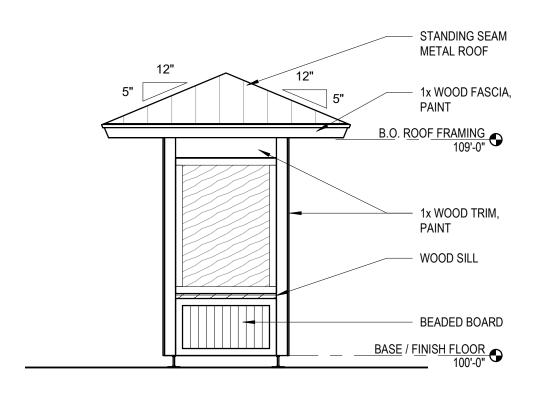

EXTERIOR ELEVATION - KIOSK #1 & #3 SIDES

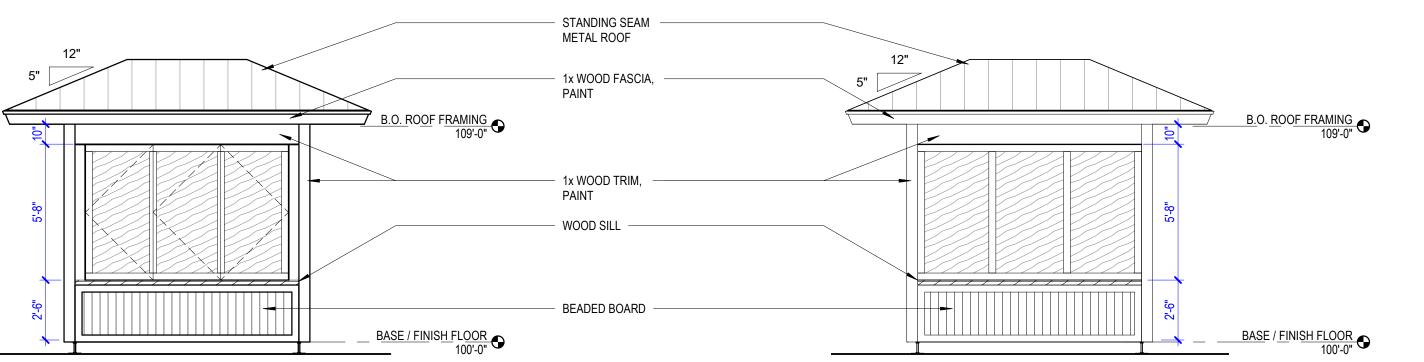

SOLID SURFACE — SEATING/SERVING


COUNTERS

FLOOR PLAN - KIOSK #1 & #3 EXTERIOR ELEVATION - KIOSK #1 & #3 FRONT

5 3-A-600


EXTERIOR ELEVATION - KIOSK #1 BACK

EXTERIOR ELEVATION - KIOSK #2 BACK

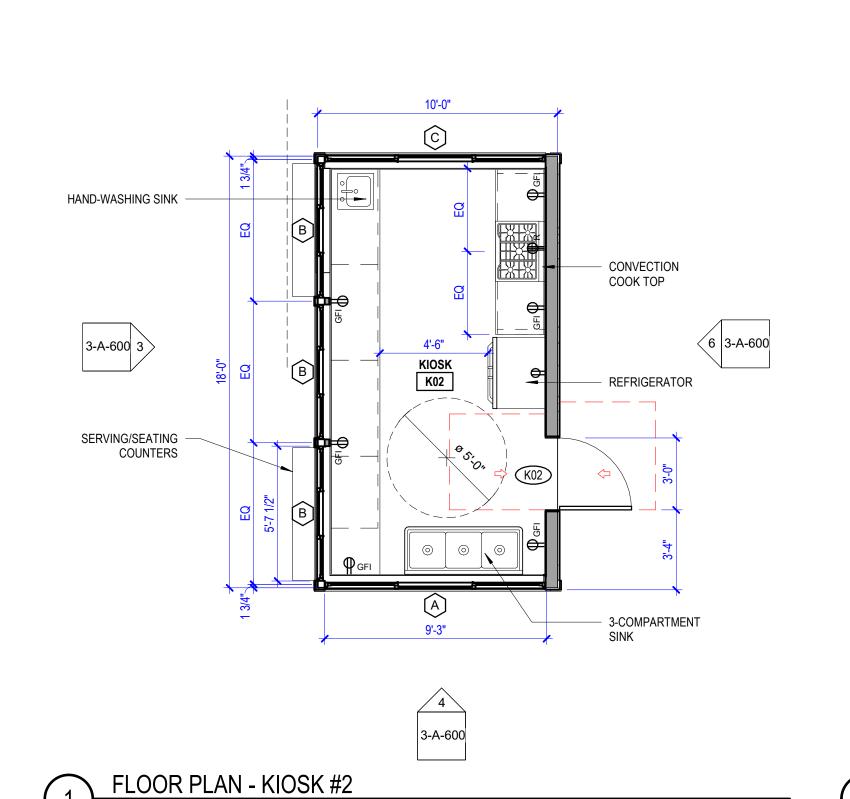

3-A-600

PLATFORM FRAMING

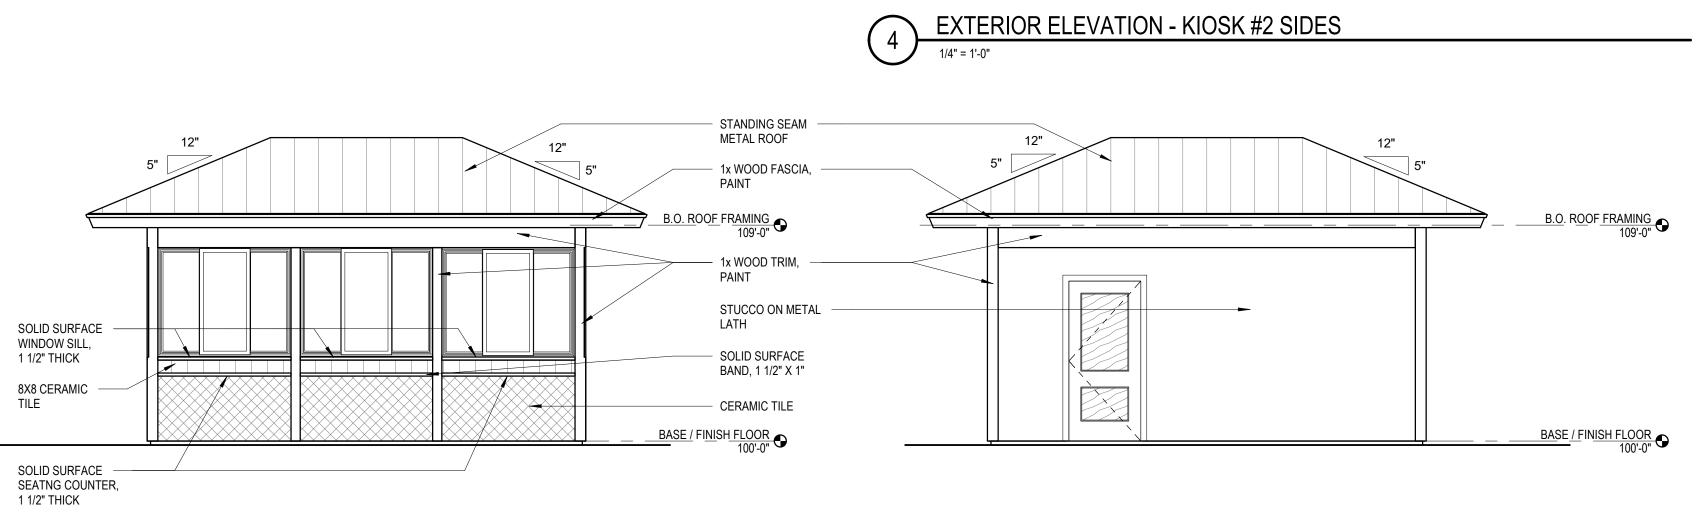

EXTERIOR ELEVATION - KIOSK #2 FRONT

SUBCONSULTANT Fisher Heck ARCHITECTS 915 SOUTH ST MARY'S STREET SAN ANTONIO TEXAS FISHERHECK.COM 210-299-1500 **REVISIONS ISSUE SETS** NO. DATE DESCRIPTION 1 06.17.20 100% CD REVIEW SET | SHEET INFORMATION PROJECT NO. 1827 A1 **DATE ISSUED** JUNE 17, 2020 SHEET NAME HDRC ELEVATIONS

SHEET NUMBER

3-A-600

STUDIO

201 GROVETON | SATX 78210

210.314.5582 | MPSTUD.IO

STATUS

100%

CONSTRUCTION

DOCUMENT SET

PRELIMINARY NOT FOR REGULATORY

APPROVAL, PERMIT, OR CONSTRUCTION
FISHER HECK, INC., ARCHITECTS
MARK B. NAVARRO #25326

PROJECT

LA VILLITA

MAVERICK PLAZA REHABILITATION

PROJECT ADDRESS 418 VILLITA STREET #9 SAN ANTONIO, TX 78205

OWNER | CLIENT

CITY OF SAN ANTONIO (PW)

114 W. COMMERCE, 6TH FLOOR SAN ANTONIO, TX 78205

STANDING SEAM METAL ROOF

1x WOOD FASCIA, PAINT


B.O. ROOF FRAMING 109'-0"

1x WOOD TRIM, PAINT


SOLID SURFACE
BAND (1 1/2" X 1")


- CERAMIC TILE

BASE / FINISH FLOOR 100'-0"

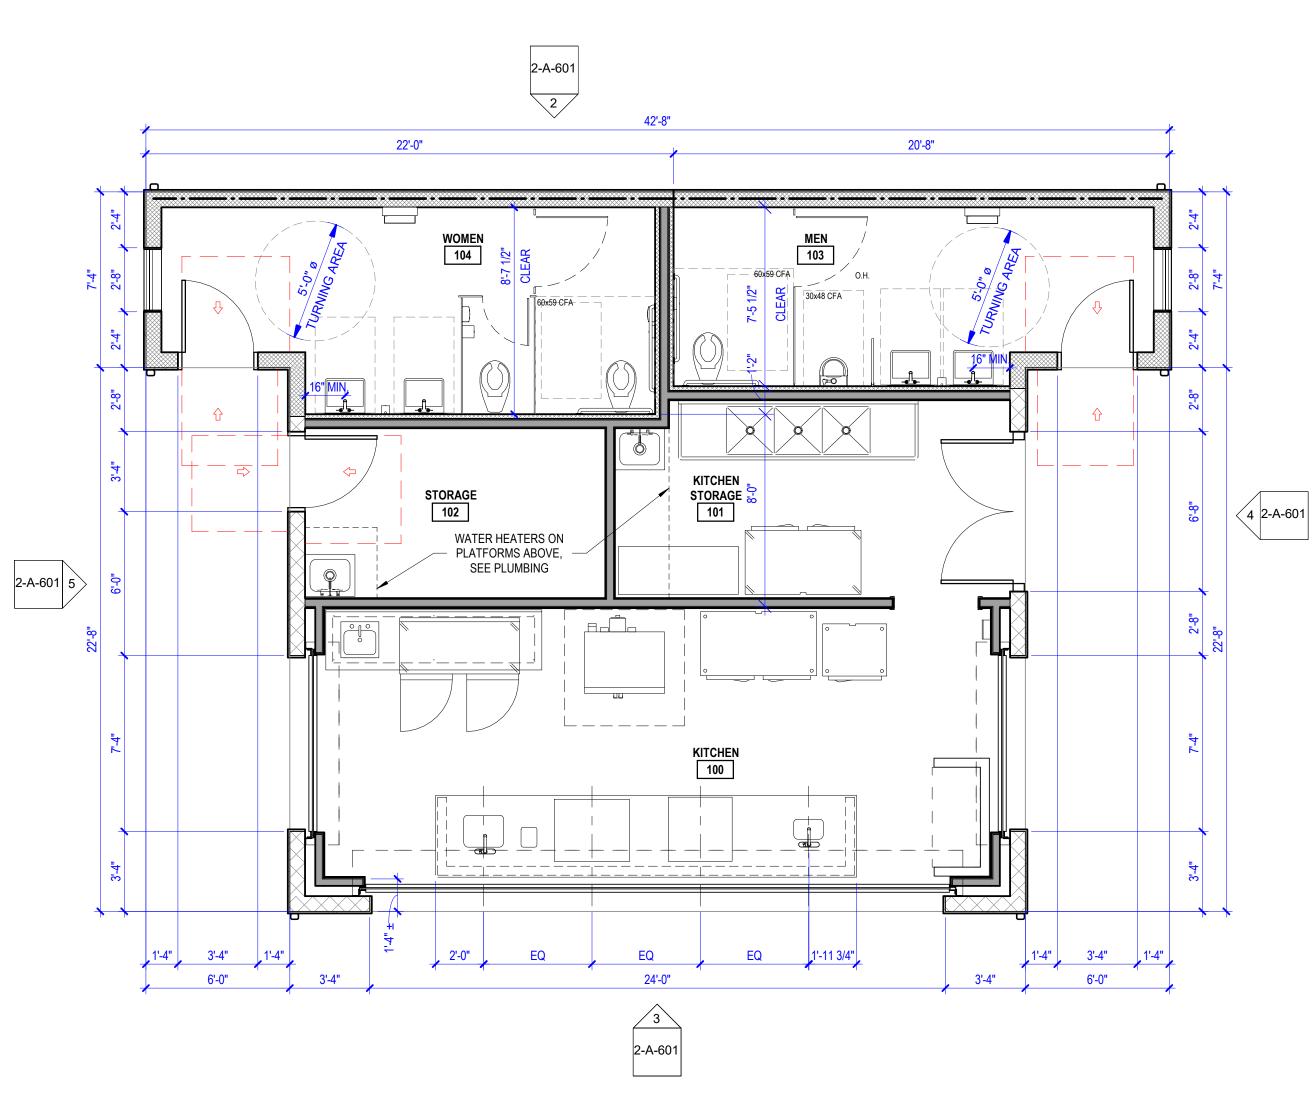


FLOOR PLAN

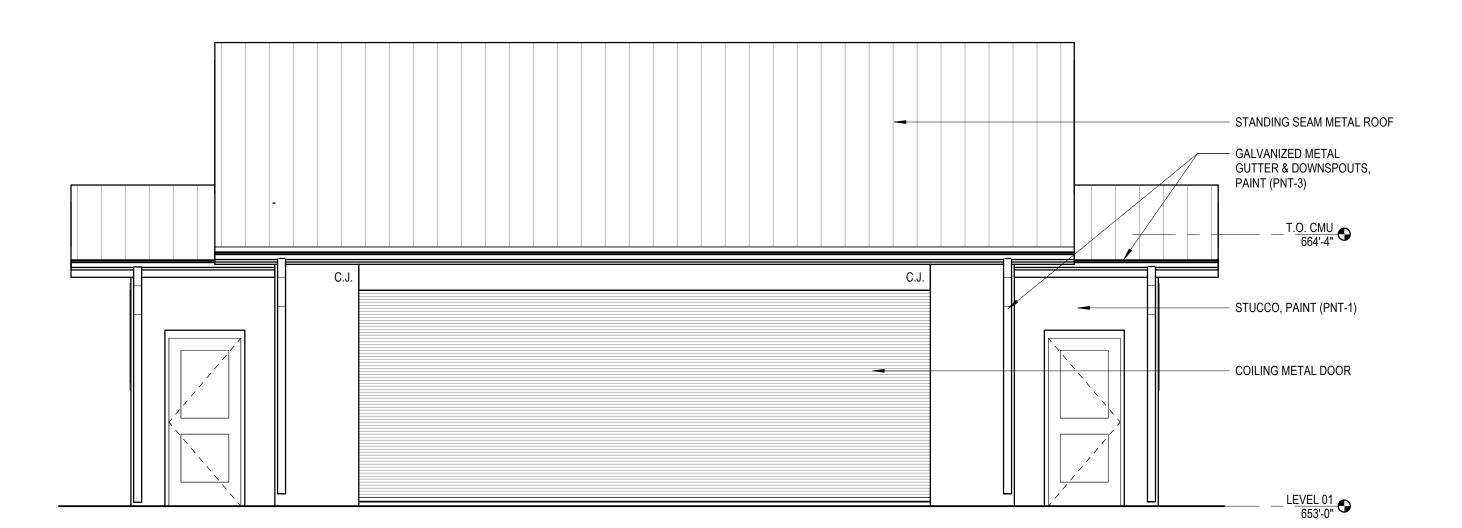


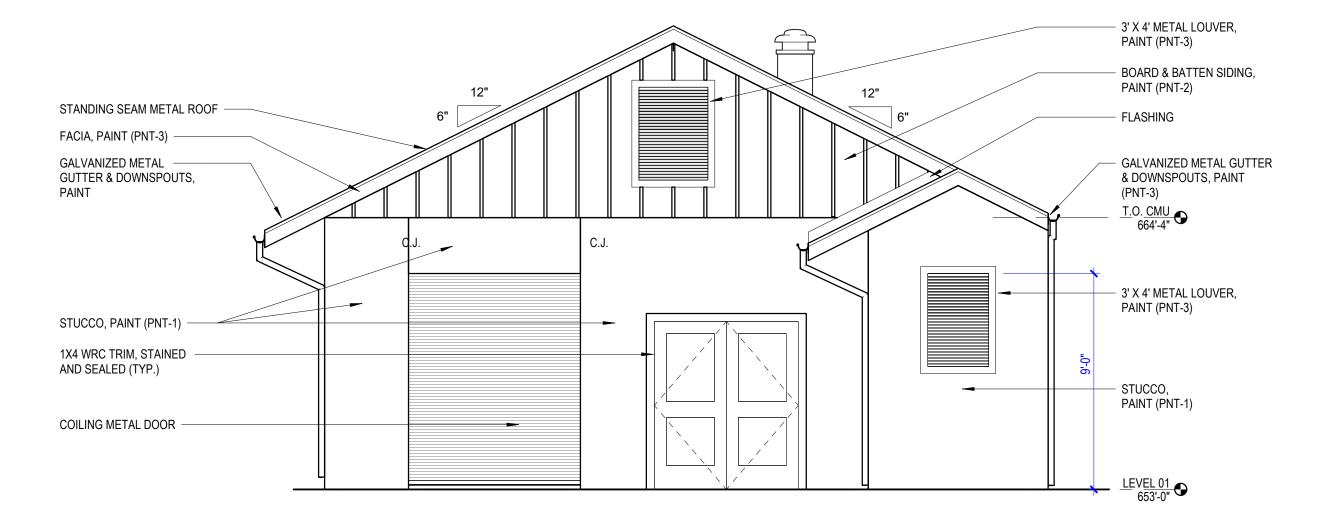

EXTERIOR ELEVATION - EAST

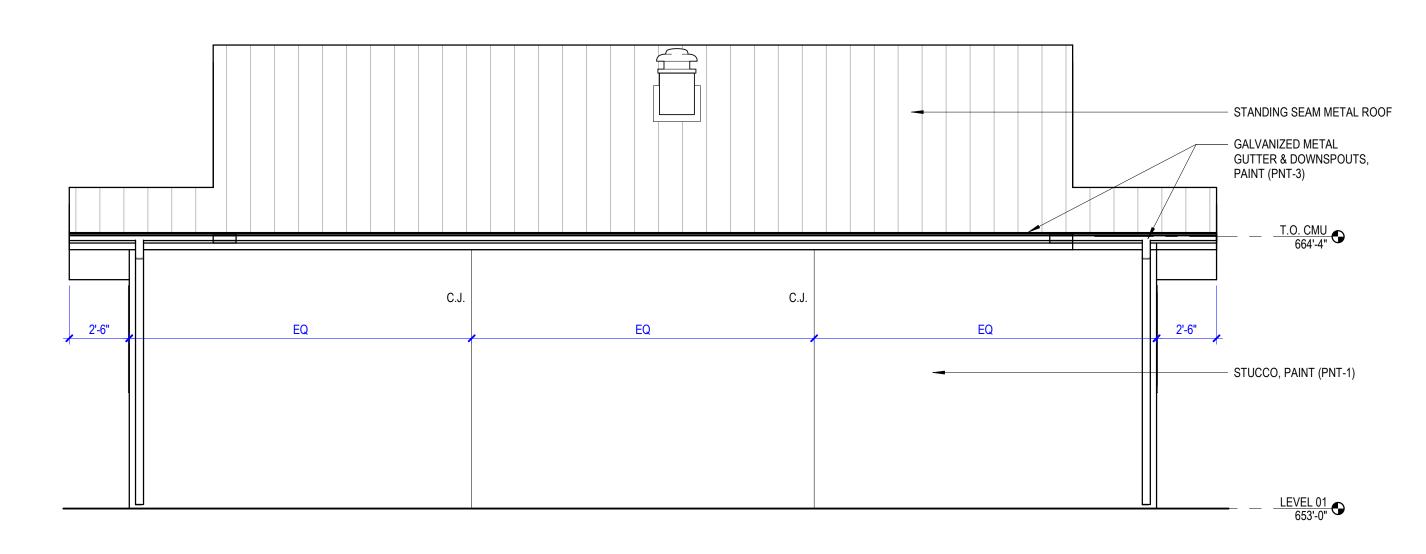

EXTERIOR ELEVATION - NORTH

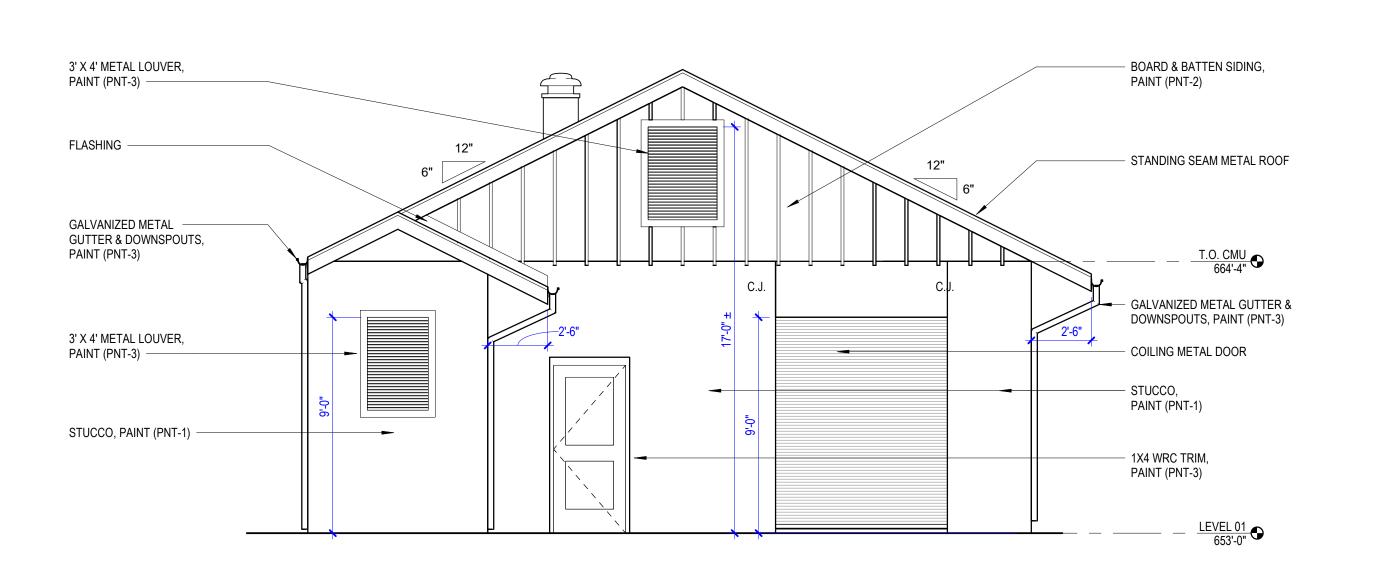

EXTERIOR ELEVATION - WEST



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CONSTRUCTION **DOCUMENT SET**

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FISHER HECK, INC., ARCHITECTS MARK B. NAVARRO #25326

PROJECT

LA VILLITA

MAVERICK PLAZA REHABILITATION

PROJECT ADDRESS 418 VILLITA STREET #9


SAN ANTONIO, TX 78205

OWNER | CLIENT

CITY OF SAN ANTONIO (PW) 114 W. COMMERCE, 6TH FLOOR SAN ANTONIO, TX 78205

SUBCONSULTANT | Fisher Heck

> 915 SOUTH ST MARY'S STREET SAN ANTONIO TEXAS FISHERHECK.COM 210-299-1500

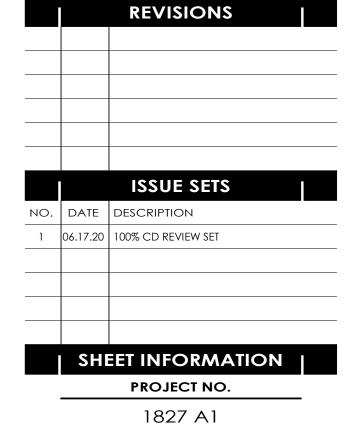

DATE ISSUED JUNE 17, 2020


SHEET NAME


HDRC ELEVATIONS

2-A-601


SHEET NUMBER




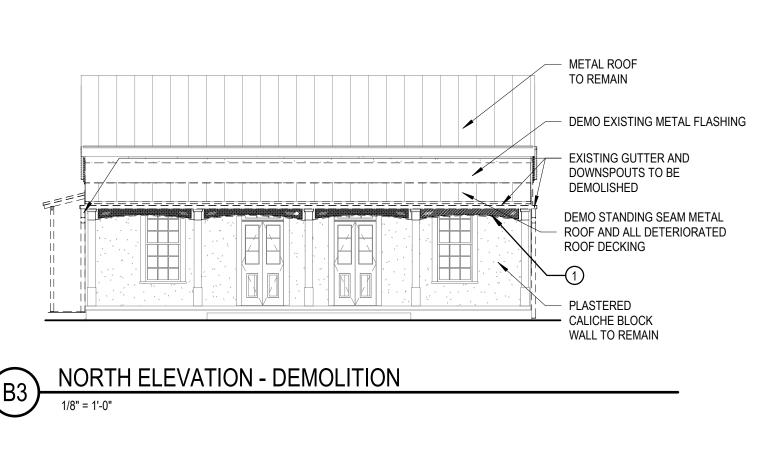

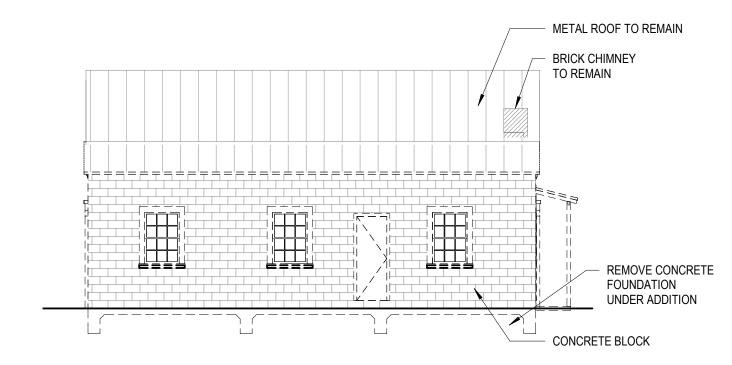




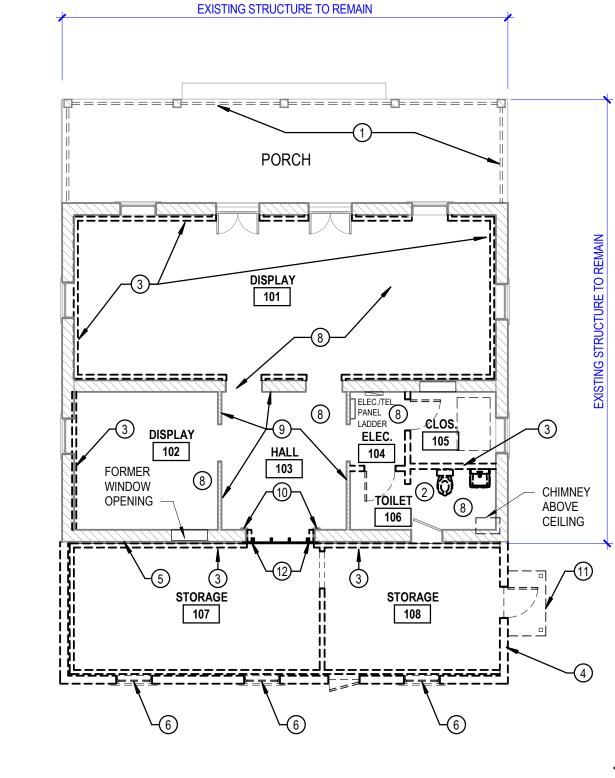

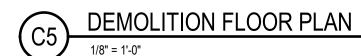

STONE AND CMU WALLS

STONE HOUSE TO REMAIN

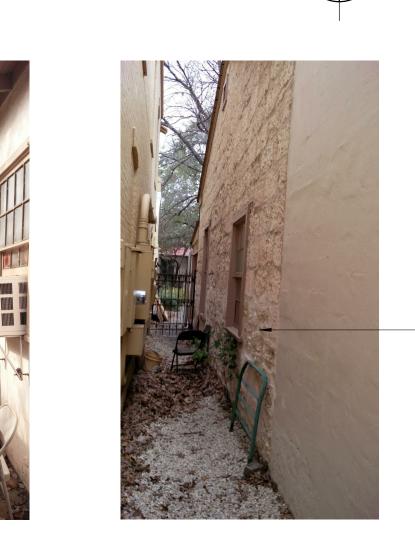

WEST ELEVATION

3/8" = 1'-0"

SOUTH ELEVATION

3/8" = 1'-0"



EAST ELEVATION

3/8" = 1'-0"

GENERAL NOTES

- A. REMOVE AND DISCARD EXISTING AIR CONDITIONING AND HEATING EQUIPMENT
- B. DO <u>NOT</u> REMOVE ANY DOORS OR WINDOWS NOT NOTED FOR
- C. DO <u>NOT</u> REMOVE BASE BOARDS OR OTHER WOODEN TRIM

E. REMOVE AND DISPOSE OF ALL ELECTRICAL EQUIPMENT

- D. REMOVE AND DISPOSE OF EXISTING PLUMBING FIXTURES
- INCLUDING CONDUITS AND LOOSE WIRING F. CAP CHILLED WATER LINES AT THE EXTERIOR OF THE
- BUILDING. REMOVE ALL CHILLED WATER LINES WITHIN THE STRUCTURE
- G. REMOVE EXISTING LADDER TO ATTIC

DEMOLITION KEYNOTES

- REMOVE SIX LATTICE PANELS BETWEEN COLUMNS WITHOUT DAMAGE
- TO ADJACENT CONSTRUCTION REMOVE SUSPENDED ACOUSTICAL CEILING SYSTEM
- REMOVE EXISTING GYP. BRD. AND WOOD FRAMED PARTITIONS
- REMOVE INTACT AND SALVAGE WINDOWS FOR REUSE. CAREFULLY REMOVE T&G PINE FLOOR BOARDS AND SALVAGE FOR REUSE. REMOVE AND DISCARD ALL TILE FLOORING, CARPET, AND ANY
- PLYWOOD FLOOR DECK. WOOD WAINSCOT TO REMAIN AT ALL LOCATIONS
- WOOD TRIM AT MASONRY WALL TO REMAIN REMOVE CANOPY AND CONCRETE STOOP
- 12 REMOVE HOLLOW METAL DOOR FRAME

DEMOLITION KEYNOTES

STONE WALL

UNTOUCHED

TO REMAIN

4" BRICK WALL (TO REMAIN)

EXISTING PARTITION TO BE DEMOLISHED

12" CALICHE BLOCK (TO REMAIN)

PROJECT ADDRESS 418 VILLITA STREET #9

STUDIO

201 GROVETON | SATX 78210

210.314.5582 | MPSTUD.IO

STATUS

100%

CONSTRUCTION

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FISHER HECK, INC., ARCHITECTS

MARK B. NAVARRO #25326

PROJECT

LA VILLITA

MAVERICK PLAZA

REHABILITATION

OWNER | CLIENT CITY OF SAN ANTONIO (PW)

SAN ANTONIO, TX 78205

114 W. COMMERCE, 6TH FLOOR SAN ANTONIO, TX 78205

SUBCONSULTANT **Fisher Heck**

ARCHITECTS

915 SOUTH ST MARY'S STREET SAN ANTONIO TEXAS FISHERHECK.COM 210-299-1500

REVISIONS ISSUE SETS NO. DATE DESCRIPTION 1 06.17.20 100% CD REVIEW SET

SHEET INFORMATION

PROJECT NO. 1827 A1

DATE ISSUED

JUNE 17, 2020

SHEET NAME

DEMOLITION PLANS & **ELEVATIONS**

SHEET NUMBER

1-A-010

SOUTH ELEVATION - FROM PLAZA

3/8" = 1'-0"

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EXISTING STRUCTURE TO REMAIN

PLASTERED

CALICHE BLOCK

WALL TO REMAIN

DEMO STANDING SEAM

METAL ROOF AND ALL DETERIORATED ROOF

PORCH COLUMN AND

BEAM TO REMAIN

DECKING






TO REMAIN ON BOTH SIDES OF OPENING WAINSCOT TO REMAIN

HALL 103 LOOKING EAST




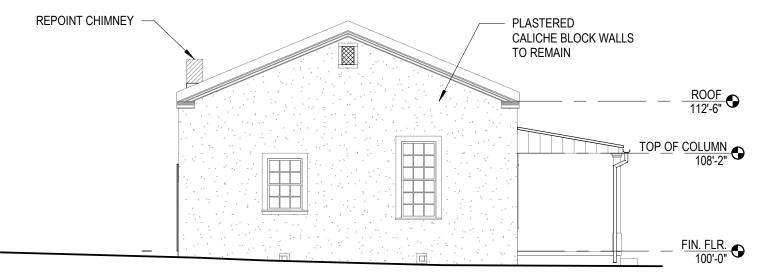





B1 EAST ELEVATION

1/8" = 1'-0"

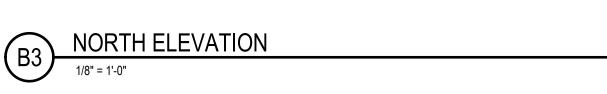


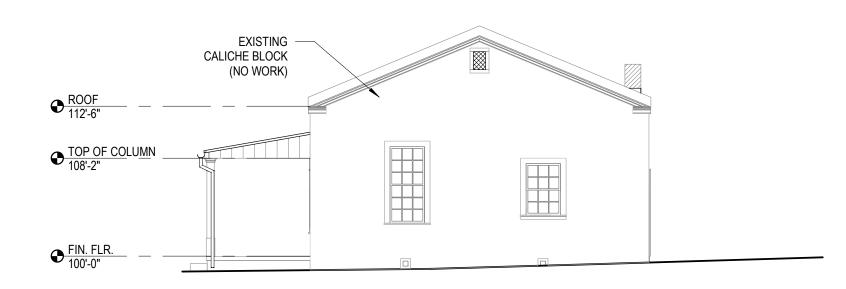


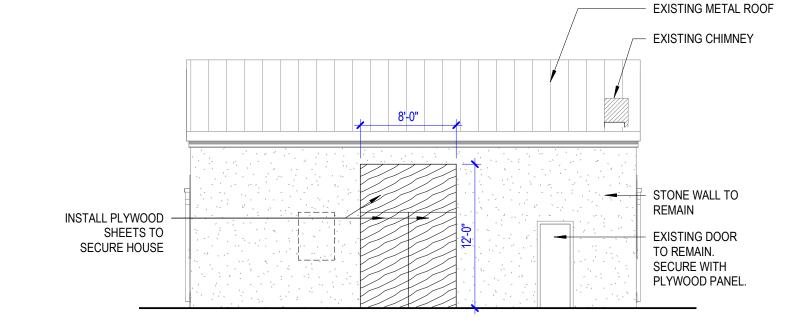


WEST ELEVATION




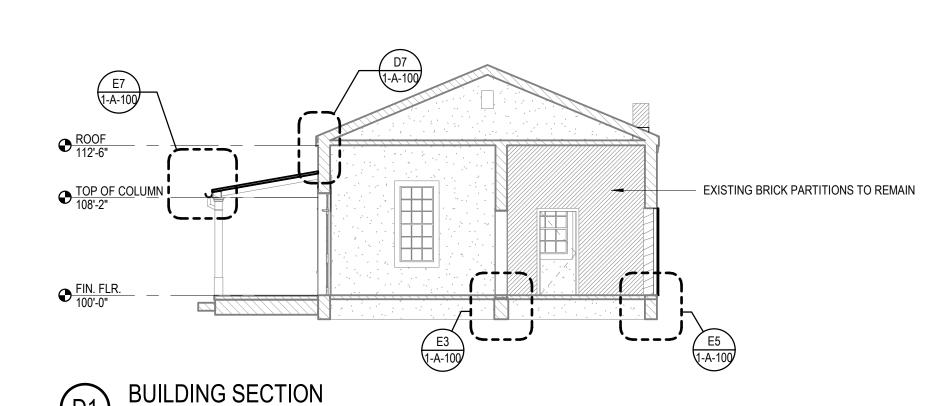

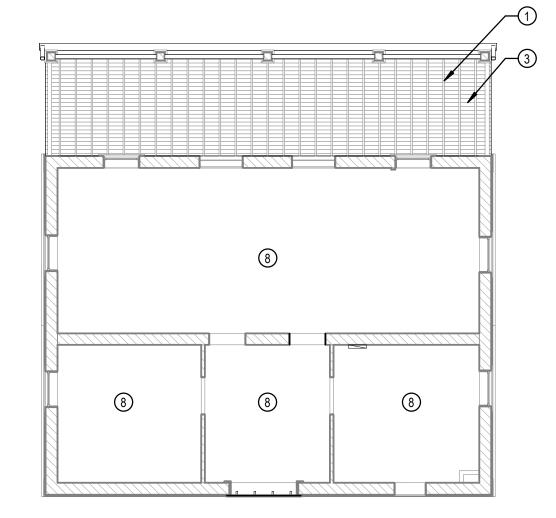


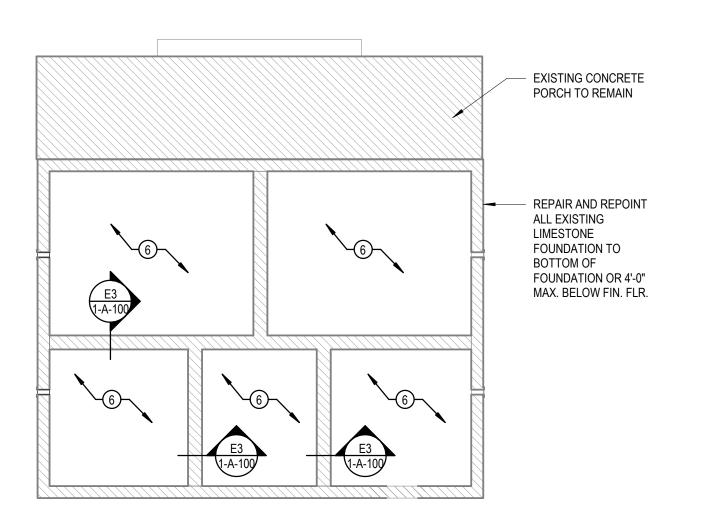


REFLECTED CEILING PLAN

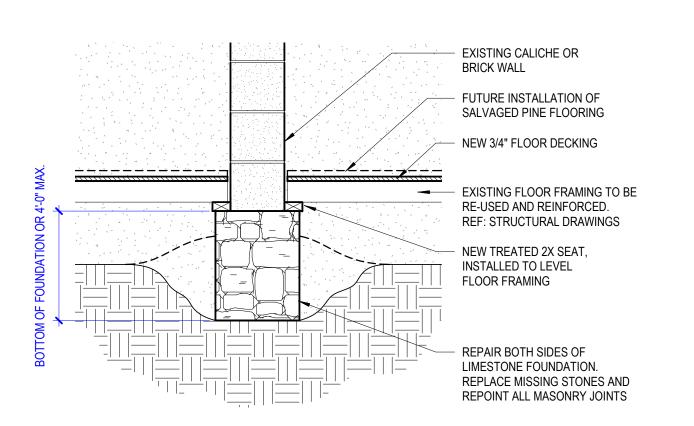

TYPICAL INTERIOR WALL FOOTING

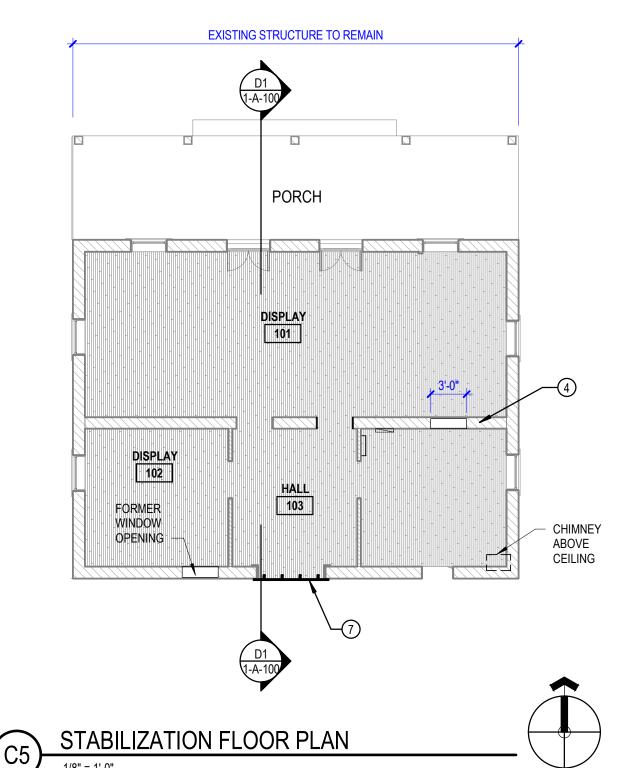

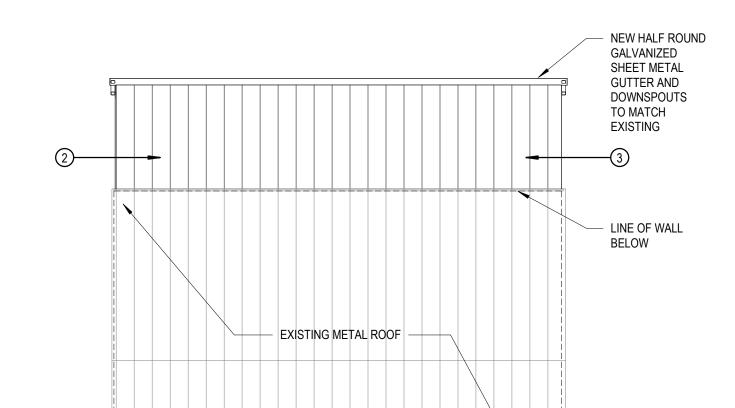


BRICK CHIMNEY

PROVIDE NEW SHEET METAL

FLASHING

TO REMAIN AND BE REPOINTED

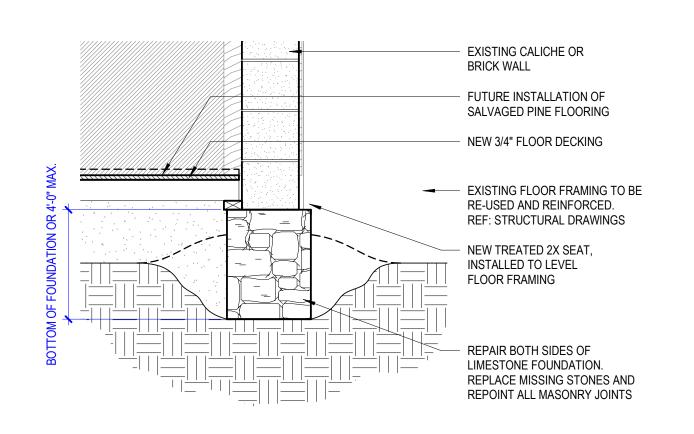

TYPICAL EXTERIOR WALL FOOTING

STABILIZATION KEYNOTES

- 1 REPLACE 2X IF FOUND TO BE DETERIORATED. ALLOW FOR 12
- REPLACE EXISTING STANDING SEAM METAL ROOF WITH NEW
- STANDING SEAM METAL ROOF REPLACE ALL DETERIORATED ROOF DECKING WITH NEW DECKING
- TO MATCH 50% REPAIR CRACK IN MASONRY WALL
- REMOVE DEBRIS FROM CRAWL SPACE. REMOVE SOIL TO EXPOSE SIDES OF LIMESTONE FOOTINGS, AND REPOINT FACES OF
- FOOTINGS SECURE EXISTING DOOR OPENING WITH 3/4" PLYWOOD ON 2X4
- STUD FRAMING 8 NO WORK ON EXISTING CEILING

STABILIZATION KEYNOTES



4" BRICK WALL (TO REMAIN)

12" CALICHE BLOCK (TO REMAIN) **NEW WALL**



STUDIO

201 GROVETON | SATX 78210

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LA VILLITA

PROJECT

MAVERICK PLAZA

REHABILITATION

PROJECT ADDRESS 418 VILLITA STREET #9

SAN ANTONIO, TX 78205

SUBCONSULTANT |


915 SOUTH ST MARY'S STREET SAN ANTONIO TEXAS FISHERHECK.COM

210-299-1500


Fisher Heck

OWNER | CLIENT

CITY OF SAN ANTONIO (PW) 114 W. COMMERCE, 6TH FLOOR SAN ANTONIO, TX 78205

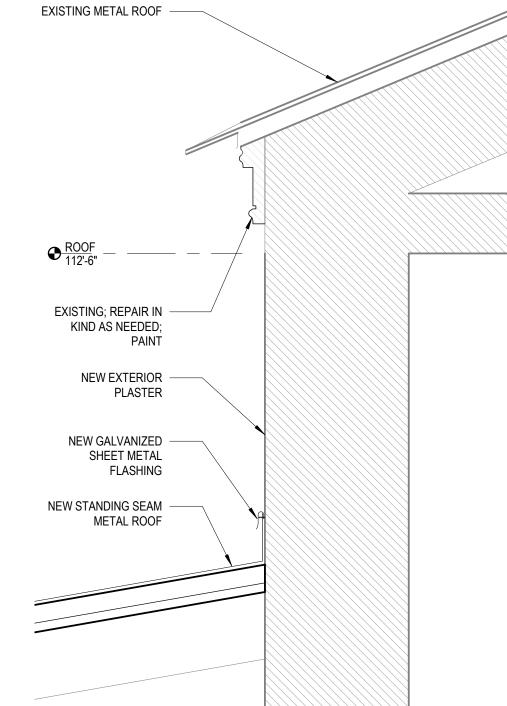



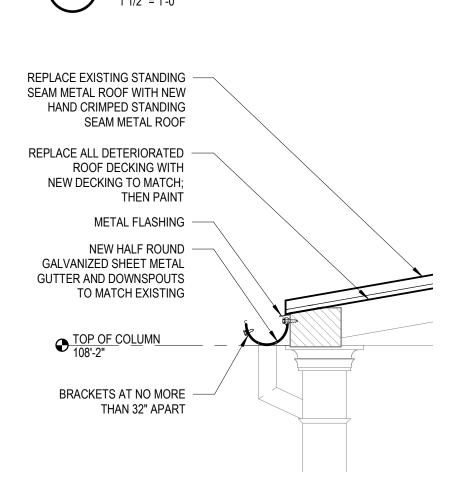

ROOF SECTION

PORCH/COLUMN SECTION

REVISIONS ISSUE SETS NO. DATE DESCRIPTION 1 06.17.20 100% CD REVIEW SET SHEET INFORMATION PROJECT NO. 1827 A1

> JUNE 17, 2020 SHEET NAME


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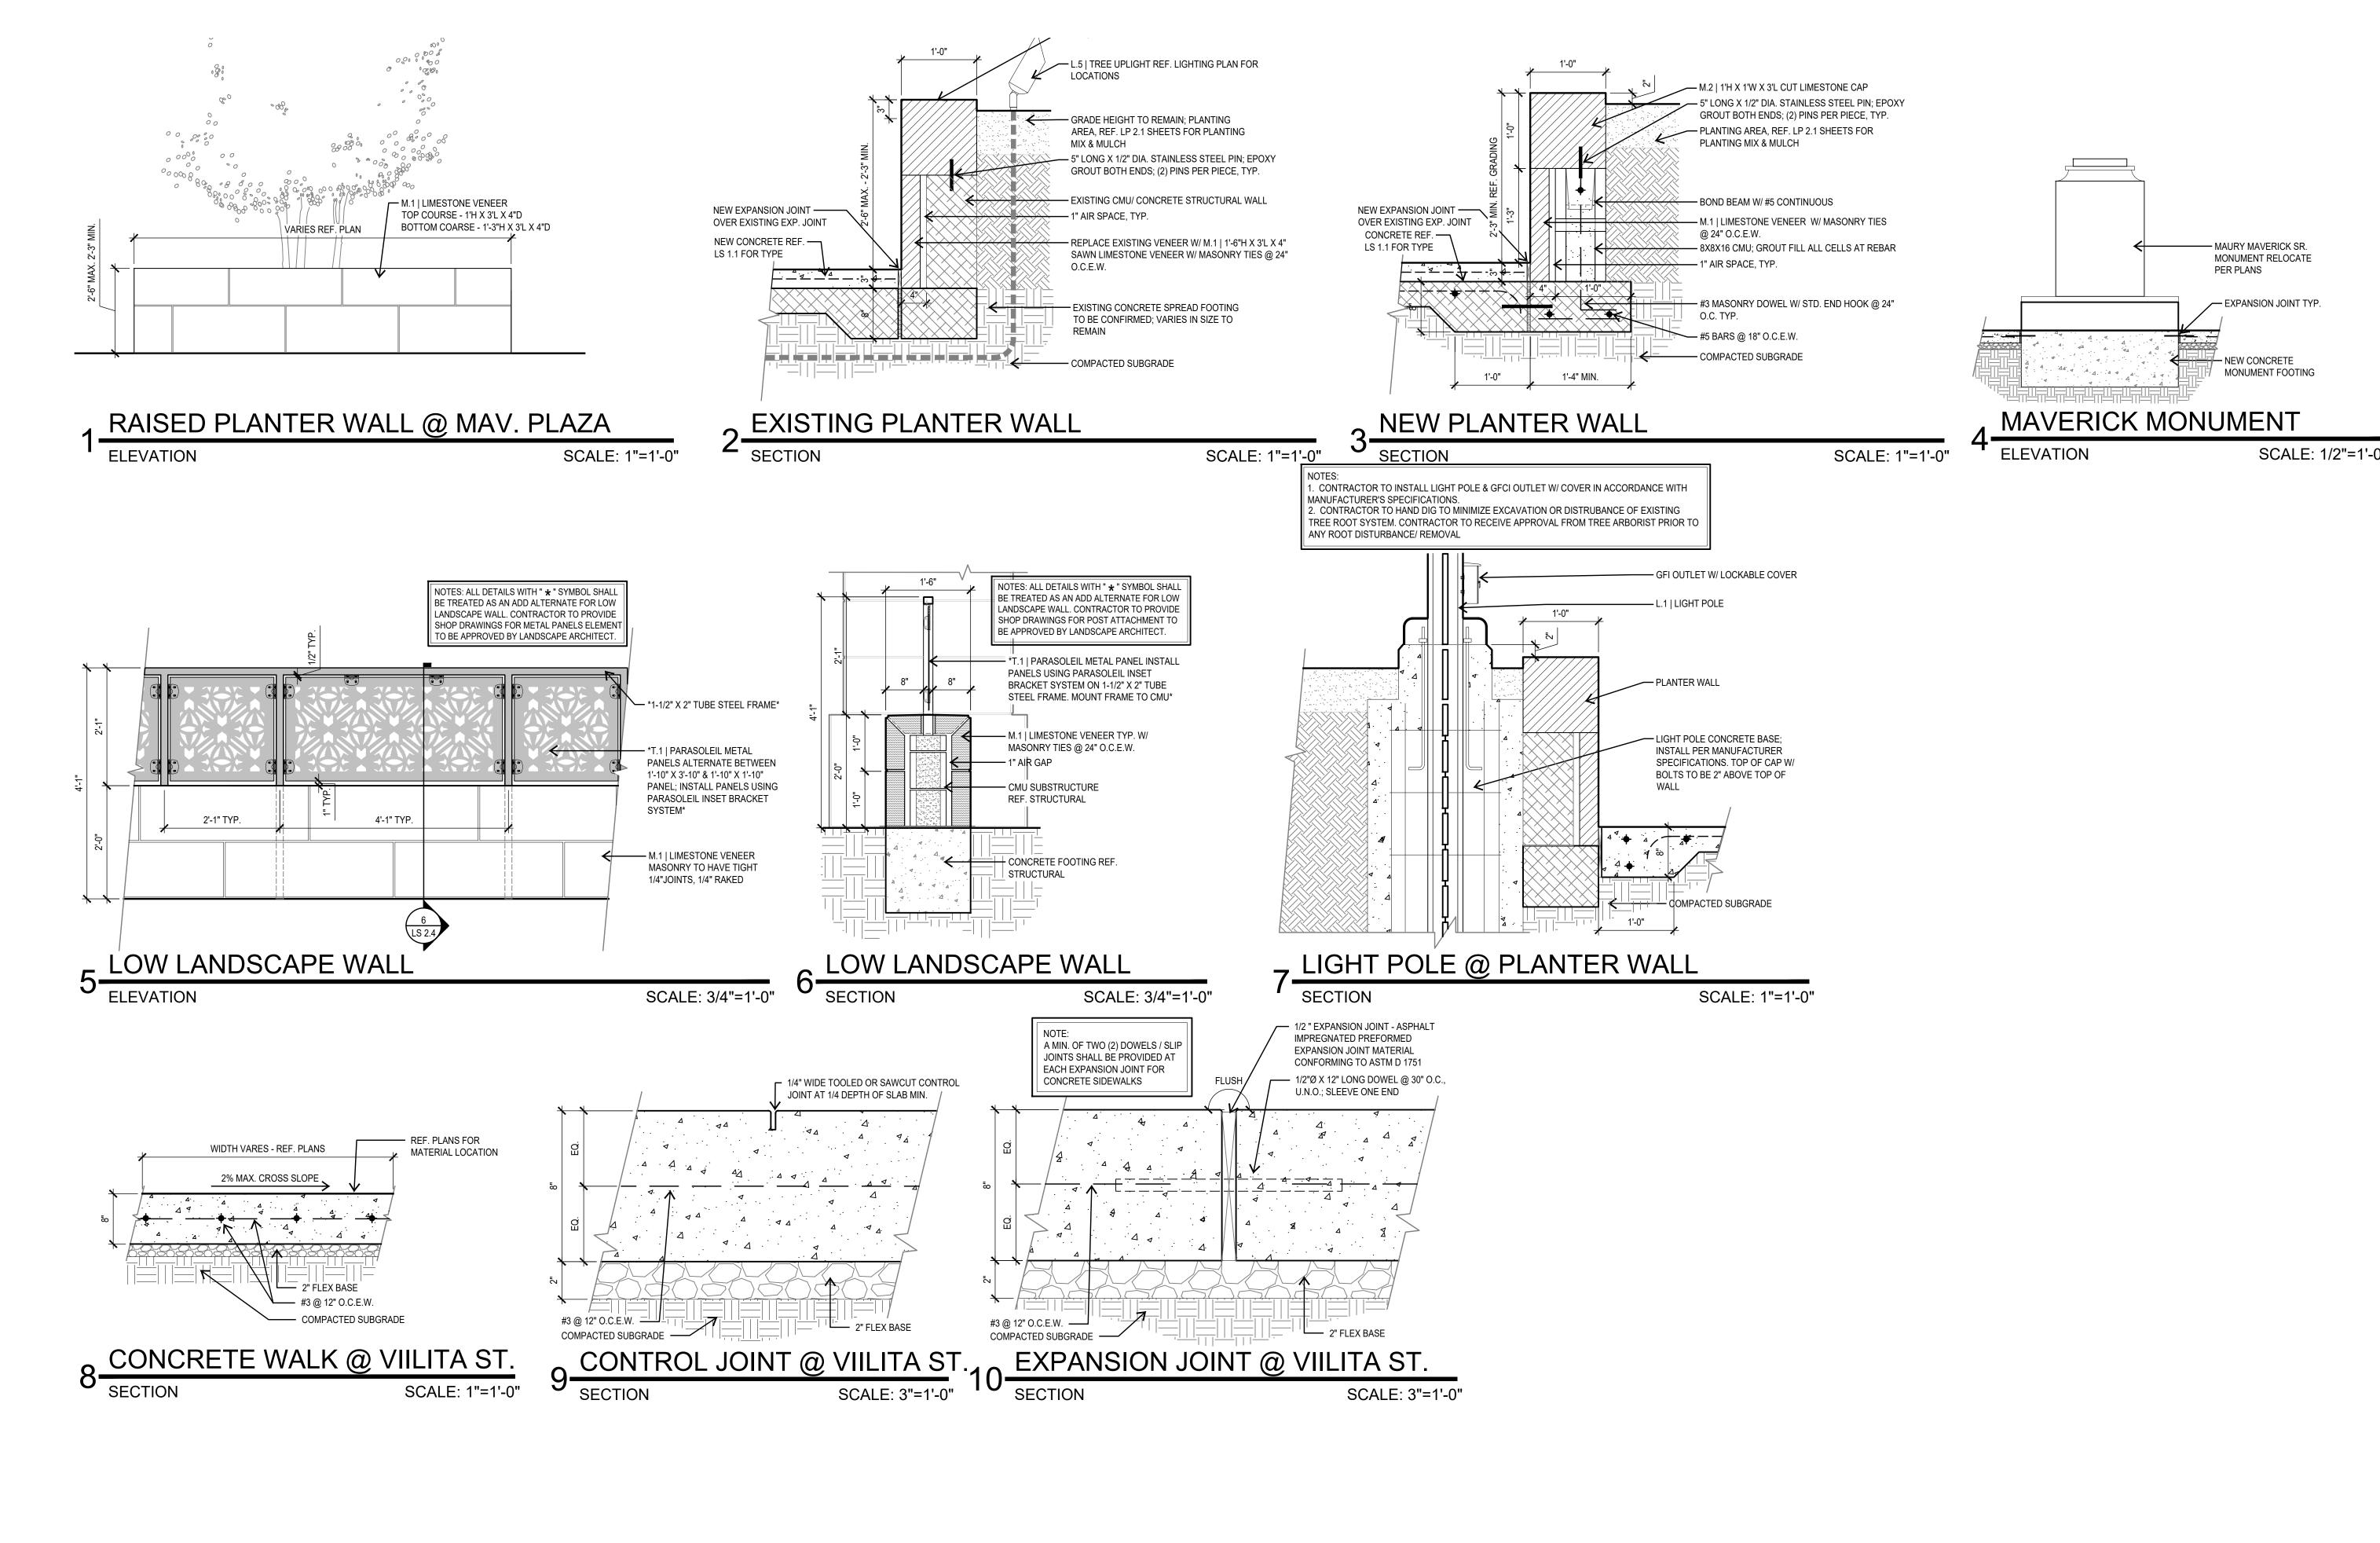
STABILIZATION PLANS AND **ELEVATIONS**

1-A-100

SHEET NUMBER

FOUNDATION PLAN



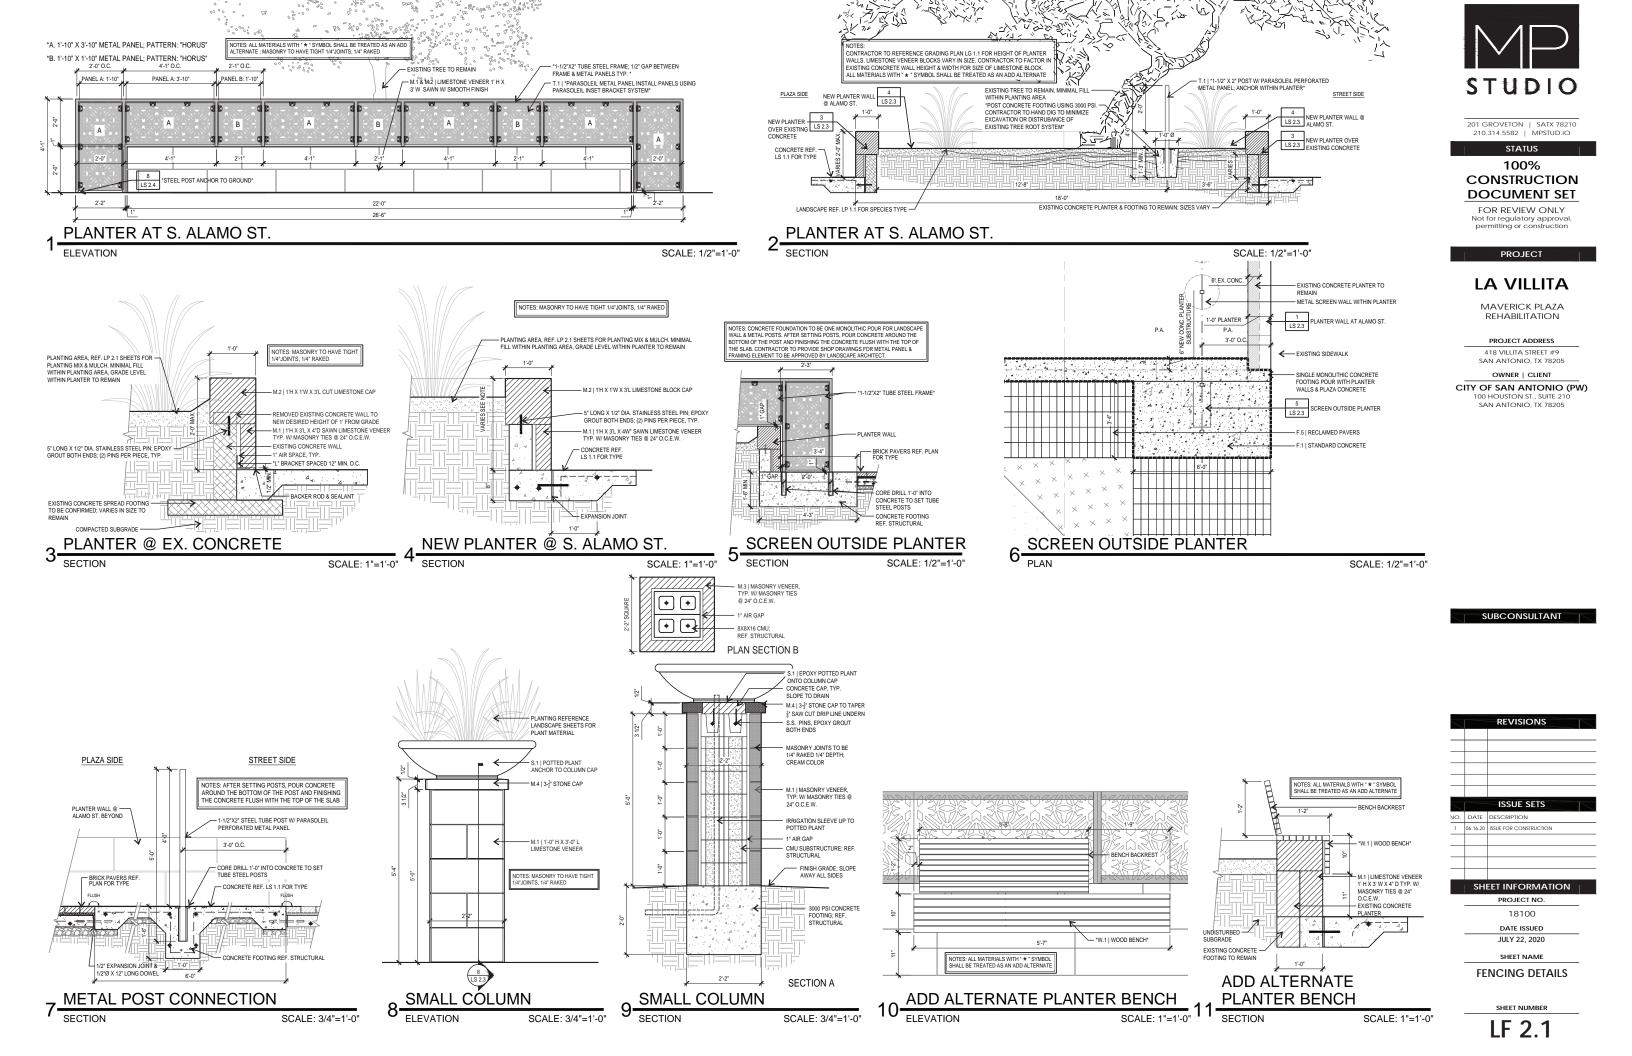

STUDIO

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> STATUS 100%

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PROJECT

LA VILLITA

MAVERICK PLAZA REHABILITATION

PROJECT ADDRESS

418 VILLITA STREET #9 SAN ANTONIO, TX 78205

OWNER | CLIENT

CITY OF SAN ANTONIO (PW)

114 W. COMMERCE, 6TH FLOOR SAN ANTONIO, TX 78205

SUBCONSULTANT

ISSUE SETS

NO. DATE DESCRIPTION

1 06.01.20 100% CD REVIEW SET

SHEET INFORMATION
PROJECT NO.

18100


JUNE 1, 2020 SHEET NAME


SITE DETAILS
PLANTERS @ MAVERICK

DATE ISSUED

PLAZA
SHEET NUMBER

LS 2.4

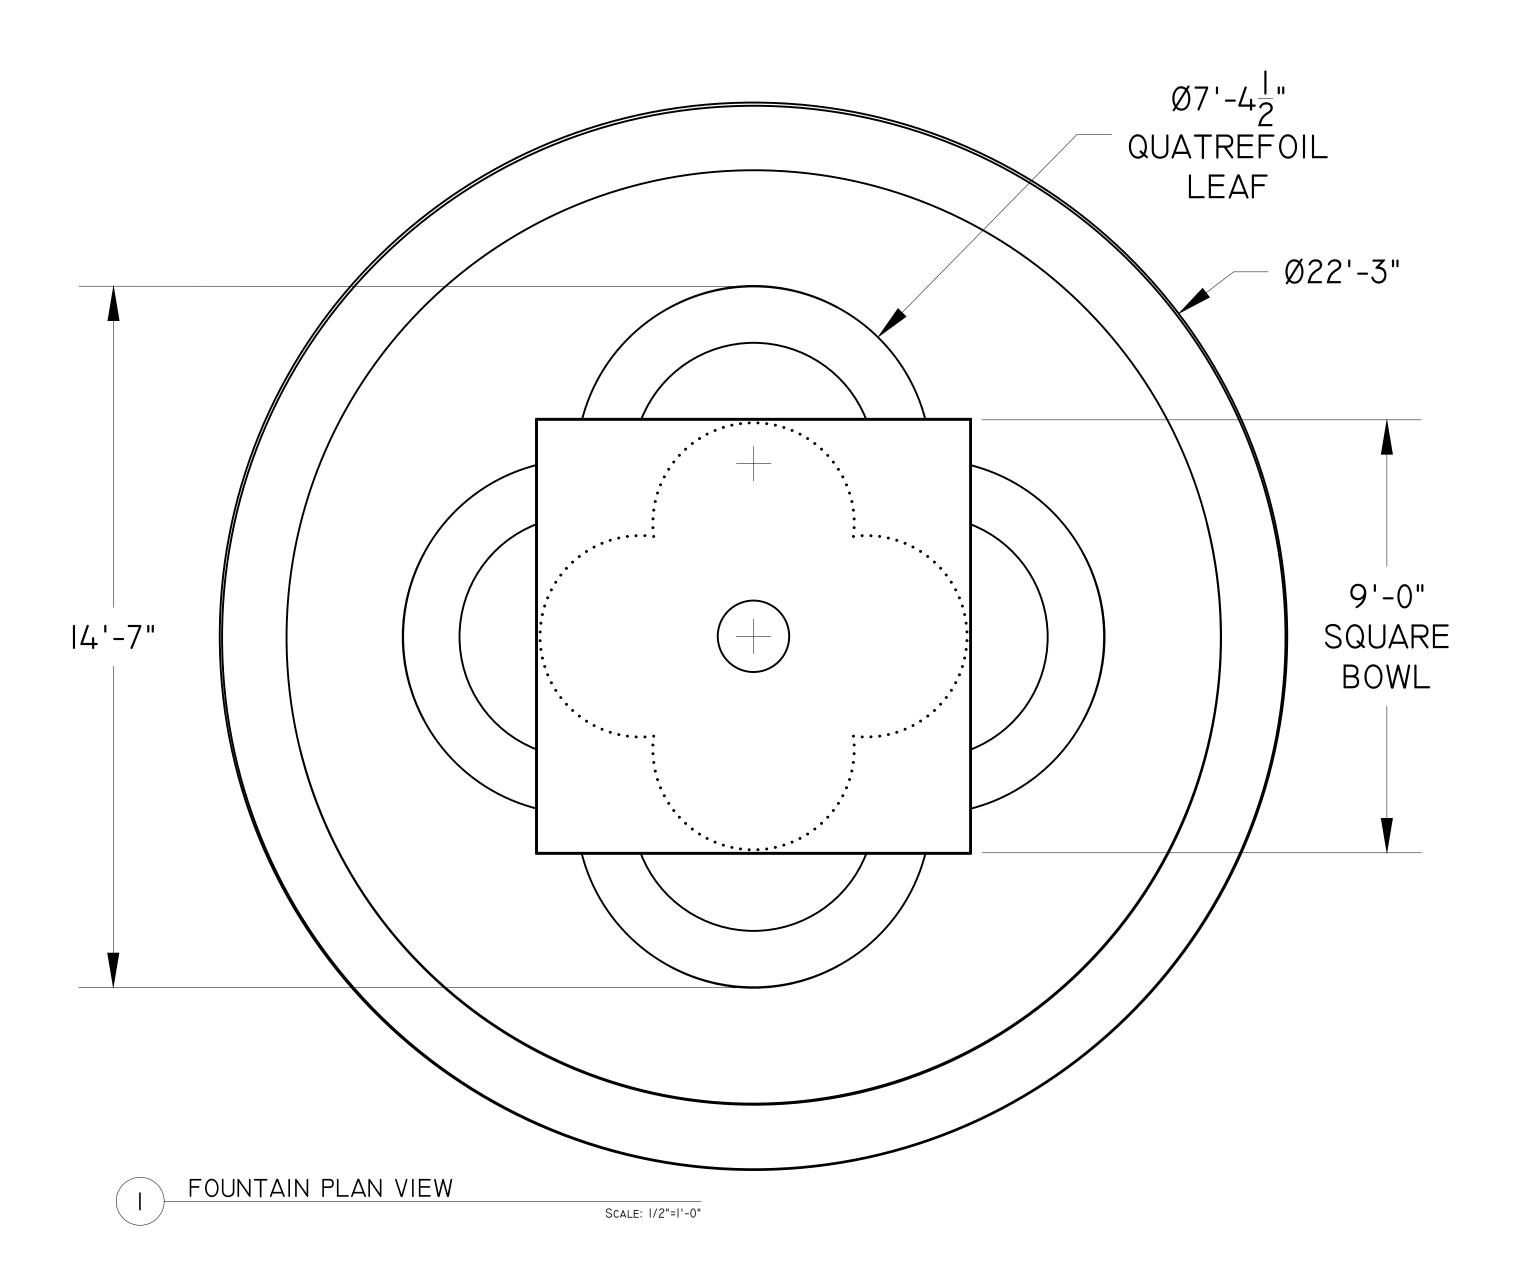

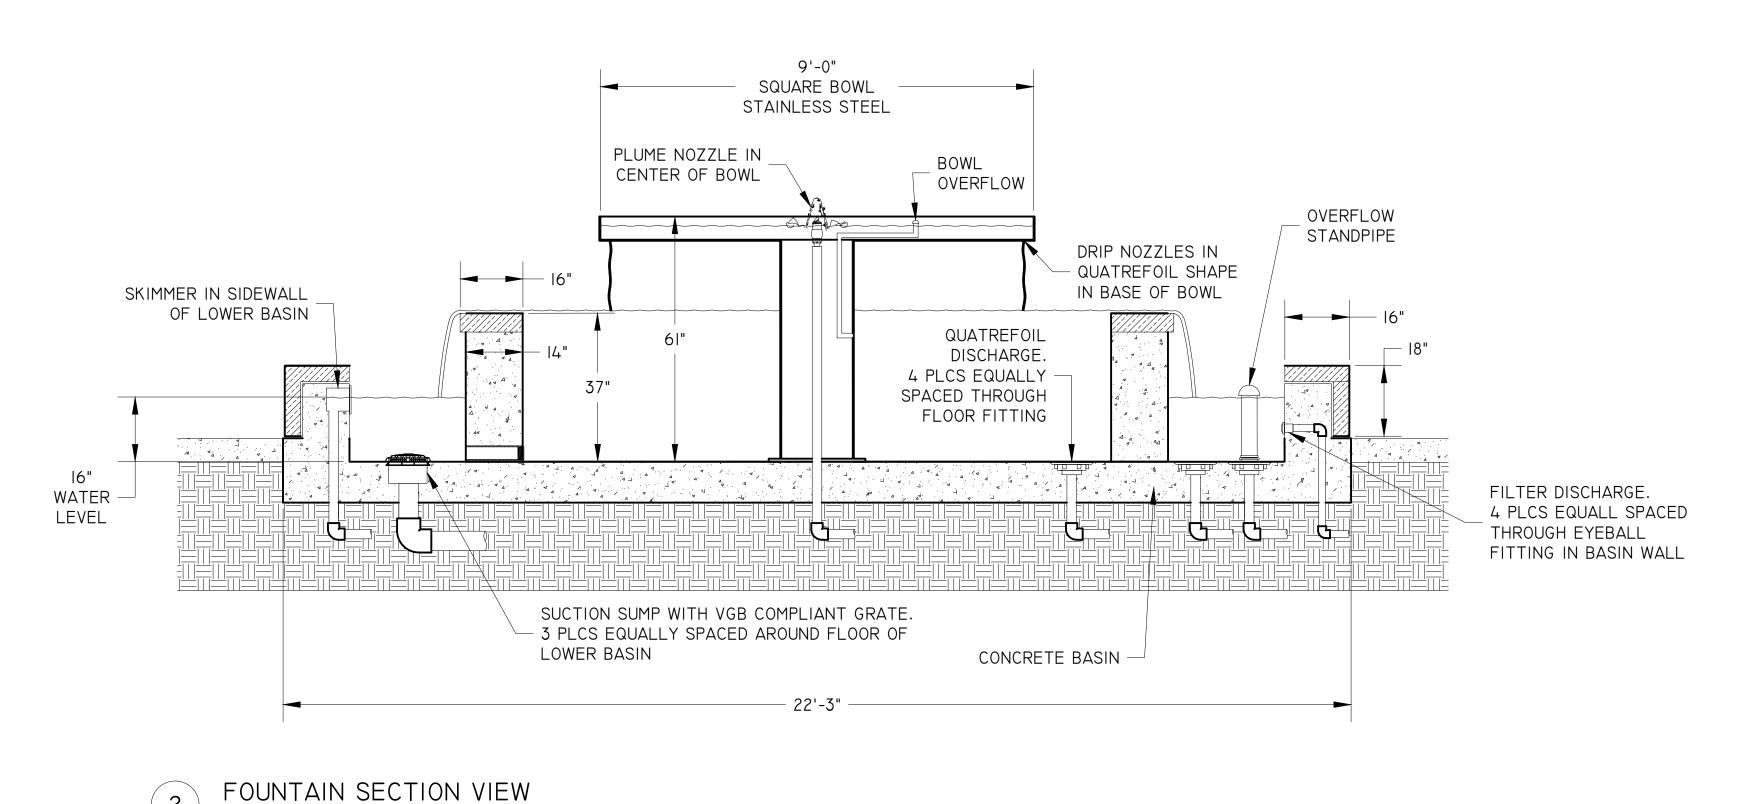

SCALE: 1/2"=1'-0"

Fountain Description:


La Villita Maverick Plaza Fountain shall be circular in shape with an approximate outer diameter of 22'-3". The exterior basin wall and coping shall be veneered with limestone. Basin interior wall and floor shall be tiled. The fountain inside shall contain a large custom formed quatrefoil shaped basin with limestone veneered coping. Within the center of the quatrefoil basin, a custom metal pedestal elevated 9ft square bowl shall be located.

The center custom 9ft square bowl shall contain a center cascade nozzle that shall create frothy foamy white-water effect approximately +/-3ft up in the air and will be illuminated by a submersible color changing LED ring light fixture. The center square bowl will also contain a multitude of small perimeter gravity nozzles, penetrating downward thru the square bowl in a shape of a quatrefoil. As the square bowl is filled with water from the center cascade nozzle, water shall flow thru the multitude of small gravity nozzles downward into the quatrefoil basin below, thus creating a gravity rain curtain effect in a quatrefoil outline.

Water from the custom metal 9ft square bowl shall fill the large custom formed quatrefoil shaped basin, additional water will also be introduced thru floor mounted discharge diffuser assemblies and overflow the perimeter edges of the quatrefoil basin. The high flow of water over the quatrefoil basin edges will create a shear waterfall effect. Floor standing submersible color changing LED light fixtures shall be located within the custom formed quatrefoil basin and will illuminate the underside of the custom metal 9ft square bowl as well as the multitude of gravity rain curtain nozzles.

Suction sumps, eyeball fittings, skimmers, and all other required fountain basin components shall be located within the lower fountain basin. Water depth shall be 18" in the lower basin.

Fully pre-assembled custom equipment skid system shall be provided for quick installation onto the concrete housekeeping pad.

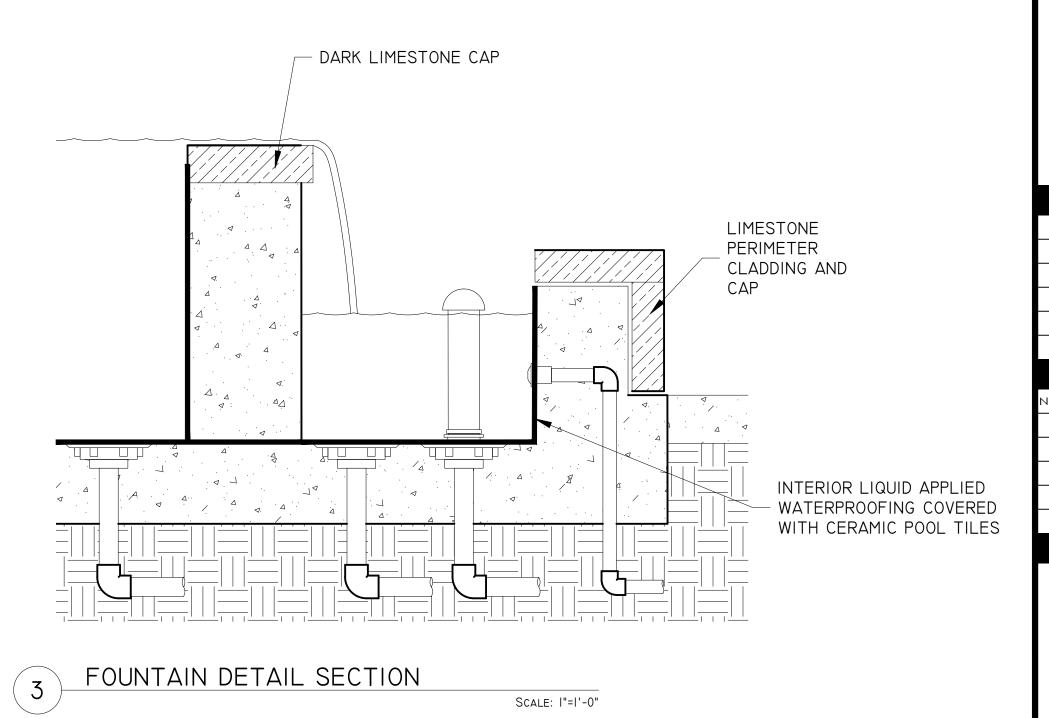



201 GROVETON | SATX 78210 210.314.5582 | MPSTUD.IO

100%

STATUS

CONSTRUCTION DOCUMENT SET

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PROJECT

LA VILLITA

MAVERICK PLAZA

PROJECT ADDRESS

418 VILLITA STREET #9 SAN ANTONIO, TX 78205

OWNER | CLIENT

CITY OF SAN ANTONIO (TCI)
114 W. COMMERCE, 6TH FLOOR
SAN ANTONIO, TX 78205

SUBCONSULTANT

REVISIONS

ISSUE SETS

10.	DATE	DESCRIPTION
1	05.01.20	100% CD REVIEW SET

SHEET INFORMATION

PROJECT NO. 18100 DATE ISSUED


MAY 1, 2020

SHEET NAME

FOUNTAIN LAYOUT & DETAILS

SHEET NUMBER

WF-3.00

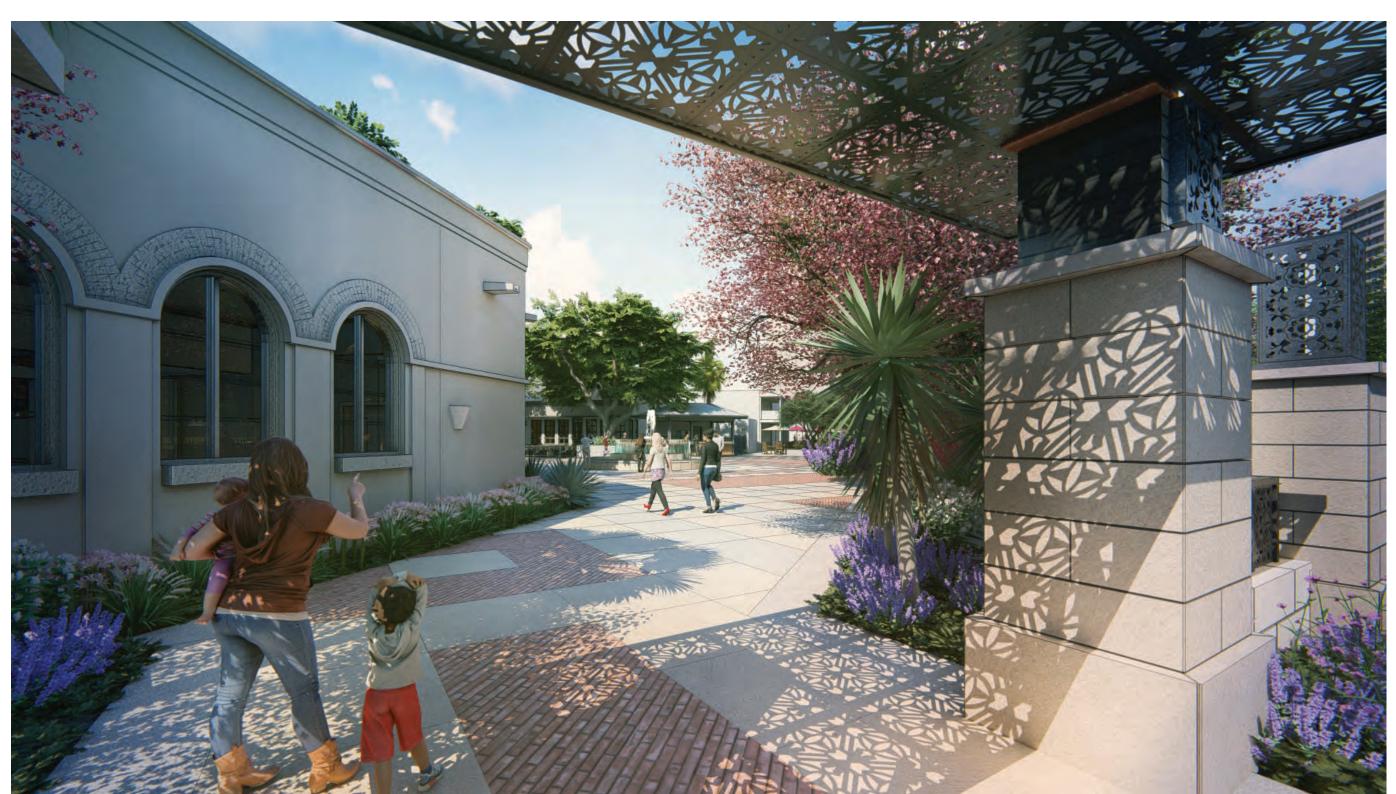



STATUS

100% CONSTRUCTION DOCUMENT SET

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PROJECT

LA VILLITA

MAVERICK PLAZA REHABILITATION

PROJECT ADDRESS

418 VILLITA STREET #9 SAN ANTONIO, TX 78205

OWNER | CLIENT

CITY OF SAN ANTONIO (PW)
100 HOUSTON ST., SUITE 210
SAN ANTONIO, TX 78205

SUBCONSULTANT

$\overline{}$		REVISIONS	
$\overline{\ }$		ISSUE SETS	
NO.	DATE	DESCRIPTION	
1	06.16.20	ISSUE FOR CONSTRUCTION	

SHEET INFORMATION


PROJECT NO.

18100

DATE ISSUED

JULY 22, 2020 SHEET NAME

ENTRY MONUMENT

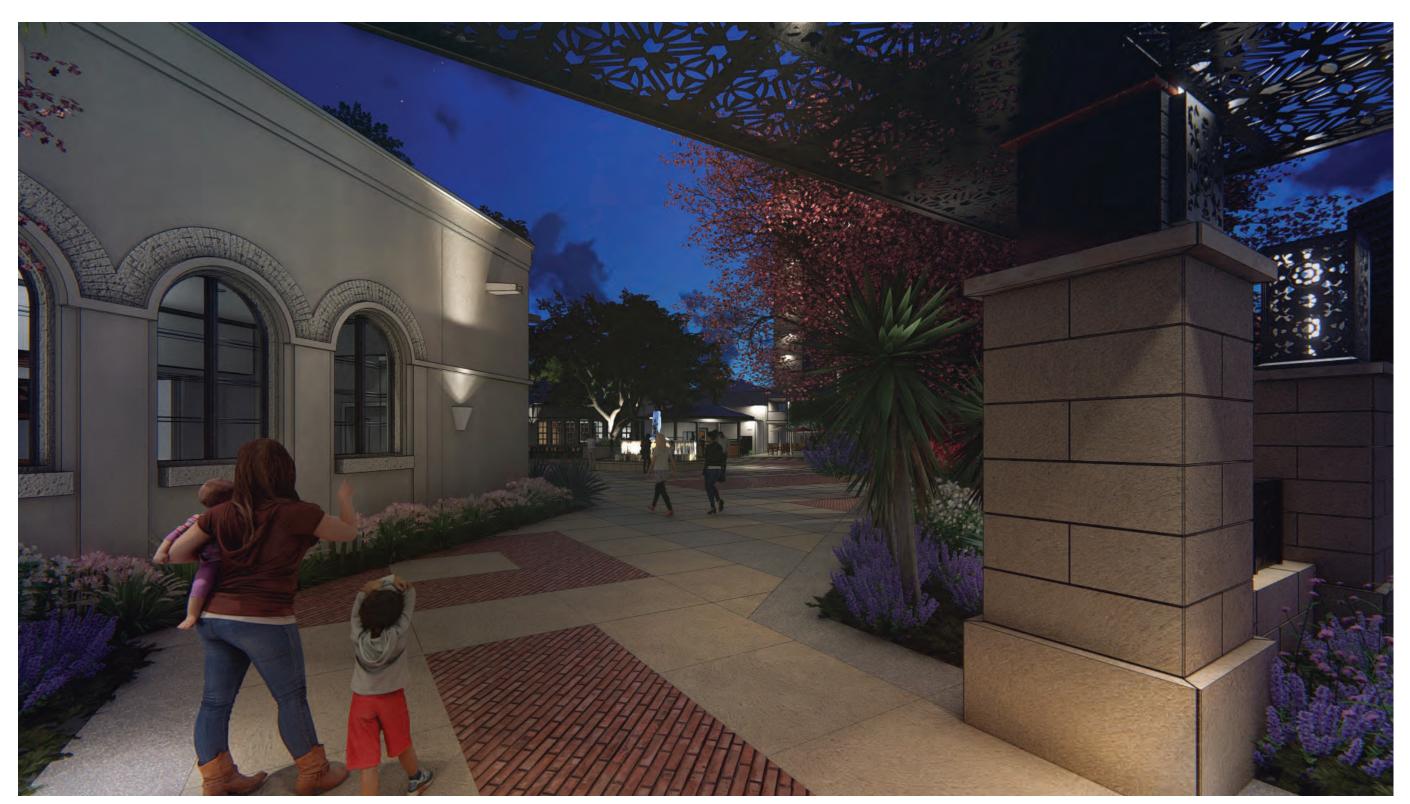



STATUS

100% CONSTRUCTION **DOCUMENT SET**

FOR REVIEW ONLY Not for regulatory approval, permitting or construction

PROJECT

LA VILLITA

MAVERICK PLAZA REHABILITATION

PROJECT ADDRESS

418 VILLITA STREET #9 SAN ANTONIO, TX 78205

OWNER | CLIENT

CITY OF SAN ANTONIO (PW) 100 HOUSTON ST., SUITE 210 SAN ANTONIO, TX 78205

SUBCONSULTANT

		REVISIONS	
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		ISSUE SETS	
NO.	DATE	DESCRIPTION	
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1	06.16.20	ISSUE FOR CONSTRUCTION	
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SHEET INFORMATION

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DATE ISSUED

JULY 22, 2020

SHEET NAME **ENTRY MONUMENT**





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PROJECT ADDRESS

418 VILLITA STREET #9 SAN ANTONIO, TX 78205

OWNER | CLIENT

CITY OF SAN ANTONIO (PW)
100 HOUSTON ST., SUITE 210
SAN ANTONIO, TX 78205

SUBCONSULTANT

		REVISIONS	
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		ISSUE SETS	
NO.	DATE	DESCRIPTION	
1	06.16.20	ISSUE FOR CONSTRUCTION	

SHEET INFORMATION

PROJECT NO.

18100

JULY 22, 2020

SHEET NAME

VILLITA STREET ENTRY





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PROJECT

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CITY OF SAN ANTONIO (PW)
100 HOUSTON ST., SUITE 210
SAN ANTONIO, TX 78205

SUBCONSULTANT

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$\overline{\ }$	ISSUE SETS	

NO. DATE DESCRIPTION 1 06.16.20 SSUE FOR CONSTRUCTION

SHEET INFORMATION

PROJECT NO.

1810

DATE ISSUED

JULY 22, 2020 SHEET NAME

ALAMO STREET PLANTER WALL





STATUS

100% CONSTRUCTION **DOCUMENT SET**

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PROJECT

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418 VILLITA STREET #9 SAN ANTONIO, TX 78205

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SUBCONSULTANT

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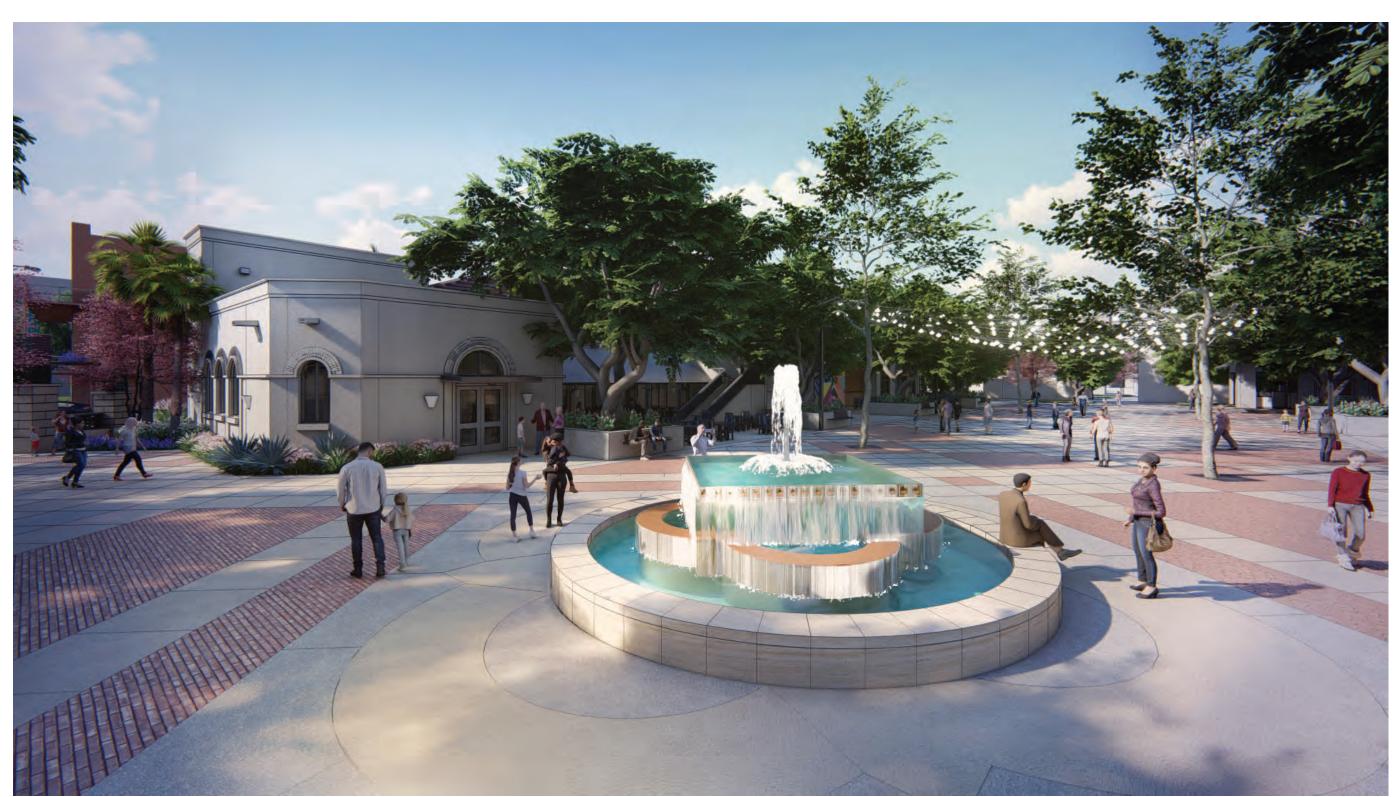
SHEET INFORMATION

PROJECT NO.

DATE ISSUED

JULY 22, 2020

SHEET NAME PLAZA FOUNTAIN





STATUS

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PROJECT

LA VILLITA

MAVERICK PLAZA REHABILITATION

PROJECT ADDRESS

418 VILLITA STREET #9 SAN ANTONIO, TX 78205

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100 HOUSTON ST., SUITE 210
SAN ANTONIO, TX 78205

SUBCONSULTANT

		REVISIONS
		ISSUE SETS
NO.	DATE	DESCRIPTION

NO. DATE DESCRIPTION 1 06.16.20 ISSUE FOR CONSTRUCTION

SHEET INFORMATION

PROJECT NO.

18100

JULY 22, 2020

SHEET NAME

PLAZA FOUNTAIN





STATUS

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PROJECT

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418 VILLITA STREET #9 SAN ANTONIO, TX 78205

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CITY OF SAN ANTONIO (PW)
100 HOUSTON ST., SUITE 210
SAN ANTONIO, TX 78205

SUBCONSULTANT

		REVISIONS	
		ISSUE SETS	
NO.	DATE	DESCRIPTION	
1	06.16.20	ISSUE FOR CONSTRUCTION	

SHEET INFORMATION


PROJECT NO.

18100

JULY 22, 2020

SHEET NAME

PLAZA FOUNTAIN

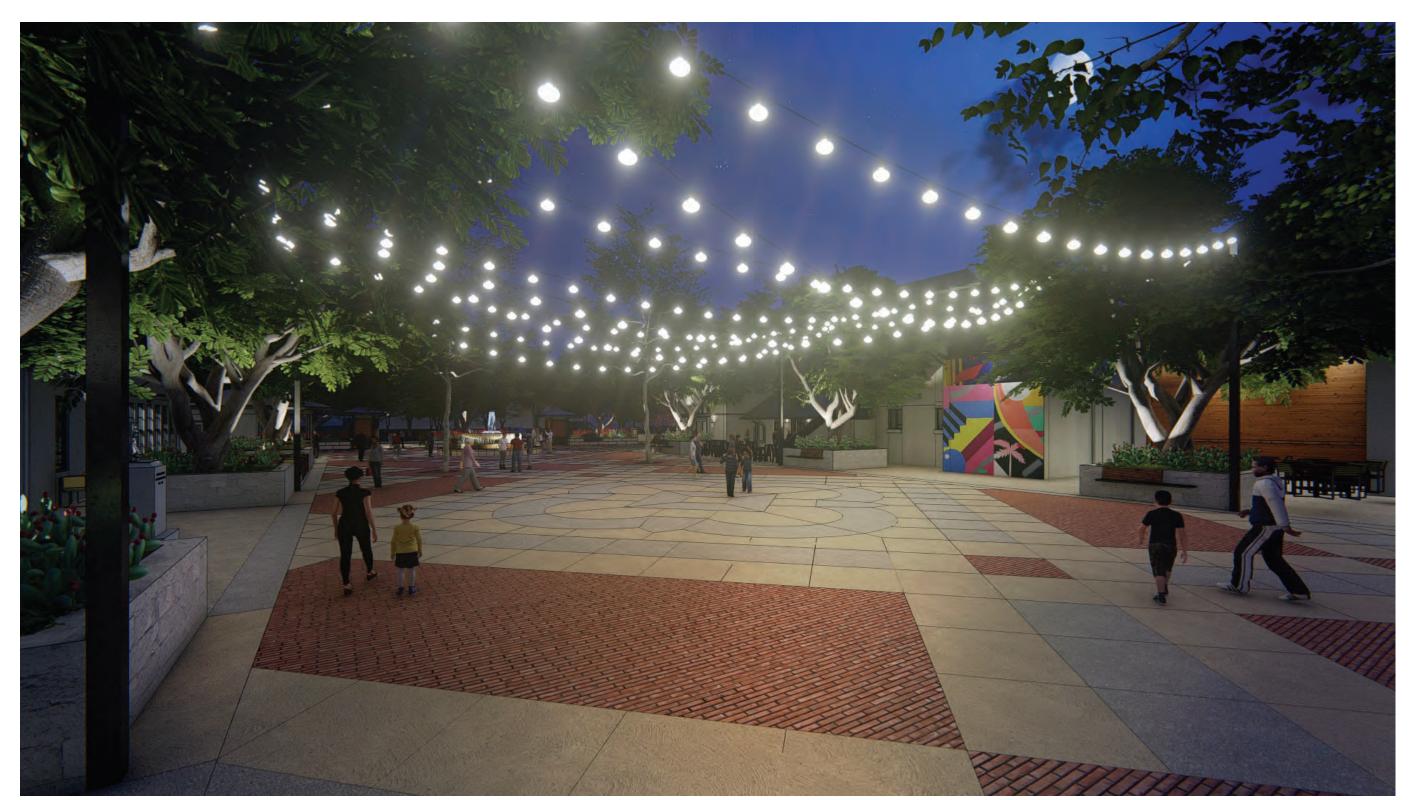



STATUS

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418 VILLITA STREET #9 SAN ANTONIO, TX 78205

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CITY OF SAN ANTONIO (PW)
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SAN ANTONIO, TX 78205

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PROJECT NO.

DATE ISSUED

JULY 22, 2020

SHEET NAME PLAZA FOUNTAIN





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PROJECT NO.


18100

JULY 22, 2020


SHEET NAME

PLAZA FOUNTAIN




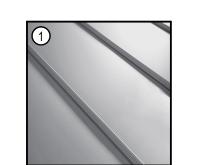

ROOF: STANDING-SEAM, GALVANIZED UNPAINTED

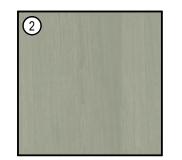


EXTERIOR WALLS, SILLS, FASCIA, AND SOFFIT: WOOD PAINTED (SW 6192)

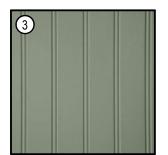


EXTERIOR WALLS: BEADED BOARD PANELS


PAINTED (SW 6186)

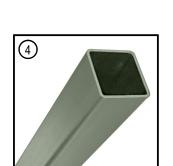


EXPOSED COLUMNS: **HOLLOW SECTION** PAINTED (SW 6186)

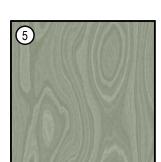


WOODEN PANELS: PLYWOOD PAINTED (SW 6192)

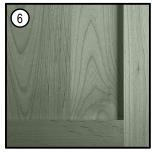


WOODEN DOORS: WOOD EDGE (1X) PAINTED (SW 6186)

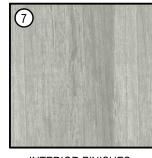


INTERIOR FINISHES: WOOD PAINTED (SW 6197)

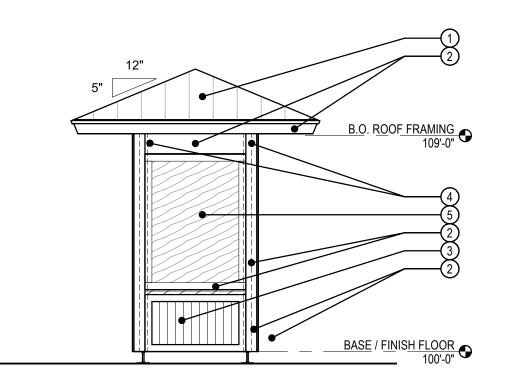

SIDE ELEVATION - SMALL KIOSK (A)

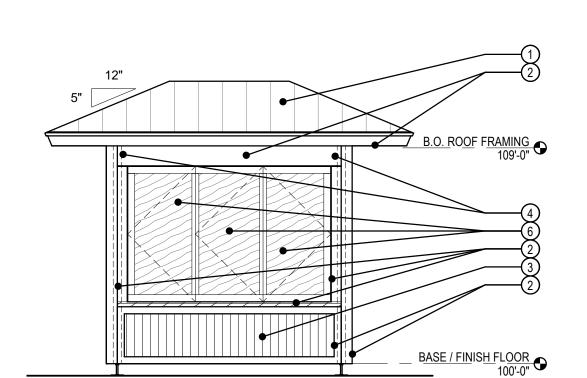


FRONT ELEVATION - SMALL KIOSK (A)

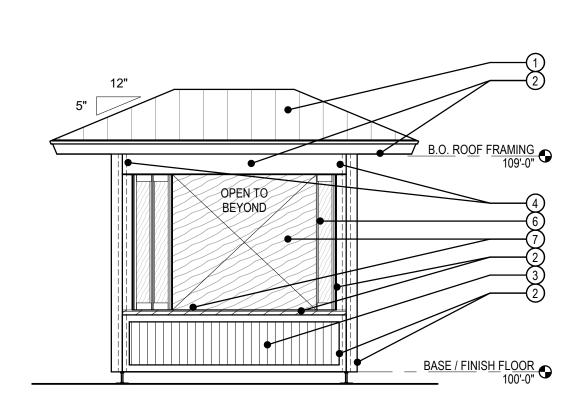


FRONT ELEVATION - SMALL KIOSK (A)


SMALL KIOSK (B)

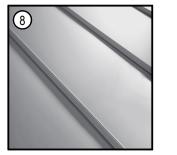


ROOF: STANDING-SEAM, GALVANIZED UNPAINTED

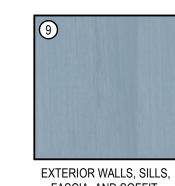


FASCIA, AND SOFFIT: WOOD PAINTED (SW 6521)

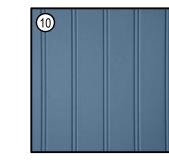

EXTERIOR WALLS: BEADED BOARD PANELS PAINTED (SW 6523)

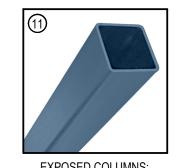

EXPOSED COLUMNS: HOLLOW SECTION STEEL PAINTED (SW 6523)

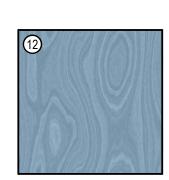


WOODEN PANELS: PLYWOOD PAINTED (SW 6521)




WOODEN DOORS: WOOD EDGE (1X) PAINTED (SW 6523)




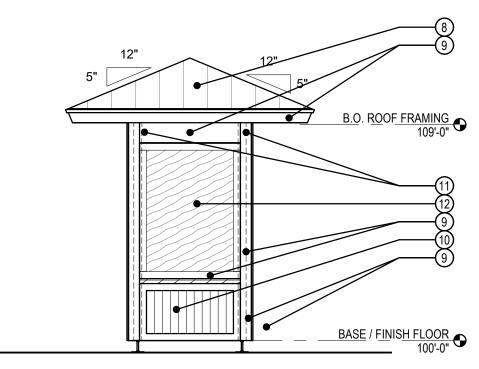


SIDE ELEVATION - SMALL KIOSK (B)

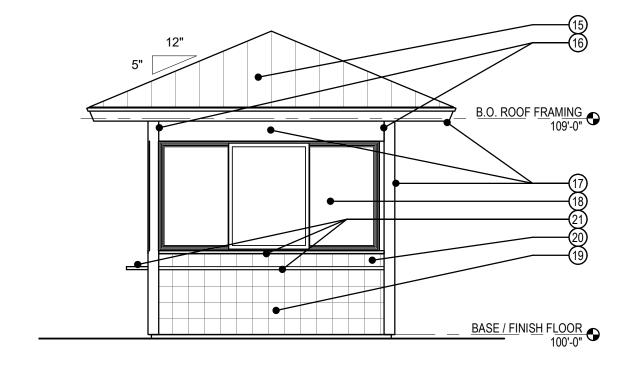


SIDE ELEVATION - LARGE KIOSK

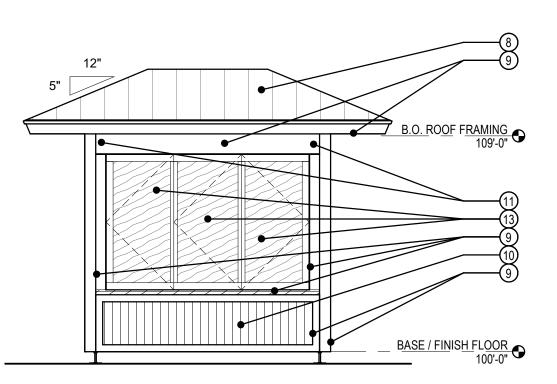

FRONT ELEVATION - SMALL KIOSK (B)

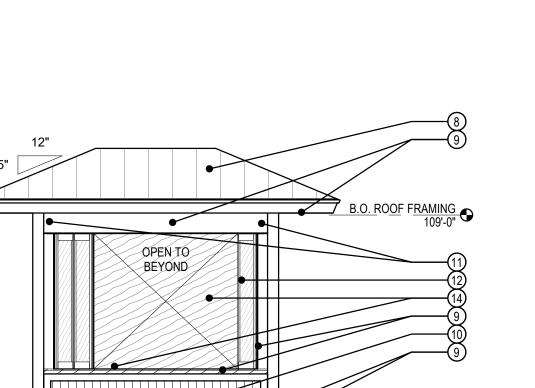


FRONT ELEVATION - SMALL KIOSK (B)

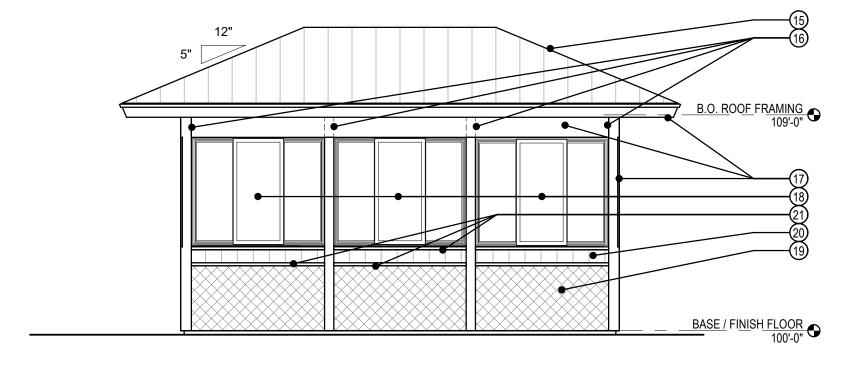


PRONT ELEVATION - LARGE KIOSK

1/4" = 1'-0"

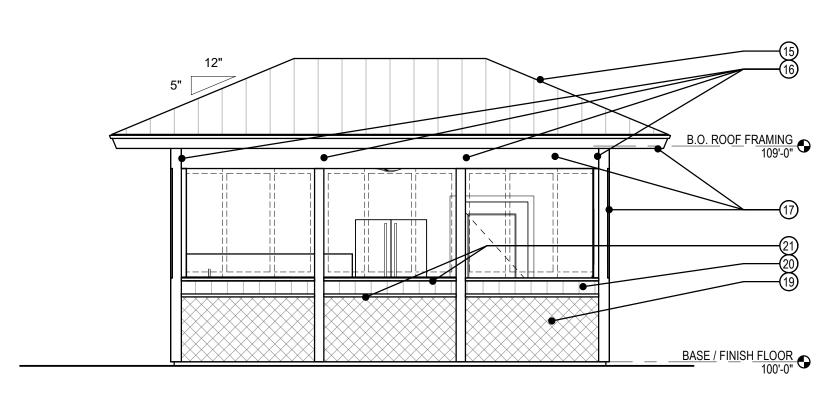


FRONT ELEVATION - LARGE KIOSK




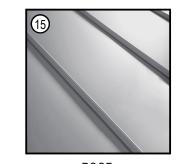


ROOF: STANDING-SEAM, GALVANIZED UNPAINTED

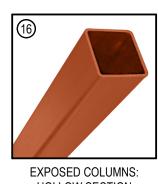


HOLLOW SECTION STEEL, PAINTED (SW 6636)

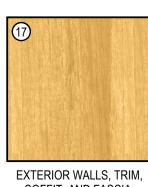


EXTERIOR WALLS, TRIM, SOFFIT, AND FASCIA: WOOD, PAINTED (SW 6675)

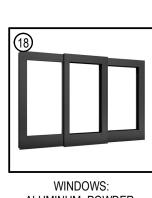


ALUMINUM, POWDER-COATED (FACTORY BLACK)

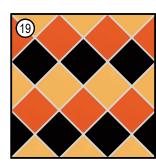

CERAMIC TILE, GLAZED (MUSTARD 1012 (3), ORANGE BURST 1097 (3), BLACK K111 (2))

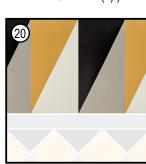

WAINSCOT BAND: LILI CEMENT TILE, MATERIALS MARKETING, SAN ANTONIO (VEGAS 3)

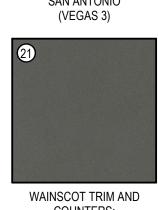

WAINSCOT TRIM AND COUNTERS: SOLID SURFACE (CEMENTO SPA)

STUDIO

201 GROVETON | SATX 78210 210.314.5582 | MPSTUD.IO

STATUS

100% CONSTRUCTION **DOCUMENT SET**

PRELIMINARY NOT FOR REGULATORY APPROVAL, PERMIT, OR CONSTRUCTION FISHER HECK, INC., ARCHITECTS MARK B. NAVARRO #25326

PROJECT

LA VILLITA

MAVERICK PLAZA REHABILITATION

PROJECT ADDRESS 418 VILLITA STREET #9

SAN ANTONIO, TX 78205 OWNER | CLIENT

CITY OF SAN ANTONIO (PW) 114 W. COMMERCE, 6TH FLOOR SAN ANTONIO, TX 78205

SUBCONSULTANT |



915 SOUTH ST MARY'S STREET SAN ANTONIO TEXAS FISHERHECK.COM 210-299-1500

		REVISIONS
-		
		ISSUE SETS
NO.	DATE	DESCRIPTION
1	06.17.20	100% CD REVIEW SET

SHEET INFORMATION

PROJECT NO. 1827 A1


> **DATE ISSUED** JUNE 17, 2020

SHEET NAME


HDRC MATERIALS & FINISHES REVIEW

3-A-601


INTERIOR FINISHES

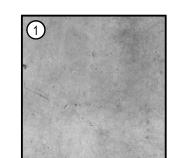


FLOORS: CONCRETE, POLISHED AND SEALED

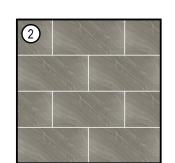

KITCHEN WALLS: 12X24 PORCELAIN TILE, (COMPOSER VR11)

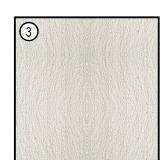


STORAGE ROOM WALLS: FIBERGLASS REINFORCED PLASTIC, (P151 - LIGHT GREY)

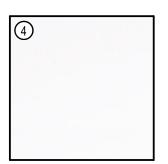

CEILINGS: FIBERGLASS REINFORCED PLASTIC, (S100G - WHITE)




KITCHEN APPLIANCES: STAINLESS STEEL

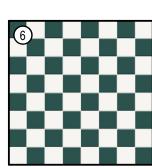


COUNTER WALL FACES: CERAMIC TILE, GLAZED (0115 EMERALD GREEN / 0190 ARCTIC WHITE)




COUNTERTOPS: SOLID SURFACE SILESTONE (GREY EXPO)

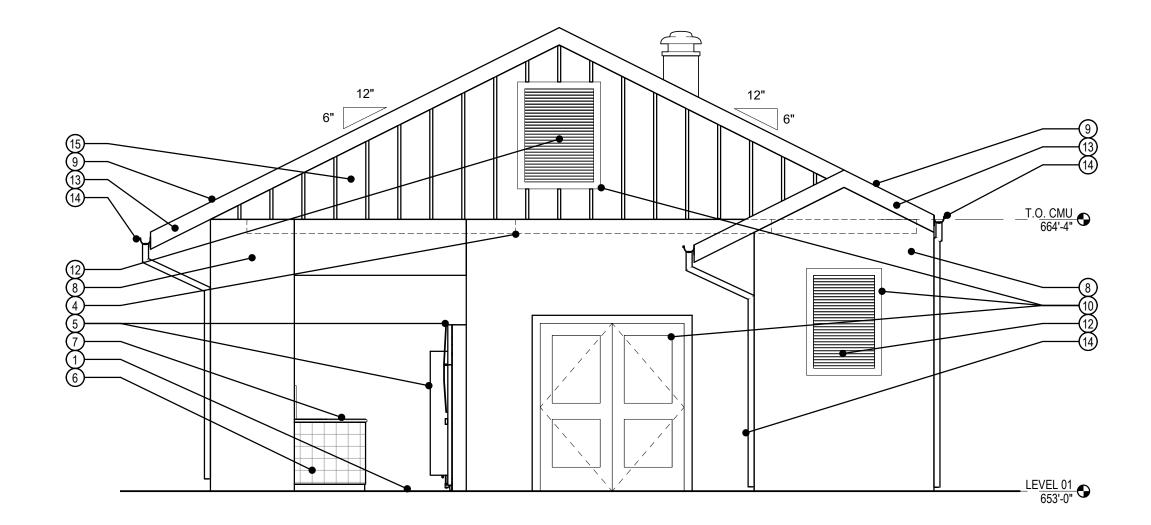

EAST ELEVATION - MATERIALS & FINISHES

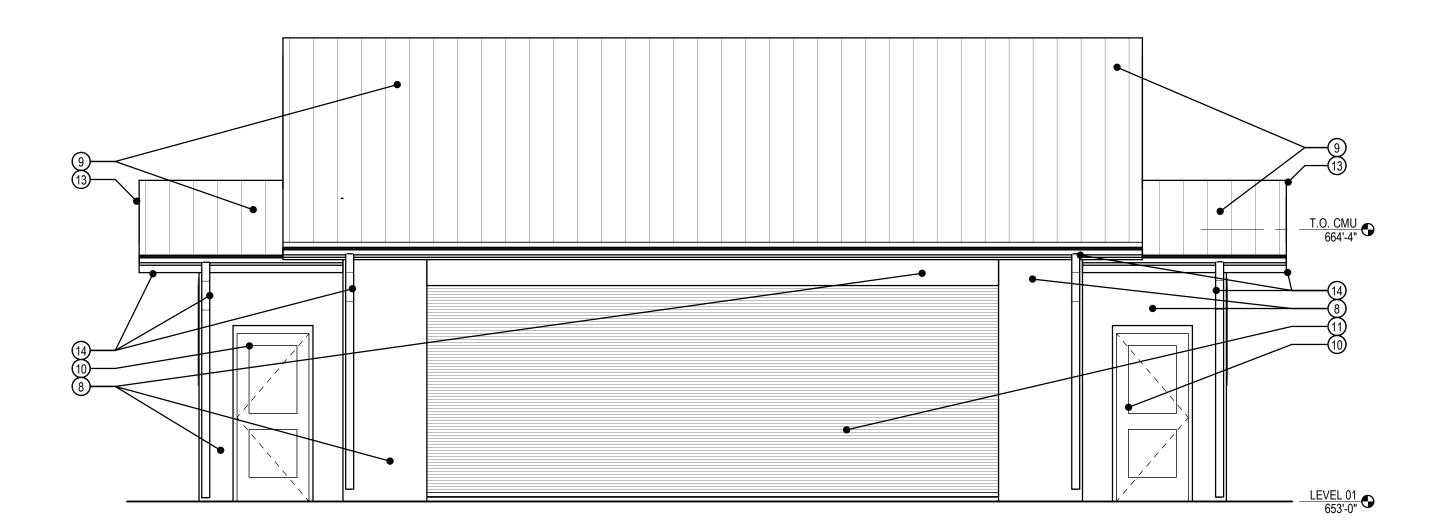

SOUTH ELEVATION - MATERIALS & FINISHES

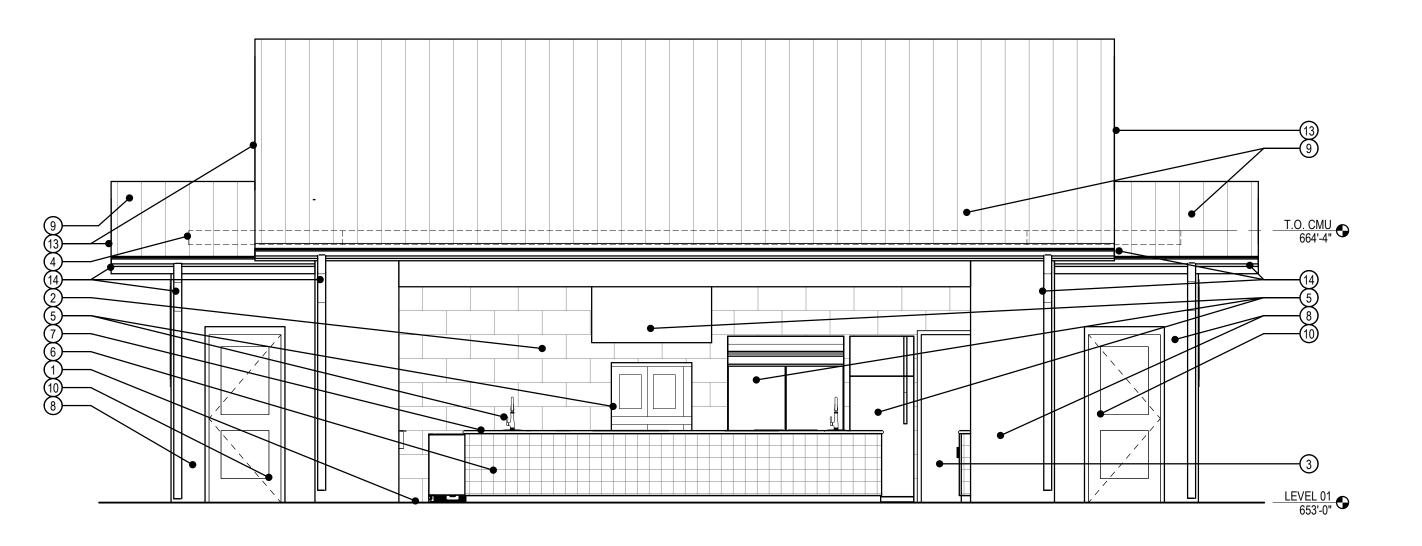


SOUTH ELEVATION - MATERIALS & FINISHES

1/4" = 1'-


EXTERIOR FINISHES



EXTERIOR WALLS: PLASTER, SAND-FINISHED PAINTED (SW 6107)

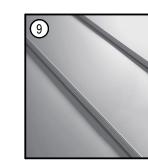


ROOF: STANDING-SEAM, GALVANIZED UNPAINTED

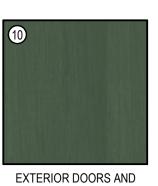


EXTERIOR DOORS AN TRIM PIECES: WOOD PAINTED (SW 6461)



COILING METAL DOORS: METAL, FACTORY FINISHED BAKED ENAMEL, GREY

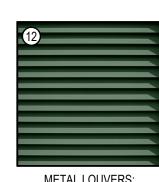


METAL LOUVERS: GALVANIZED METAL PAINTED (SW 6461)

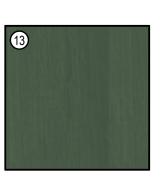

DRIP EDGE, FASCIA, RAFTERS, AND SOFFIT: WOOD PAINTED (SW 6461)



GUTTERS AND DOWNSPOUTS, GALVANIZED METAL PAINTED (SW 6461)

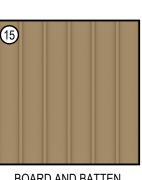

BOARD AND BATTEN SIDING, WOOD PAINTED (SW 6109)



201 GROVETON | SATX 78210 210.314.5582 | MPSTUD.IO

100% CONSTRUCTION DOCUMENT SET

STATUS

PRELIMINARY NOT FOR REGULATORY
APPROVAL, PERMIT, OR CONSTRUCTION
FISHER HECK, INC., ARCHITECTS
MARK B. NAVARRO #25326

6/1

PROJECT

LA VILLITA

MAVERICK PLAZA REHABILITATION

PROJECT ADDRESS

418 VILLITA STREET #9 SAN ANTONIO, TX 78205

OWNER | CLIENT

CITY OF SAN ANTONIO (PW)
114 W. COMMERCE, 6TH FLOOR

SAN ANTONIO, TX 78205

Fisher Heck

A R C H I T E C T S

915 SOUTH ST MARY'S STREET SAN ANTONIO TEXAS FISHERHECK.COM 210-299-1500

		REVISIONS	
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NO.	DATE	DESCRIPTION	
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| SHEET INFORMATION |

PROJECT NO.1827 A1

JUNE 17, 2020

SHEET NAME

HDRC MATERIALS AND FINISHES REVIEW

2-A-602

SEMI/DECIDUOUS

STUDIO

SHRUBS



LEOPARD PLANT FARFUGIUM JAPONICUM 'AUREOMACULATA' 2' HEIGHT X 2' WIDTH



ESPERANZA TECOMA STANS 3'-6' HEIGHT X 3'-4' WIDTH



BICOLOR IRIS DIETES BICOLOR 4'HEIGHT X 2'-3' WIDTH



PRIDE OF BARBADOS CAESALPINIA PULCHERRIMA 5'-8' HEIGHT X 3'-4' WIDTH



SKELETON LEAF GOLDENEYE VIGUIERA STENOLOBA S.F. BLAKE 4'HEIGHT X 2'-4' WIDTH



FLAME ACANTHUS ANISACANTHUS QUADRIFIDUS VAR. WRIGHTII 3'-5' HEIGHT X 3'-4' WIDTH



THRYALLIS GALPHIMIA GLAUCA 4'HEIGHT X 2'-3' WIDTH



FIRECRACKER FERN RUSSELIA EQUISETIFORMIS 2'-4' HEIGHT X 3'-5' WIDTH

TREES

......



8"-10" CALIPER



PALO VERDE DESERT MUSEUM CERCIDIUM X 'DESERT MUSEUM' 6"-8" CALIPER



TEXAS EBONY EBENOPSIS EBANO 6"-8" CALIPER

STATUS

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CITY OF SAN ANTONIO (PW) 100 HOUSTON ST., SUITE 210 SAN ANTONIO, TX 78205

GROUNDCOVERS



FROG FRUIT PHYLA NODIFLORA 2"- 3"HEIGHT X 4"- 8" WIDTH



TRADESCANTIA PALLIDA 12" HEIGHT X 18" WIDTH



CAREX TEXENSIS 12"-18" HEIGHT X 2' WIDTH





ZEXMENIA

2' HEIGHT X 1'-3' WIDTH

WEDELIA ACAPULCENSIS VAR. HISPIDA

GREGG'S MISTFLOWER CONOCLINIUM GREGGII 3' HEIGHT X 2' WIDTH



MEXICAN FEATHER GRASS NASSELLA TENUISSIMA 1'-2'HEIGHT X 30" WIDTH

ACCENT/SUCCULENTS



DWARF PALMETTO SABAL MINOR 3'-6'HEIGHT X 3'-6' WIDTH



BOUGAINVILLEA BOUGAINVILLEA SPECTABILIS (B. BRASILIENSIS)



SPINELESS PRICKLY PEAR OPUNTIA FICUS-INDICA 10'-15' HEIGHT X 5'-10' WIDTH

SUBCONSULTANT



PROJECT NO.

18100 DATE ISSUED

JULY 22, 2020 SHEET NAME

PLANTING PALETTE

SHEET NUMBER

LP 2.1












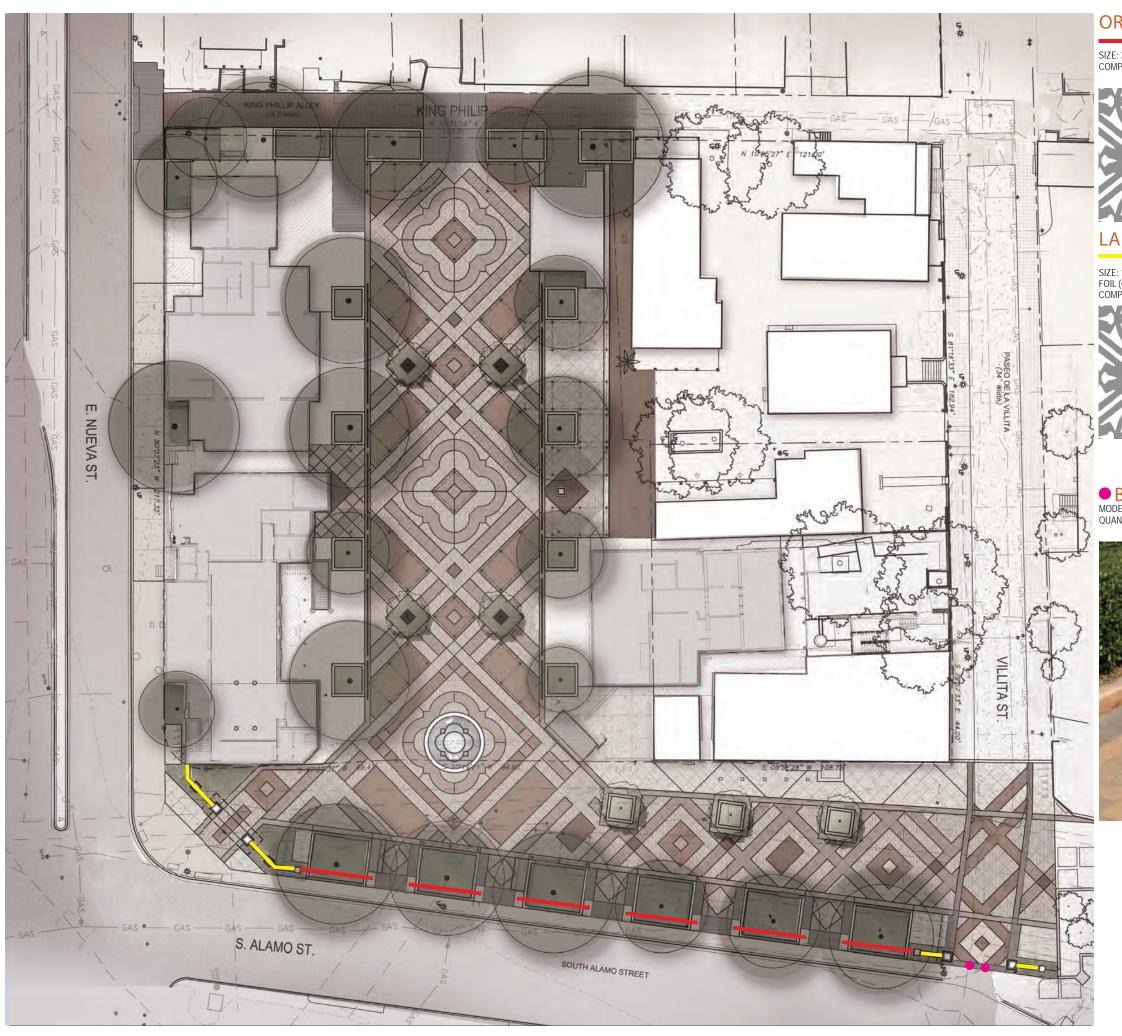

ORNAMENTAL PANEL


SIZE: 2'X4'X 3/16" PANEL | FINISH: COPPER FOIL (CFL) COMPANY: PARASOLEIL 816.304.1017 | PATTERN: HORUS



LANDSCAPE WALL

SIZE: 1'-10"X 3'-10"X 3/16" & 1'-10"X 1'-10"X 3/16" PANEL | FINISH: COPPER

COMPANY: PARASOLEIL 816.304.1017 | PATTERN: HORUS

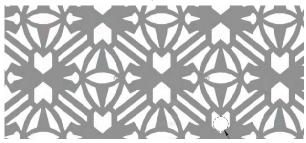

LA VILLITA

PROJECT

STUDIO

201 GROVETON | SATX 78210 210.314.5582 | MPSTUD.IO STATUS 100% CONSTRUCTION **DOCUMENT SET** FOR REVIEW ONLY Not for regulatory approval, permitting or construction

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PROJECT ADDRESS

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OWNER | CLIENT

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● BOLLARDS

MODEL: DG-3REM LOCK REMOVABLE BOLLARD | FINISH: STANDARD |
QUANTITY: 3 | COMPANY: URBAN ACCESSORIES



SUBCONSULTANT

		ISSUE SETS	
NO.	DATE	DESCRIPTION	
1	06.16.20	ISSUE FOR CONSTRUCTION	
		CET INICODIA ATION	

SHEET INFORMATION

PROJECT NO.

DATE ISSUED


JULY 22, 2020

SHEET NAME FENCING PLAN

SHEET NUMBER

LF 1.0

SIGNAGE FRONT LIT LETTERS CHANNEL LETTERS- FRONT LIT 1'-2" HEIGHT FONT TYPE TO BE PROVIDED BY OWNER | CHANNEL TO BE ANTIQUE RUSTED BROWN | LOCAL SOURCE

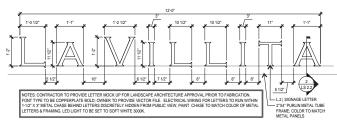

LA VILLITA -METAL SIGN

SCALE: 3/4"=1'-(

FESTOON LIGHTS

LIGHTS TO ATTACH TO POLE LIGHT | FIXTURE: FIRFESV12LAMPE, SOCKET: SUSPENDED CABLE 12" SOCKET SPACING | COMPANY: TMB | CONTACT: HOSSLEY LIGHTING 210.775.4166




FOUNTAIN LIGHTS UNDERWATER AND SUBMERSIBLE UP-LIGHTS TO BE SPECIFIED BY FOUNTAIN



LIGHT BOX ON ENTRY PORTAL & COLUMNS

FIXTURE: CUSTOM | TWO HILLS STUDIO 512.707.7571

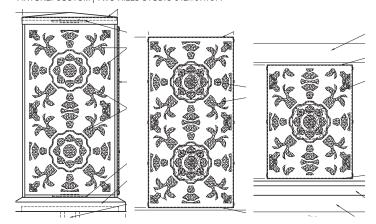

TREE UPLIGHTS
FIXTURE: FL3A BLT C4 K2 139 L2 0H1 GROUND MOUNT | COMPANY: VISION 3 | CONTACT: HOSSLEY LIGHTING 210.775.4166



IN-GRADE LIGHT 1G2A BLT STD PC 1410 0 HI | TEXTURED BRONZE | CLEAR ANODIZED | CONTACT: HOSSLEY LIGHTING 210.775.4166





| COLOR: UBT BRONZE TEXTURED | CONTACT: HOSSLEY LIGHTING 210.775.4166



BRONZE | BASE: ROUND STERNBURG LIGHTING | CONTACT: HOSSLEY LIGHTING 210.775.4166



STUDIO

201 GROVETON | SATX 78210 210.314.5582 | MPSTUD.IO

STATUS

100% CONSTRUCTION **DOCUMENT SET**

FOR REVIEW ONLY Not for regulatory approval, permitting or construction

PROJECT

LA VILLITA

MAVERICK PLAZA REHABILITATION

PROJECT ADDRESS

418 VILLITA STREET #9 SAN ANTONIO, TX 78205

OWNER | CLIENT

CITY OF SAN ANTONIO (PW)

100 HOUSTON ST., SUITE 210 SAN ANTONIO, TX 78205

SUBCONSULTANT

_		
		ISSUE SETS
NO.	DATE	DESCRIPTION
1	06.16.20	ISSUE FOR CONSTRUCTION

PROJECT NO.

18100


DATE ISSUED JULY 22, 2020

SHEET NAME

LIGHTNING MATERIALS

SHEET NUMBER

LL 2.1

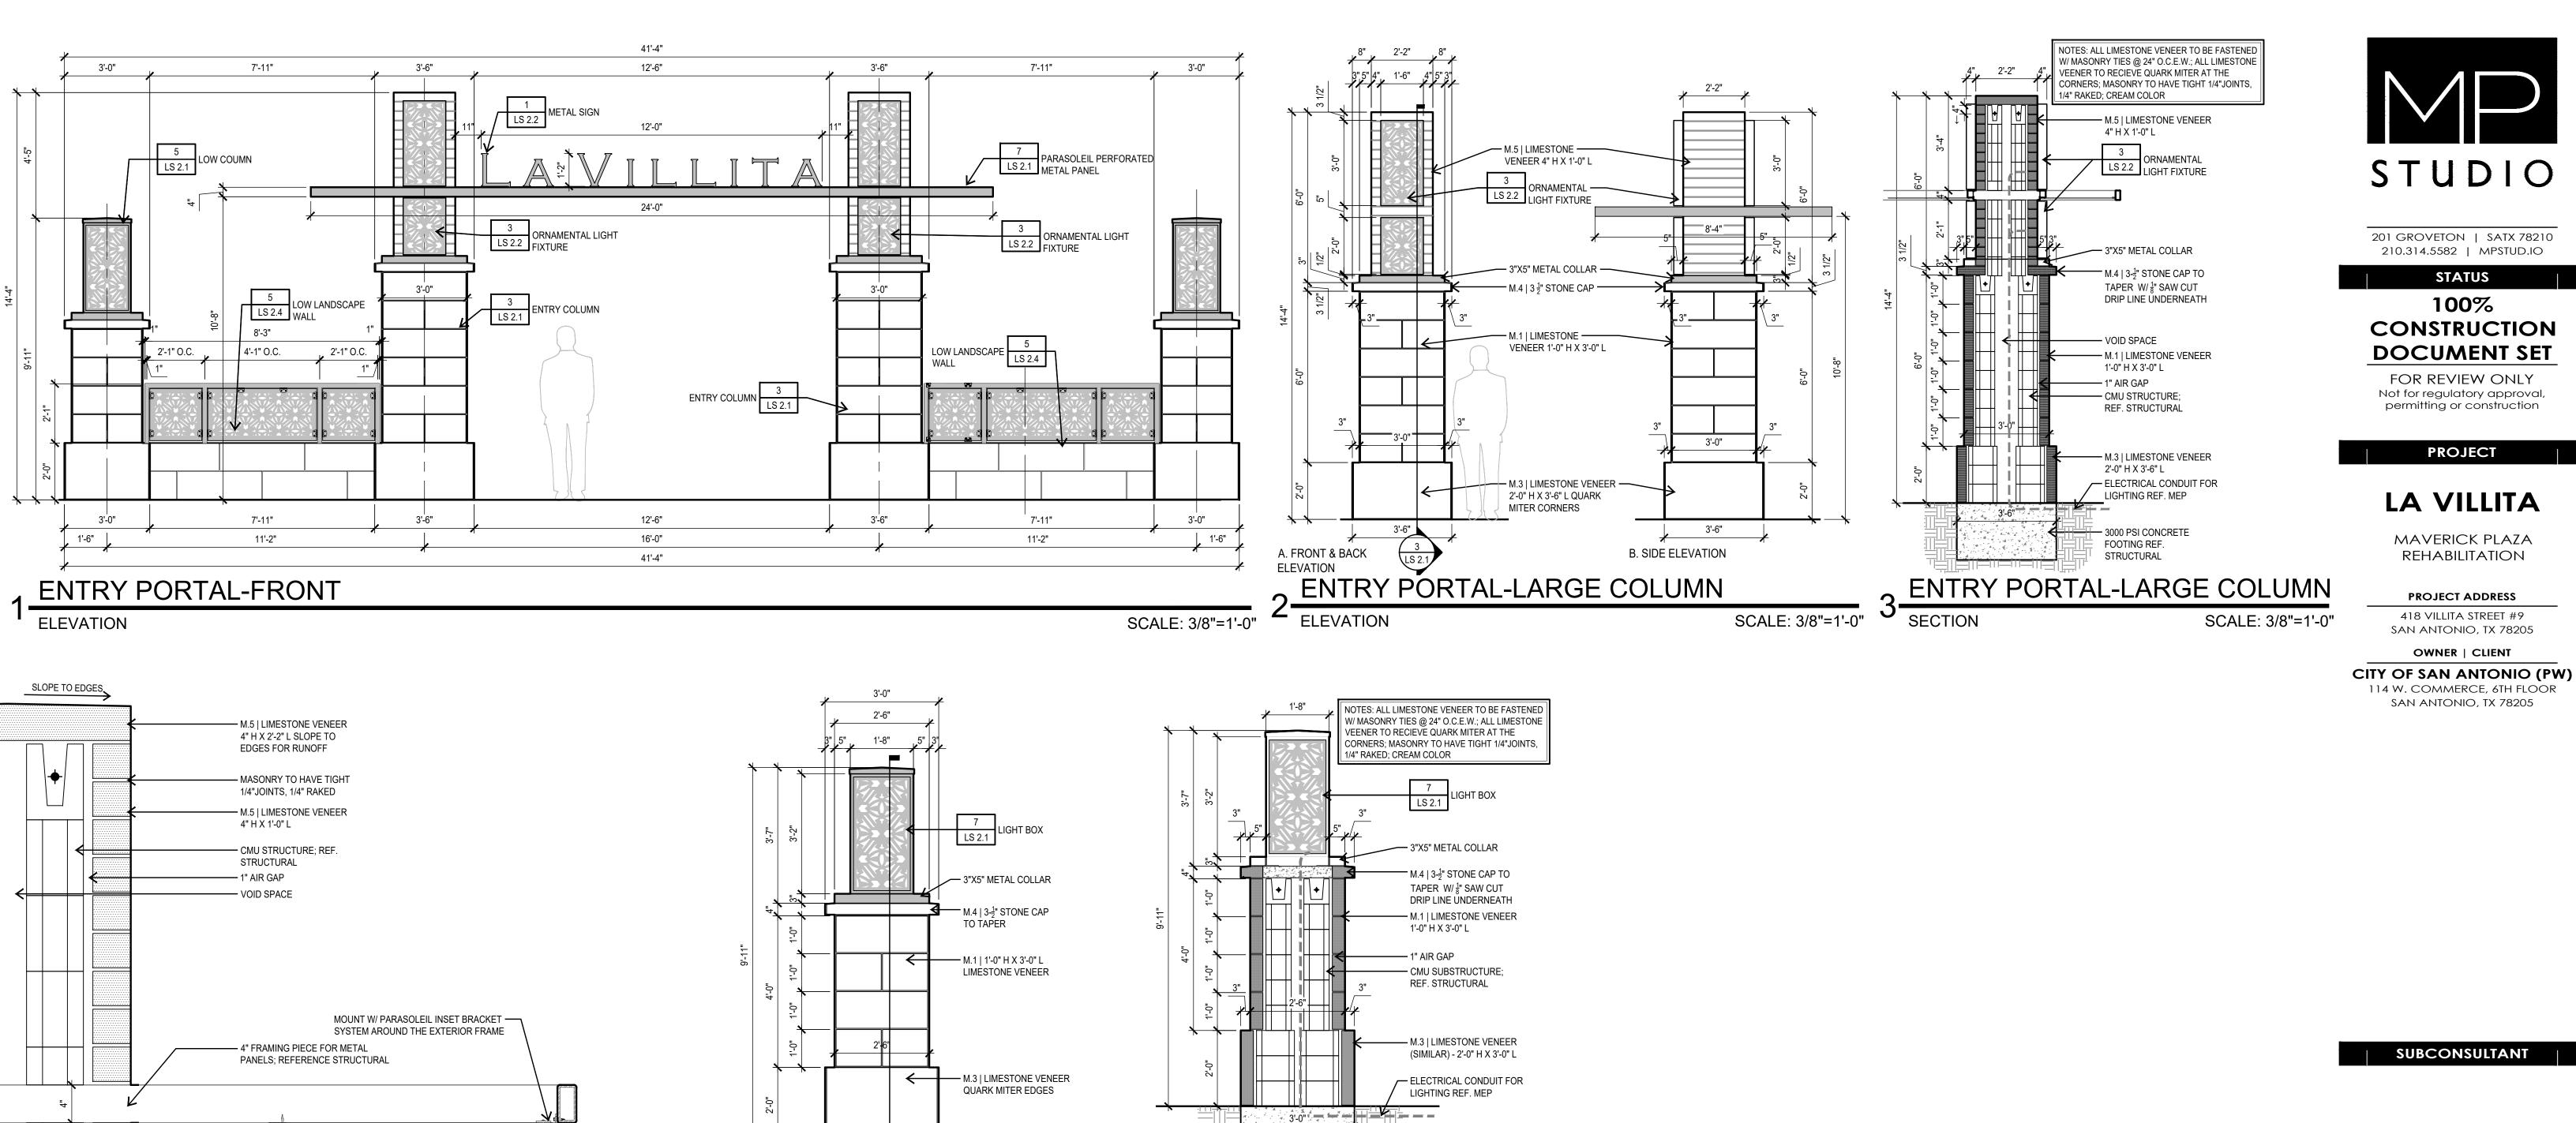

ENTRY PORTAL- LOW COLUMN

SCALE: 1/2"=1'-0"

6 ENTRY PORTAL- LOW COLUMN

SCALE: 1/2"=1'-0"

SCALE: 1/2"=1'-0"

NOTES: T.1 | PARASOLEIL METAL PANELS TO BE DIRECT MOUNTED TO 2"X3" PURLIN METAL TUBE

FRAME USING PARASOLEIL FLAT BRACKET SYSTEM TO INTERNALLY FRAME; AND PARASOLEIL

INSET BRACKET SYSTEM AROUND THE EXTERIOR FRAME PER MANUFACTURER SPECIFICATIONS

24'-0"

A. 2'-0" X 4'-0" METAL PANEL HORUS PATTERN

B. 2'-0" X 2'-0" METAL PANEL HORUS PATTERN

3/4" RIGID CONDUIT W/ ELEC. WIRING ALONG CENTRAL FRAMING ———

ENTRY PORTAL-METAL PERFORATED PANEL

TO SIGNAGE LETTERS; PAINTED TO MATCH FRAMING COLOR

T.1 | PARASOLEIL METAL PANELS TO BE MOUNTED TO 2"X4" METAL FRAME - MOUNT W/ PARASOLEIL FLAT BRACKET SYSTEM TO INTERNALLY FRAME

NOTES: CONTRACTOR TO PROVIDE SHOP

DRAWINGS FOR LIGHT BOX ELEMENT TO BE

INTERNAL L.E.D. LIGHT

- T.1 | PARASOLEIL PANEL PATTERN: HORUS; SIZE

LIGHT BOX FEATURE

CONTRACTOR TO

- INTERNAL L.E.D. LIGHT

- 3"X5" METAL COLLAR

- M.4 | 3- $\frac{1}{2}$ " STONE CAP TO

TAPER W/ $\frac{1}{8}$ " SAW CUT

DRIP LINE UNDERNEATH

— 4" CONCRETE DECK

— ELECTRIC CONDUIT REF.

SCALE: 1"=1'-0"

APPROVED BY LANDSCAPE ARCHITECT.

3'-0" X 1'-6"

PROVIDE

SCALE: 1-1/2"=1'-0"

LARGE COLUMN-TOP

COLUMN LIGHT BOX

3000 PSI CONCRETE FOOTING; REF. STRUCTURAL

- L.2 | "LA VILLITA" SIGN LETTERS SECURE TO OUTER

---- 1-1/2" X 3" METAL CHASE BEHIND LETTERS HOUSING

ELEC. WIRING, PAINTED TO MATCH FRAME COLOR

- ENTRY PORTAL

COLUMN TOP

PORTION

METAL TUBE

SCALE: 1/2"=1'-0"

METAL PERFORATED PANEL

VIEW LOOKING UP

FRAME OVERHANGING 1"


4'-0"


SUBCONSULTANT

STATUS

100%


PROJECT

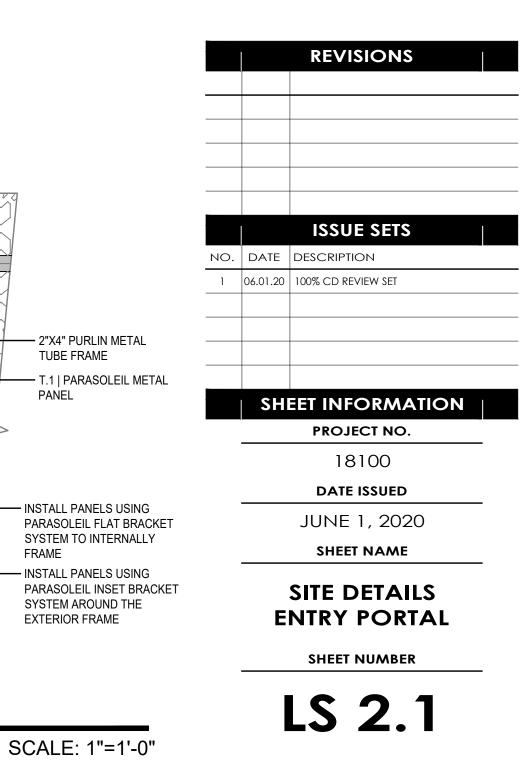

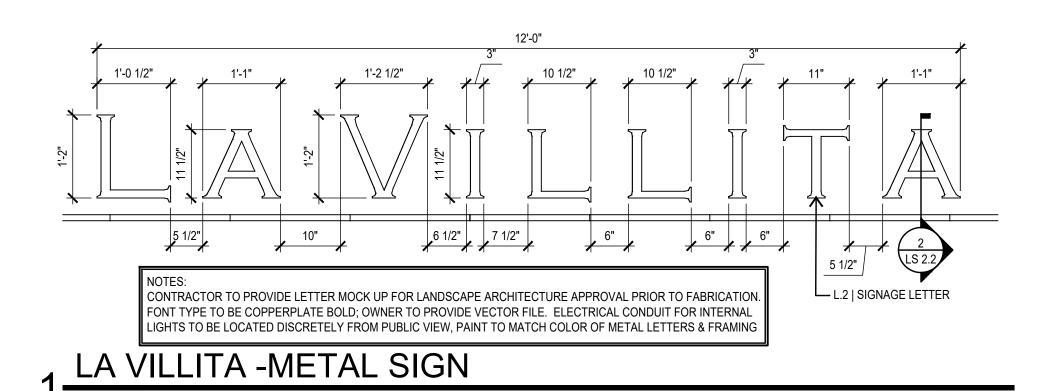


ELEVATION

SCALE: 3/4"=1'-0"

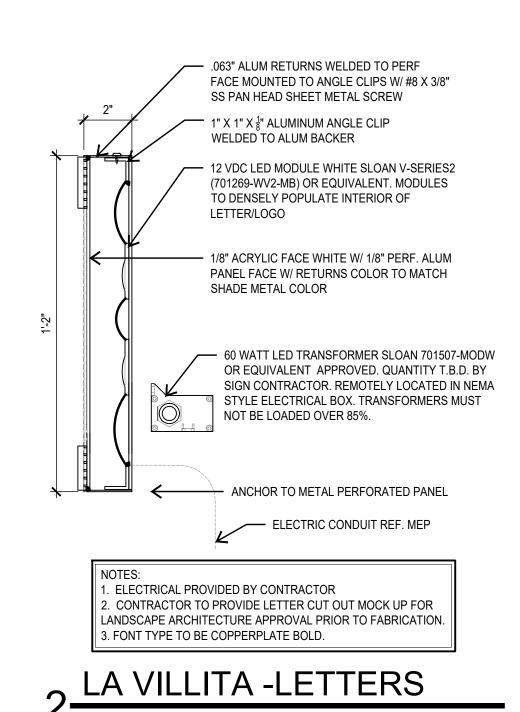

SCALE: 3"=1'-0"

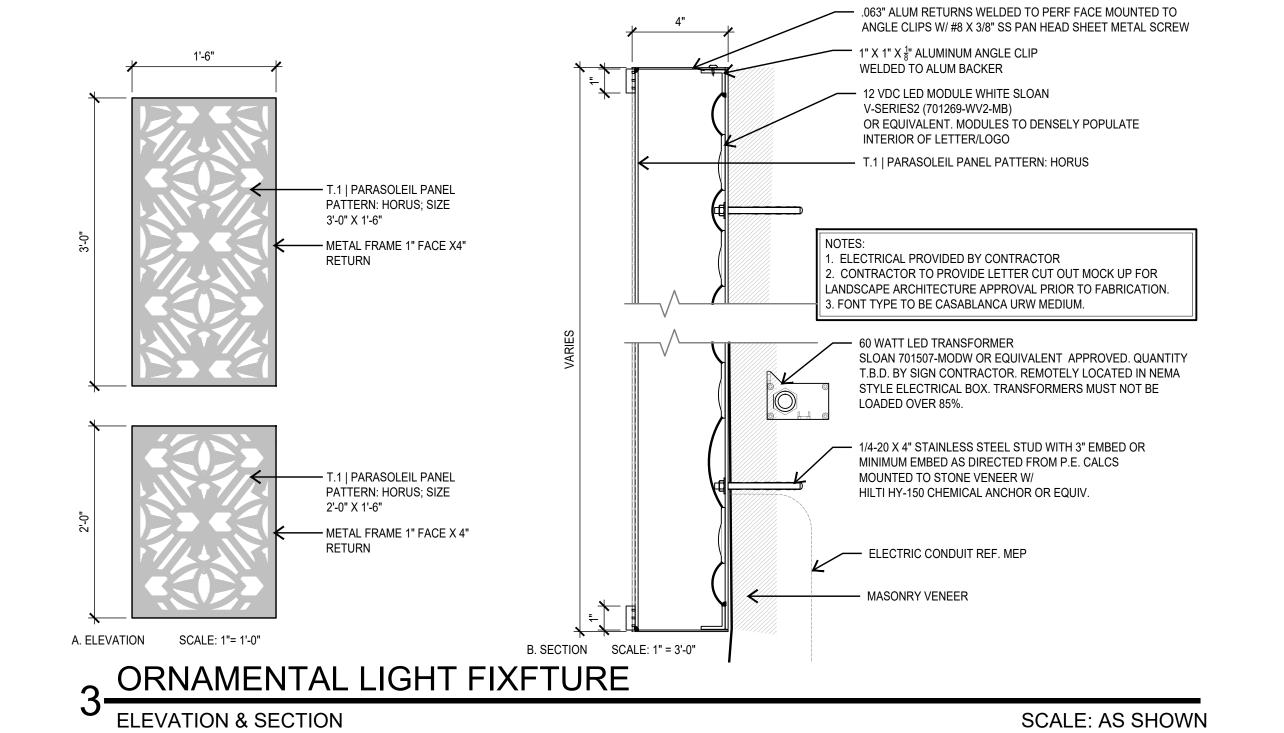

STUDIO

201 GROVETON | SATX 78210 210.314.5582 | MPSTUD.IO

STATUS

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PROJECT

LA VILLITA

MAVERICK PLAZA

PROJECT ADDRESS

REHABILITATION

418 VILLITA STREET #9 SAN ANTONIO, TX 78205

OWNER | CLIENT

CITY OF SAN ANTONIO (PW)
114 W. COMMERCE, 6TH FLOOR

SAN ANTONIO, TX 78205

SUBCONSULTANT

		REVISIONS
		ISSUE SETS
NO.	DATE	DESCRIPTION
1	06.01.20	100% CD REVIEW SET
	SH	EET INFORMATION

JUNE 1, 2020 SHEET NAME

18100

DATE ISSUED

SITE DETAILS ENTRY PORTAL

SHEET NUMBER

LS 2.2





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100 HOUSTON ST., SUITE 210 SAN ANTONIO, TX 78205

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NO.	DATE	DESCRIPTION

		ISSUE SETS
NO.	DATE	DESCRIPTION
1	06.16.20	ISSUE FOR CONSTRUCTION

SHEET INFORMATION

PROJECT NO.

DATE ISSUED

JULY 22, 2020

SHEET NAME

ENTRY MONUMENT

SHEET NUMBER

LIMESTONE VENEER
SIZE: 1'H X 3'LX 4" D | COLOR: 40% CREAM, 60% PEWTER | FINISH: 2/3 BRUSHED, 1\3 HAND HEWN | COMPANY: MATERIALS MARKETING 210.785.2012









© ORNAMENTAL PANEL

SIZE: 2'X4'X 3/16" PANEL | FINISH: COPPER FOIL (CFL) COMPANY: PARASOLEIL 816.304.1017 | PATTERN: HORUS

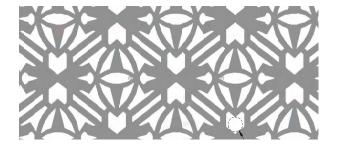

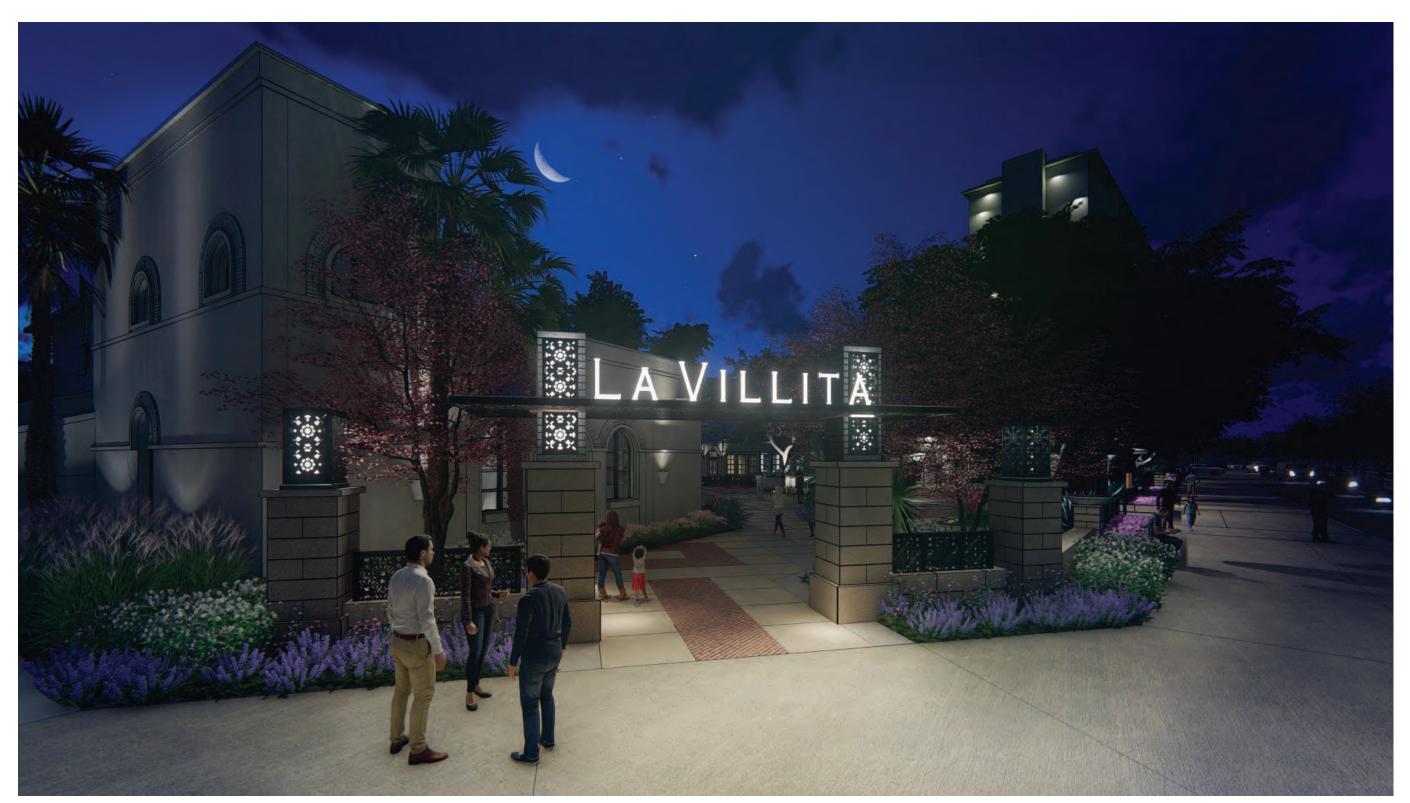



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	СП	FET INFORMATION	15.

PROJECT NO.

18100

DATE ISSUED JULY 22, 2020

SHEET NAME

ENTRY MONUMENT