




New Infill Residences in Dignowity Hill Historic District 313 N. Pine St. - Lot 8, San Antonio, TX 78202

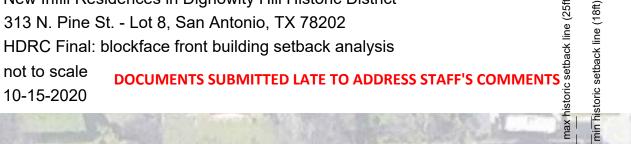

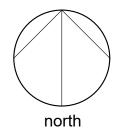


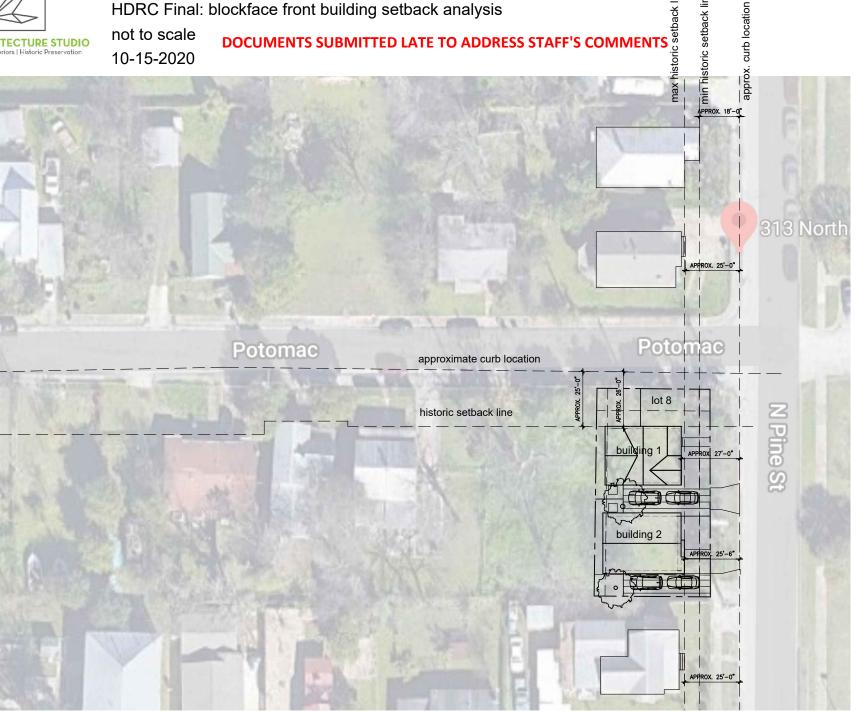




10-15-2020


New Infill Residences in Dignowity Hill Historic District 313 N. Pine St. - Lot 8, San Antonio, TX 78202 HDRC Final: landscape site plan 1/16" = 1'-0"

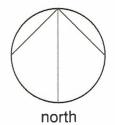

OAK TREE

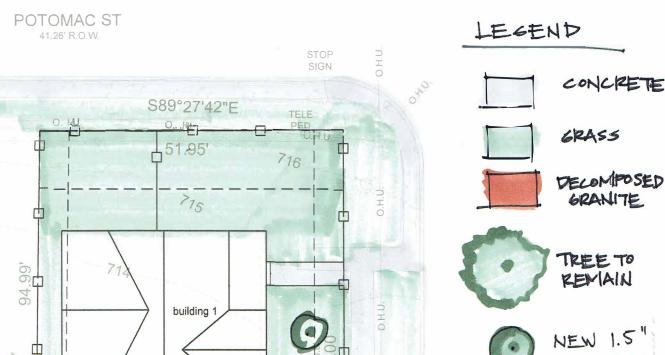



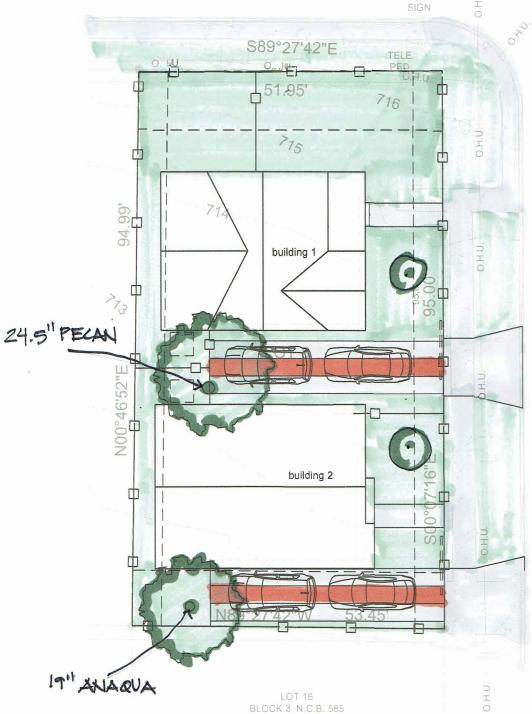



landscape site plan

# NEW RESIDENCE

## 313 N PINE ST - LOT 8, BUILDING 1, SAN ANTONIO, TX 78202



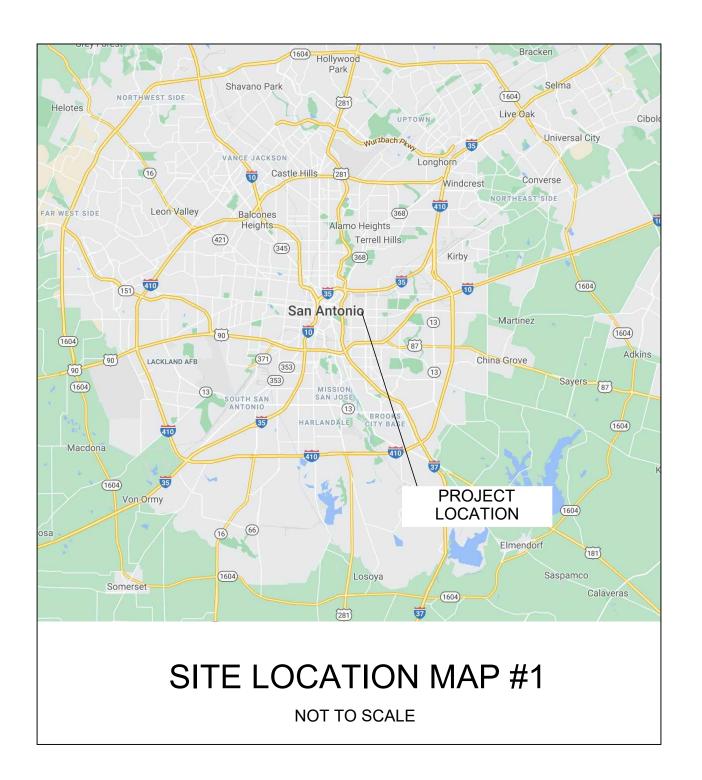

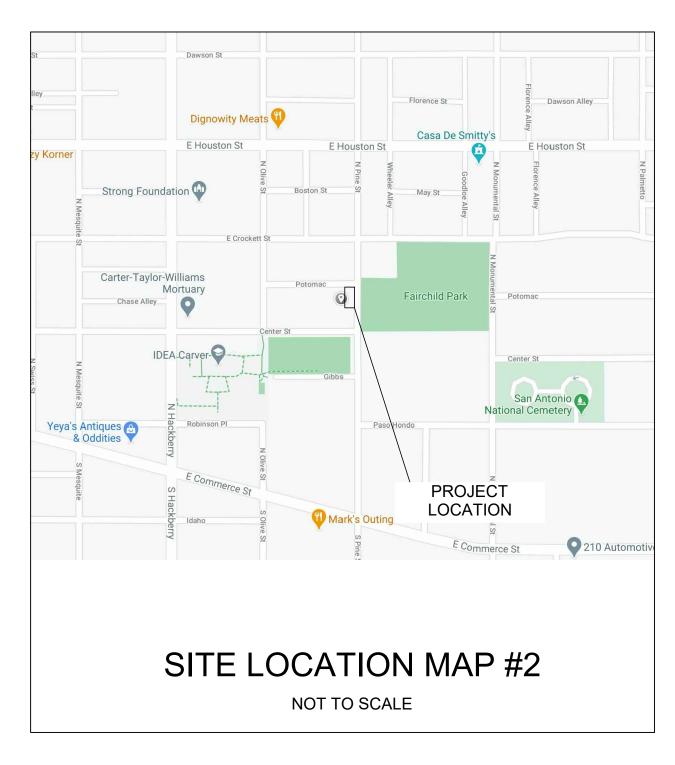

1723 WHISPER VALLEY ST TEL. 210.201.3637

1700 S LAMAR BLVD, STE 338 AUSTIN, TX 78704 TEL. 512.522.5505

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THE CONTRACTOR SHALL BE RESPONSIBLE FOR PROVIDING HIS OWN TELEPHONE. TOILET, VALVES, OR OTHER DEVICES NECESSARY TO RUN POWER TOOLS AND EQUIPMENT. SUCH MODIFICATIONS TO EXISTING UTILITIES SHALL BE REMOVED AT COMPLETION OF THE

19. CONTRACTOR SHALL SUBMIT SHOP DRAWINGS TO THE ARCHITECT IN A TIMELY MANNER THAT WILL ALLOW NOT LESS THAN 10 DAYS FOR REVIEW. THE GENERAL CONTRACTOR SHALL SUBMIT CORRECT NUMBER REQUIRED, BUT NOT LESS THAN 4

20. THE GENERAL CONTRACTOR SHALL PROVIDE STREET NUMBERING ON THE BUILDING IN COMPLIANCE WITH LOCAL AUTHORITY.

ALL PENETRATIONS THRU WALLS SHALL BE SEALED AIR/WATER TIGHT AND CAULKED WITH 2 PART SEALANT EACH SIDE.

THE GENERAL CONTRACTOR SHALL PROVIDE (1) COPY OF AS-BUILT DRAWINGS TO THE OWNER AT THE COMPLETION OF THE PROJECT. AS-BUILT DRAWINGS SHALL BE KEPT ON THE JOB AT ALL TIMES AND UPDATED THROUGHOUT THE CONSTRUCTION PHASE.

UNLESS NOTED OTHERWISE, SITE PLAN DIMENSIONS ARE TO FACE OF CURB. FLOOR PLAN DIMENSIONS ARE TO FACE OF STUDS, FRAMING, MASONRY, CONCRETE WALL PANELS, OR FOUNDATION WALLS.

## SHEET INDEX

	CS	COVER SHEET
	SP100	SITE/ROOF PLAN
	A100	PROPOSED FLOOR PLAN
	A200	PROPOSED EXTERIOR ELEVATIONS
	A300	TYPICAL WALL SECTION AND DETAILS
	A500	ELECTRICAL FLOOR PLAN
	A600	DOOR & WINDOW SCHEDULES
ı		

PENDING - NOT DRAWN YET

## **ARCHITECT**

ZIGA ARCHITECTURE STUDIO, PLLC

11723 WHISPER VALLEY ST, SAN ANTONIO, TX 78230 | 210-201-3637 1700 S LAMAR BLVD, STE 338, AUSTIN, TX 78704 | 512-522-5505 INFO@STUDIOZIGA.COM | WWW.STUDIOZIGA.COM

## **CODE INFORMATION**

2018 INTERNATIONAL RESIDENTIAL CODE 2018 IECC

## **BUILDING DATA**

SQ. FT.

671 S.F. 1ST FLOOR LIVING 750 S.F. 2ND FLOOR LIVING

1,421 S.F. TOTAL LIVING

154 S.F. 1ST FLOOR PORCH 75 S.F. 2ND FLOOR PORCH

229 S.F. TOTAL PORCH © 2020 ZIGA ARCHITECTURE STUDIO, PLLC ALL RIGHTS RESERVED. THIS DRAWING AND ITS REPRODUCTIONS ARE THE PROPERTY OF ZIGA ARCHITECTURE STUDIO PLLC. IT MAY NOT BE REPRODUCED, PUBLISHED, OR USED IN ANY WAY WITHOUT THEWRITTEN PERMISSION OF ZIGA ARCHITECTURE STUDIO, PLLC.

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APPROVAL


ISSUE DESCRIPTION

HDRC FINAL 10/15/2020 HDRC FINAL REV.


**COVER SHEET** 

20-136 PROJECT NO. 10-01-20 FJZ DRAWN BY: FJZ**REVIEWED BY:** PROJECT ARCHITECT: FELIX J. ZIGA JR., AIA

TEXAS LICENSE NO. 24683

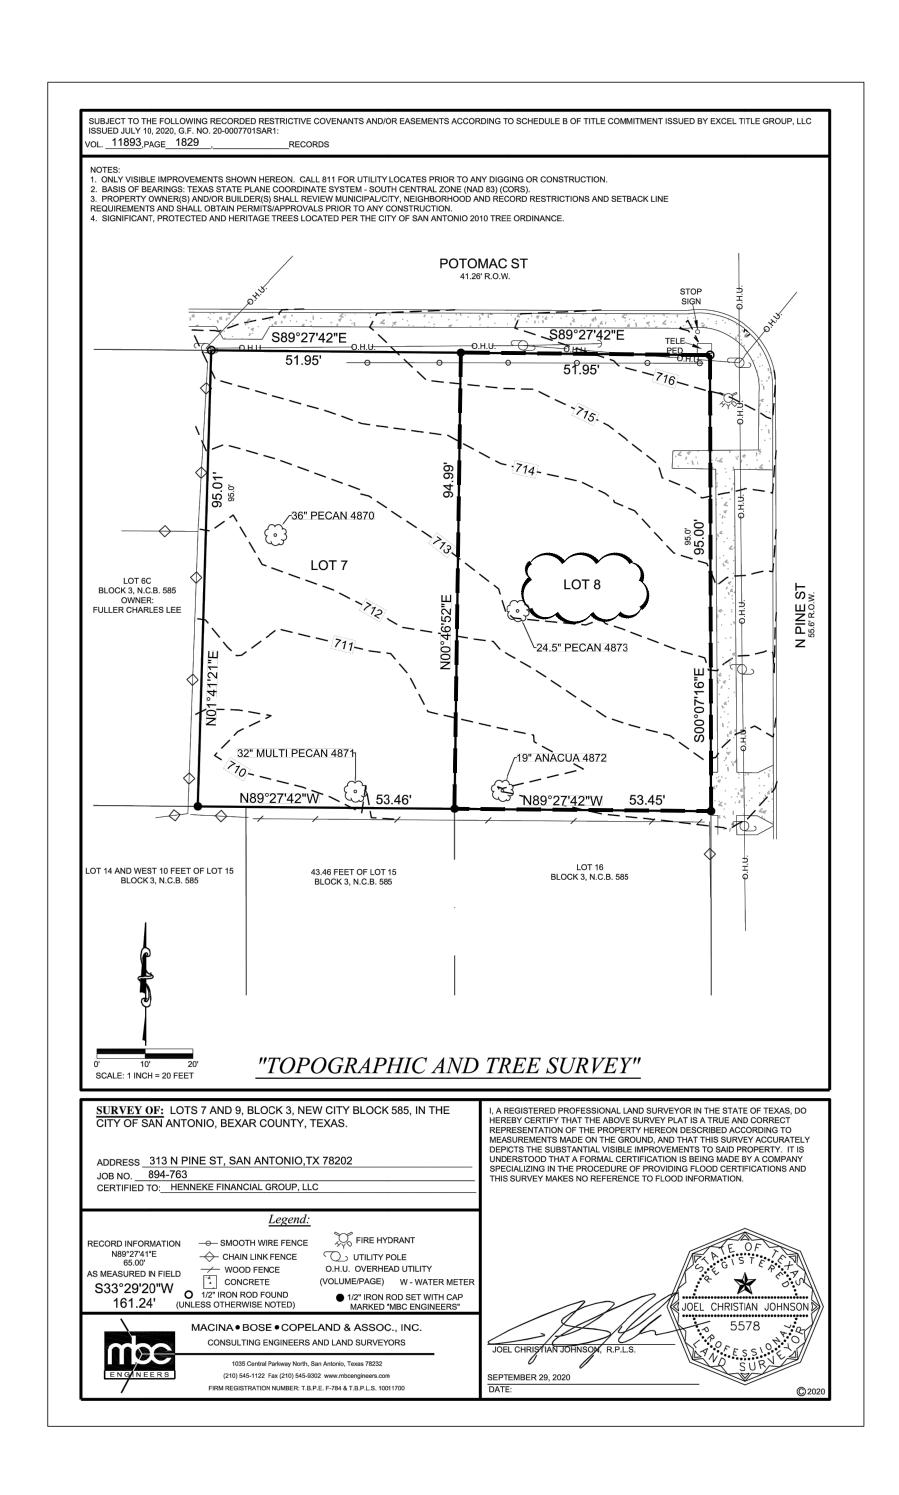



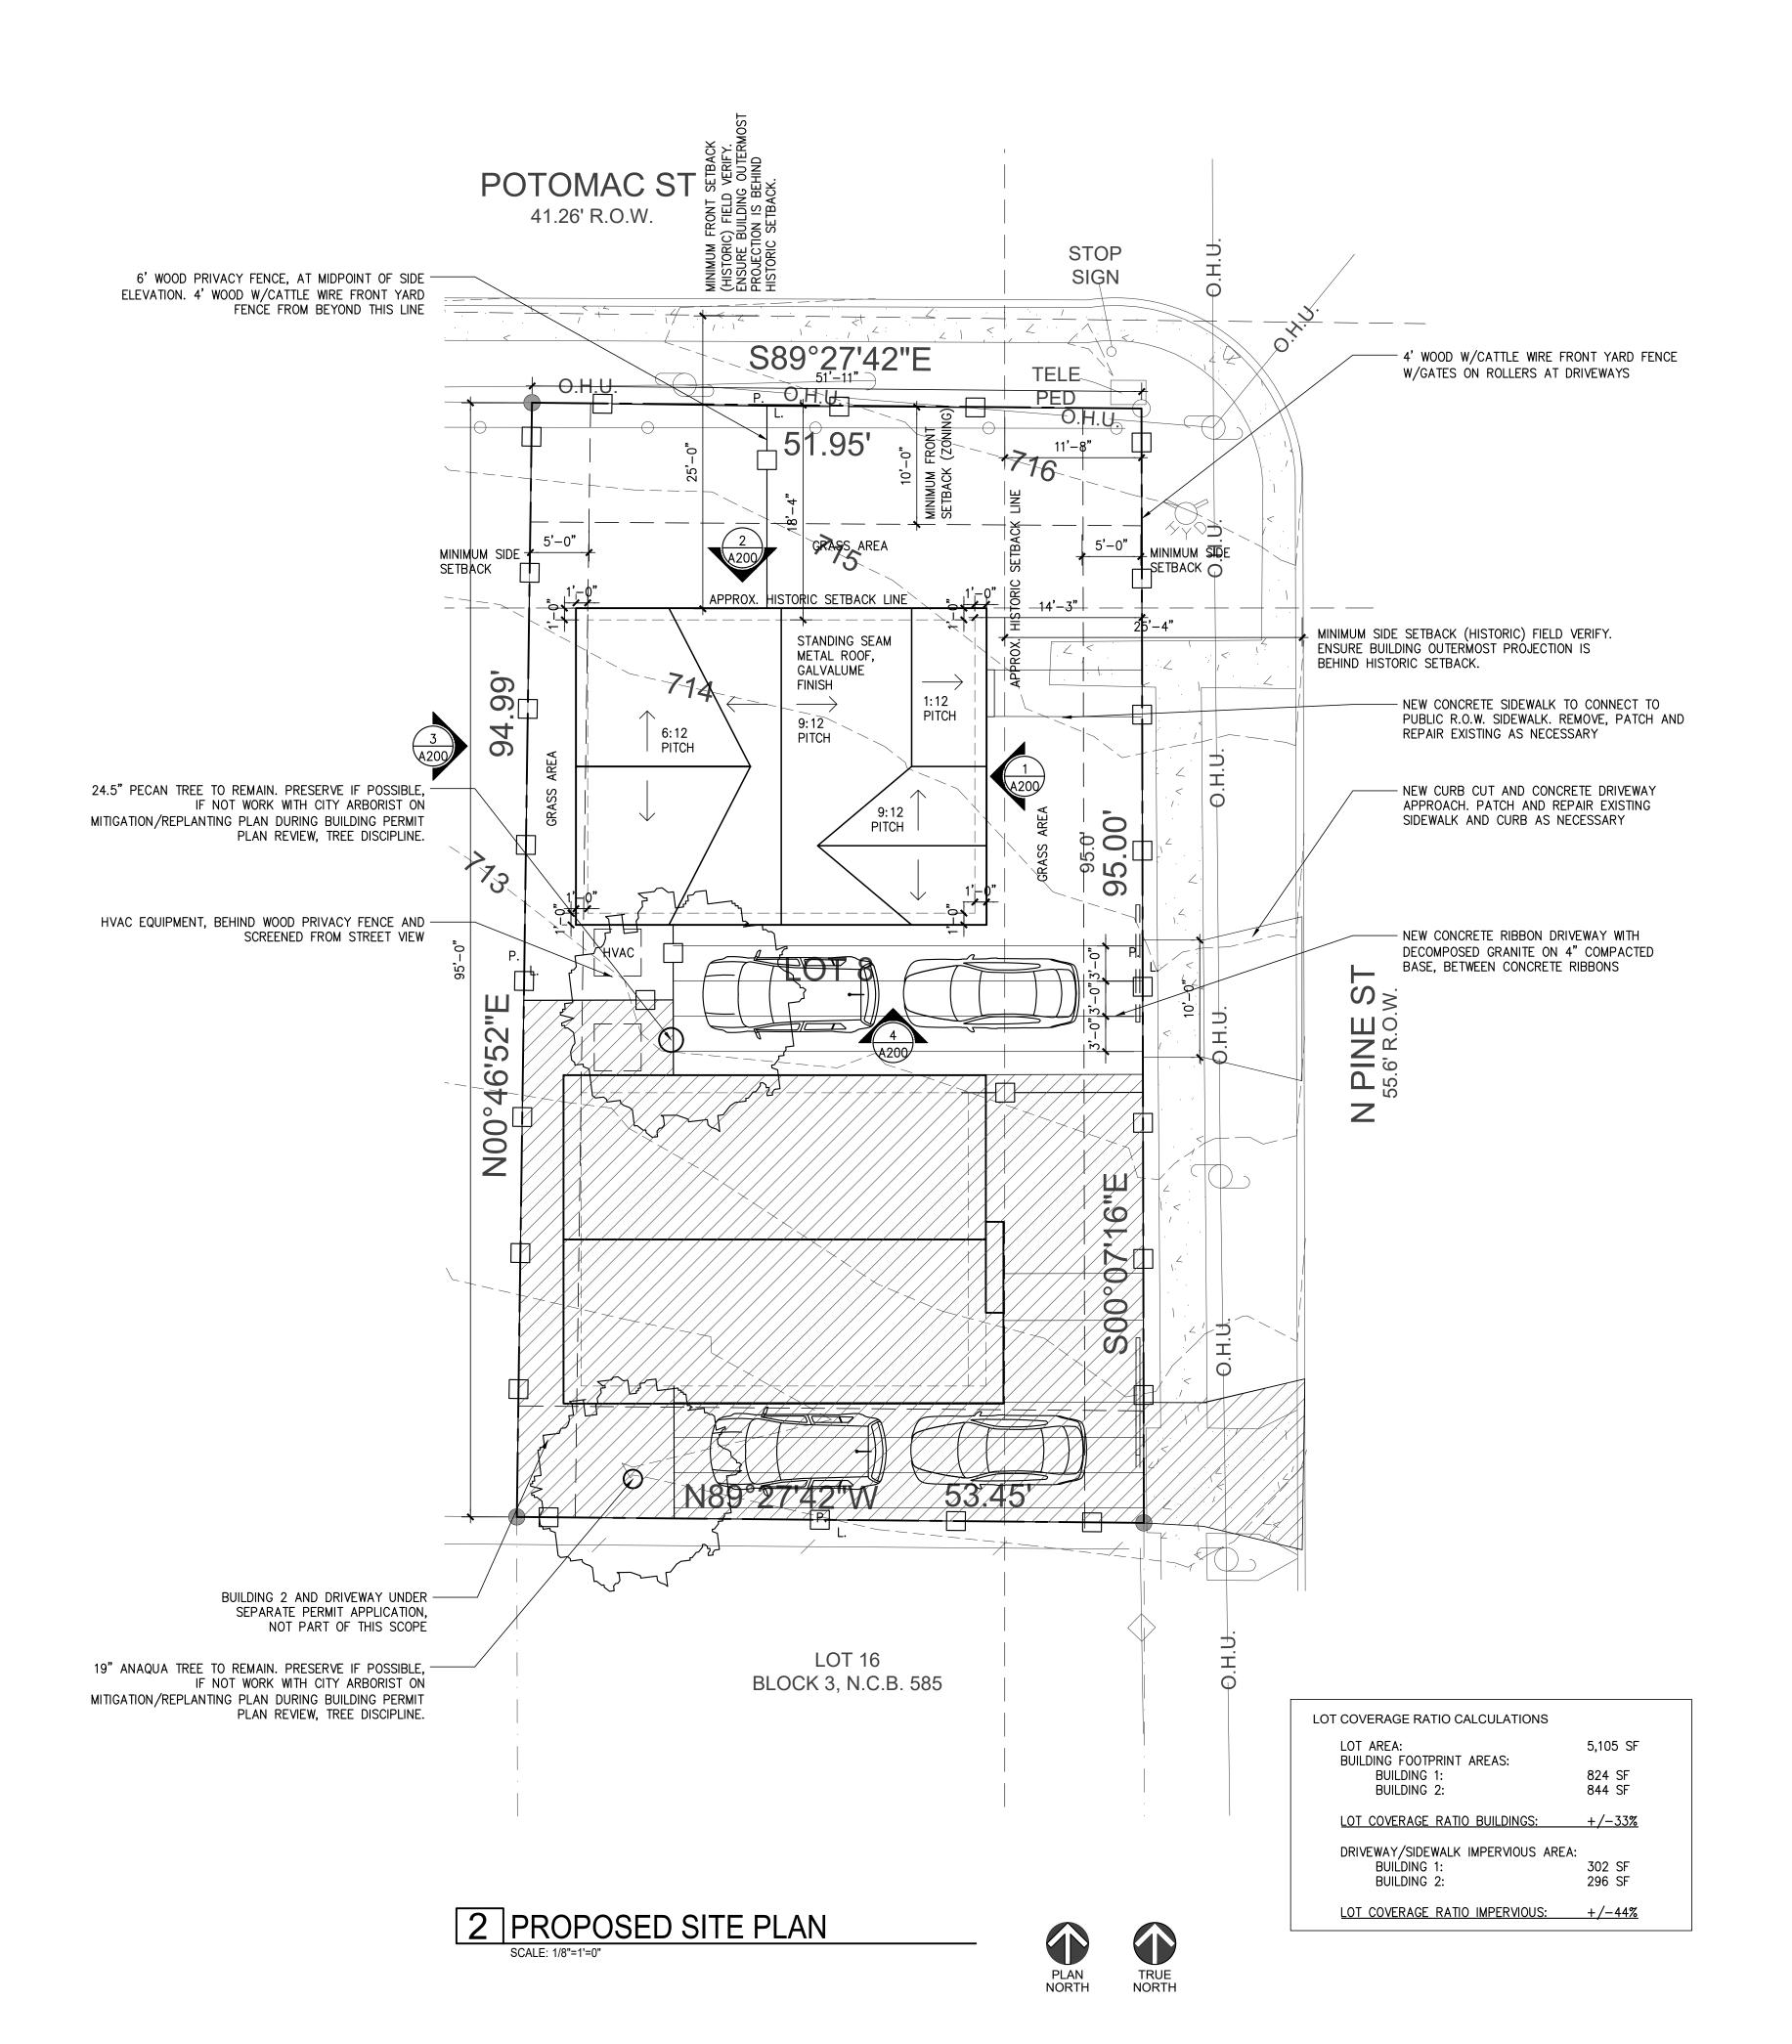

ZIGA ARCHITECTURE STUDIO

Architecture | Interiors | Historic Preservation

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NEW RESIDENCE

3 N. PINE ST. - LOT 8, BUILDING 1

SAN ANTONIO, TX 78202

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HENNEKE

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ISSUE

DATE DESCRIPTION

10/02/2020 HDRC FINAL

2 10/15/2020 HDRC FINAL REV.

PROPOSED SITE/ROOF PLAN

 PROJECT NO.
 20-136


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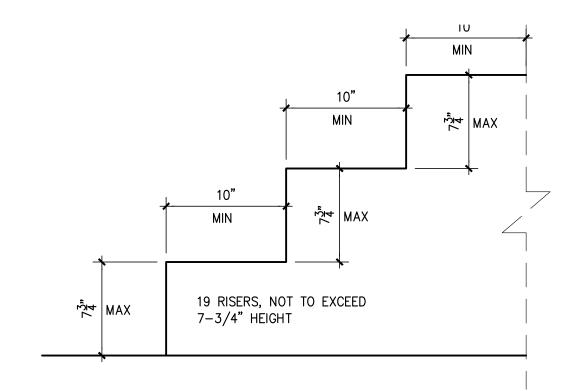
 DRAWN BY:
 FJZ

 REVIEWED BY:
 FJZ

PROJECT ARCHITECT: FELIX J. ZIGA JR., AIA TEXAS LICENSE NO. 24683

SP100



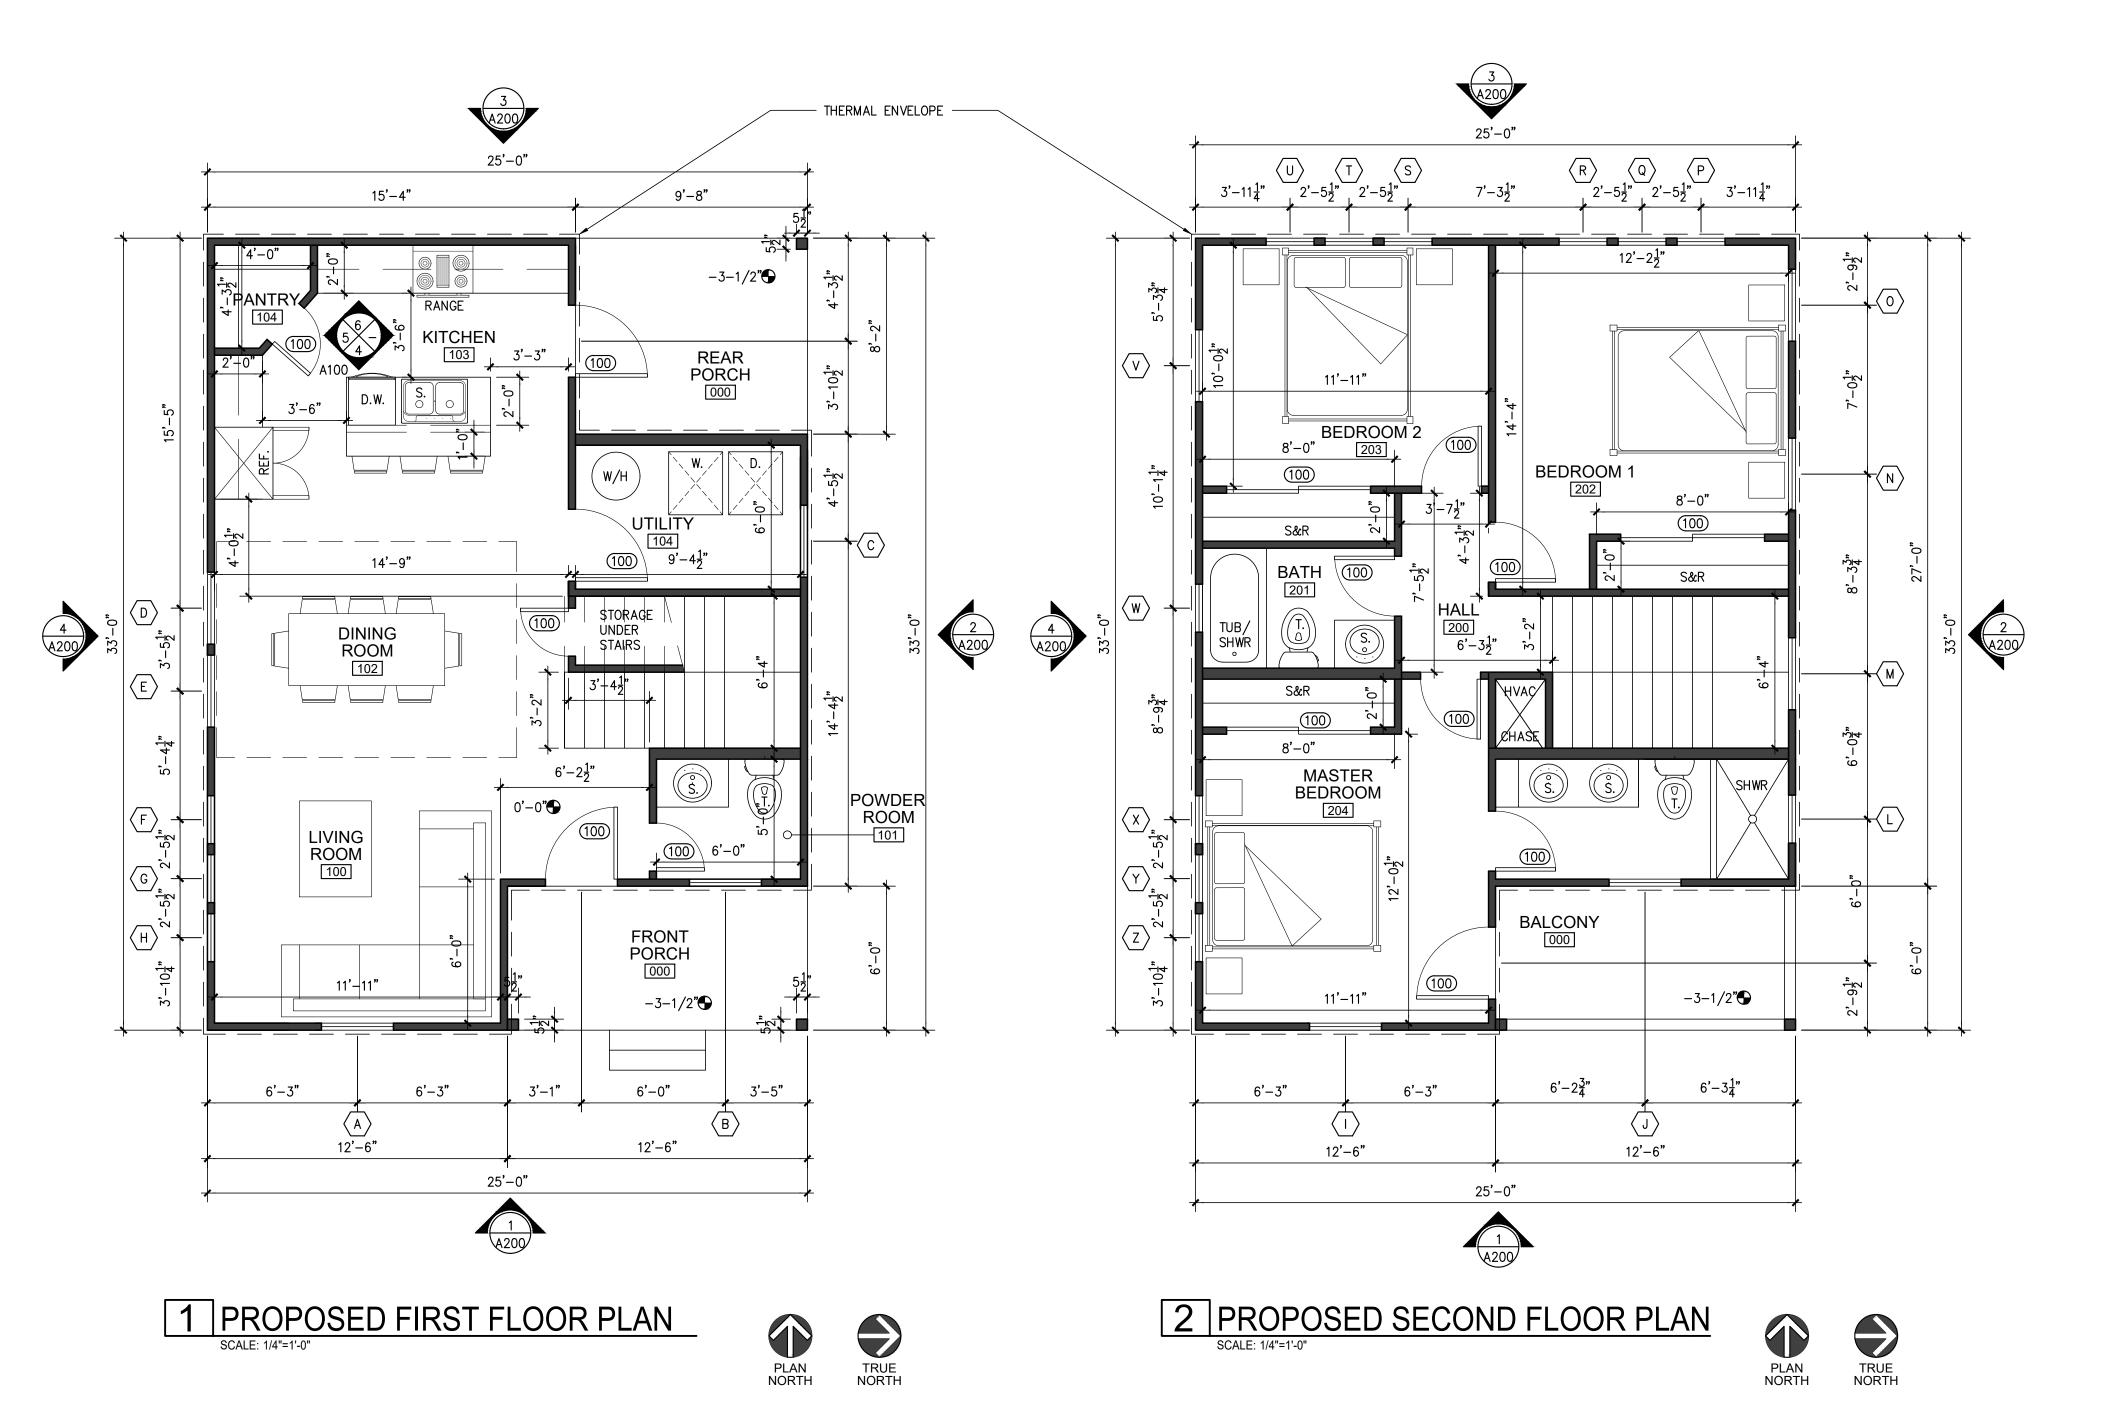

## 3 STAIR DIMENSION CONTROL DETAIL

### STAIR NOTE:

"Stair nosings shall comply with the following: R311.7.5.3 Nosings. The radius of curvature at the nosing shall be not greater than 9/16 inch. A nosing projection not less

than ¾ inch and not more than 1-1/4 inches shall be provided on stairways with solid risers. The greatest nosing projection shall not exceed the smallest nosing projection by more than 3/8 inch between two stories, including the nosing at the level of floors and landings. Beveling of nosings shall not exceed ½ inch.

Exception: A nosing projection is not required where the tread depth is not less than 11 inches."



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RESIDENCE

LLC BUILDING 78202 313 N. PINE ST. - LOT 8, SAN ANTONIO, TX **FINANCIAL** HENNEKE

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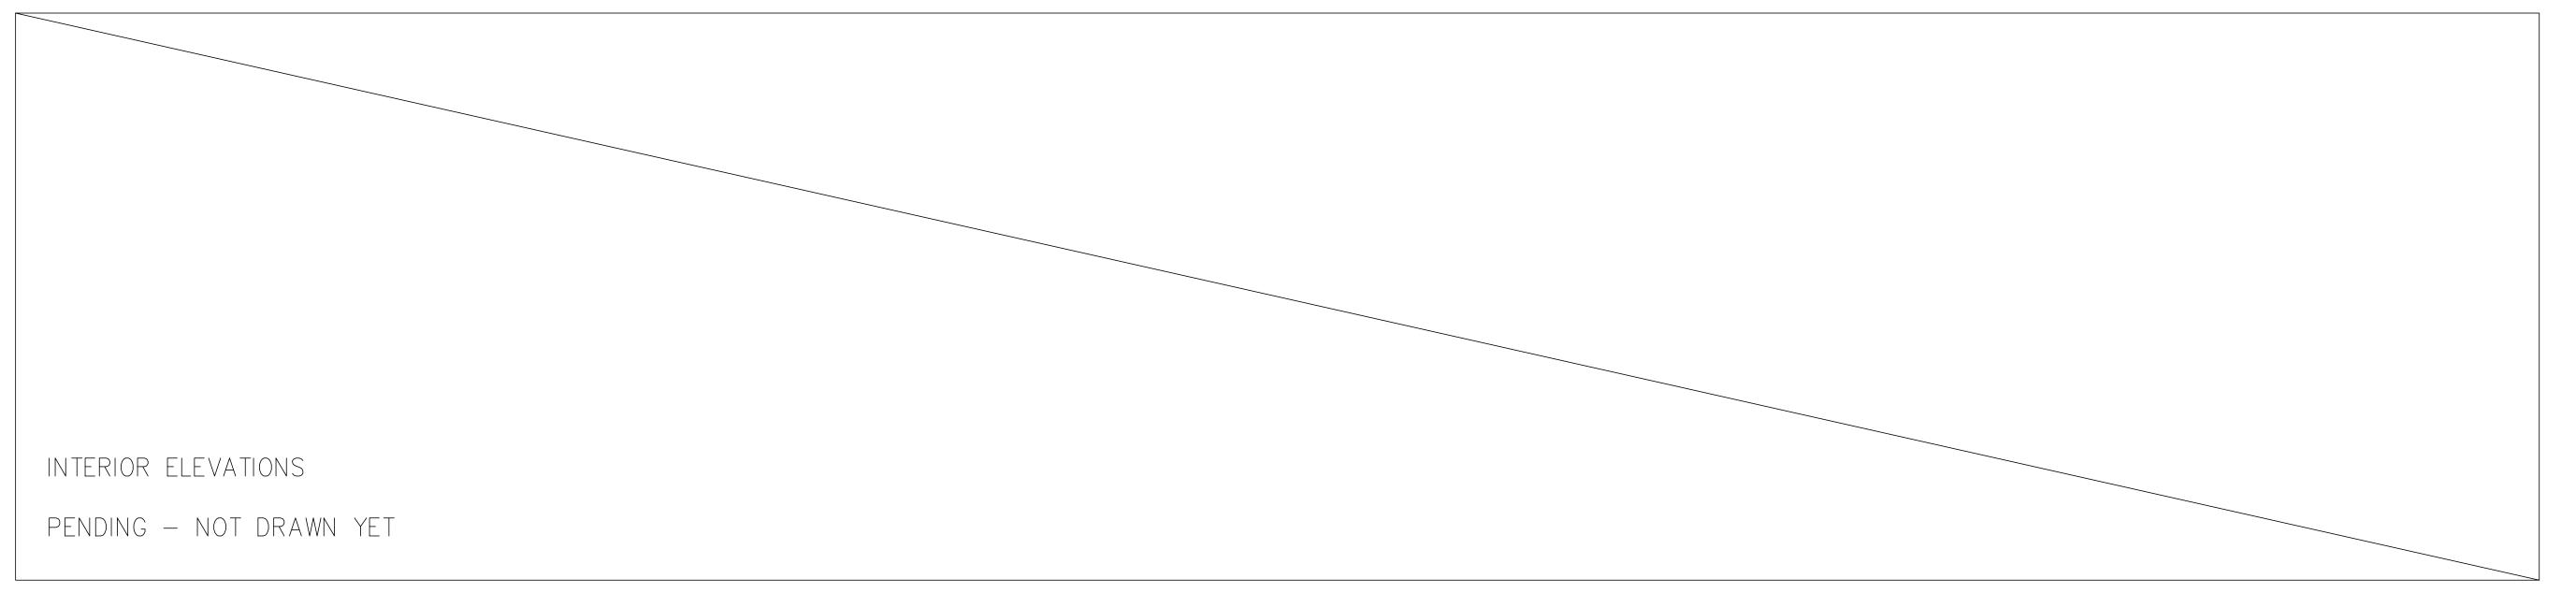
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PROPOSED FLOOR **PLANS** 

20-136 PROJECT NO. 10-01-20 DRAWN BY: FJZ **REVIEWED BY:** PROJECT ARCHITECT:

FELIX J. ZIGA JR., AIA TEXAS LICENSE NO. 24683






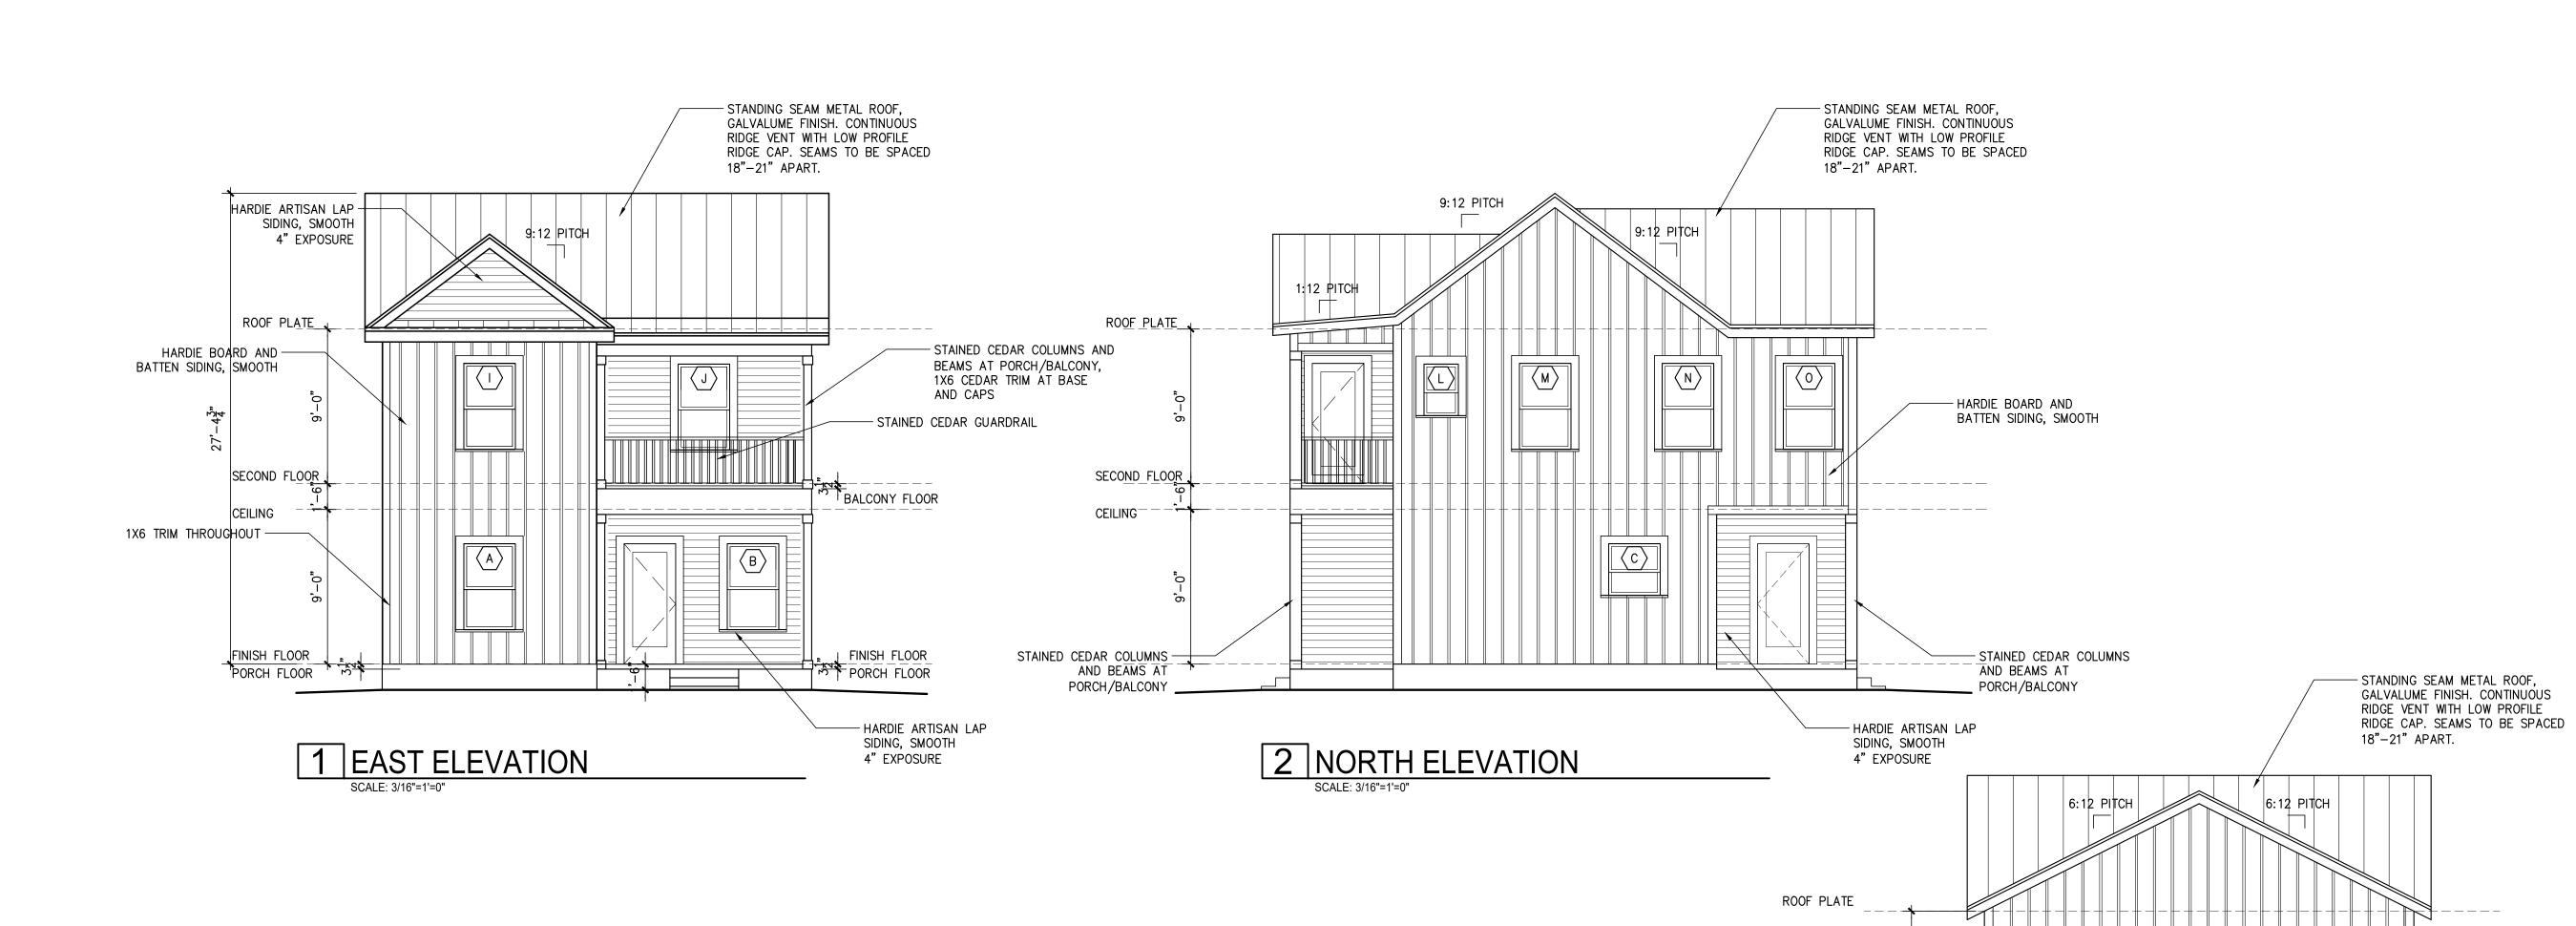


TABLE R402.4.1.1 AIR BARRIER AND INSULATION INSTALLATION						
COMPONENT	AIR BARRIER CRITERIA	INSULATION INSTALLATION CRITERIA				
General requirements	A continuous air barrier shall be installed in the building envelope.  The exterior thermal envelope contains a continuous air barrier.  Breaks or joints in the air barrier shall be sealed.	Air-permeable insulation shall not be used as a sealing material.				
Ceiling/attic	The air barrier in any dropped ceiling/soffit shall be aligned with the insulation and any gaps in the air barrier shall be sealed.  Access openings, drop down stairs or knee wall doors to unconditioned attic spaces shall be sealed.	The insulation in any dropped ceiling/soffit shall be aligned with the air barrier.				
Walls	The junction of the foundation and sill plate shall be sealed.  The junction of the top plate and the top of exterior walls shall be sealed.  Knee walls shall be sealed.	Cavities within corners and headers of frame walls shall be insulated by completely filling the cavity with a material having a thermal resistance of R-3 per inch minimum.  Exterior thermal envelope insulation for framed walls shall be installed in substantial contact and continuous alignment with the air barrier.				
Windows, skylights and doors	The space between window/door jambs and framing,					
Rim joists	and skylights and framing shall be sealed.  Rim joists shall include the air barrier.	Rim joists shall be insulated.				
Floors (including above garage and cantilevered floors)	The air barrier shall be installed at any exposed edge of insulation.	Floor framing cavity insulation shall be installed to maintain permanent contact with the underside of subfloor decking, or floor framing cavity insulation shall be permitted to be in contact with the top side of sheathing, or continuous insulation installed on the underside of floor framing and extends from the bottom to the top of all perimeter floor framing members.				
Crawl space walls	Exposed earth in unvented crawl spaces shall be covered with a Class I vapor retarder with overlapping joints taped.	Where provided instead of floor insulation, insulation shall be permanently attached to the crawlspace walls.				
Shafts, penetrations	Duct shafts, utility penetrations, and flue shafts opening to exterior or unconditioned space shall be sealed.					
Narrow cavities		Batts in narrow cavities shall be cut to fit, or narrow cavities shall be filled by insulation that on installation readily conforms to the available cavity space.				
Garage separation	Air sealing shall be provided between the garage and conditioned spaces.					
Recessed lighting	Recessed light fixtures installed in the building thermal envelope shall be sealed to the drywall.	Recessed light fixtures installed in the building thermal envelope shall be air tight and IC rated.				
Plumbing and wiring		Batt insulation shall be cut neatly to fit around wiring and plumbing in exterior walls, or insulation that on installation readily conforms to available space shall extend behind piping and wiring.				
Shower/tub on exterior wall	The air barrier installed at exterior walls adjacent to showers and tubs shall separate them from the showers and tubs.	Exterior walls adjacent to showers and tubs shall be insulated.				
Electrical/phone box on exterior walls	The air barrier shall be installed behind electrical or communication boxes or air-sealed boxes shall be installed.					
HVAC register boots	HVAC register boots that penetrate building thermal envelope shall be sealed to the subfloor or drywall.					
Concealed sprinklers	When required to be sealed, concealed fire sprinklers shall only be sealed in a manner that is recommended by the manufacturer. Caulking or other adhesive sealants shall not be used to fill voids between fire sprinkler cover plates and walls or ceilings.					

a. In addition, inspection of log walls shall be in accordance with the provisions of ICC-400.

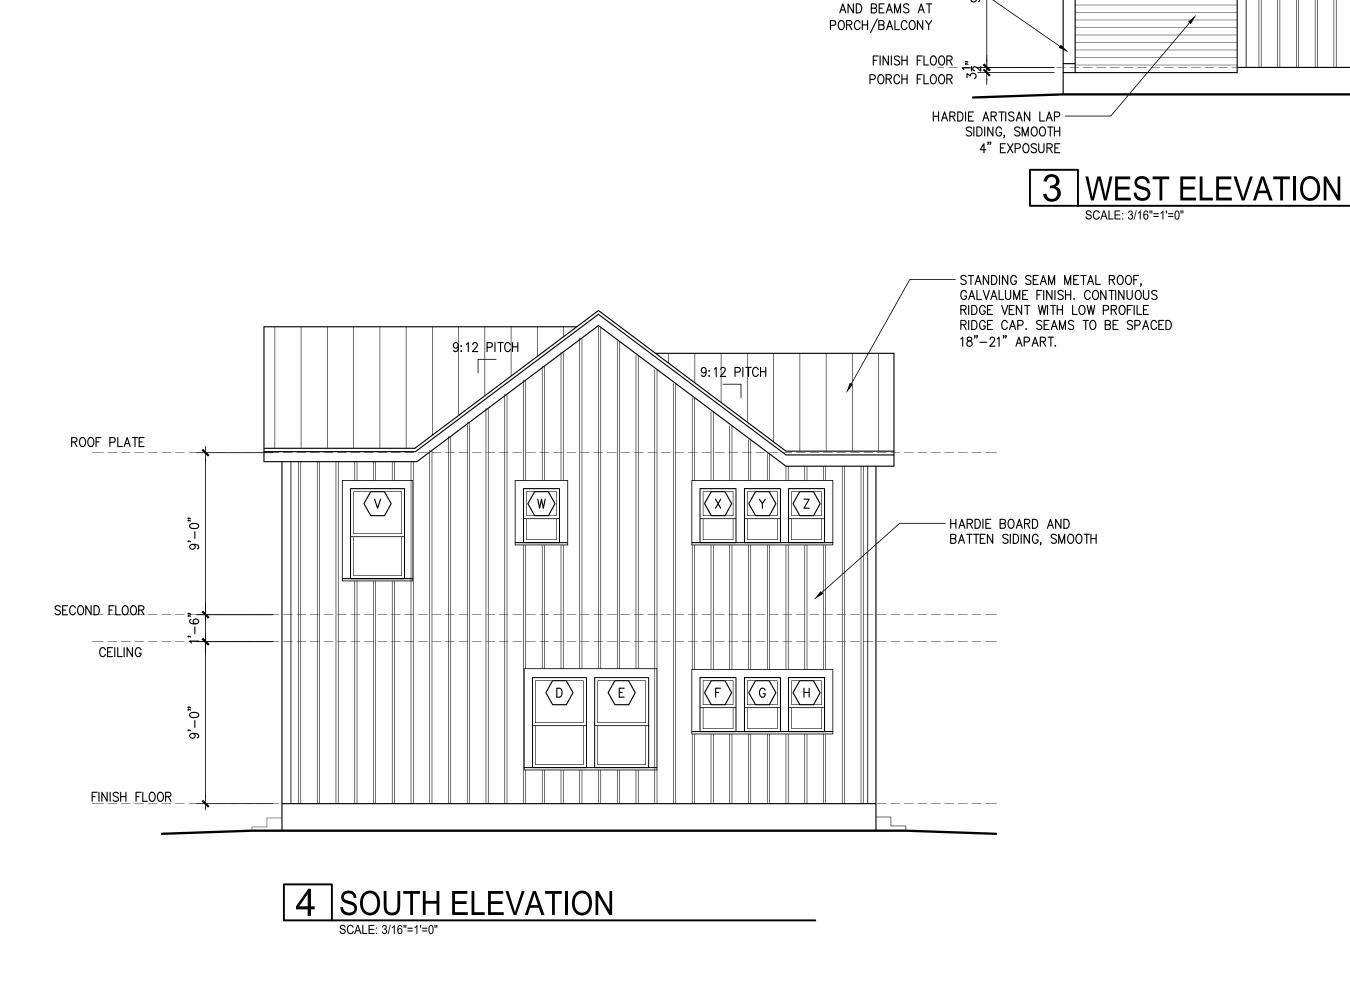

SECOND FLOOR

STAINED CEDAR COLUMNS -

CEILING



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BUILDING 78202 RESIDENCE Α, Τ Α, NEW 313 N. F

**FINANCIAL** 

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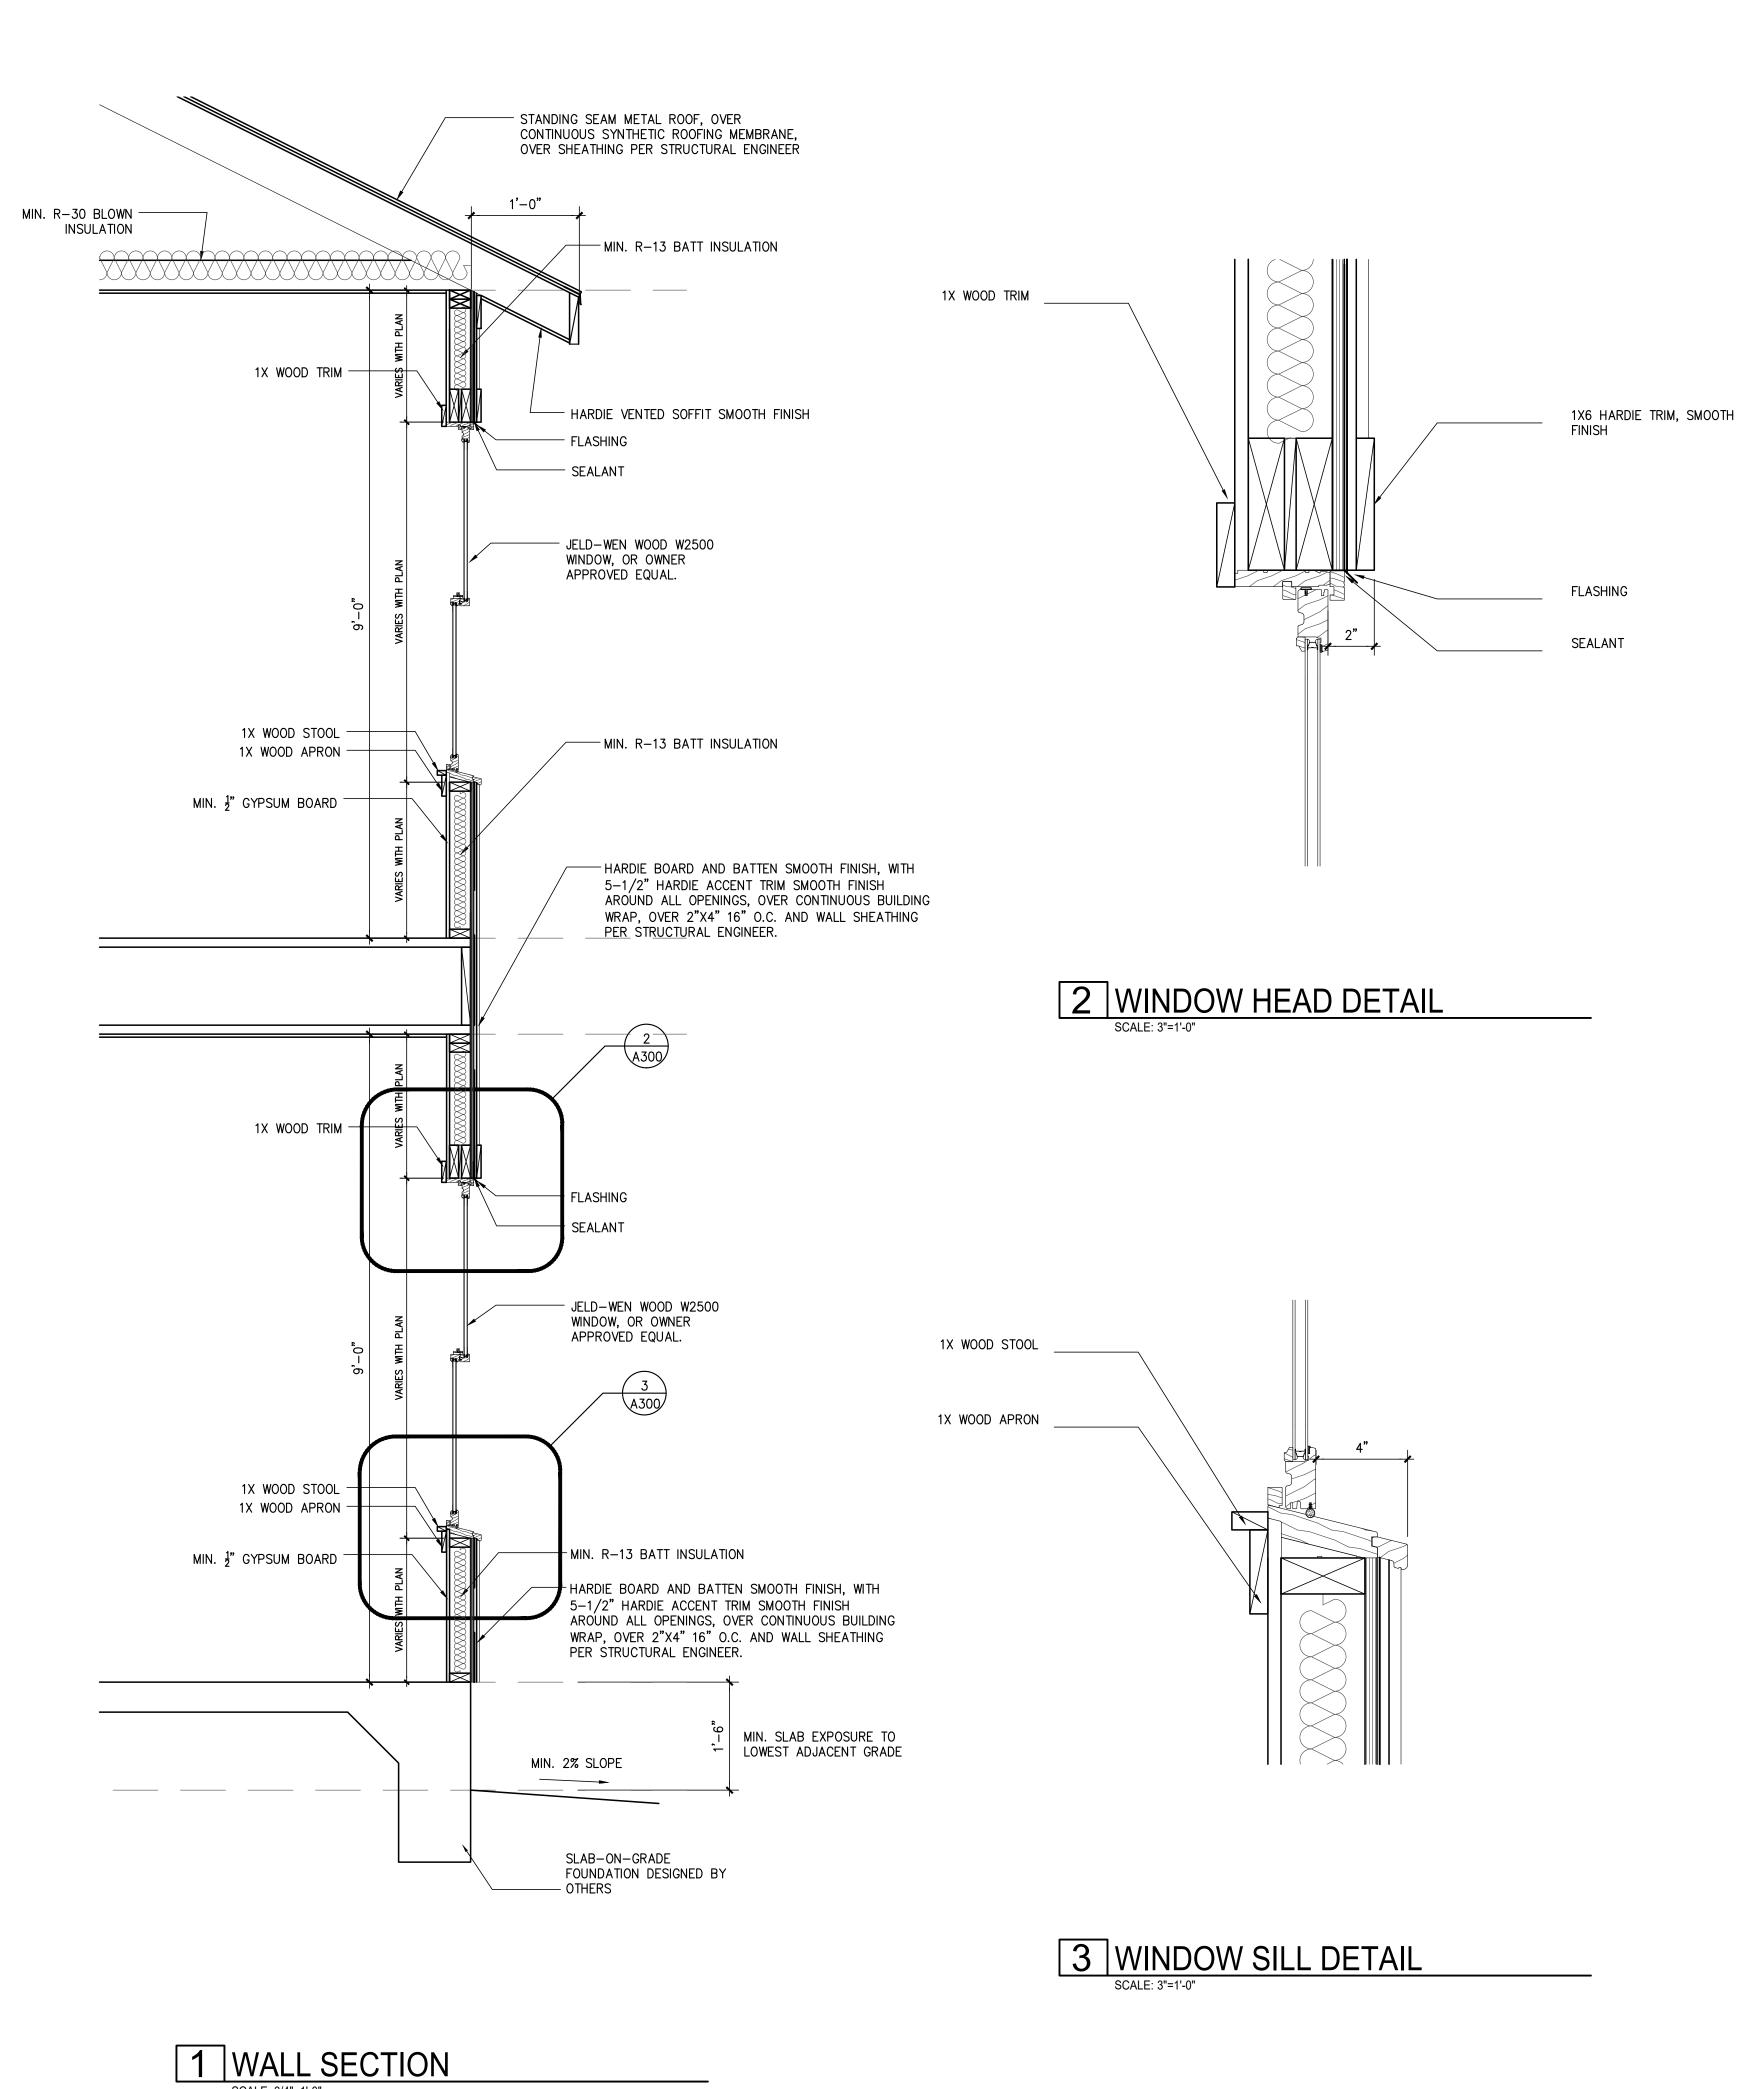
BATTEN SIDING, SMOOTH


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ISSUE DESCRIPTION HDRC FINAL 10/15/2020 HDRC FINAL REV.

### PROPOSED EXTERIOR **ELEVATIONS**

PROJECT NO.	20-136	
DATE:	10-01-20	
DRAWN BY:	FJZ	
REVIEWED BY:	FJZ	
PROJECT ARCHITECT:		
FELIX J. ZIGA JR., AIA		
TEXAS LICENSE NO. 24683		



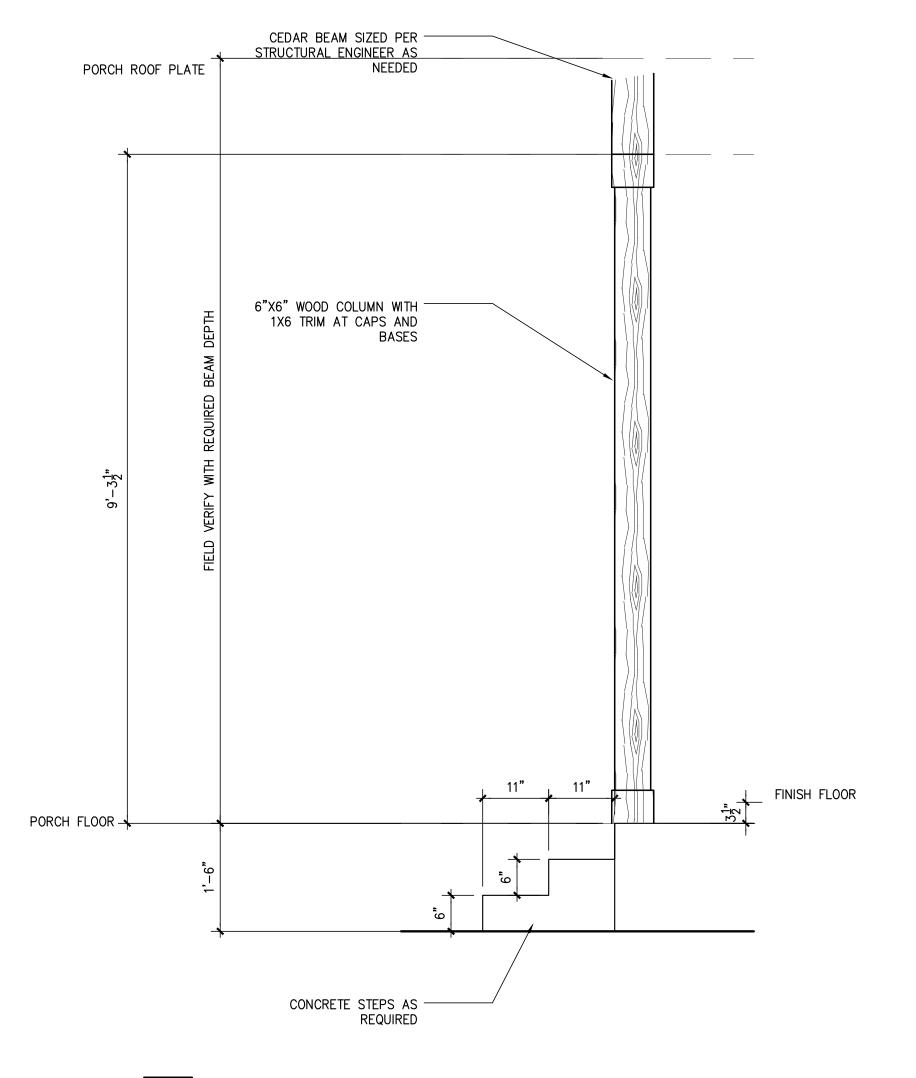

4 TYPICAL CEDAR COLUMN DETAIL
SCALE: 3/4"=1'-0"



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SUILDING 1

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3

HENNEKE

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ISSUE DATE DESCRIPTION

1 10/02/2020 HDRC FINAL 2 10/15/2020 HDRC FINAL REV.

WALL SECTION AND DETAILS

PROJECT NO. 20-136

DATE: 10-01-20

DRAWN BY: FJZ

REVIEWED BY: FJZ


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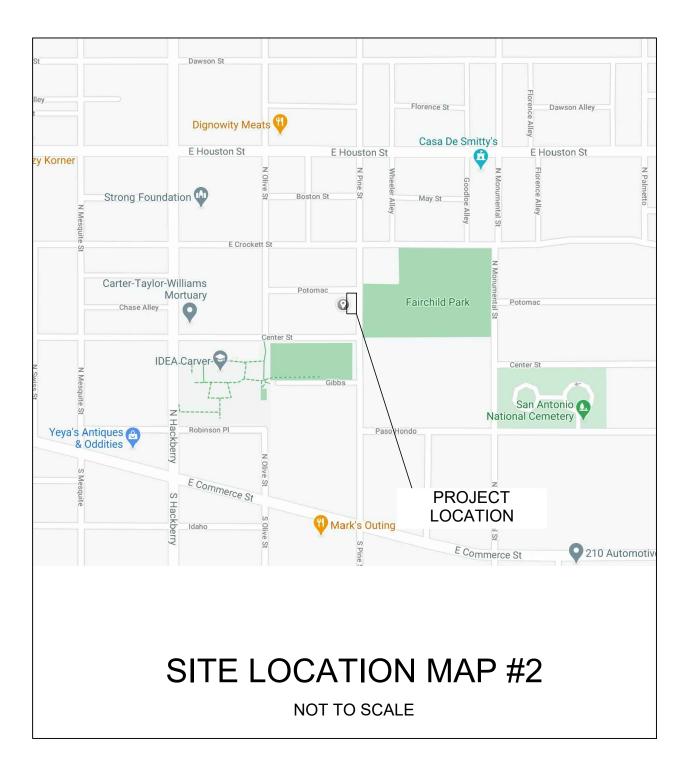
A300

# NEW RESIDENCE

## 313 N PINE ST - LOT 8, BUILDING 2, SAN ANTONIO, TX 78202





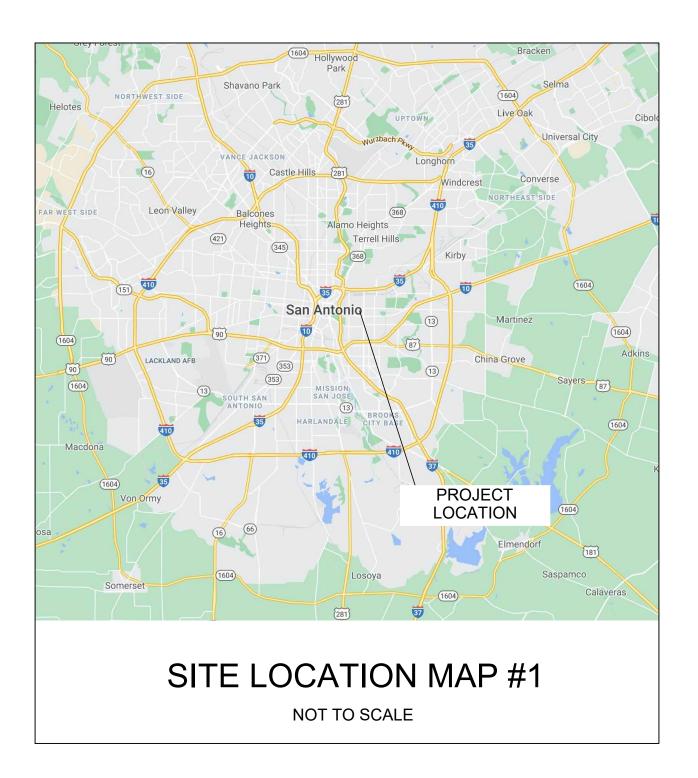

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15. THE CONTRACTOR IS REQUIRED TO TAKE DUE PRECAUTIONARY MEASURES TO PROTECT THE UTILITIES OR STRUCTURES AT THE SITE. IT SHALL BE THE CONTRACTOR'S RESPONSIBILITY TO NOTIFY THE OWNER OF UTILITIES OR STRUCTURES CONCERNED BEFORE STARTING WORK. THE CONTRACTOR SHALL NOTIFY THE PROPER UTILITY IMMEDIATELY UPON BREAK OR DAMAGE TO ANY UTILITY LINE OR APPURTENANCE. OR THE INTERRUPTION OF THEIR SERVICE. HE SHALL NOTIFY THE PROPER UTILITY INVOLVED, IF EXISTING UTILITY CONSTRUCTION CONFLICTS WITH REQUIREMENTS, THE CONTRACTOR SHALL NOTIFY THE ENGINEER SO THAT THE CONFLICT MAY BE RESOLVED.

INSTALL ALL MANUFACTURED ITEMS, MATERIALS, AND EQUIPMENT IN STRICT ACCORDANCE WITH MANUFACTURER'S WRITTEN INSTRUCTIONS, EXCEPT THAT THE SPECIFICATIONS, WHERE MORE STRINGENT, SHALL GOVERN.

THE CONTRACTOR SHALL BE RESPONSIBLE FOR PROVIDING ALL TAPS, EXTENSIONS, WATER, AND ELECTRICITY FOR ALL PROJECT FUNCTIONS, OFFICE, STORAGE, ETC.

THE CONTRACTOR SHALL BE RESPONSIBLE FOR PROVIDING HIS OWN TELEPHONE, TOILET, VALVES, OR OTHER DEVICES NECESSARY TO RUN POWER TOOLS AND EQUIPMENT. SUCH MODIFICATIONS TO EXISTING UTILITIES SHALL BE REMOVED AT COMPLETION OF THE

 CONTRACTOR SHALL SUBMIT SHOP DRAWINGS TO THE ARCHITECT IN A TIMELY MANNER THAT WILL ALLOW NOT LESS THAN 10 DAYS FOR REVIEW. THE GENERAL CONTRACTOR SHALL SUBMIT CORRECT NUMBER REQUIRED, BUT NOT LESS THAN 4

20. THE GENERAL CONTRACTOR SHALL PROVIDE STREET NUMBERING ON THE BUILDING IN COMPLIANCE WITH LOCAL AUTHORITY.

ALL PENETRATIONS THRU WALLS SHALL BE SEALED AIR/WATER TIGHT AND CAULKED WITH 2 PART SEALANT EACH SIDE.

THE GENERAL CONTRACTOR SHALL PROVIDE (1) COPY OF AS-BUILT DRAWINGS TO THE OWNER AT THE COMPLETION OF THE PROJECT. AS-BUILT DRAWINGS SHALL BE KEPT ON THE JOB AT ALL TIMES AND UPDATED THROUGHOUT THE CONSTRUCTION PHASE.

UNLESS NOTED OTHERWISE, SITE PLAN DIMENSIONS ARE TO FACE OF CURB. FLOOR PLAN DIMENSIONS ARE TO FACE OF STUDS, FRAMING, MASONRY, CONCRETE WALL PANELS, OR FOUNDATION WALLS.

## SHEET INDEX

CS	COVER SHEET
SP100	SITE/ROOF PLAN
A100	PROPOSED FLOOR PLAN
A200	PROPOSED EXTERIOR ELEVATIONS
A300	TYPICAL WALL SECTION AND DETAILS
A500	ELECTRICAL FLOOR PLAN
A600	DOOR & WINDOW SCHEDULES

PENDING - NOT DRAWN YET

## **ARCHITECT**

ZIGA ARCHITECTURE STUDIO, PLLC

11723 WHISPER VALLEY ST, SAN ANTONIO, TX 78230 | 210-201-3637 1700 S LAMAR BLVD, STE 338, AUSTIN, TX 78704 | 512-522-5505 INFO@STUDIOZIGA.COM | WWW.STUDIOZIGA.COM

## **CODE INFORMATION**

2018 INTERNATIONAL RESIDENTIAL CODE 2018 IECC

## **BUILDING DATA**

SQ. FT.

671 S.F. 1ST FLOOR LIVING 750 S.F. 2ND FLOOR LIVING

1,421 S.F. TOTAL LIVING

173 S.F. 1ST FLOOR PORCH 75 S.F. 2ND FLOOR PORCH

248 S.F. TOTAL PORCH

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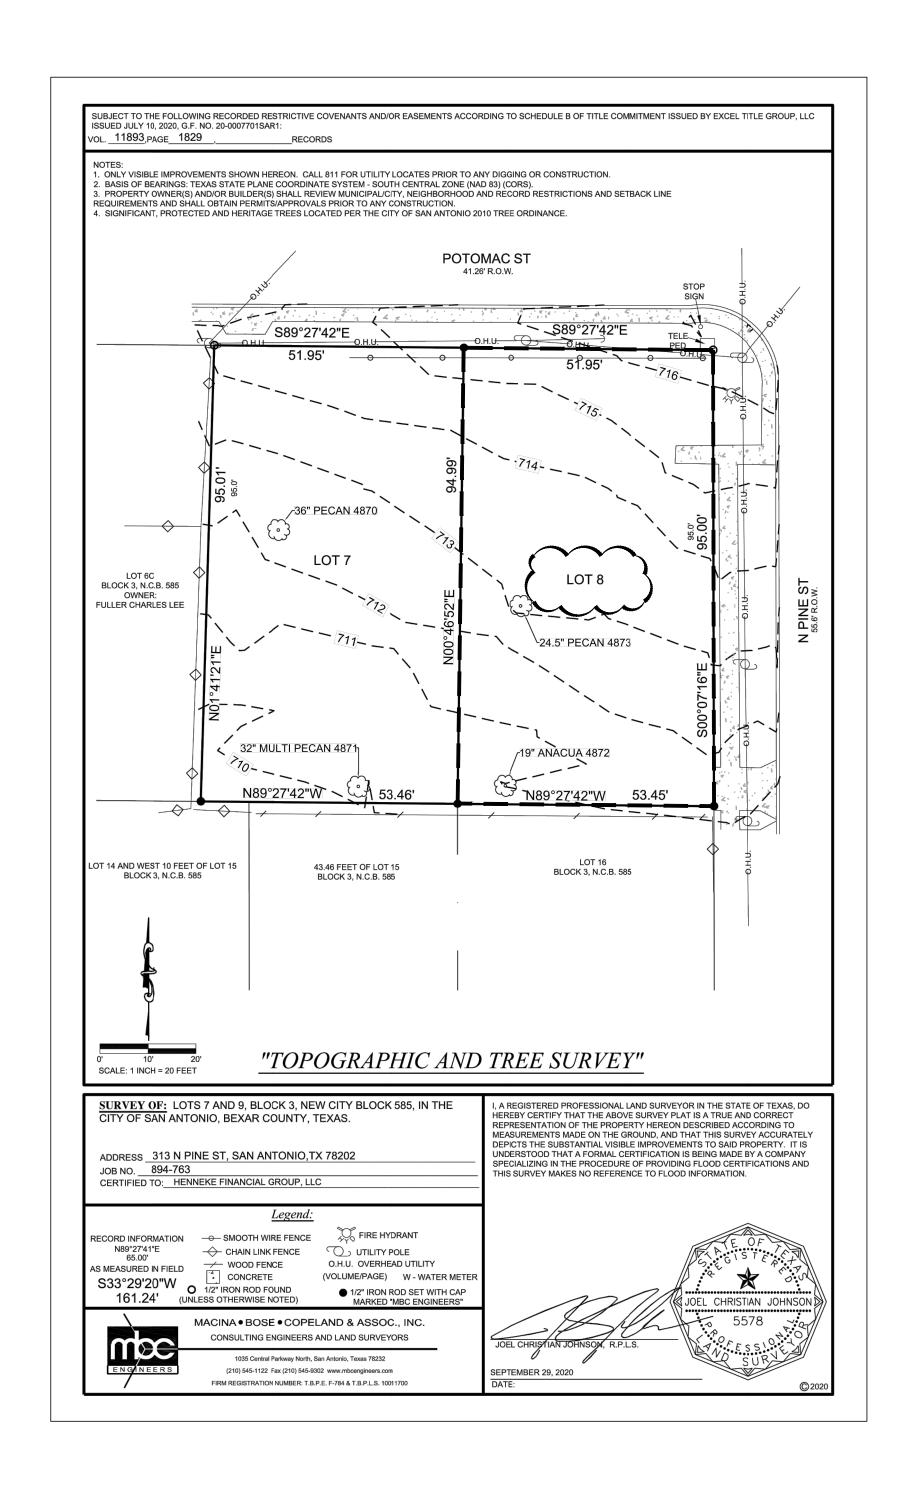
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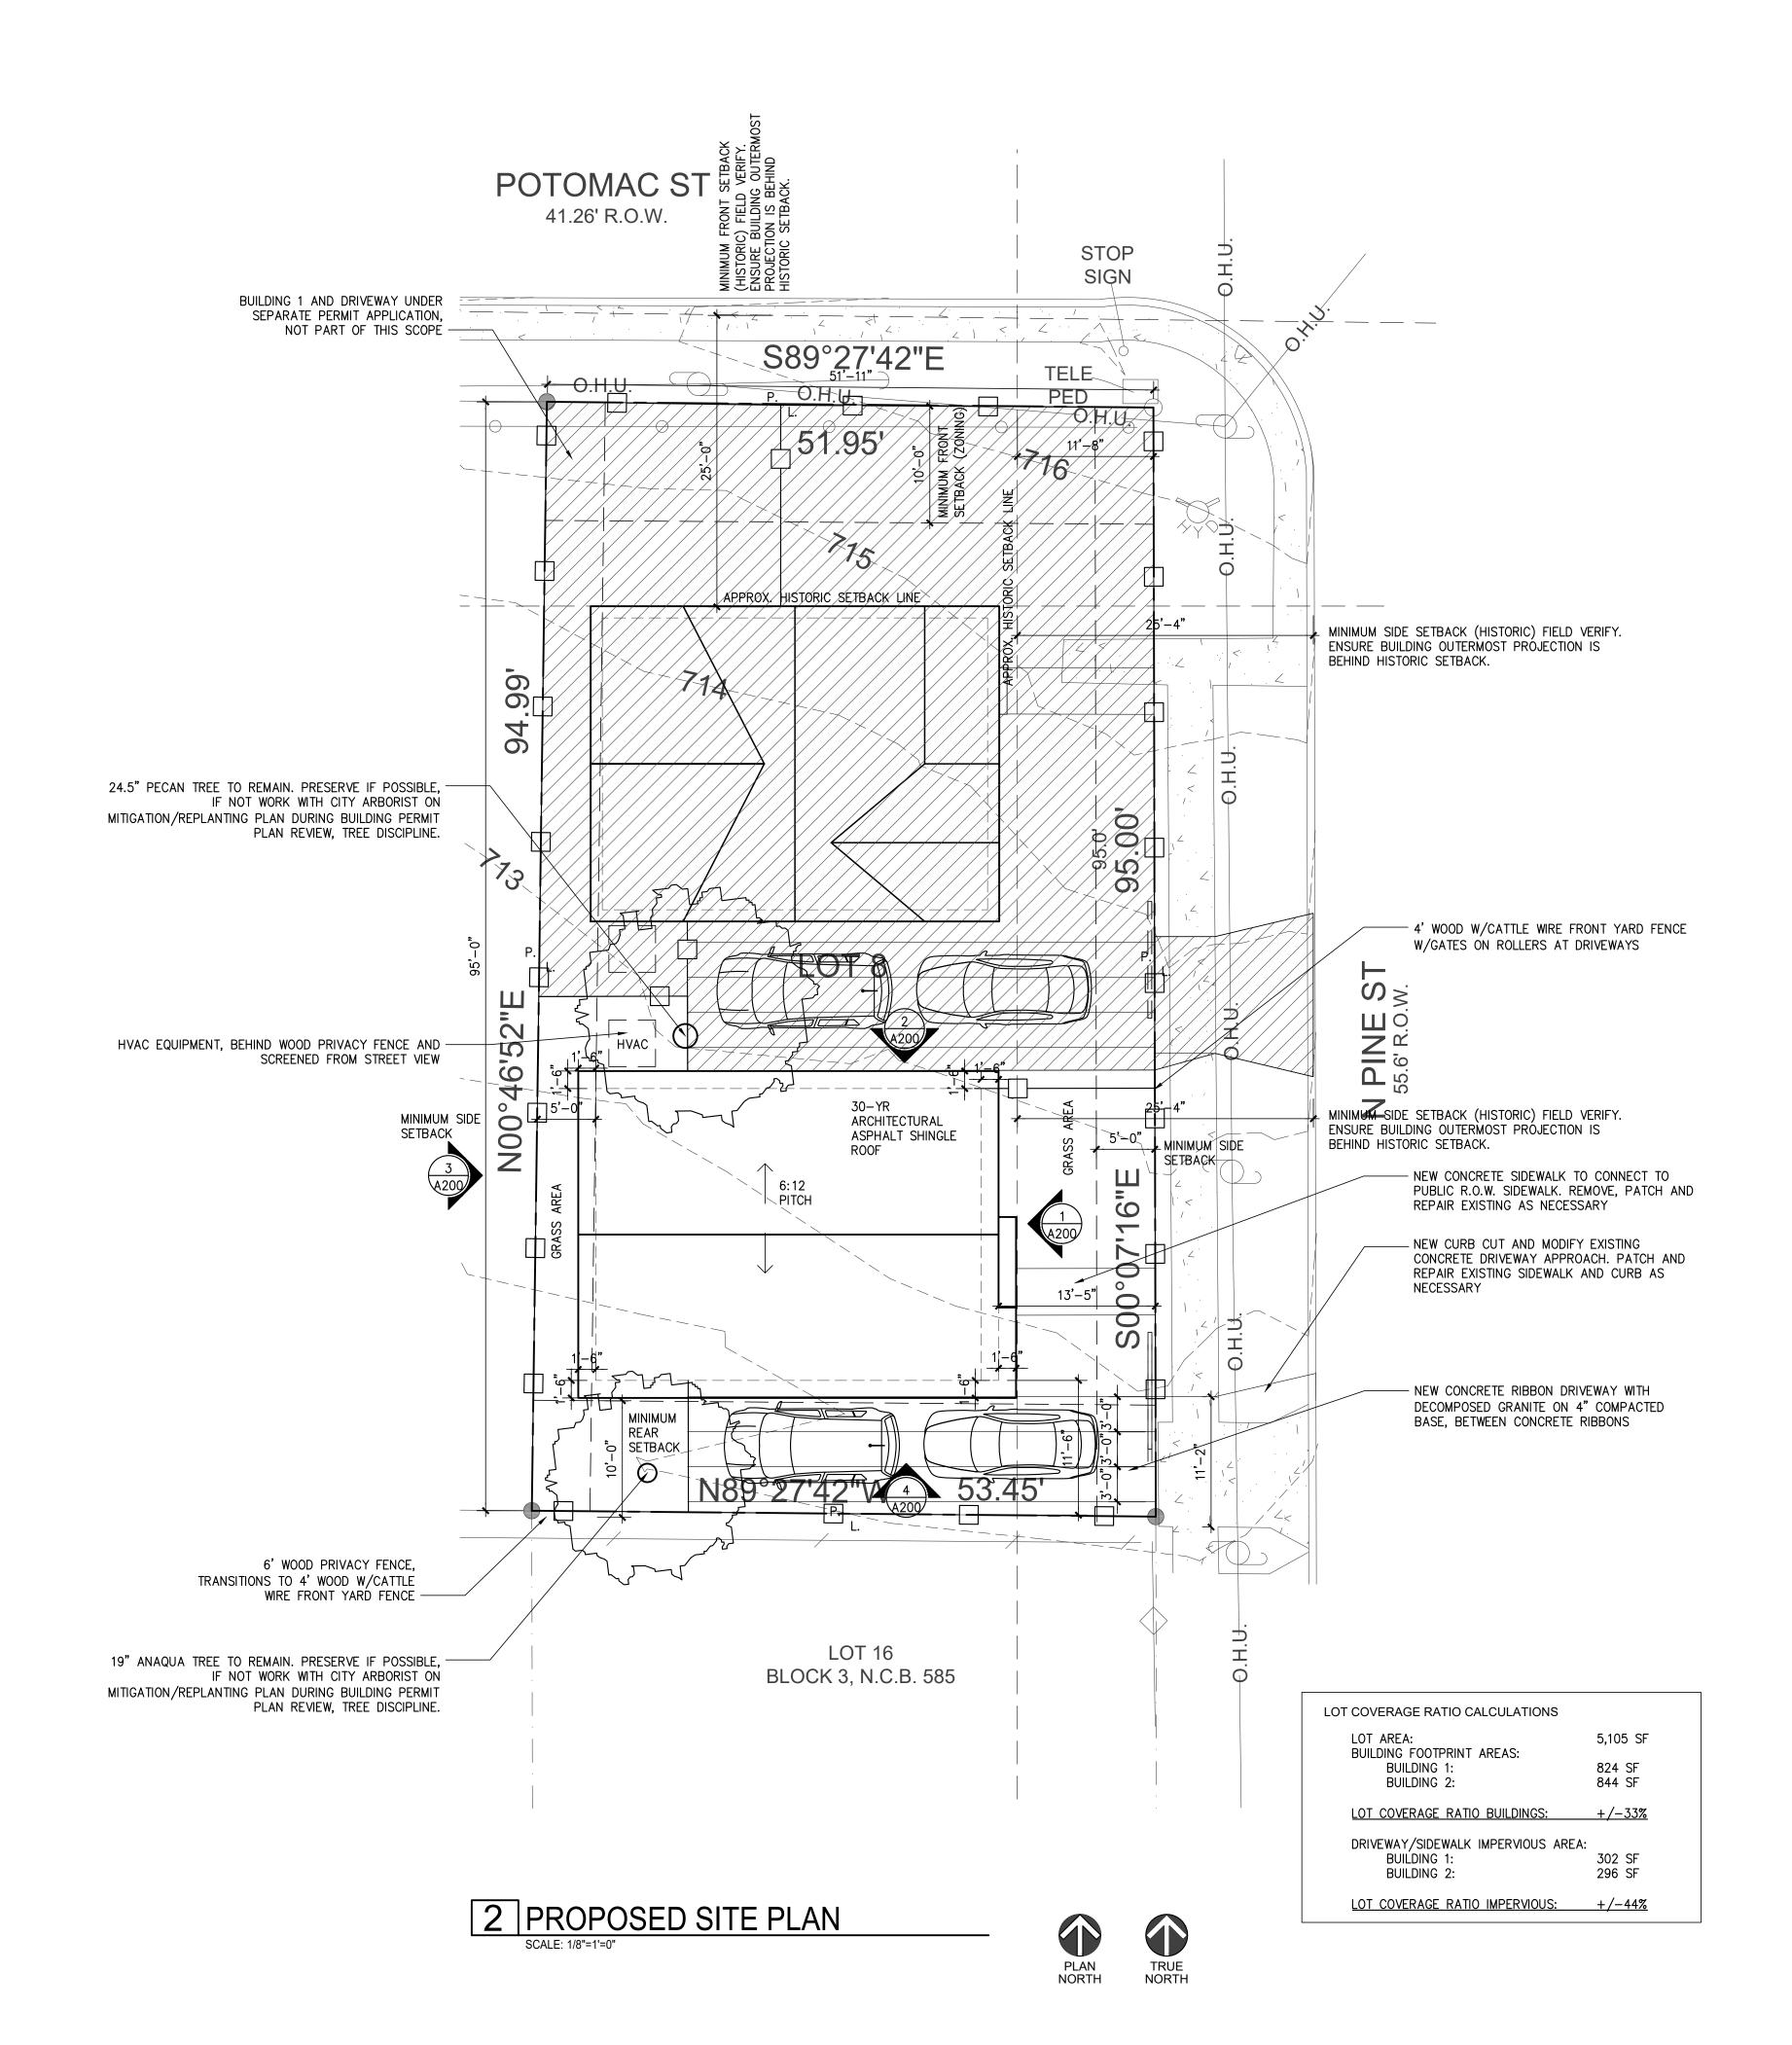
**COVER SHEET** 

20-136 PROJECT NO. 10-01-20 FJZ DRAWN BY: FJZ**REVIEWED BY:** PROJECT ARCHITECT: FELIX J. ZIGA JR., AIA

TEXAS LICENSE NO. 24683









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SIDENCE

HENNEKE 13

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3

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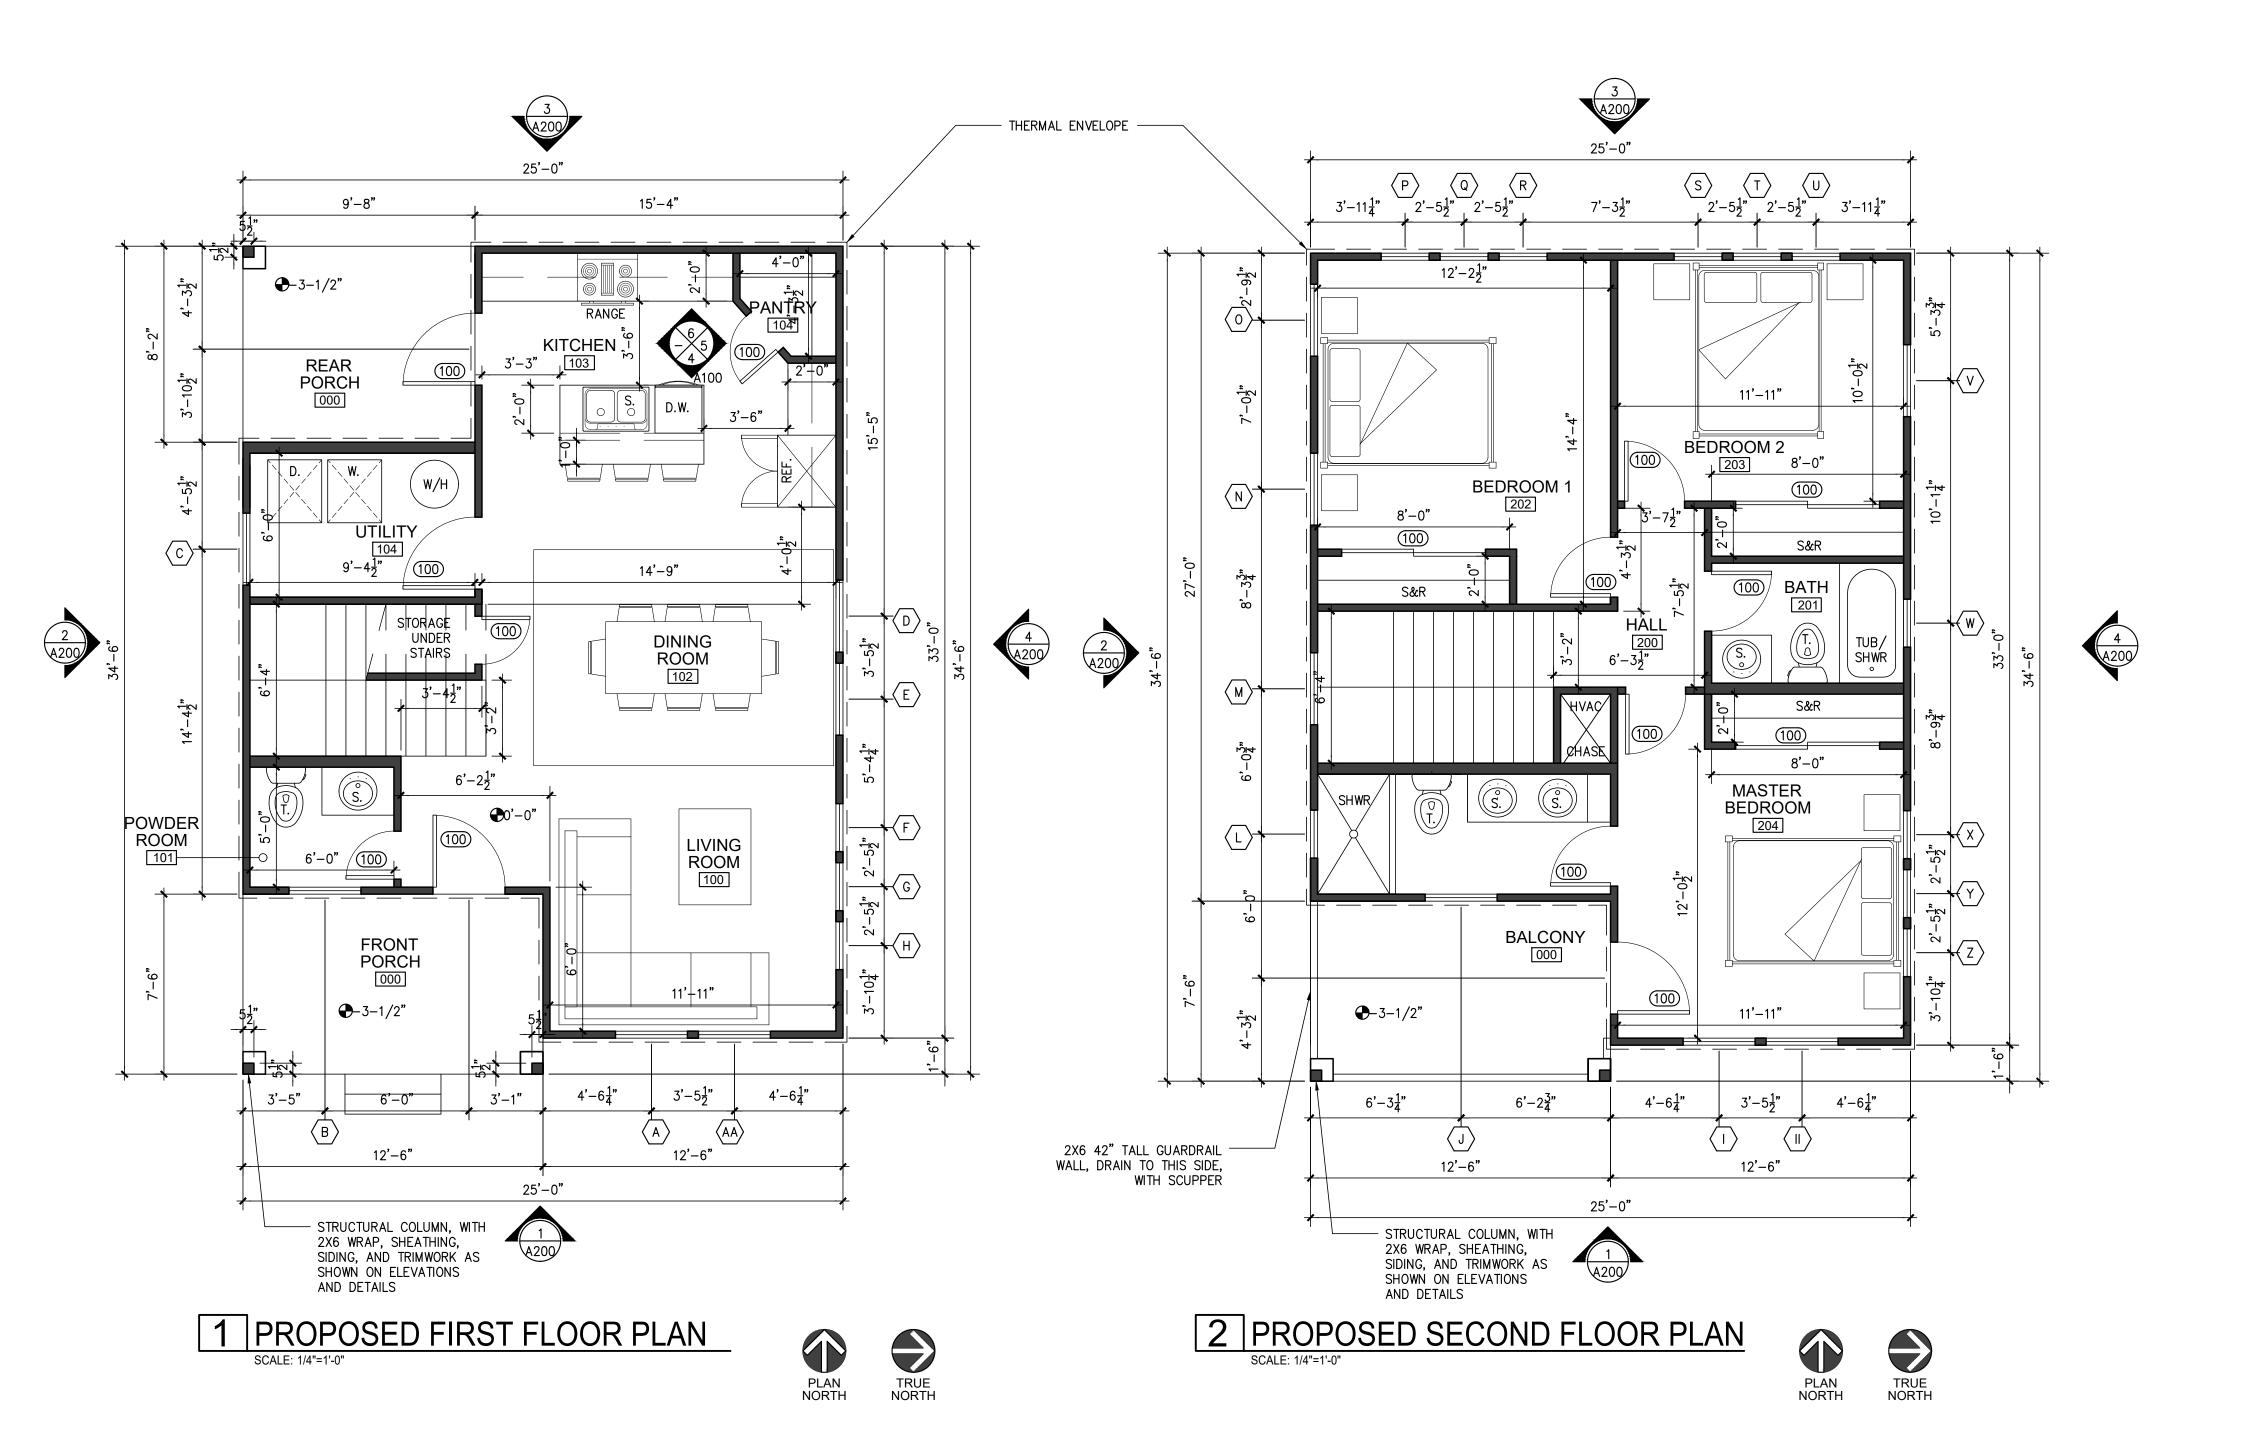
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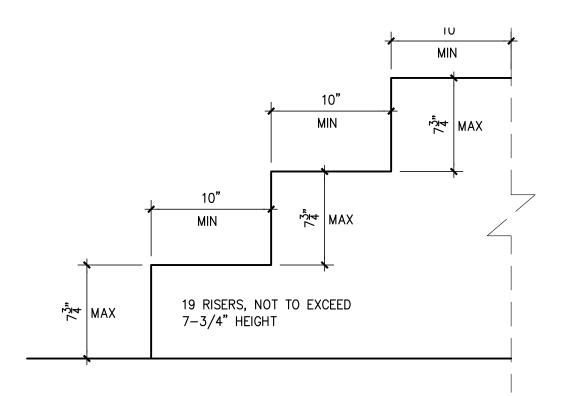
DESCRIPTION 10/02/2020 HDRC FINAL 10/15/2020 HDRC FINAL REV.

PROPOSED SITE/ROOF PLAN

20-136 PROJECT NO. 10-01-20 FJZ DRAWN BY: FJZ **REVIEWED BY:** PROJECT ARCHITECT:

FELIX J. ZIGA JR., AIA TEXAS LICENSE NO. 24683





## 3 STAIR DIMENSION CONTROL DETAIL

### STAIR NOTE:

"Stair nosings shall comply with the

following: R311.7.5.3 Nosings. The radius of curvature at the nosing shall be not greater than 9/16 inch. A nosing projection not less than ¾ inch and not more than 1-1/4 inches shall be provided on stairways with solid risers. The greatest nosing projection shall not exceed the smallest nosing projection by more than 3/8 inch between two stories, including the nosing at the level of floors and landings. Beveling of nosings shall not exceed ½ inch.

Exception: A nosing projection is not required where the tread depth is not less than 11 inches."



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RESIDENCE

2 BUILDING 78202 PINE ST. - LOT 8, SAN ANTONIO, TX 313 N.

LLC

GROUP,

HENNEKE FINANCIAL

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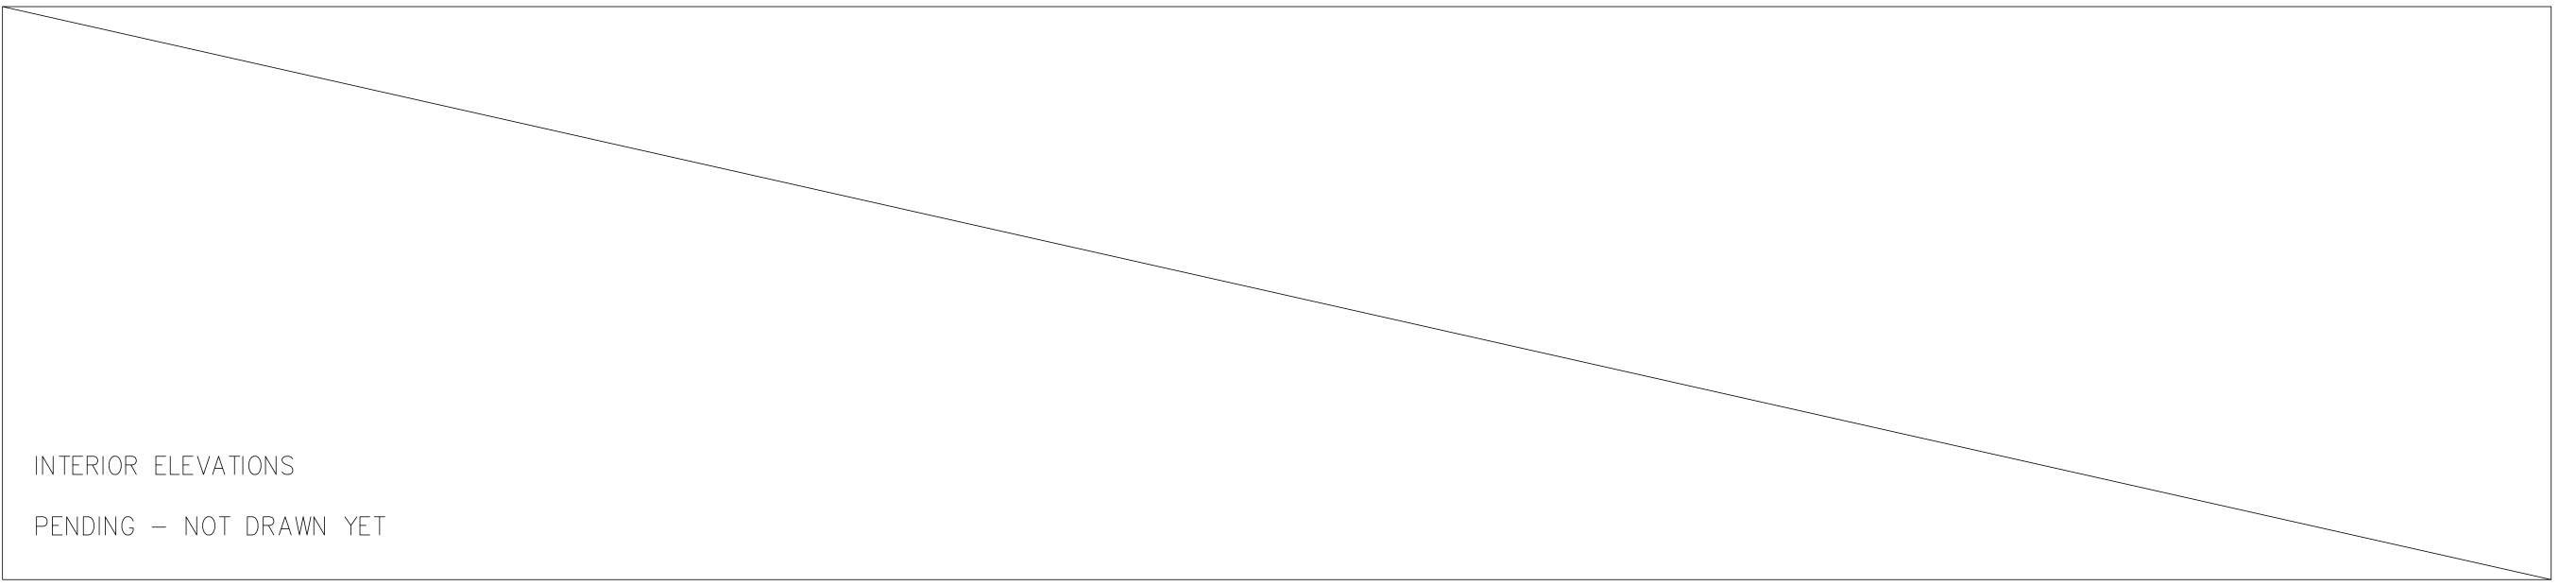
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PROPOSED FLOOR **PLANS** 

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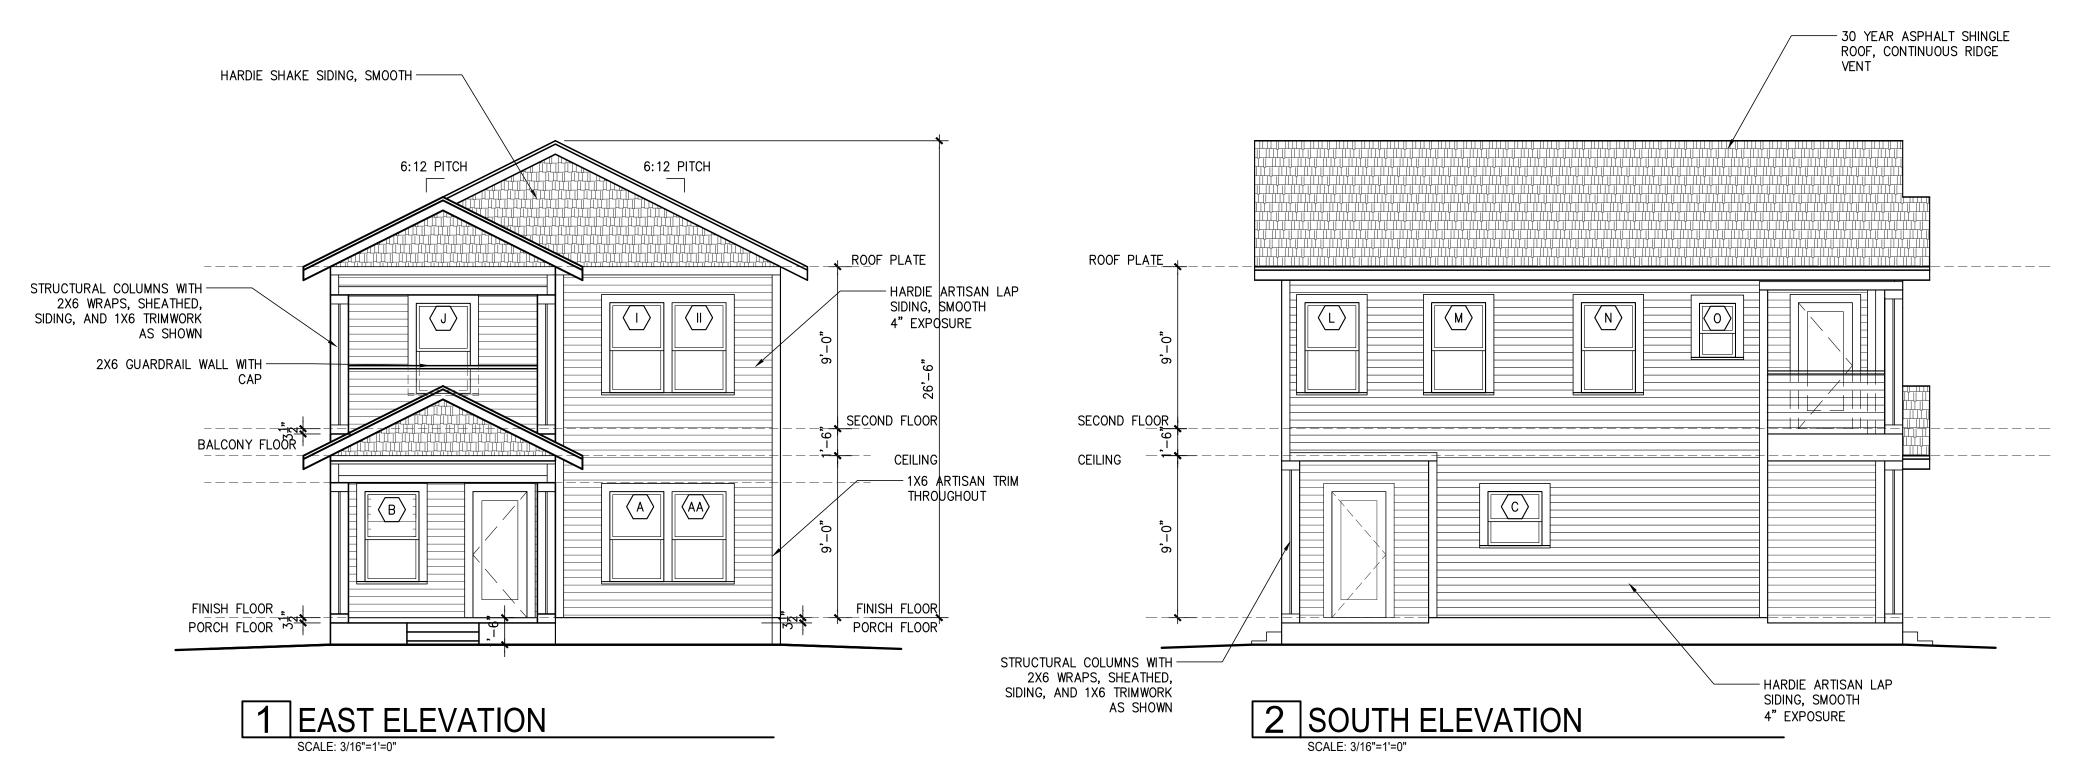
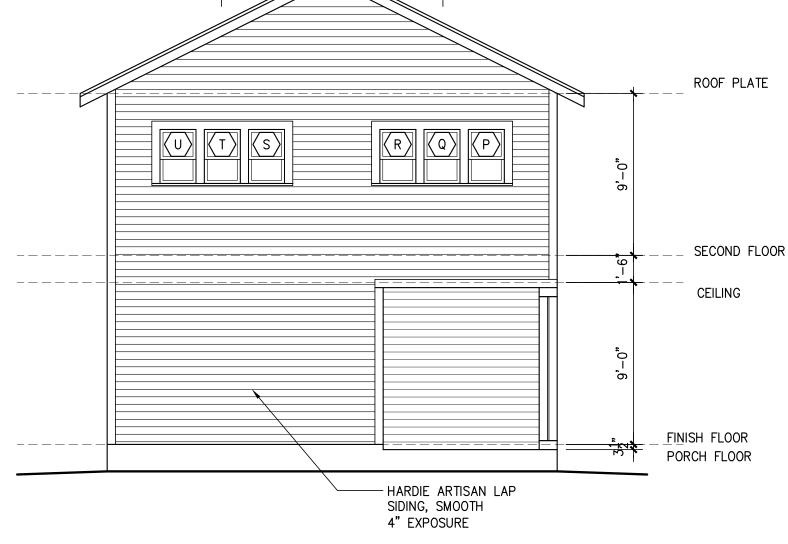



TABLE R402.4.1.1 AIR BARRIER AND INSULATION INSTALLATION						
COMPONENT	AIR BARRIER CRITERIA	INSULATION INSTALLATION CRITERIA				
General requirements	A continuous air barrier shall be installed in the building envelope.  The exterior thermal envelope contains a continuous air barrier.  Breaks or joints in the air barrier shall be sealed.	Air-permeable insulation shall not be used as a sealing material.				
Ceiling/attic	The air barrier in any dropped ceiling/soffit shall be aligned with the insulation and any gaps in the air barrier shall be sealed.  Access openings, drop down stairs or knee wall doors to unconditioned attic spaces shall be sealed.	The insulation in any dropped ceiling/soffit shall be aligned with the air barrier.				
Walls	The junction of the foundation and sill plate shall be sealed.  The junction of the top plate and the top of exterior walls shall be sealed.  Knee walls shall be sealed.	Cavities within corners and headers of frame walls shall be insulated by completely filling the cavity with a material having a thermal resistance of R-3 per inch minimum.  Exterior thermal envelope insulation for framed walls shall be installed in substantial contact and continuous alignment with the air barrier.				
Vindows, skylights and doors	The space between window/door jambs and framing, and skylights and framing shall be sealed.					
Rim joists	Rim joists shall include the air barrier.	Rim joists shall be insulated.				
Floors (including above garage and cantilevered floors)	The air barrier shall be installed at any exposed edge of insulation.	Floor framing cavity insulation shall be installed to maintain permanent contact with the underside of subfloor decking, or floor framing cavity insulation shall be permitted to be in contact with the top side of sheathing, or continuous insulation installed on the underside of floor framing and extends from the bottom to the top of all perimeter floor framing members.				
Crawl space walls	Exposed earth in unvented crawl spaces shall be covered with a Class I vapor retarder with overlapping joints taped.	Where provided instead of floor insulation, insulation shall be permanently attached to the crawlspace walls.				
Shafts, penetrations	Duct shafts, utility penetrations, and flue shafts opening to exterior or unconditioned space shall be sealed.					
Narrow cavities		Batts in narrow cavities shall be cut to fit, or narrow cavities shall be filled by insulation that on installation readily conforms to the available cavity space.				
Garage separation	Air sealing shall be provided between the garage and conditioned spaces.					
Recessed lighting	Recessed light fixtures installed in the building thermal envelope shall be sealed to the drywall.	Recessed light fixtures installed in the building thermal envelope shall be air tight and IC rated.				
Plumbing and wiring		Batt insulation shall be cut neatly to fit around wiring and plumbing in exterior walls, or insulation that on installation readily conforms to available space shall extend behind piping and wiring.				
Shower/tub on exterior wall	The air barrier installed at exterior walls adjacent to showers and tubs shall separate them from the showers and tubs.	Exterior walls adjacent to showers and tubs shall be insulated.				
Electrical/phone box on exterior walls	The air barrier shall be installed behind electrical or communication boxes or air-sealed boxes shall be installed.					
HVAC register boots	HVAC register boots that penetrate building thermal envelope shall be sealed to the subfloor or drywall.					
Concealed sprinklers	When required to be sealed, concealed fire sprinklers shall only be sealed in a manner that is recommended by the manufacturer. Caulking or other adhesive sealants shall not be used to fill voids between fire sprinkler cover plates and walls or ceilings.					

a. In addition, inspection of log walls shall be in accordance with the provisions of ICC-400.



6:12 PITCH

3 WEST ELEVATION

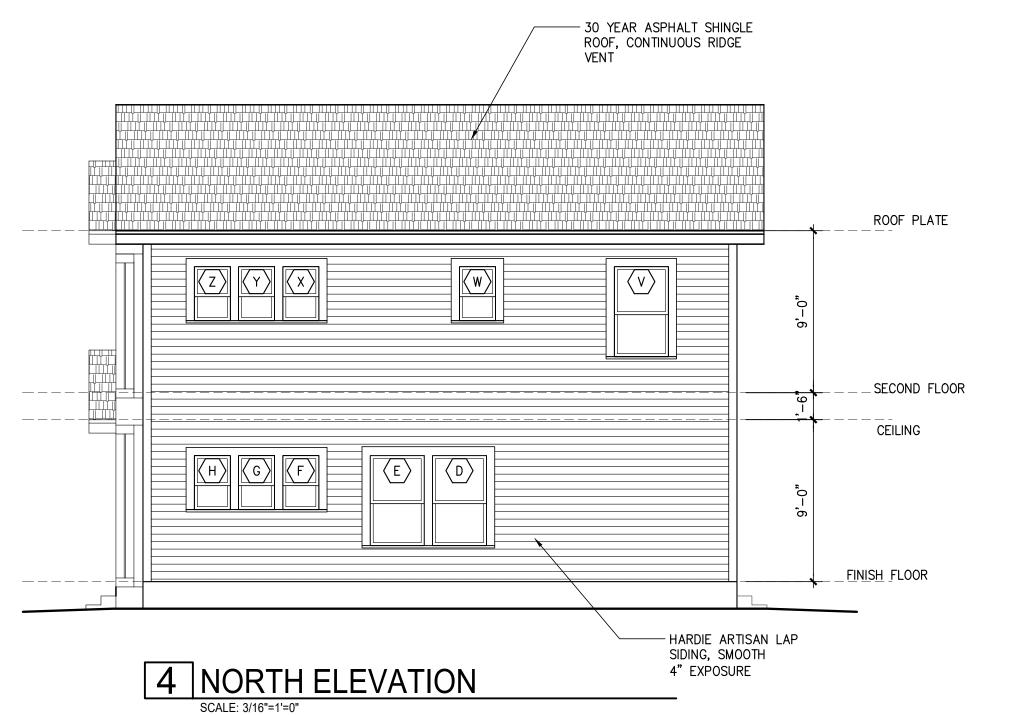



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7 BUILDING 7 ω, <u>Χ</u> 313 N. PINE ST. - LO SAN ANTONIO

**FINANCIAL** 

RESIDENCE

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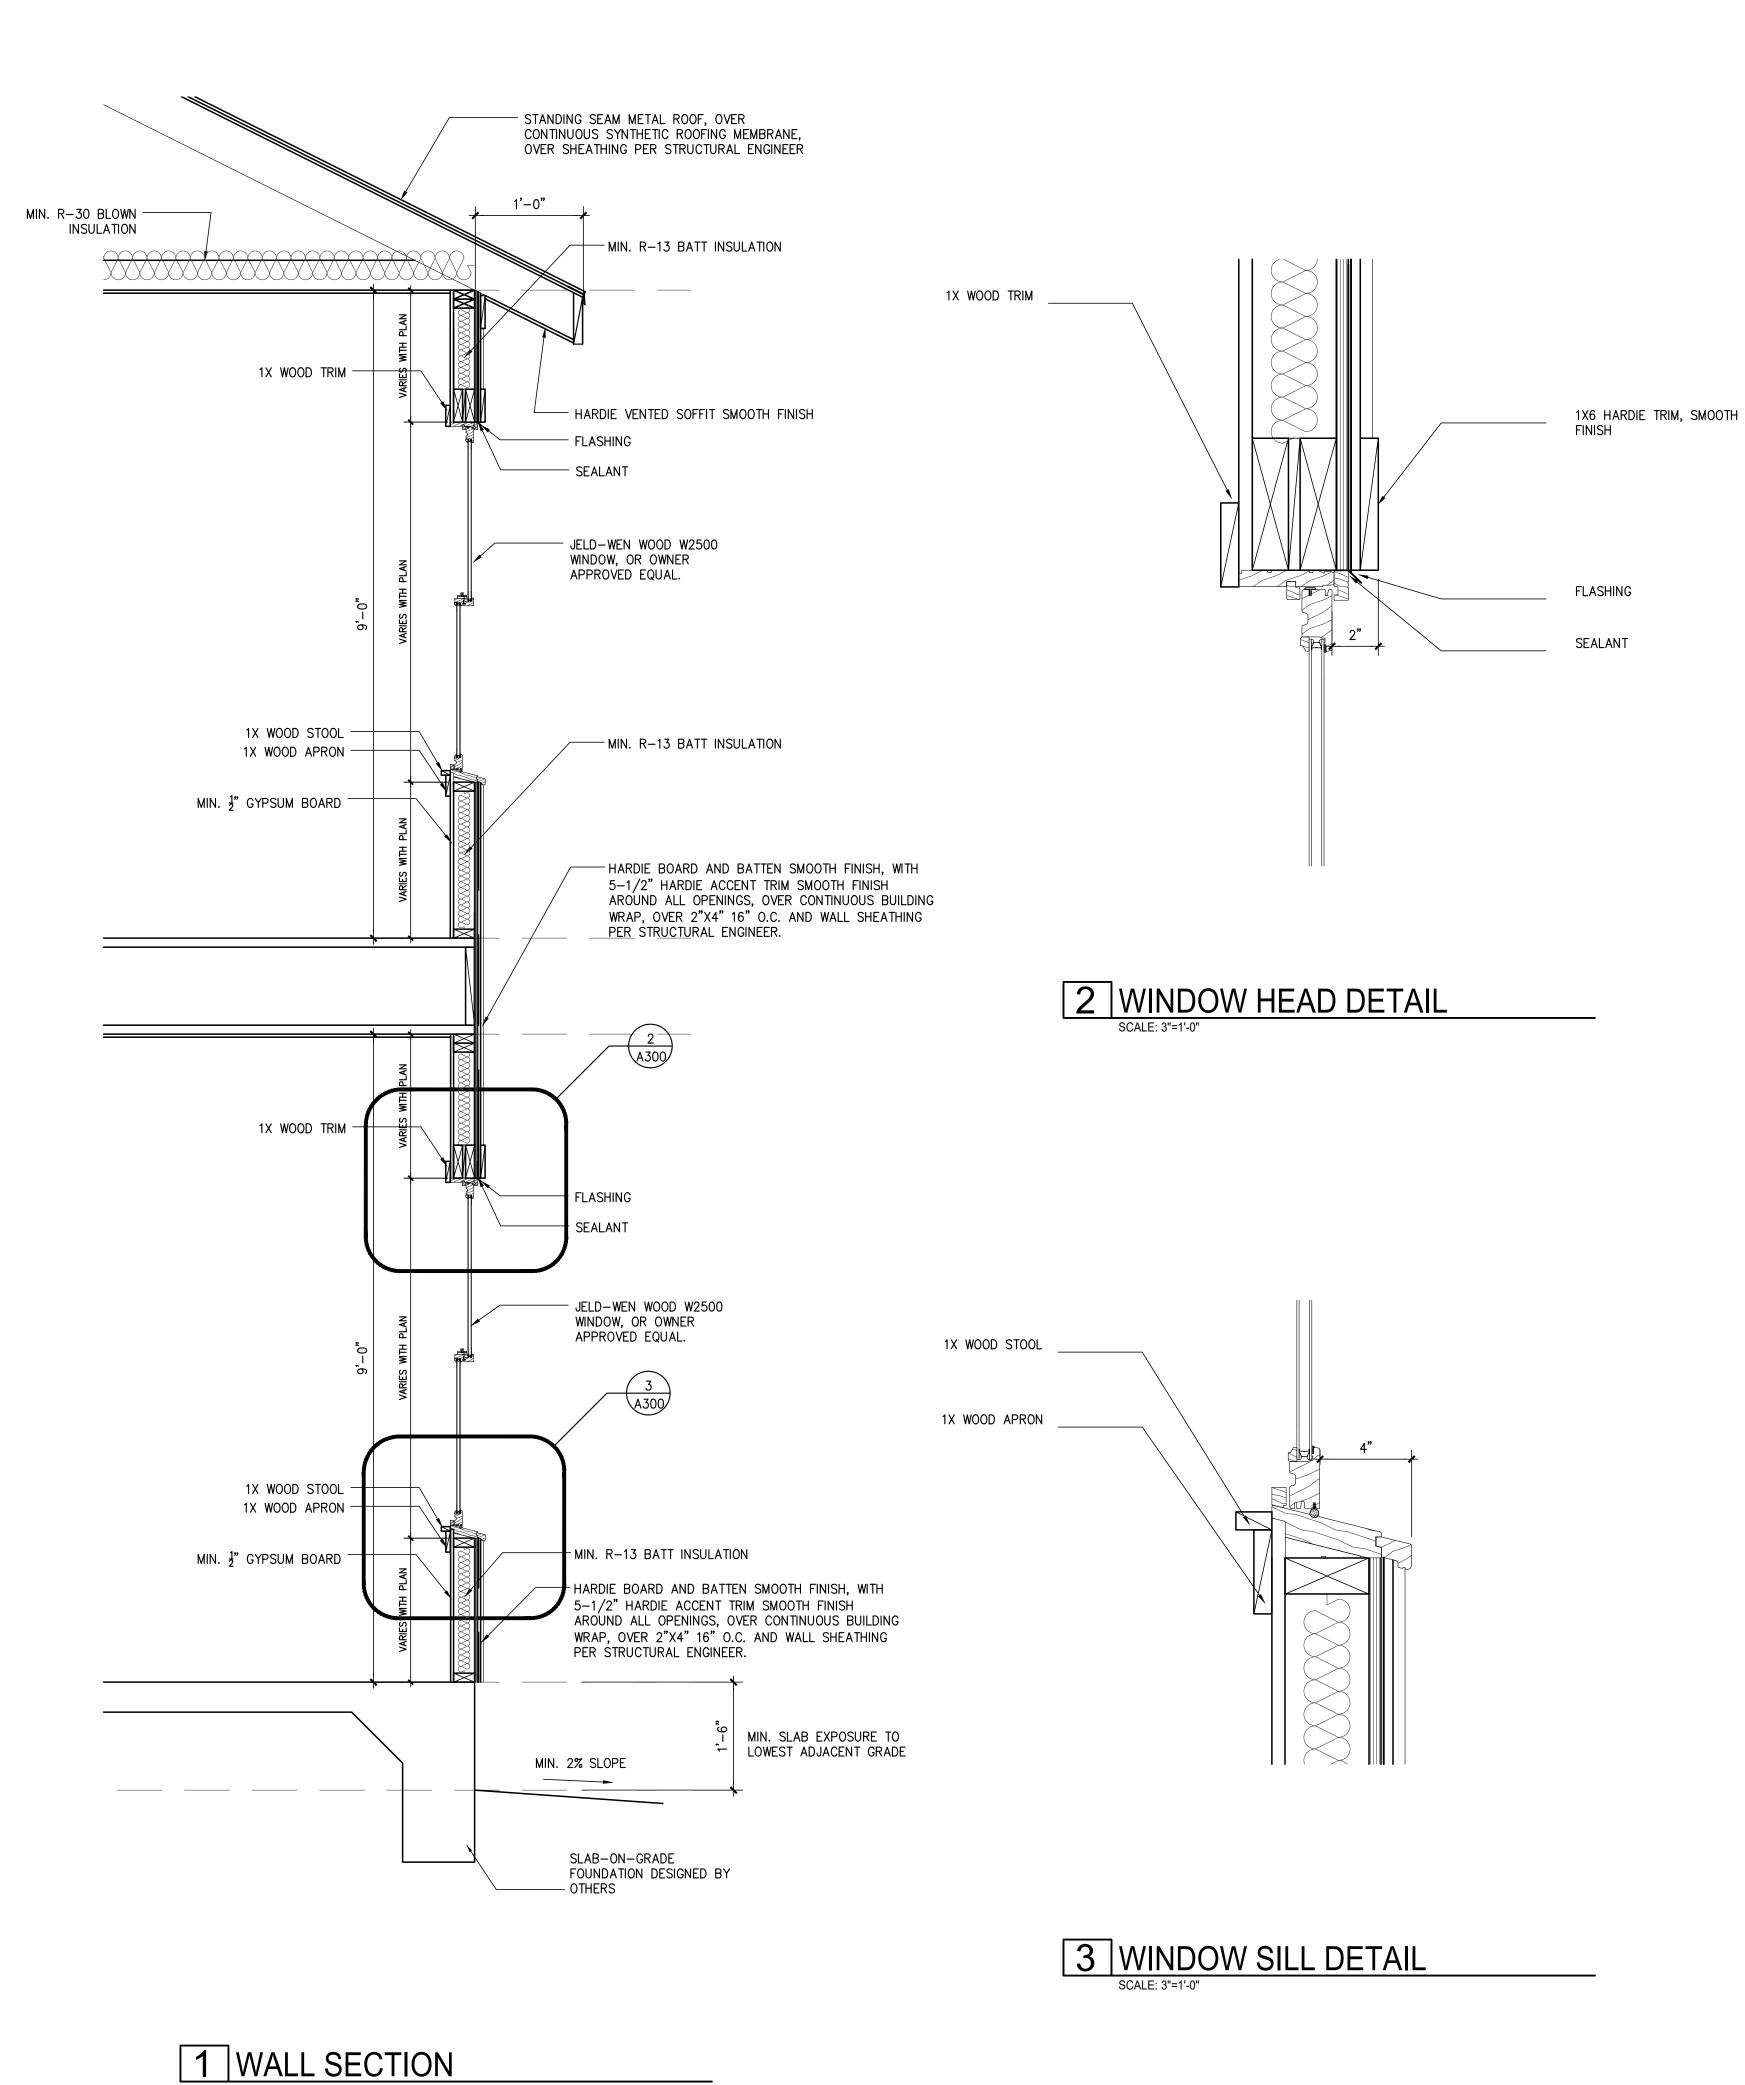
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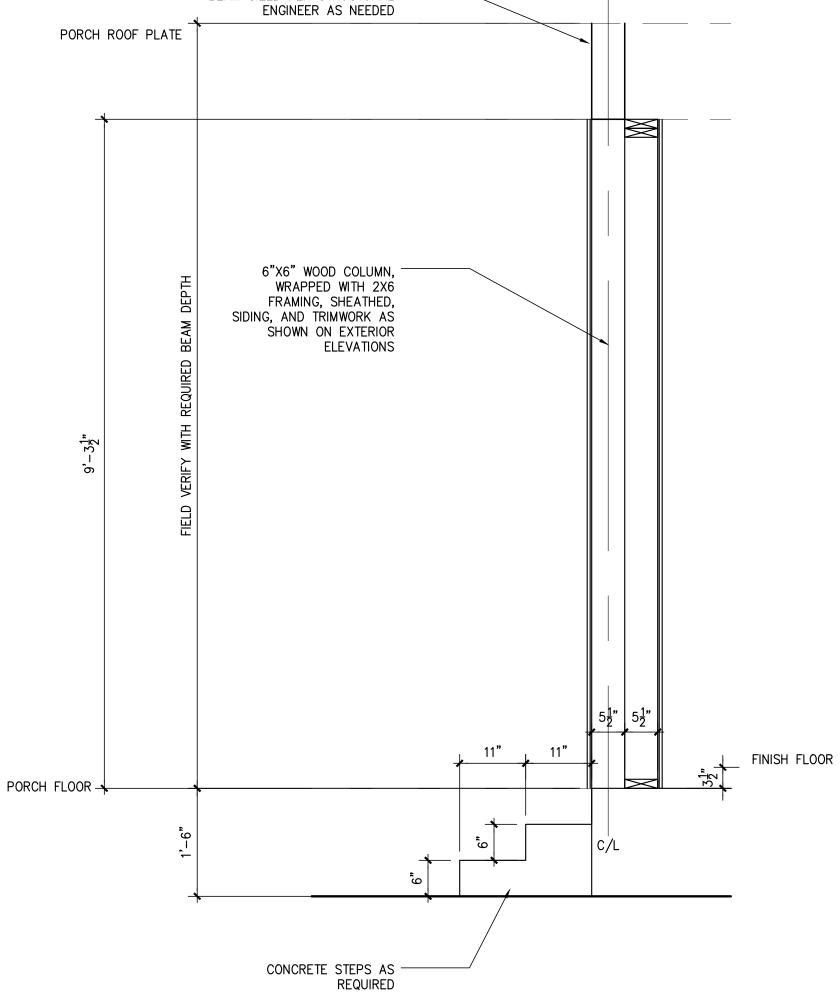
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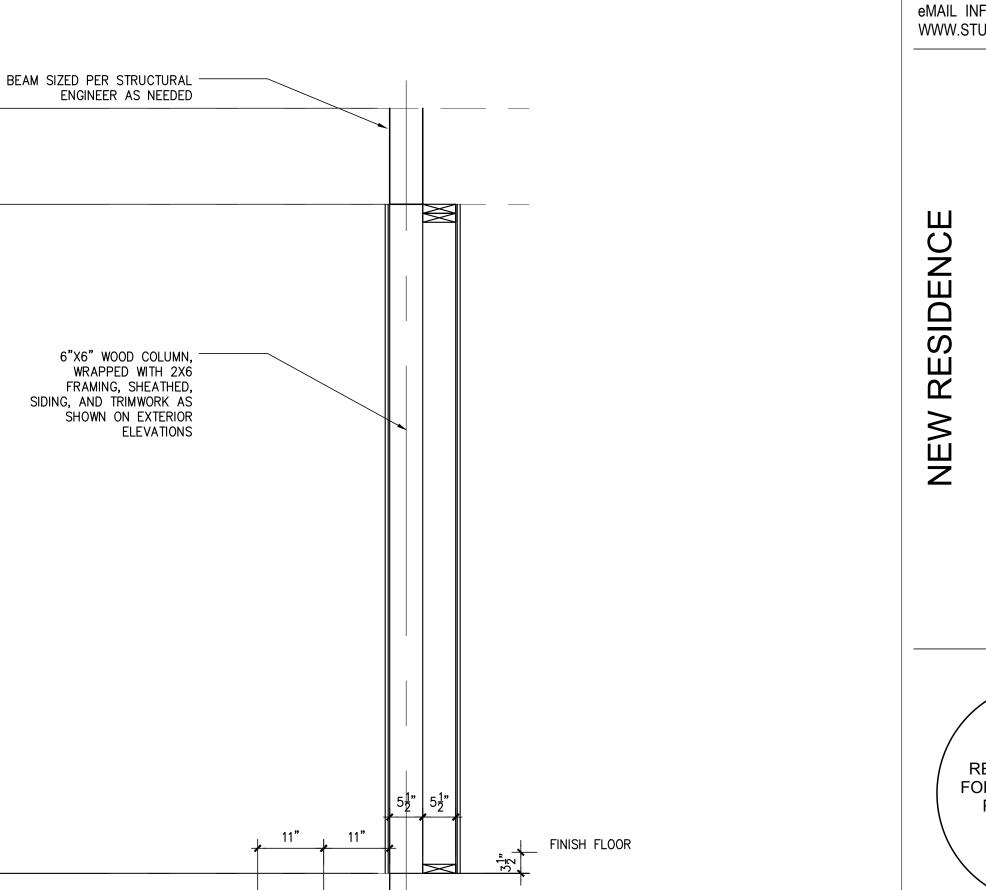
PROPOSED EXTERIOR **ELEVATIONS** 

20-136 PROJECT NO. 10-01-20 FJZ DRAWN BY: FJZ **REVIEWED BY:** PROJECT ARCHITECT: FELIX J. ZIGA JR., AIA TEXAS LICENSE NO. 24683





4 TYPICAL CEDAR COLUMN DETAIL



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HENNEKE

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WALL SECTION AND

**DETAILS** 

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